DRAWING GENERAL NOTES:

CONTRACTOR SHALL VERIFY EXISTING CONDITIONS IN FIELD PRIOR TO BEGINNING WORK.

PLUMBING GENERAL NOTES:

- CAREFUL COORDINATION WITH LIGHTING, ELECTRICAL, MECHANICAL, STRUCTURAL AND PIPING INSTALLATION. CONTRACTOR SHALL PROVIDE NECESSARY OFFSETS IN NEW AND EXISTING PIPING AND ELECTRICAL CONDUIT AS REQUIRED TO ACCOMMODATE NEW WORK. CONTRACTOR SHALL ALLOW FOR ANY CONFLICTS
- PIPING LAYOUTS ARE DIAGRAMMATIC AND DO NOT SHOW ALL ELEMENTS OF CONSTRUCTION. CONTRACTOR SHALL BE RESPONSIBLE FOR ALL CHANGES ON DIRECTION, ELEVATION AND MINOR OFFSETS NECESSARY FOR COMPLETE INSTALLATION OF ELEMENTS SHOWN.
- OTHERWISE NOTED. REFER TO ARCHITECTURAL FLOOR PLANS FOR ALL

DIMENSIONS.

Ш

ARCHITECTURAL WORK IS CRITICAL FOR COMPLETE ENCOUNTERED.

ALL WASTE PIPING SHOWN IS BELOW THE FINISHED

FLOOR UNLESS OTHERWISE NOTED. ALL VENT PIPING SHOWN IS ABOVE THE CEILING UNLESS 5/18/23



INTERIORS

21109

DATE:

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SHEET TITLE: LEGENDS, NOTES, AND

SHEET NUMBER:

PLUMBING LEGEND SYMBOLS AND ABBREVIATIONS DOMESTIC COLD WATER BALL VALVE ABOVE EXISTING DOMESTIC COLD WATER TO BE REMOVED ABOVE FINISHED FLOOR VALVE IN VERTICAL AFF EXISTING DOMESTIC COLD WATER TO REMAIN CAP ON END OF PIPE INVERT \bigcirc CO BFF DOMESTIC HOT WATER CLEANOUT - FLOOR TYPE BELOW FINISHED FLOOR \bigcirc CO EXISTING DOMESTIC HOT WATER TO BE REMOVED CLEANOUT - WALL TYPE CW COLD WATER P-TRAP EXISTING DOMESTIC HOT WATER TO REMAIN DN DOWN DOMESTIC HOT WATER RETURN PIPE TURNING DOWN EX **EXISTING** EXISTING DOMESTIC HOT WATER RETURN TO BE REMOVED PIPE TURNING UP **HOT WATER** TEE DOWN EXISTING DOMESTIC HOT WATER RETURN TO REMAIN WASTE STACK SANITARY VENT TEE UP VENT STACK \longrightarrow **14 EXISTING SANITARY VENT TO BE REMOVED** TIE NEW INTO EXISTING ABOVE CEILING P-1 **EXISTING SANITARY VENT TO REMAIN** PLUMBING FIXTURE NUMBER WHA WATER HAMMER ARRESTOR BELOW FINISHED GRADE STORM DRAINAGE XX RISER NUMBER BFG EXISTING STORM DRAINAGE TO BE REMOVED WATER HAMMER ARRESTOR TMV THERMOSTATIC MIXING VALVE PLUG TYPE CLEANOUT TRAP PRIMER EXISTING STORM DRAINAGE TO REMAIN ____ SANITARY WASTE BALANCING VALVE

CHECK VALVE

GATE VALVE

FLOOR SINK

FLOOR DRAIN

REDUCED PRESSURE ZONE BFP

THERMOSTATIC MIXING VALVE

ROOF DRAIN/OVERFLOW DRAIN

EXISTING SANITARY WASTE TO BE REMOVED

EXISTING SANITARY WASTE TO REMAIN

CONSTRUCTION DUST PARTITION

SHEET MATCH LINE

2 PSI GAS LINE

EXSITING 2 PSI

_ __ _ _ _

PLUMBING SPECIFICATION - GENERAL

SECTION 220001 - PLUMBING GENERAL PART 1-GENERAL

- 1.1 RELATED DOCUMENTS Drawings and general provisions of the Contract, including General and Supplementary Conditions and Division 1 Specification Section, Apply to this Section.
- 1.2 SUMMARY Work Included:
- Submittals **Electrical Requirements**
- Excavation & Backfilling Painting
- Cleaning
- Testing SUBMITTALS

Plumbing

- The Contractor shall submit for review by the Architect data of materials and equipment to incorporated in the work. Submittals shall be supported by descriptive
- material, catalogs, cuts, diagrams, performance curves, and charts published by the manufacturer to show conformance to specification and drawing requirements; model numbers alone will not be acceptable. B. Refer to the individual sections for identified
- equipment and materials for which submittals are required. C. Refer to the SHOP DRAWINGS, PRODUCT DATA AND SAMPLES Section for required procedures. Submittals shall be required for:
- Pipe Certification Pipe fittings, solders used Plumbing Fixtures - The contractor shall verify the plumbing fixture requirement for type of fixtures, valves and trim with the engineer prior to rough in work and prior to
- Valves, Backflow preventors, Grease Traps, Floor
- Plumbing Equipment Electrical Data Prior to submitting data for equipment requiring electrical service, the Contractor shall verify that electrical characteristics of equipment submittals comply with electrical service provided for the specified items of equipment.
 - 2. Upon receipt of the Contractor of reviewed submittals for equipment provided under this Division, the Contractor shall coordinate the electrical service requirements, i.e., motor horsepower and full load amps, electrical service characteristics (voltage and phase), and number of services for each item of equipment requiring electrical connections with the electrical drawings and specifications. The Contractor shall furnish to the Architect a complete typewritten list of electrical requirements for each item of equipment to be installed.
- F. Items on or projecting through the ceiling shall be coordinated with other items and shall be shown on the reflected ceiling plan shop drawings submitted for the Architect's review. Such items shall follow the reflected ceiling plan shop drawings and shall not be install until reviewed by the Architect with no exceptions taken.
- 1.4 QUALITY ASSURANCE A. The mechanical equipment and installation shall conform to the applicable codes.
- B. Permits Obtain all permits and inspections for the installation of this work and pay all charges incident thereto. Deliver to the Owner all certificates of said inspection issued by authorities having jurisdiction.
- C. Workmanship and Materials The workmanship and materials covered by these specifications shall conform to all ordinates and regulations of the City, county and/or other authorities having
- jurisdiction. 1.5 OPERATION AND MAINTENANCE
- INSTRUCTIONS A. Refer to Division 1 for Detail Requirements. Printed Materials: Provide required printed material for binding in operation and maintenance manuals.
- C. Instructions of Owner personnel: Before final inspection, at a time designated by the Architect, provide a representative with knowledge of the building systems to instruct Owner's designated personnel in operation, adjustment, and maintenance of products, equipment, and systems under this division of the
- specifications. For equipment requiring seasonal operation, perform instructions for other seasons within six months unless requested otherwise. 2. Use operation and maintenance manuals as basis of
- instruction. Review contents of manual with personnel in detail to explain all aspects of operation and maintenance. 3. Prepare and insert additional data in Operation and Maintenance Manual when need for such data becomes apparent during instruction.
- 1.6 RECORD DOCUMENTS A. Refer to Division 1 for record documents and related submittals.
- 1.7 CONTRACT DRAWINGS A. Drawings are diagrammatic and indicate general arrangement of systems and work. B. Follow drawings in laying out work and check drawings of other disciplines relating to work to verify space

conditions. Do not scale drawings.

Division of these Specifications shall comply with the electrical system characteristics indicated on the electrical and mechanical drawings. B. Power wiring (i.e., feeders to motors, water heaters, and electric heaters and tapes including final connection to equipment) shall be provided under Division 26 - Electrical. PART 3 EXECUTIONS

and connection arrangements.

1.8 GUARANTY

3.1 PAINTING ordering the plumbing fixtures. A. Factory painted equipment that has been scratched or marred shall be repainted to match Original

Contractor.

PART 2 PRODUCTS

2.1 ELECTRICAL WORK

uninsulated black steel pipe exposed to sight inside the building which are not provided with a factory applied prime coat shall be cleaned of rust, grease and scale. After cleaning hangers, supports and pipe, a fieldapplied prime coat shall be provided. In addition, such items in finished spaces shall also be provided with two coats of finish paint in a color to match adjacent surface. C. Steel equipment hangers and supports, uninsulated black steel pipe, and black steel pipe support exposed to sight outside the building which are not provided with factory prime coat shall be cleaned of rust, grease and scale. After cleaning hangars, supports and pipe, a field-applied prime coat and two coats of bituminous aluminum paint shall be provided. Insulated pipes outside the building shall be cleaned of rust,

Steel equipment hangers and supports and

applied prime coat before installing insulation. D. All painting shall conform to the requirements of the PAINTING Section. 3.2 CLEANING AND ADJUSTING

grease and scale, and shall be provided with a field-

- A. All equipment, pipe, valves and fittings shall be cleaned of grease, oil, and paint spots, metal Cuttings, sludge, and construction debris. Ducts, plenums and casings shall be cleaned of all debris and blown free of all particles
- 1. Of rubbish and dust before installing outlet faces. Bearings shall be lubricated as recommended by the equipment manufacturer. D. Temporary filters shall be provided for fans that
- are used during construction. At the time of starting the balancing of the air distribution system, new filters shall be installed.
 - 3.3 TESTING PIPE SYSTEM A. General: Concealed piping and insulated piping shall be tested in place before concealing or covering. Piping located underground shall be tested before backfilling. Equipment, materials, and instruments for testing shall be furnished by the Contractor without additional cost to the Owner. System components not rated for the respective test pressure shall be isolated from the system during the test.
 - B. Observation: The Contractor shall notify the owner's representative two days prior to a scheduled test. The owner's representative, at this option, has the right to witness the test. Sanitary, Waste, and Vent System
 - 1. The hydrostatic test shall be performed before installing fixtures. Water tests shall be applied to each system (s) either in its entirety or in sections. If the test is applied to the entire system, all openings in the piping shall be closed except the highest opening, and the system shall be filled with water and tested with at least a 10 ft. head of water. In testing successive sections, at least the upper 10 ft. of the next preceding section shall be tested so that each joint or pipe in the building except the uppermost 10 ft. of the system has been submitted to a test of at least a 10 ft. head of water. The water shall be kept in the system, or in the portion under test for at least 2 hours before inspection starts. The system shall be tight at all joints. END OF SECTION

JOB NUMBER:

05/18/23

DESCRIPTION

ABBREVIATIONS -

PLUMBING

2920 FIRST AVENUE SOUTH BIRMINGHAM, ALABAMA 35233 CCRARCHITECTURE.COM 205-324-8864





GENERAL NOTES:

1. 1"Ø DOMESTIC COLD WATER LINE TO EACH WATER CLOSET.

- 2. 3/4"Ø DOMESTIC COLD WATER LINE TO EACH
- MAIN LINE.

KEY NOTES:

- 1/2"Ø COLD AND HOT WATER LINES TO ROUTE DOWN WALL AND UNDER COUNTER TO SINK.
- 2 3/4"Ø COLD AND HOT WATER LINES TO ROUTE DOWN WALL AND CONNECT TO LAVATORIES.
- SEE CIVIL FOR CONTINUATION.
- 3/4"Ø COLD AND HOT WATER LINES TO ROUTE INTO CONCESSION AREA AND CONNECT TO SINKS AND REQUIRED EQUIPMENT. SEE KITCHEN CONSULTANT FOR CONTINUATION.
- 1/2"Ø COLD AND HOT WATER LINES TO ROUTE DOWN WALL AND CONNECT TO WASHING MACHINE VALVE BOX.
- 6 GAS METER BY OTHERS: 2# SYSTEM TOTAL CFH: 2263 LONGEST LENGTH: 260'
- 1/2"Ø COLD WATER LINE TO ROUTE UP AND CONNECT TO HOSE BIBB ON SIDE WALL OF ROOF.
- GAS LINE TO ROUTE UP EXTERIOR OF BUILDING AND SPLIT INTO TWO LINES. ONE LINE TO ROUTE INTO THE BUILDING ABOVE THE CEILING AND CONNECT TO THE KITCHEN EQUIPMENT. THE SECOND LINE TO CONTINUE TO THE ROOF AND CONNECT TO THE ROOFTOP EQUIPMENT.

URINAL.

SHUT-OFF VALVES TO BE INCLUDED ON ALL DOMESTIC WATER AND GAS LINE BRANCHES FROM

JOB NUMBER:

21109

DATE:


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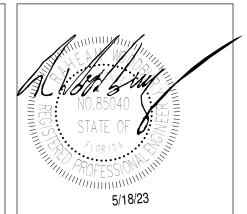
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SHEET TITLE: FIRST FLOOR PLAN PLUMBING

SHEET NUMBER:

P101





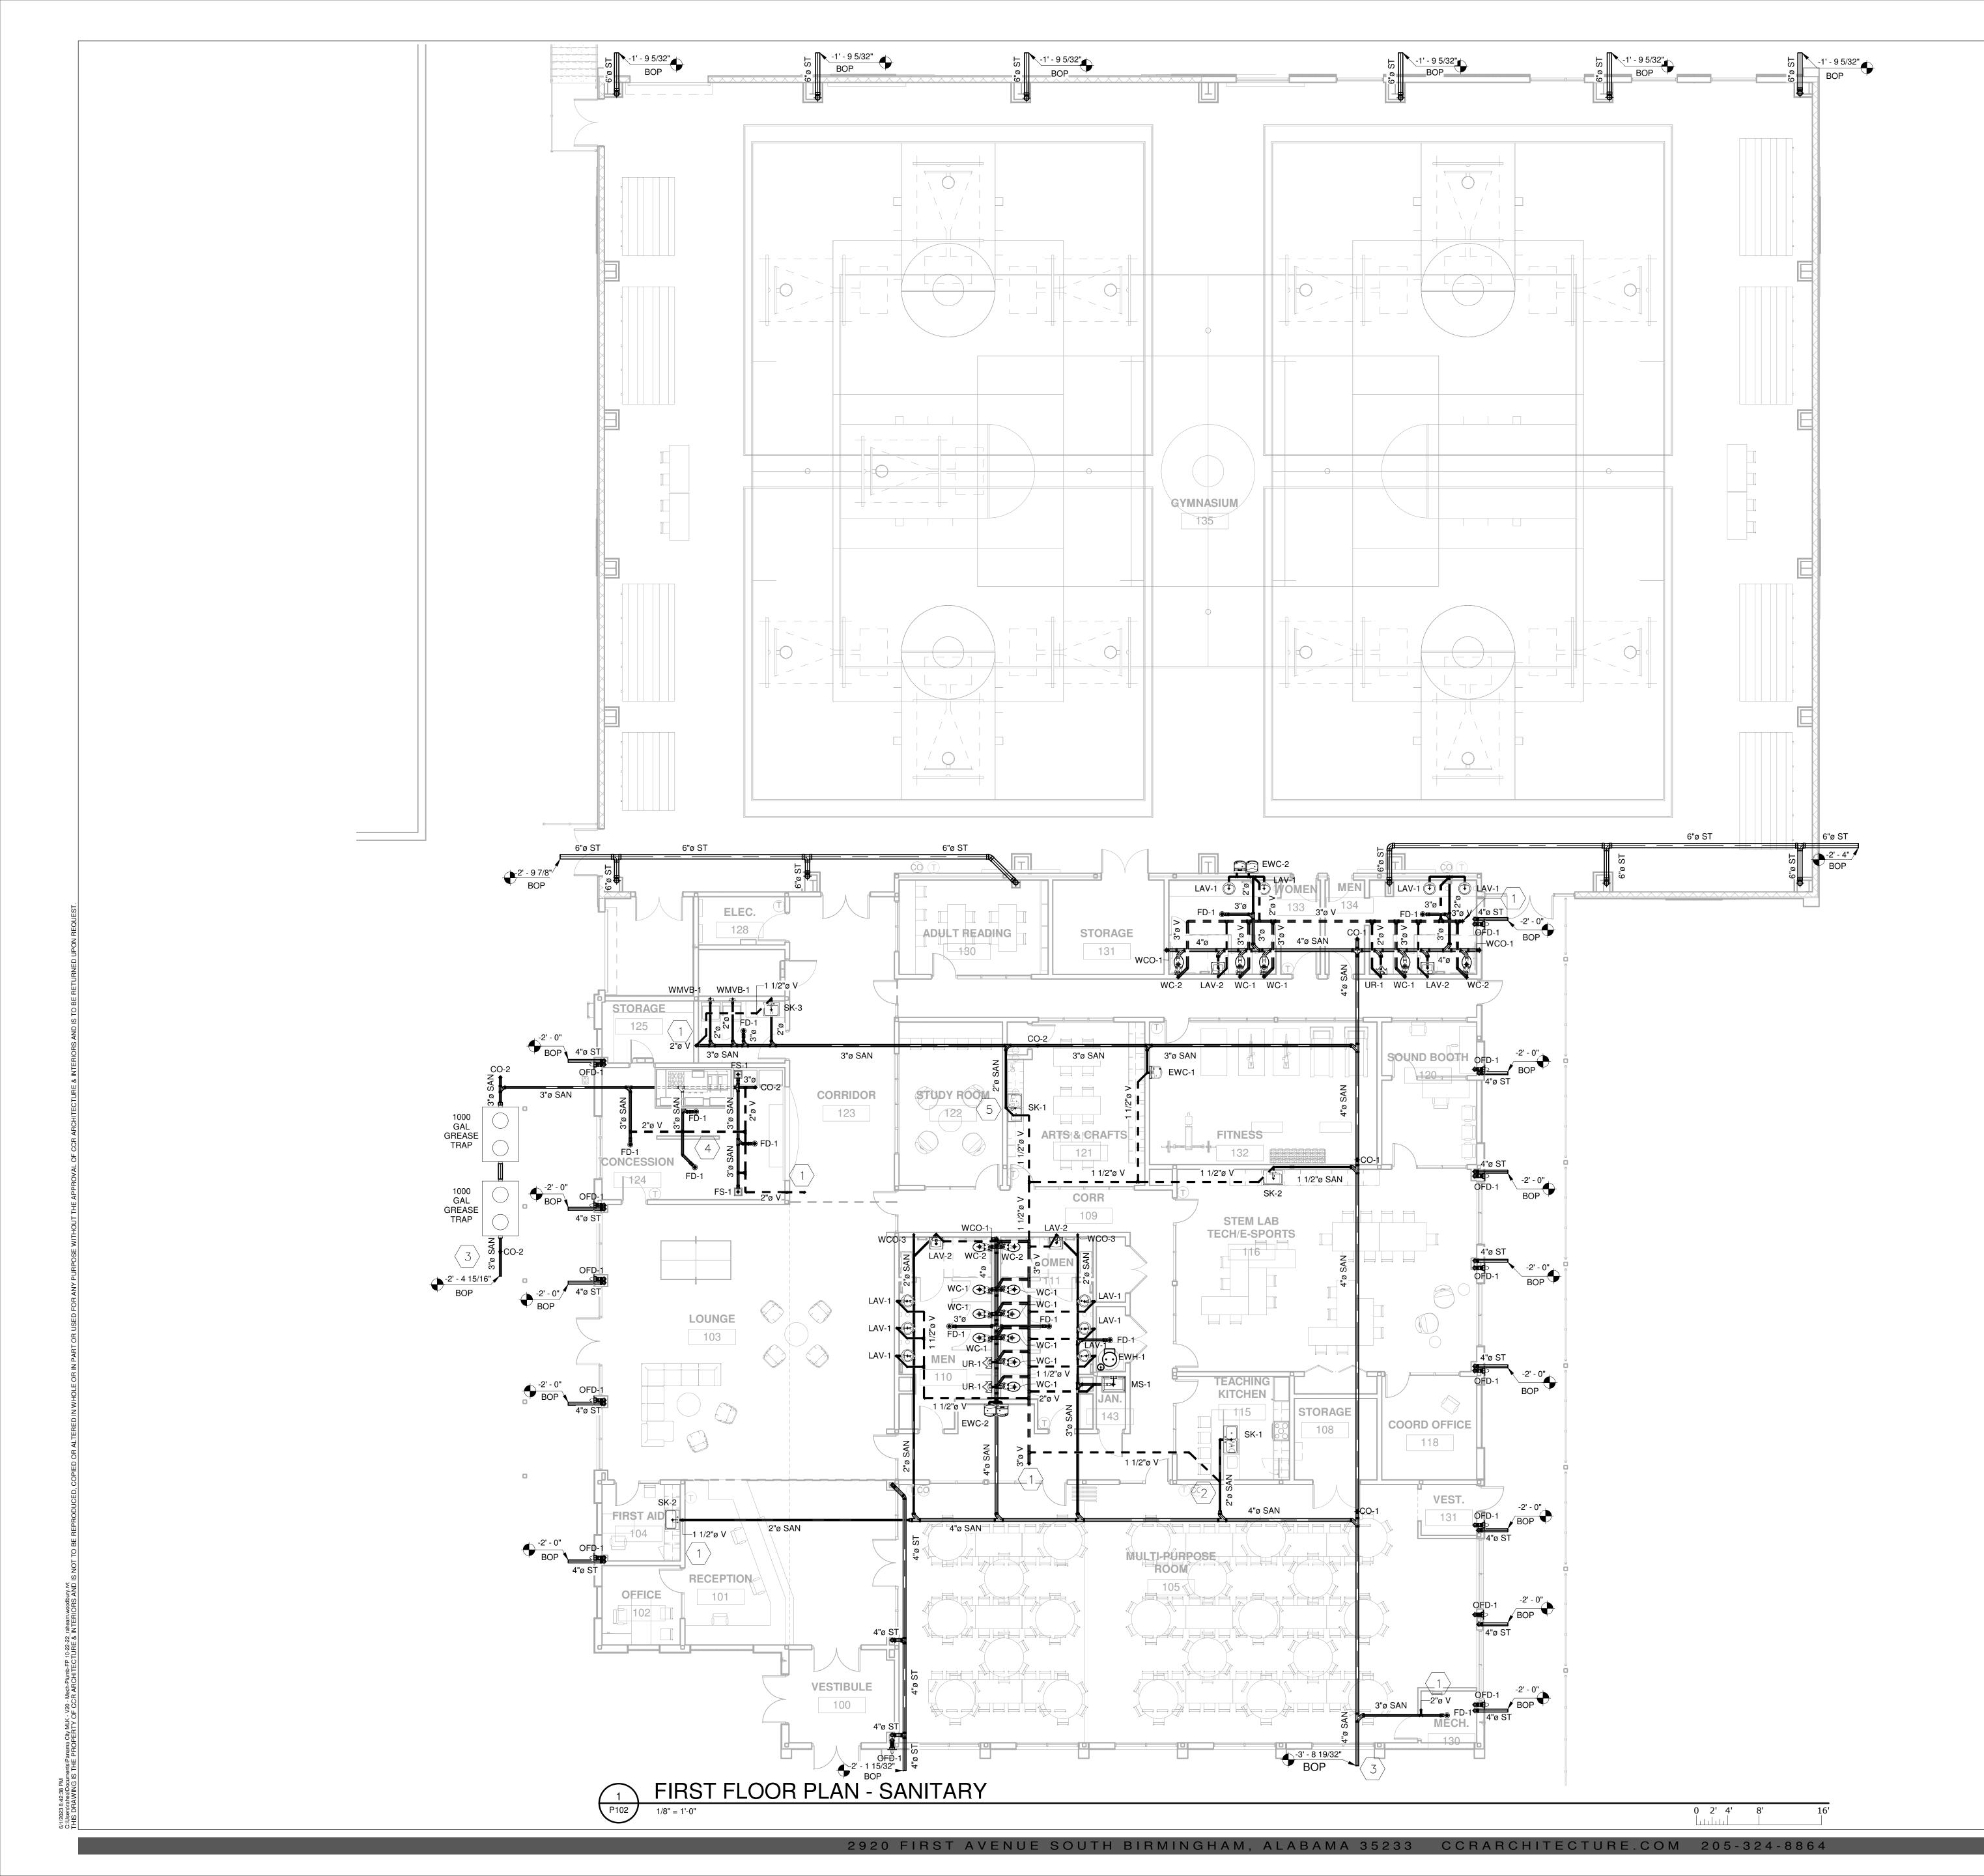

CENTE

GENERAL NOTES:

PLUMBING CONTRACTOR TO FIELD VERIFY ALL

KEY NOTES:

- VENT LINE TO ROOF.
- VENT LINE TO ROUTE UNDER COUNTER AND UP IN
- CONTINUE TO CIVIL.

EXISTING CONDITIONS BEFORE WORK AND COORDINATE WITH OTHER DISCIPLINES.

COORDINATE ROOF DRAINS AND STORM LINES WITH ARCHITECTURAL AND CIVIL.

- $\langle 4 \rangle$ Vent line to route under floor.
- SOLIDS INTERCEPTOR TO BE INSTALLED UNDERCOUNTER TO SINK IN LIEU OF P-TRAP. FOR ABOVE THE FLOOR INSTALLATION.

JOB NUMBER: 21109

DATE: 05/18/23

PRINTED / REVISIONS # DESCRIPTION

SHEET TITLE: FIRST FLOOR PLAN -SANITARY

SHEET NUMBER: P102



GENERAL NOTES:

VENT LINES TO BE A MINIMUM OF 24" ABOVE ROOF FLOOR. ADJUST AS NEEDED. AND MINIMUM OF 10' FROM FRESH AIR INTAKE.

SHUT-OFF VALVES TO BE INCLUDED ON ALL GAS LINE BRANCHES FROM MAIN LINE.

COORDINATE ROOF DRAINS AND STORM LINES WITH ARCHITECTURAL AND CIVIL.

JOB NUMBER: 21109

DATE: 05/18/23

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DESCRIPTION DATE

SHEET TITLE: ROOF - PLUMBING

SHEET NUMBER: P201

1 1/2"ø V

DOWN TO GAS METER -

___1 1/4"ø NG_

1 ROOF - PLUMBING

1/8" = 1'-0"

3/4"ø NG

-ф-6"ø ST

3/4"ø NG

CW LINE DOWN TO MAIN

3/4"ø NG

EF-9

EF-6

EF-5

3/4"ø NG

RTU-7 224 CFH

-ф-6"ø ST

6"ø ST -ф-

1 1/4"ø NG

→RD-1 4"ø ST


-∳-6"ø ST

6"ø ST

6"ø ST -∳-

TYPICAL FLOOR CLEANOUT DETAIL

- CLEANOUT COVER ADJUSTABLE HOUSING - FINISHED FLOOR LONG SWEEP 1/4 BEND OR "Y" & 1/8 BEND. (USE REDUCING TYPE _WHERE REQUIRED) DIRECTION OF FLOW

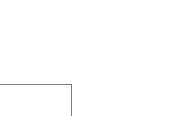

WATER HAMMER ARRESTOR SCHEDULE										
MARK A B C D E										
MAXIMUM FIXTURE UNITS	11	32	60	133	154	330				
MAXIMUM PRESSURE RATING	ATING 65 PSI									

TURN LEAD DOWN

INTO STACK (CANNOT

INSULATION

SLEEVE ROOF CONSTRUCTION AS REQUIRED (PROVIDE FIRE

BY LOCAL CODES)

REQUIRED)

- VENT STACK OR

STACK VENT


- INCREASER (WHEN

RATED CAULKING WHEN REQUIRED

RESTRICT FLOW OF

AIR) VENT CAP

ROOFING

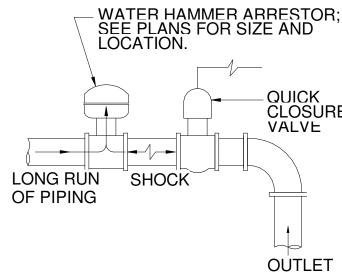

1. WATER HAMMER ARRESTOR SIZED ACCORDING TO PLUMBING AND DRAINAGE INSTITUTE (PDI)

RATING. 2. INSTALL ACCORDING TO MANUFACTURER'S INSTRUCTIONS.

SHEET LEAD FLASHING; MOP IN WITH ROOFING

→ MINIMUM→

VENT THROUGH ROOF DETAIL


12 INCHES

MATERIAL


12 INCHES

ROOF CONSTRUCTION—


WATER HAMMER ARRESTOR DETAIL 8 P401

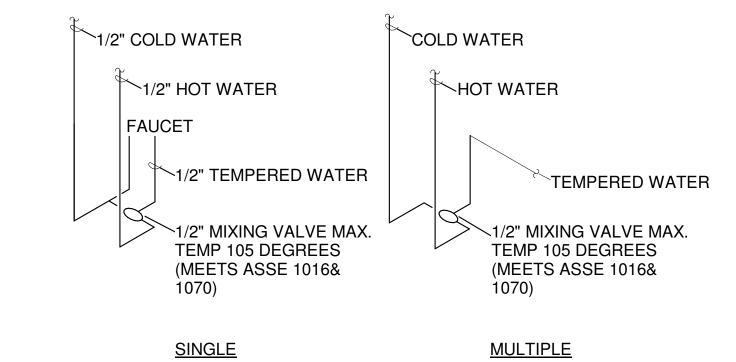


TYPICAL LAVATORY MIXING VALVE DETAIL

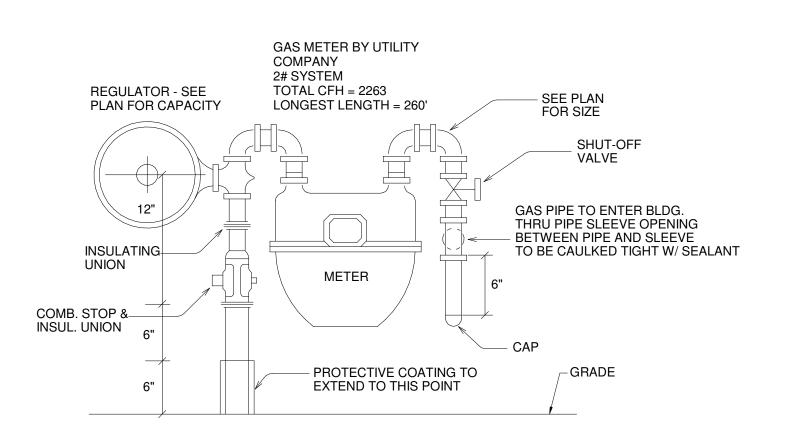


GAS METER DETAIL

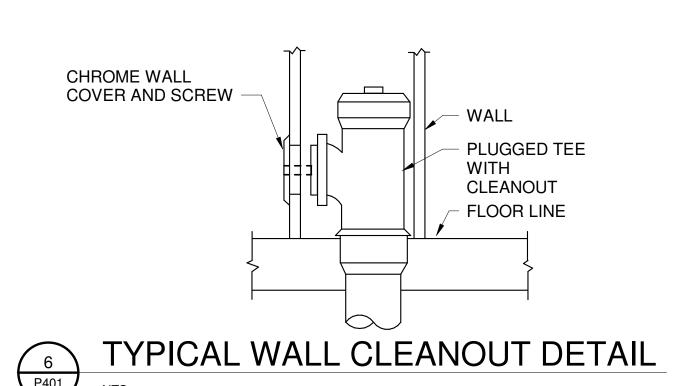


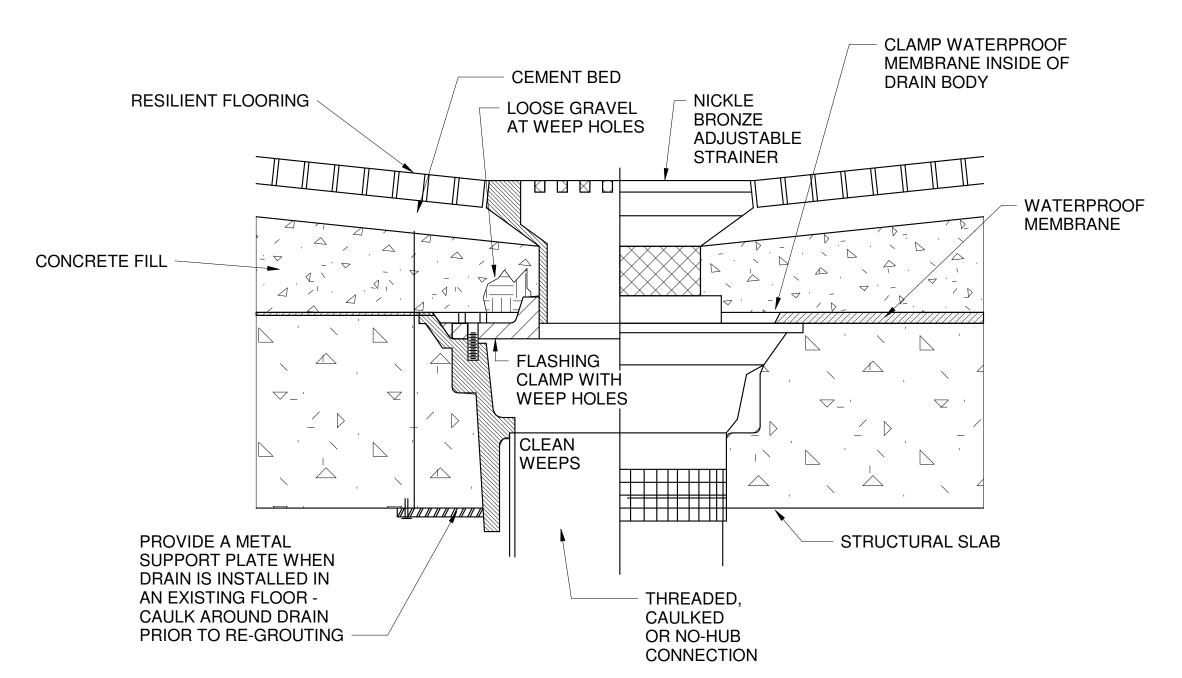

FLOOR DRAIN DETAIL

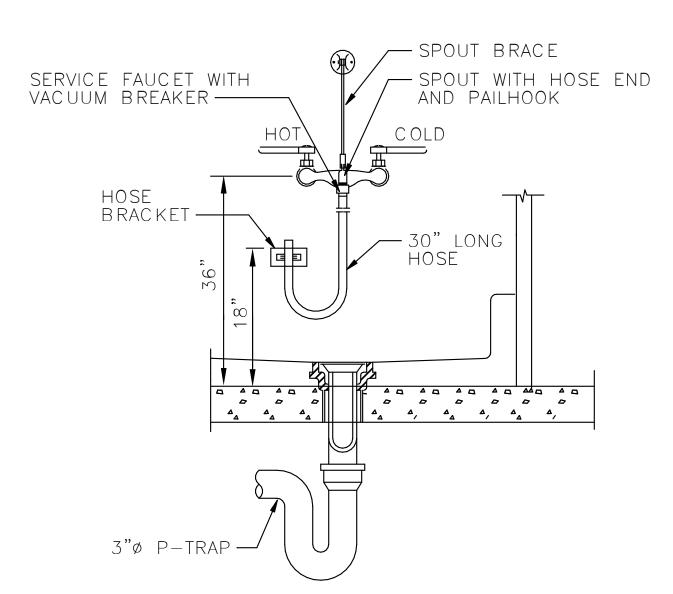

SANITARY SINK WATER OUTLET DETAIL

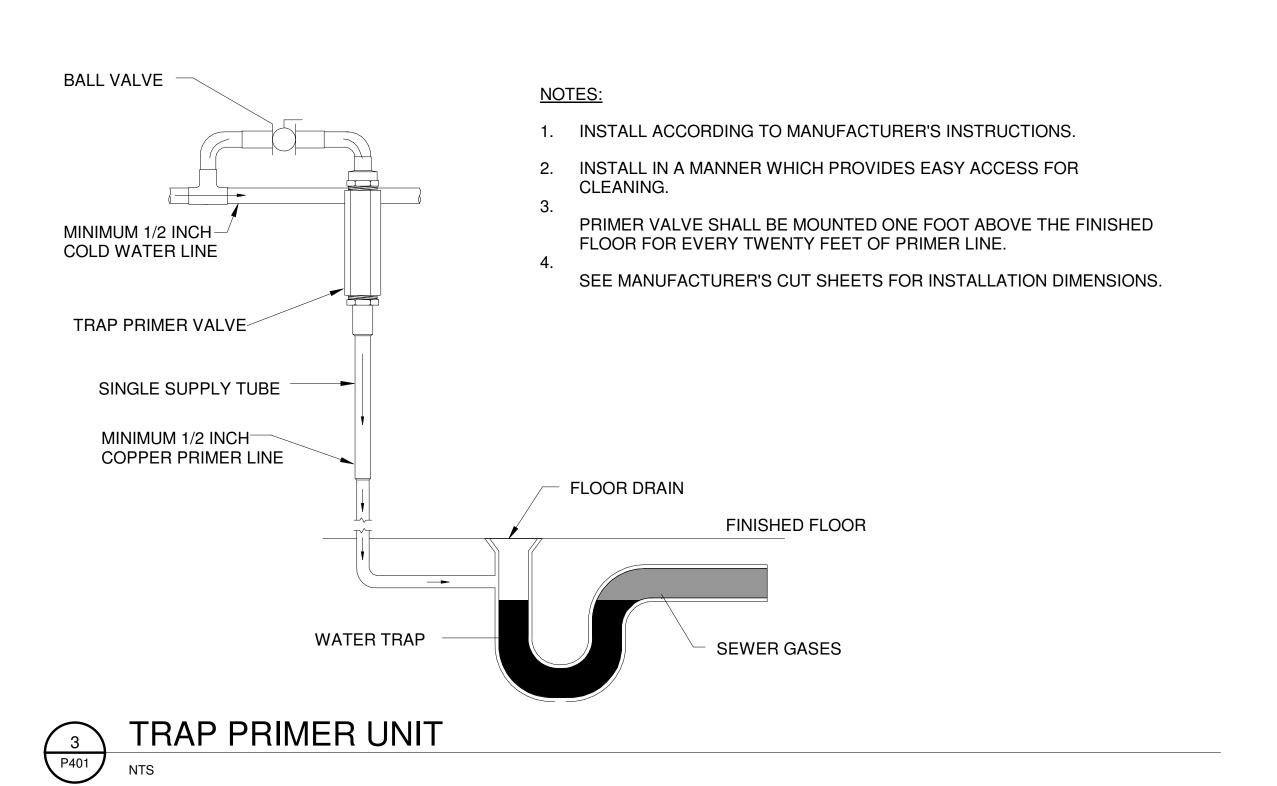

SHEET TITLE: DETAILS - PLUMBING

P401

SHEET NUMBER:

1. HEAT TRAP IS NOT REQUIRED WHERE MIXING VALVE

MANUFACTURER'S INSTRUCTIONS.

IS INSTALLED BELOW STORAGE TANK OR WATER HEATER.

2. SET THE MIXING VALVE TO THE SYSTEM ACCORDING TO


3. SET THE BALANCING VALVE FOR 20% OF THE TOTAL RETURN.

4. MIXING VALVE TO BRING HOT WATER TEMPERATURE DOWN

FROM 140F TO 120F. FIXTURES TO HAVE A SECOND MIXING


VALVE TO BRING TEMPERATURE DOWN TO 105F.


HOT WATER HEATER MIXING VALVE DETAIL 4 P402

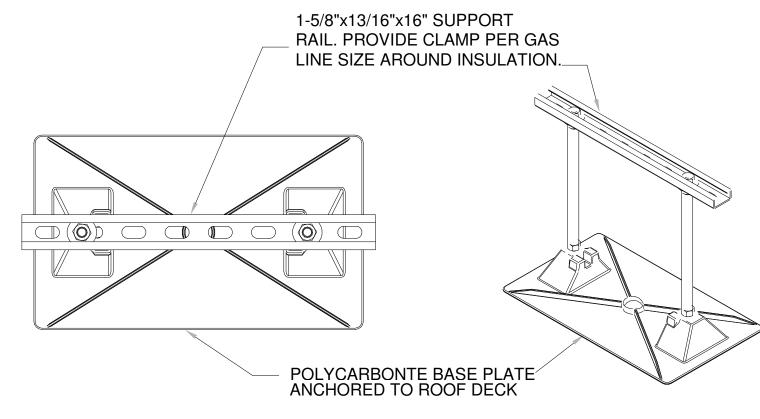


PROVIDE SUPPORT EQUAL TO MIRO INDUSTRIES MODEL 16-BASE STRUT-12 SUPPORTS TO BE 10' MAX FROM EACH OTHER THROUGHOUT ENTIRE PIPE RUN. APPLICABLE FOR CONDENSATE LINES AS WELL

OUTDOOR GAS / CONDENSATE PIPING SUPPORT DETAIL 5 P402

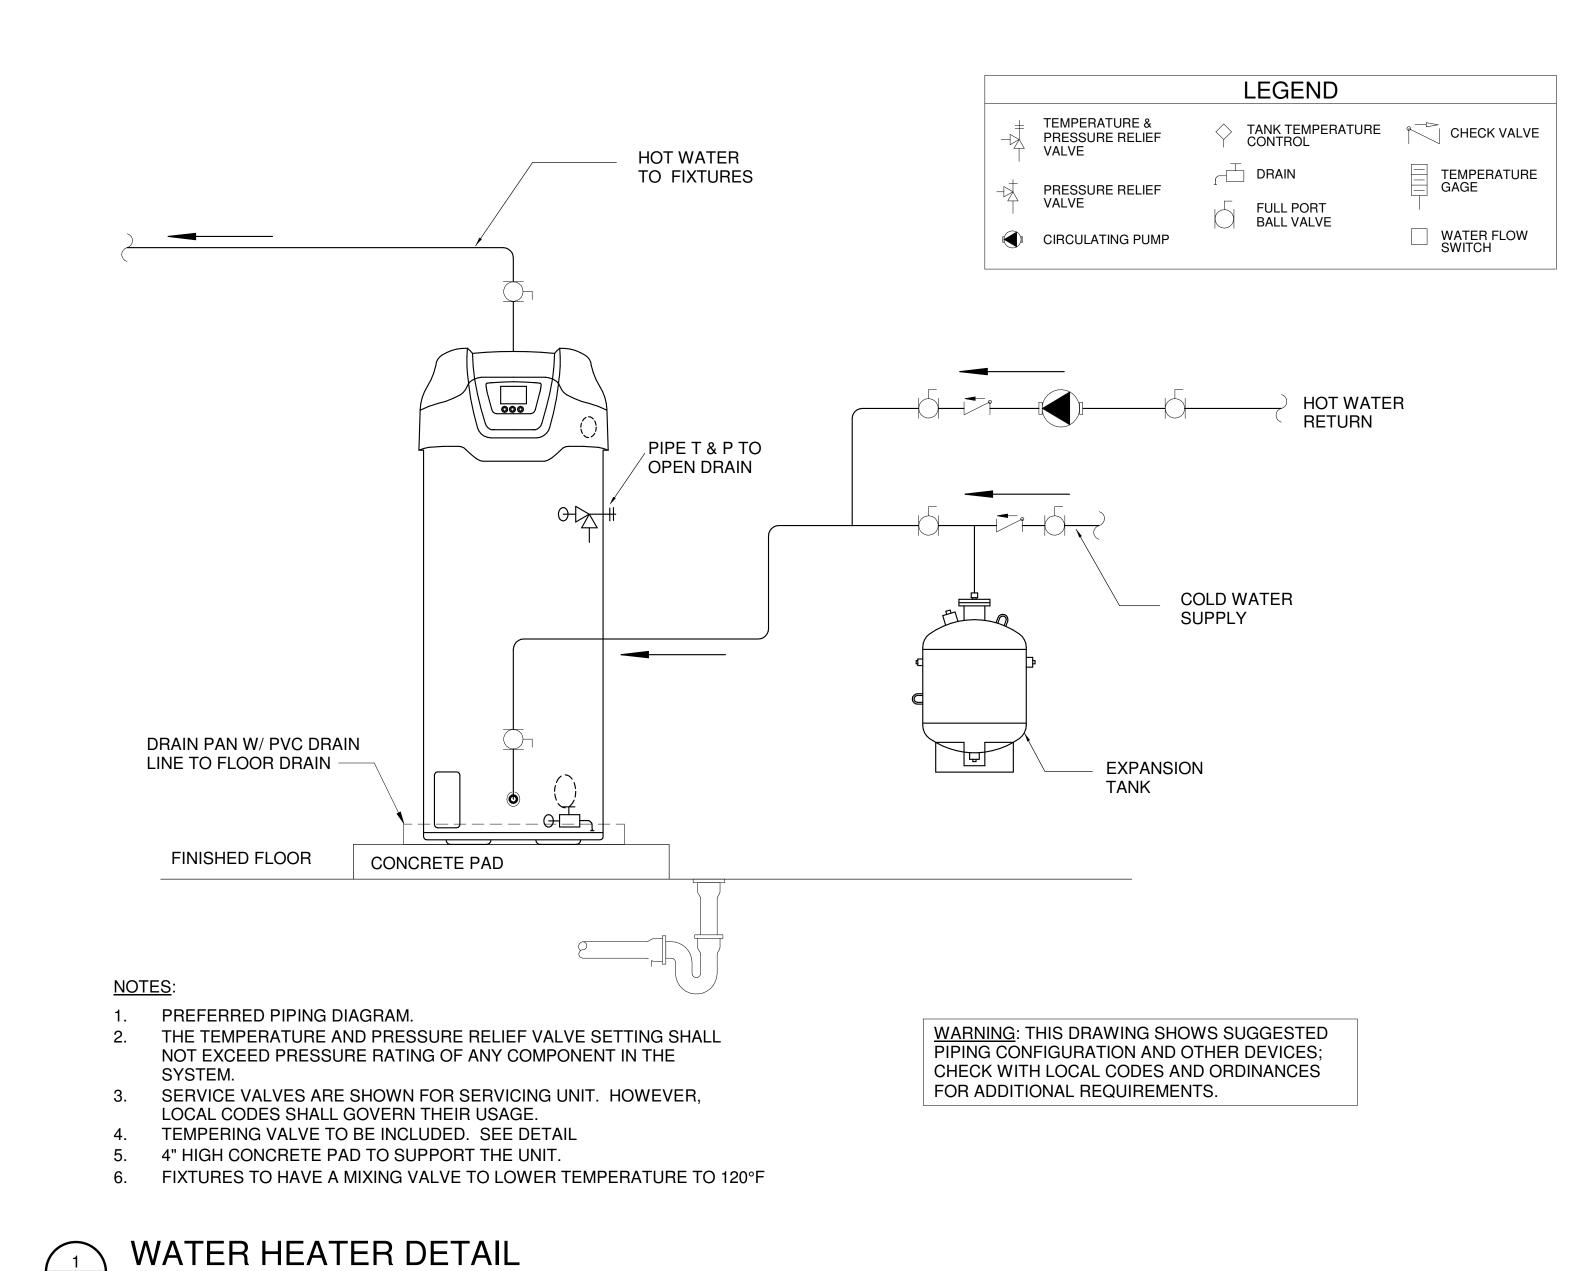

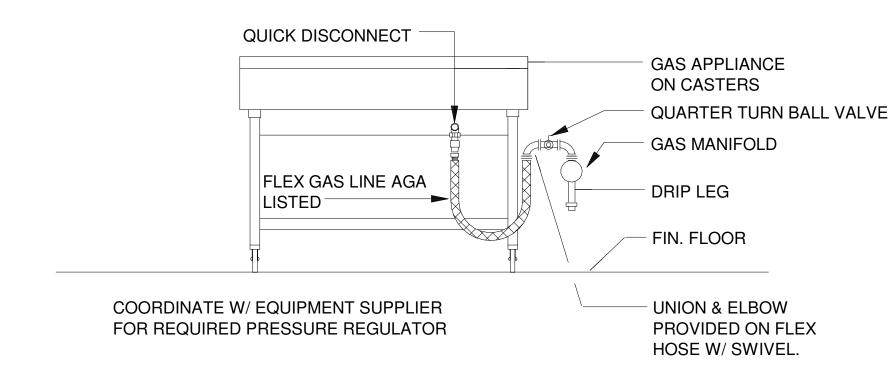


TYPICAL GAS APPLIANCE CONNECTION

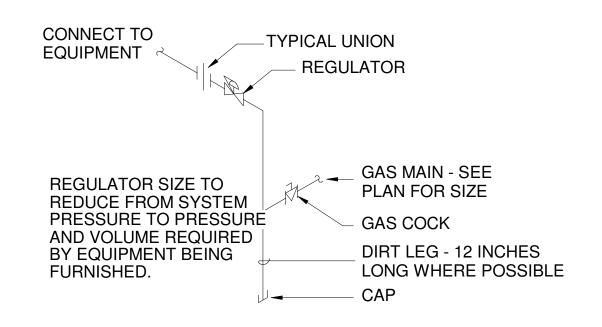

TYPICAL GAS CONNECTION DETAIL

P402
NTS

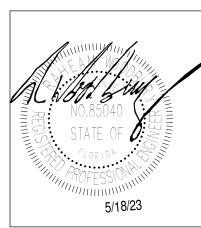

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JOB NUMBER: 21109

DATE: 05/18/23

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SHEET TITLE: DETAILS - PLUMBING

P402

SHEET NUMBER:

SCHEDULE - PLUMBING

SHEET TITLE:

P501

PLUMBING FIXTURE SCHEDULE HOT COLD												
MARK	DESCRIPTION	MANUFACTURER	MODEL	WATER	WATER	WASTE	VENT	REMARKS				
1000 GAL	1000 GAL GREASE TRAP					3"	2"					
GREASE TRAP BFP-1	DOUBLE CHECK VALVE BACKFLOW ASSEMBLY	WATTS	LF007-NRS		2-1/2"							
CO-1	FLOOR CLEANOUT WITH HEAVY DUTY ROUND TOP	WATTS	CO-204-RX			4"						
CO-2	FLOOR CLEANOUT WITH HEAVY DUTY ROUND TOP	WATTS	CO-203-RX			3"						
EWC-1	ELECTRIC WATER COOLER WITH BOTTLE FILLER	ELKAY	LZSG8WSLK		1/2"	1-1/2"	1-1/2"	115V/60HZ				
EWC-2	BI-LEVEL ELECTRIC WATER COOLER WITH BOTTLE FILLER	ELKAY	LZSTLG8WSLK		1/2"	1-1/2"	1-1/2"	115V/60HZ				
FD-1	FLOOR DRAIN	JAY R SMITH	2005		1/2"	3"	2"	NICKEL BRONZE TYPE "B" ADJUSTABLE TOP. 1/2" TRAP PRIMER CONNECTION.				
FS-1	FLOOR SINK	JAY R SMITH	3009		1/2"	3"	2"	FIXTURES ROUTED TO FLOOR SINK TO HAVE MINIMUM 1" AIR GAP TO SURFACE OF FLOOR SINK.				
GAS METER HB-1	GAS METER BY OTHERS HEAVY COMMERCIAL WALL	 PRIER	 C-634BX1		3/4			24" AFF. BACKLOW PREVENTION, FREEZELESS, NICKEL LOCKING BOX				
ו -טוו	HYDRANT WITH LOCK AND KEY	TTULIT	O-034BX1		3/4			24 AIT. BAOREOWITHEVENTION, THEEZELESS, MOREE ECONING BOX				
LAV-1	COUNTERTOP LAVATORY	ZURN	Z5110	1/2"	1/2"	1-1/2"	2"	FAUCET - ZURN Z81101-XL. 4" CENTERSET. TEMPERING VALVE TO BI INCLUDED.				
LAV-2	WALL HUNG LAVATORY	ZURN	Z5350	1/2"	1/2"	1-1/2"	2"	FAUCET - ZURN Z81101-XL. 4" CENTERSET. TEMPERING VALVE TO BI				
MS-1	MOP SINK	STERN-WILLIAMS	MTB-3624			3"	2"	MOP BASIN WITH BUMPER GAURDS, MOP HANGERS, AND SS SPLASH PANELS.				
MS-2	MOP SINK FAUCET	STERN-WILLIAMS	T-10-VB	1/2"	1/2"			MOP SINK FAUCET WITH HOSE.				
OFD-1	OVERFLOW DOWNSPOUT NOZZLE	JAY R SMITH	1770			4"		24" MAX AFF. A PREFINISH METAL (COW TONGUE) DOWNSPOUT NOZZLE WITH ESCUTCHEON FITTING 4" DIAMETER PVC ELBOW. COLOR TO BE EITHER WHITE TO MATCH WHITE METAL WALL PANELS OR CLEAR ANODIZED SILVER.				
PRV-1	HIGH CAPACITY WATER PRESSURE REDUCING VALVE WITH STRAINER	WATTS	LFN223B-S		2-1/2"			SET AT 60 PSI				
RD-1	ROOF DRAIN AND OVERFLOW DRAIN	JAY R SMITH	1850			4"						
SK-1	DOUBLE BOWL SINK	ELKAY	LR4322	1/2"	1/2"	2"	2"	FAUCET TO BE - ELKAY: LKD2439BHC. TEMPERING VALVE TO BE INCLUDED.				
SK-2	SINGLE BOWL SINK	ELKAY	LRAD312265	1/2"	1/2"	2"	2"	FAUCET TO BE - ELKAY: LKD2439BHC. TEMPERING VALVE TO BE INCLUDED.				
SK-3	SINGLE BOWL SINK	ELKAY	PLA252212	1/2"	1/2"	2"	2"	FAUCET TO BE - ELKAY: LK2000CR. TEMPERING VALVE TO BE INCLUDED.				
SOLID INTERCEPTOR	SOLIDS INTERCEPTOR	ZURN	Z1180			2"	1-1/2"	INTERCEPTOR TO BE USED IN LIEU OF P-TRAP, FOR ON-FLOOR INSTALLATION.				
UR-1	URINAL	ZURN	Z5750		3/4	2"	2"	WALL MOUNTED, MANUAL FLUSH VALVE (0.5 GPF) ZURN Z60003AV-WS				
WC-1	WATER CLOSET ADA	KOHLER	4406		1"	4" 4"	3"	FLOOR MOUNTED, MANUAL FLUSH VALVE: KOHLER - K-13517				
WC-2	WATER CLOSET - ADA COMPLIANT	KOHLER	4406		1	·	3"	FLOOR MOUNTED, MANUAL FLUSH VALVE: KOHLER - K-13517				
WCO-1	EXPANABLE LINE CLEANOUT WITH WALL ACCESS COVER	JAY R. SMITH	4510			4"	3"	PROVIDE WITH STAINLESS STEEL COVER. VENT WHERE APPLICABLE				
WCO-2	EXPANABLE LINE CLEANOUT WITH WALL ACCESS COVER	JAY R. SMITH	4510			3"	2"	PROVIDE WITH STAINLESS STEEL COVER. VENT WHERE APPLICABLE				
WCO-3 WMVB-1	EXPANABLE LINE CLEANOUT WASHING MACHINE VALVE BOX	JAY R. SMITH IPS CORPORATION	4510 W4700	1/2"	1/2"	2" 2"	2" 2"	PROVIDE WITH STAINLESS STEEL COVER. VENT WHERE APPLICABLE GUY GRAY OR APPROVED EQUAL				

ELECTRIC WATER HEATER SCHEDULE													
	ENTERING LEAVING RECOVERY RATE STORAGE TANK TANK WIDTH												
MARK	MANUFACTURER	MODEL	EFF (%)	WATER TEMP	WATER TEMP	(GPH) @ 100°F	CAPACITY (GAL)	HEIGHT	/ DIAMETER	V/PH/HZ	KILOWATTS	WEIGHT	REMARKS
EWH-1	A. O. SMITH	DRE-52-15	96	50 °F	140 °F	61	50	55.25"	21.75"	208/3/60	15.0	260	

PUMP SCHEDULE											
MARK	MANUFACTURER	MODEL	SERVICE	PUMP TYPE	FLOW RATE	DISCH HEAD (FT)	RPM	MOTOR STARTER	POWER	V/PH/HZ	REMARKS
CP-1	Bell & Gossett	NBF-45	HW RECIRCULATION	IN-LINE CIRCULATOR	5 GPM	15	3300	INTERGRAL	270 W	115/1/60	1

REMARKS:

1. PROVIDE TIME CLOCK/TIMER TO OPERATE DURING OCCUPIED PERIODS.

EXPANSION TANK SCHEDULE											
MARK	MARK MANUFACTURER MODEL SERVICE ORIENTATION TYPE (GAL) VOLUME (GAL) PRE-CHARGE PRE-CHARGE VOLUME (GAL) PRESSURE (PSI) REMARKS										
EXT-1	WATTS	DETA 5	HOT WATER	VERTICAL	BLADDER	3.5	2.3	40	CONNECT TO EWH-1		


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SHEET TITLE: ISOMETRIC - SANITARY


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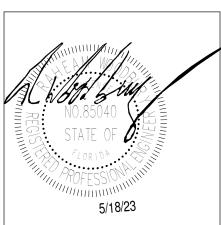
KEYPLAN N.T.S.

P601



ISOMETRIC -SANITARY
NTS

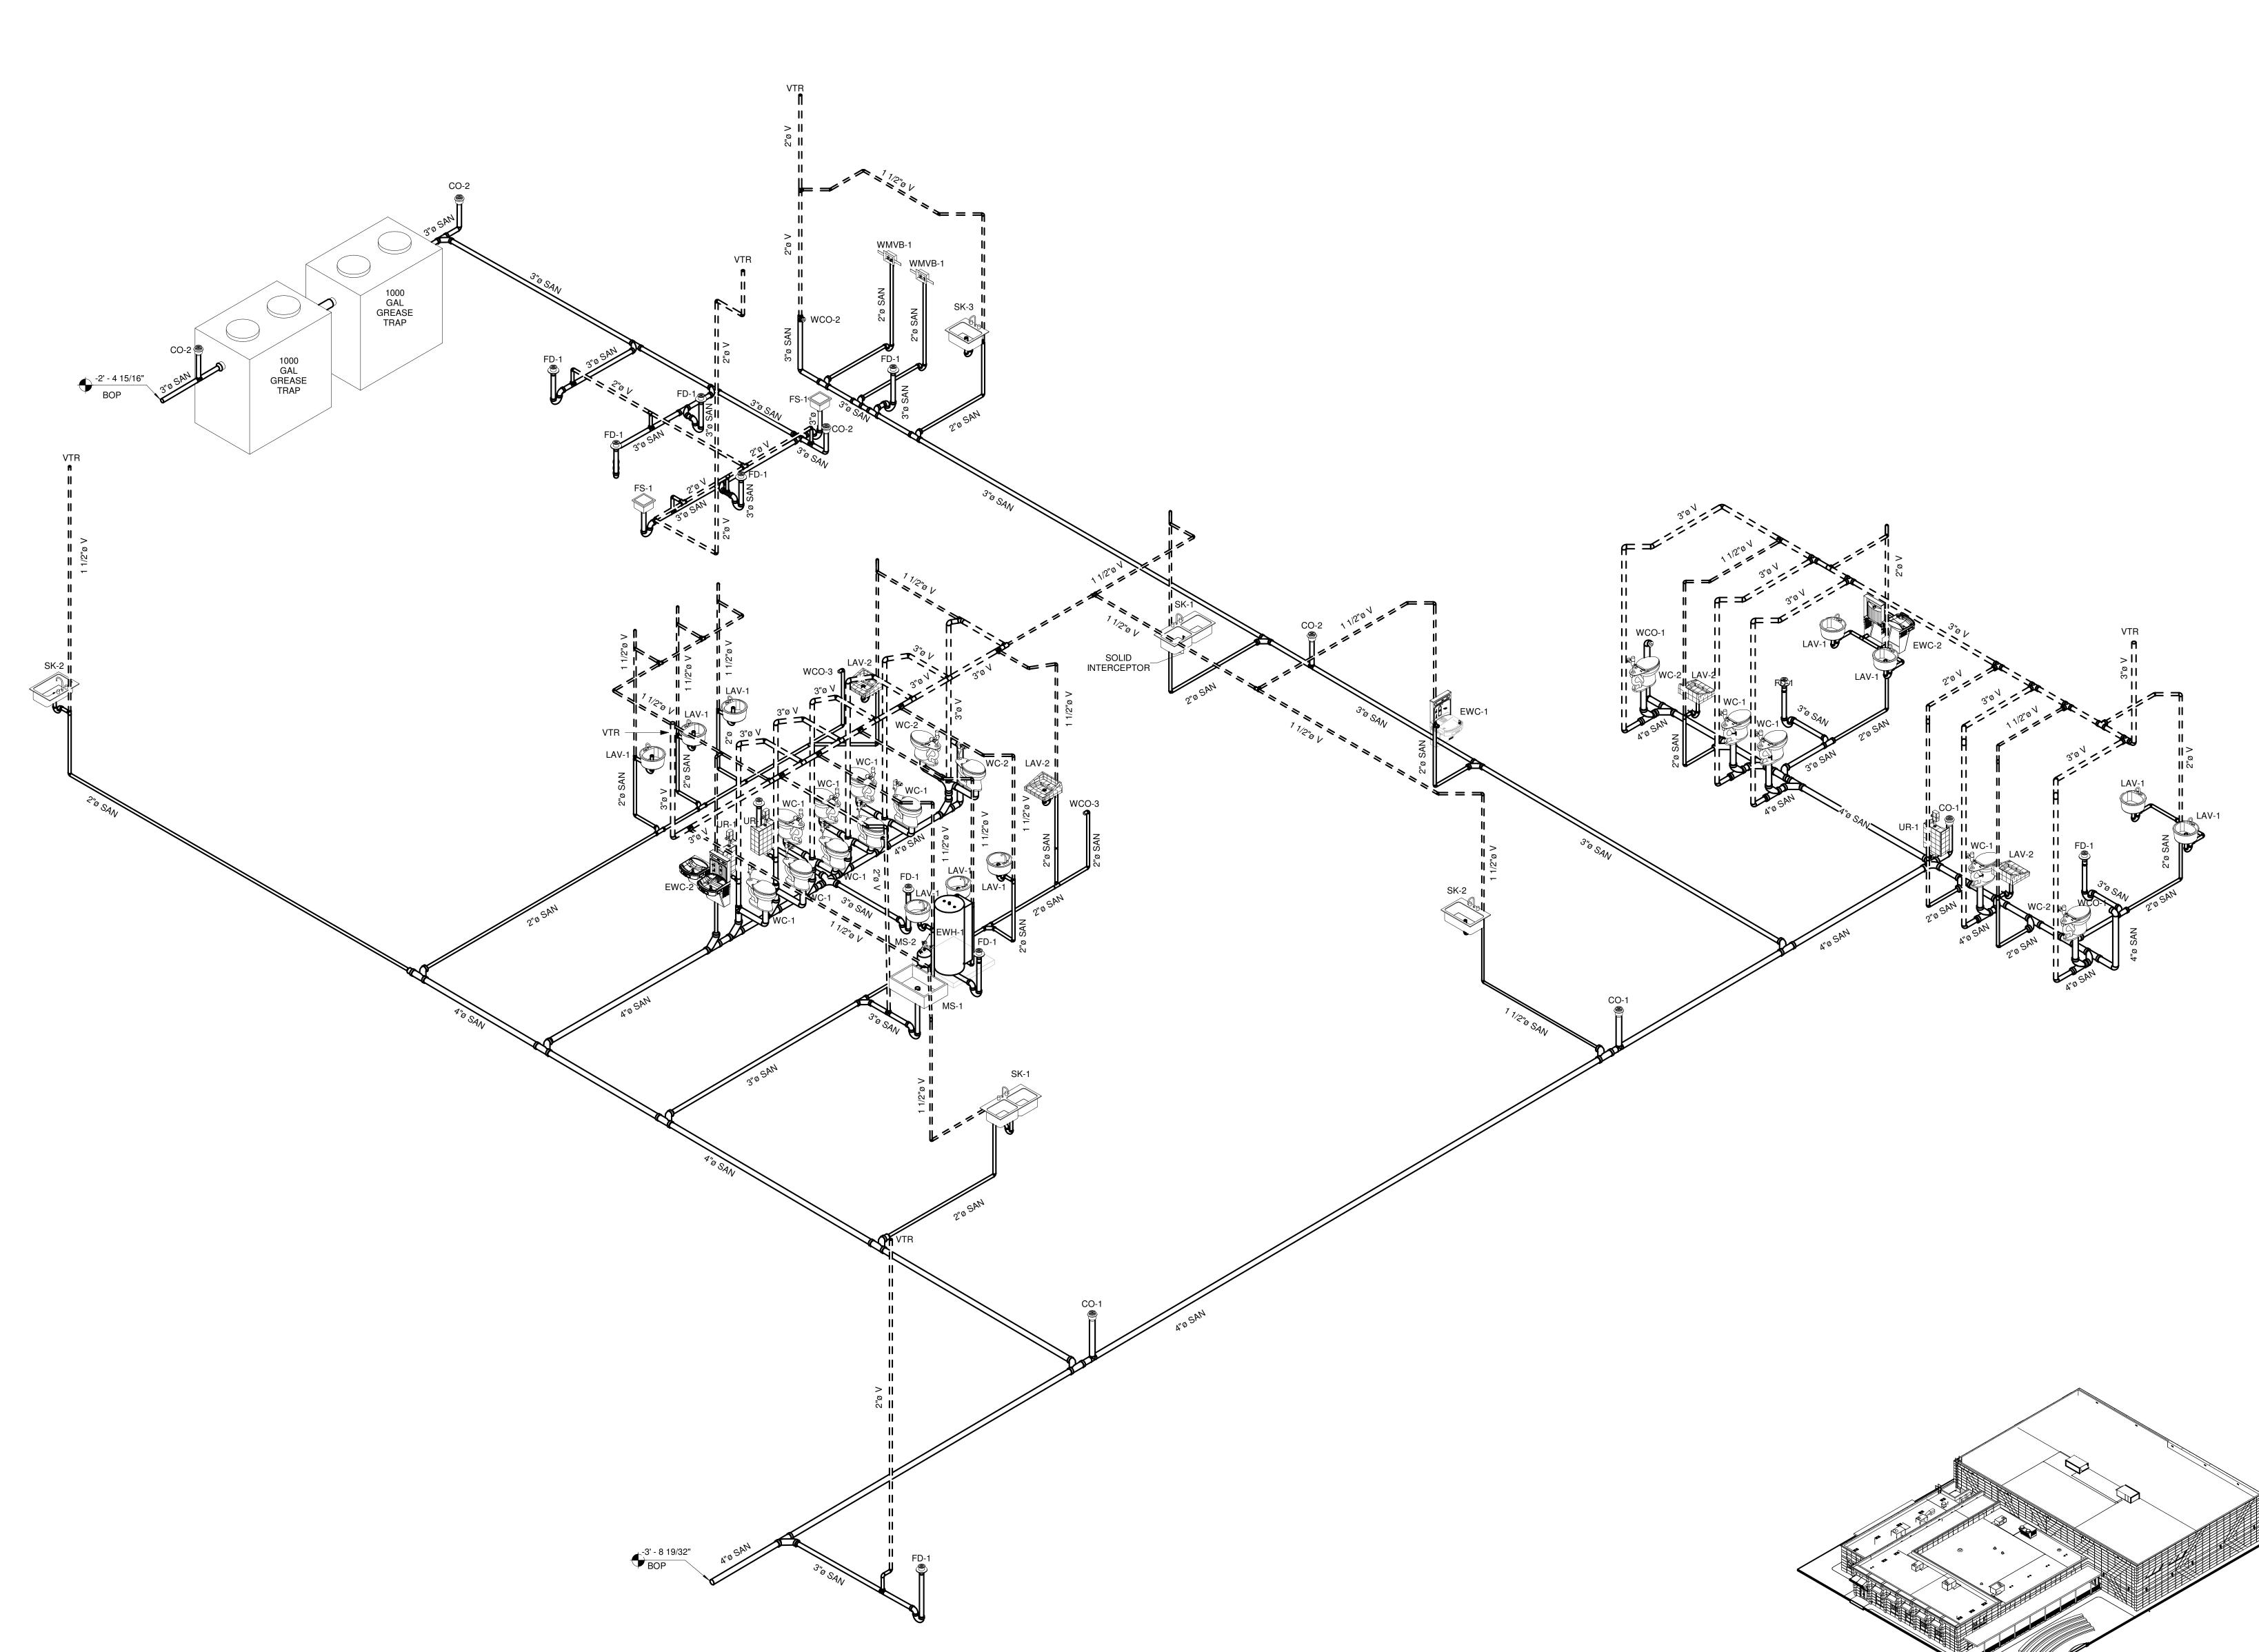

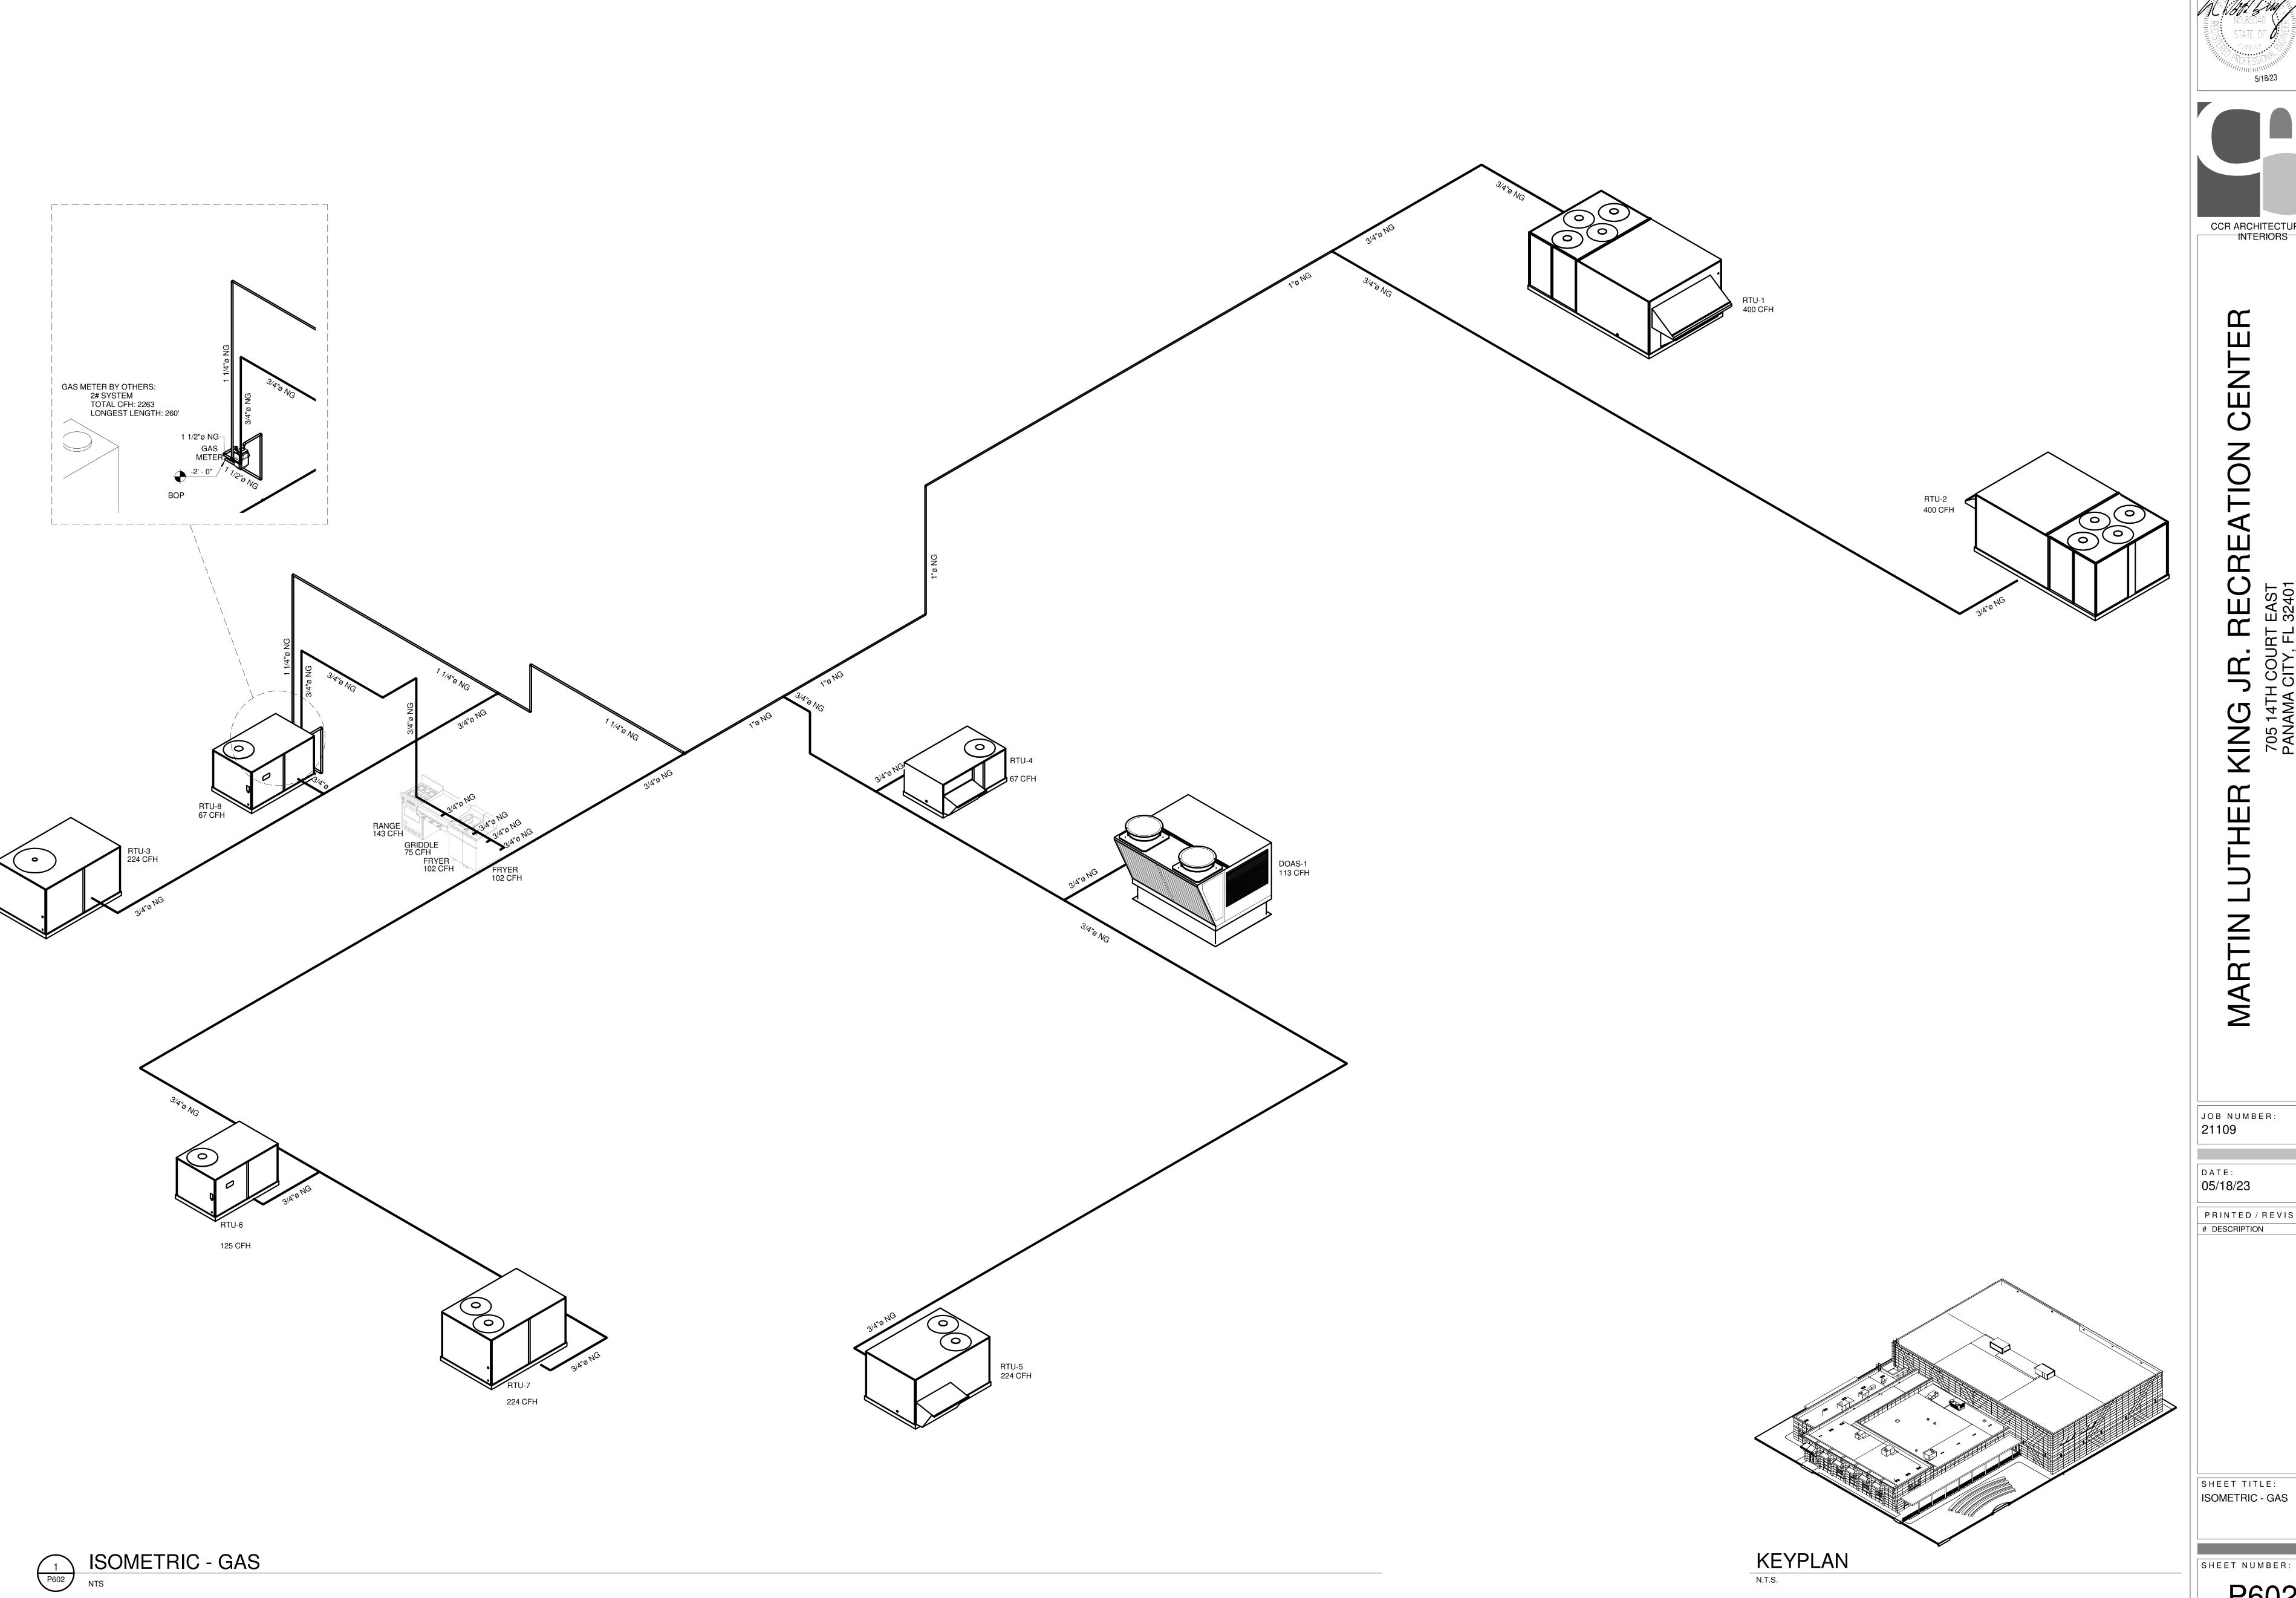



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SHEET TITLE: ISOMETRIC - GAS

P602