

NOTE:
11" x 17" SHEETS ARE PLOTTED AT 1/2
THE SCALE NOTED ON THESE DRAWINGS

**FSU TURNBULL
CONFERENCE CENTER
RENOVATIONS**

REV	DATE	DESCRIPTION

PROJECT PHASE
CONSTRUCTION DOCUMENTS

DATE
18 OCTOBER 2023

DRAWN BY
RMP/BI

PROJECT NO
74000


CHECKED BY
BI/RMP

SHEET TITLE

**FIRST FLOOR PLAN-
MEASURED DRAWINGS-
EXISTING**


SHEET NO
A100.1

REV NO

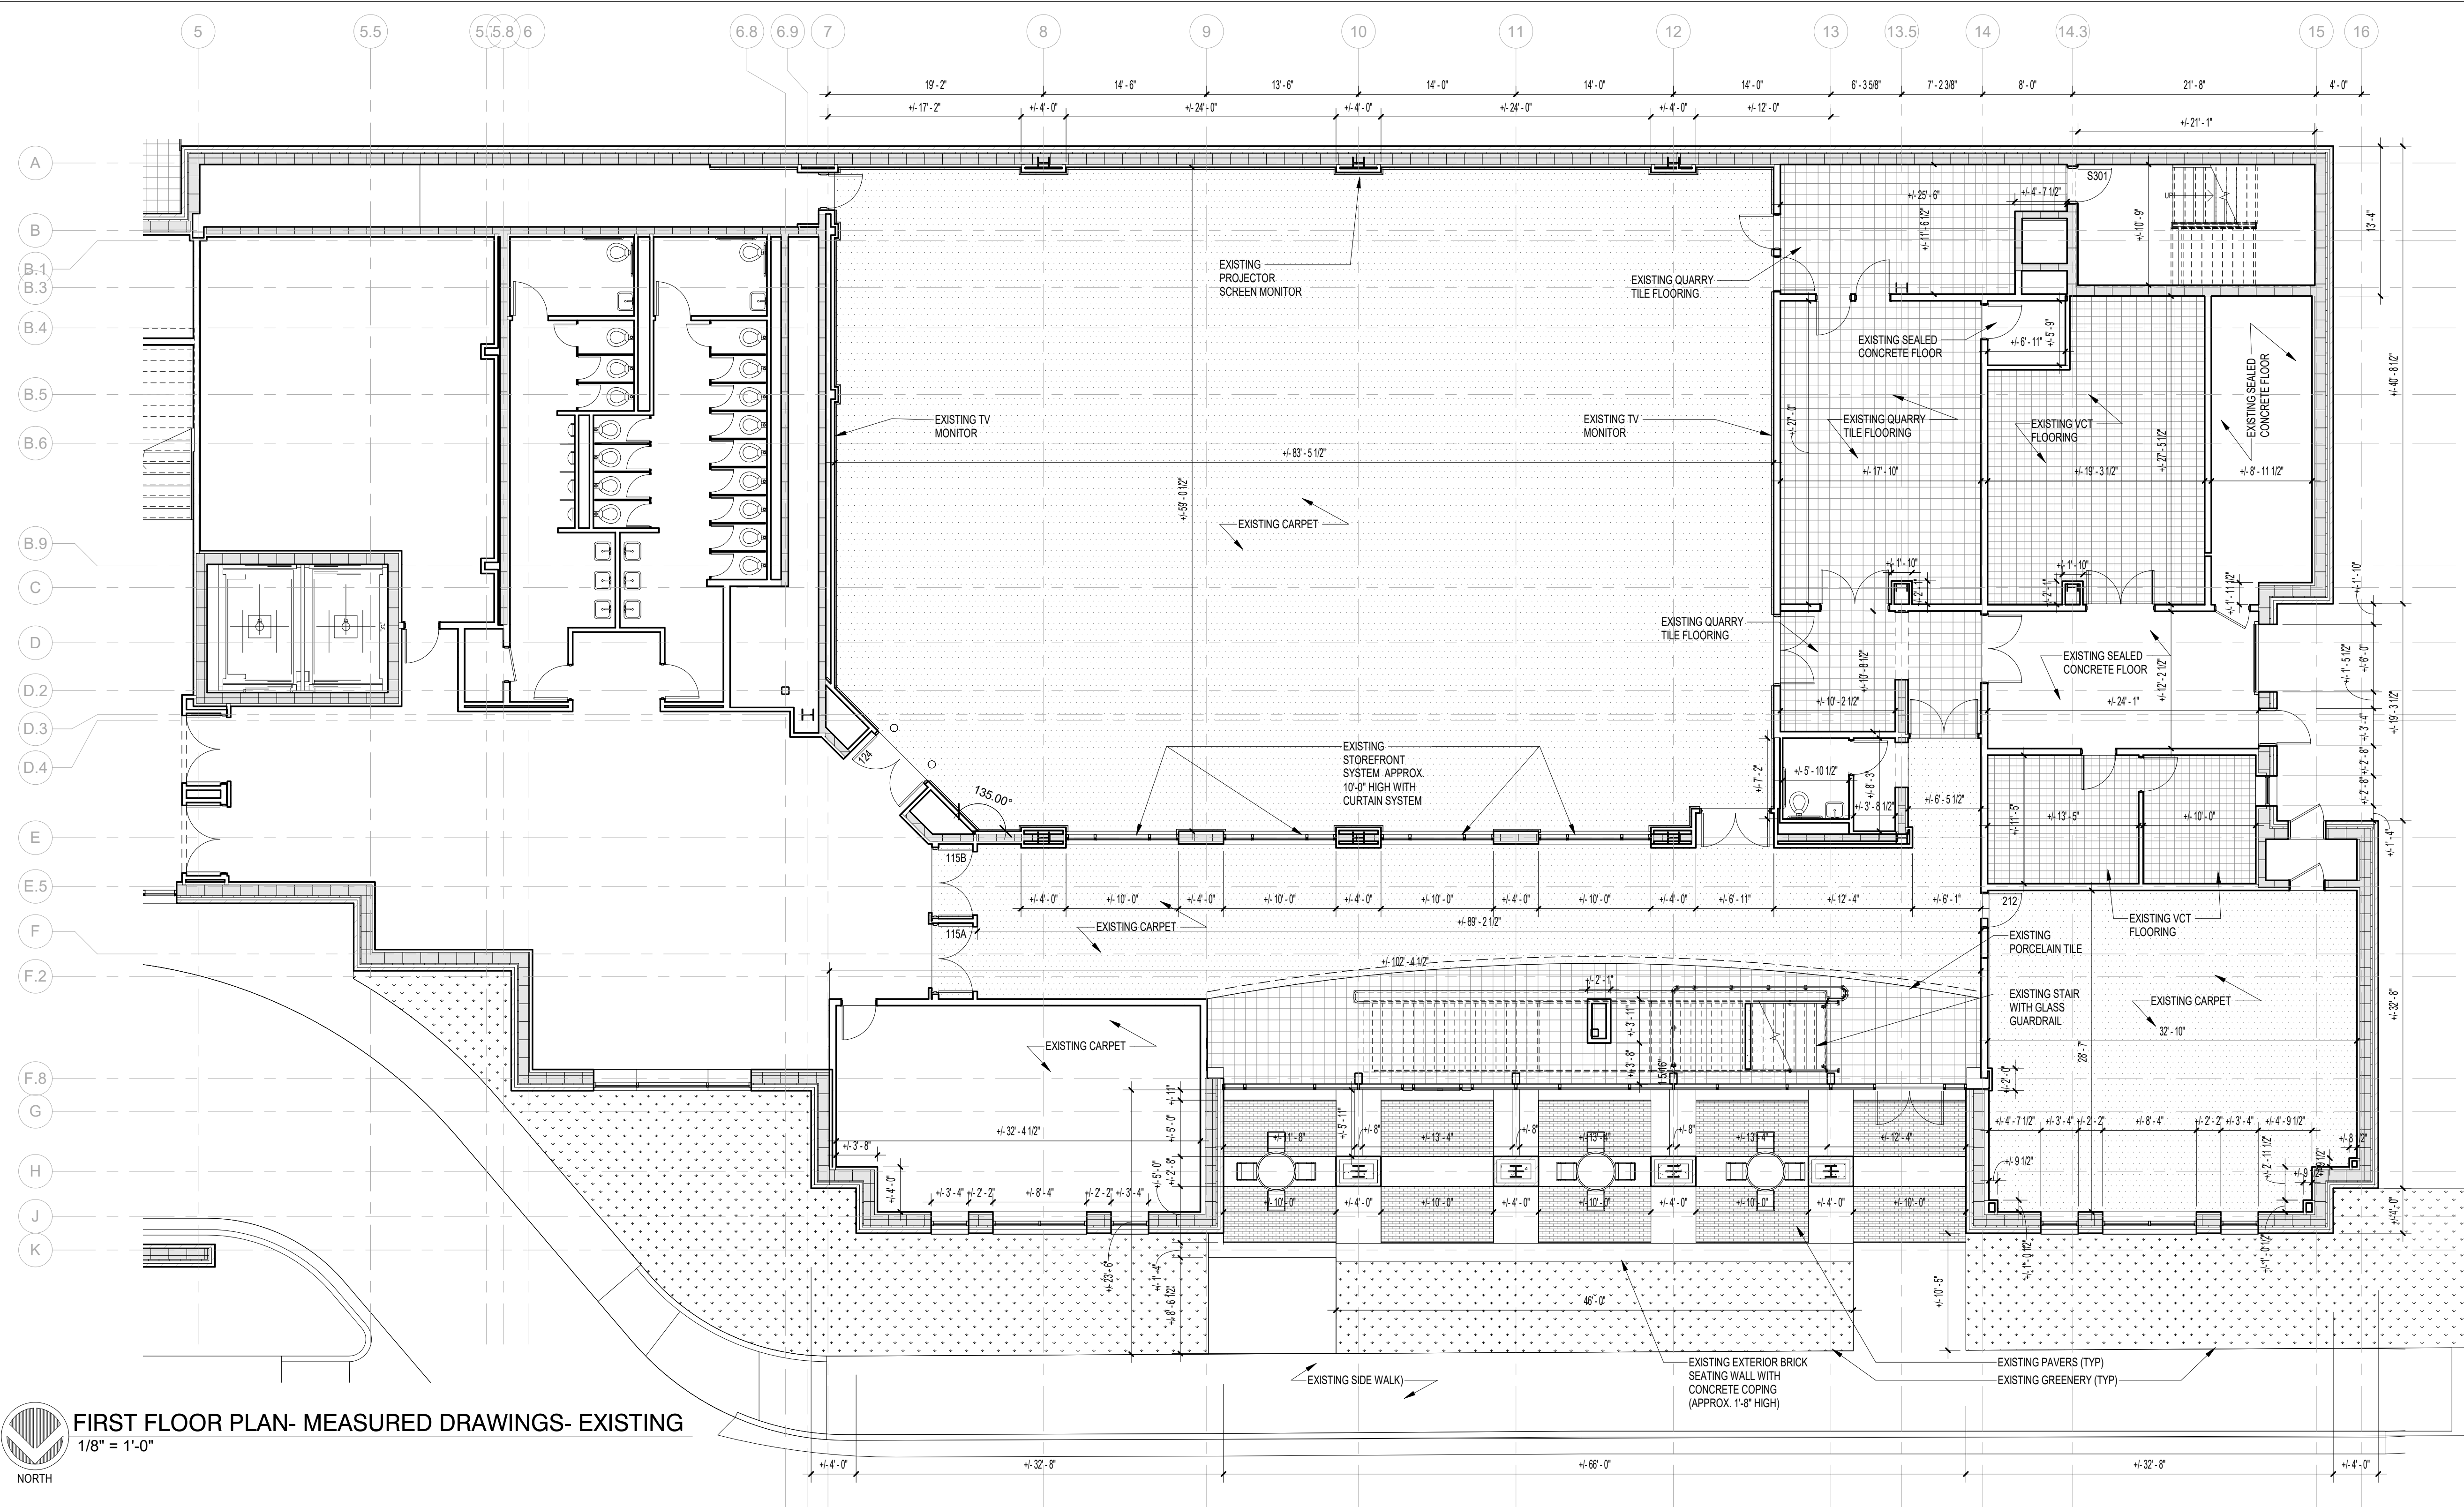

FIRST FLOOR PLAN- MEASURED DRAWINGS- EXISTING
1/8" = 1'-0"
NORTH

DOOR COORDINATION NOTE:
NUMBERED DOORS ON EXISTING DRAWINGS ARE SCHEDULED FOR "RE-USE". SEE NEW WORK
PLAN AND DOOR SCHEDULE FOR LOCATIONS

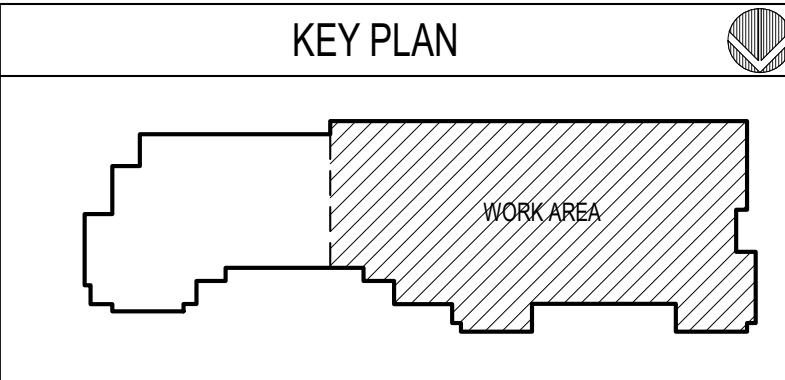

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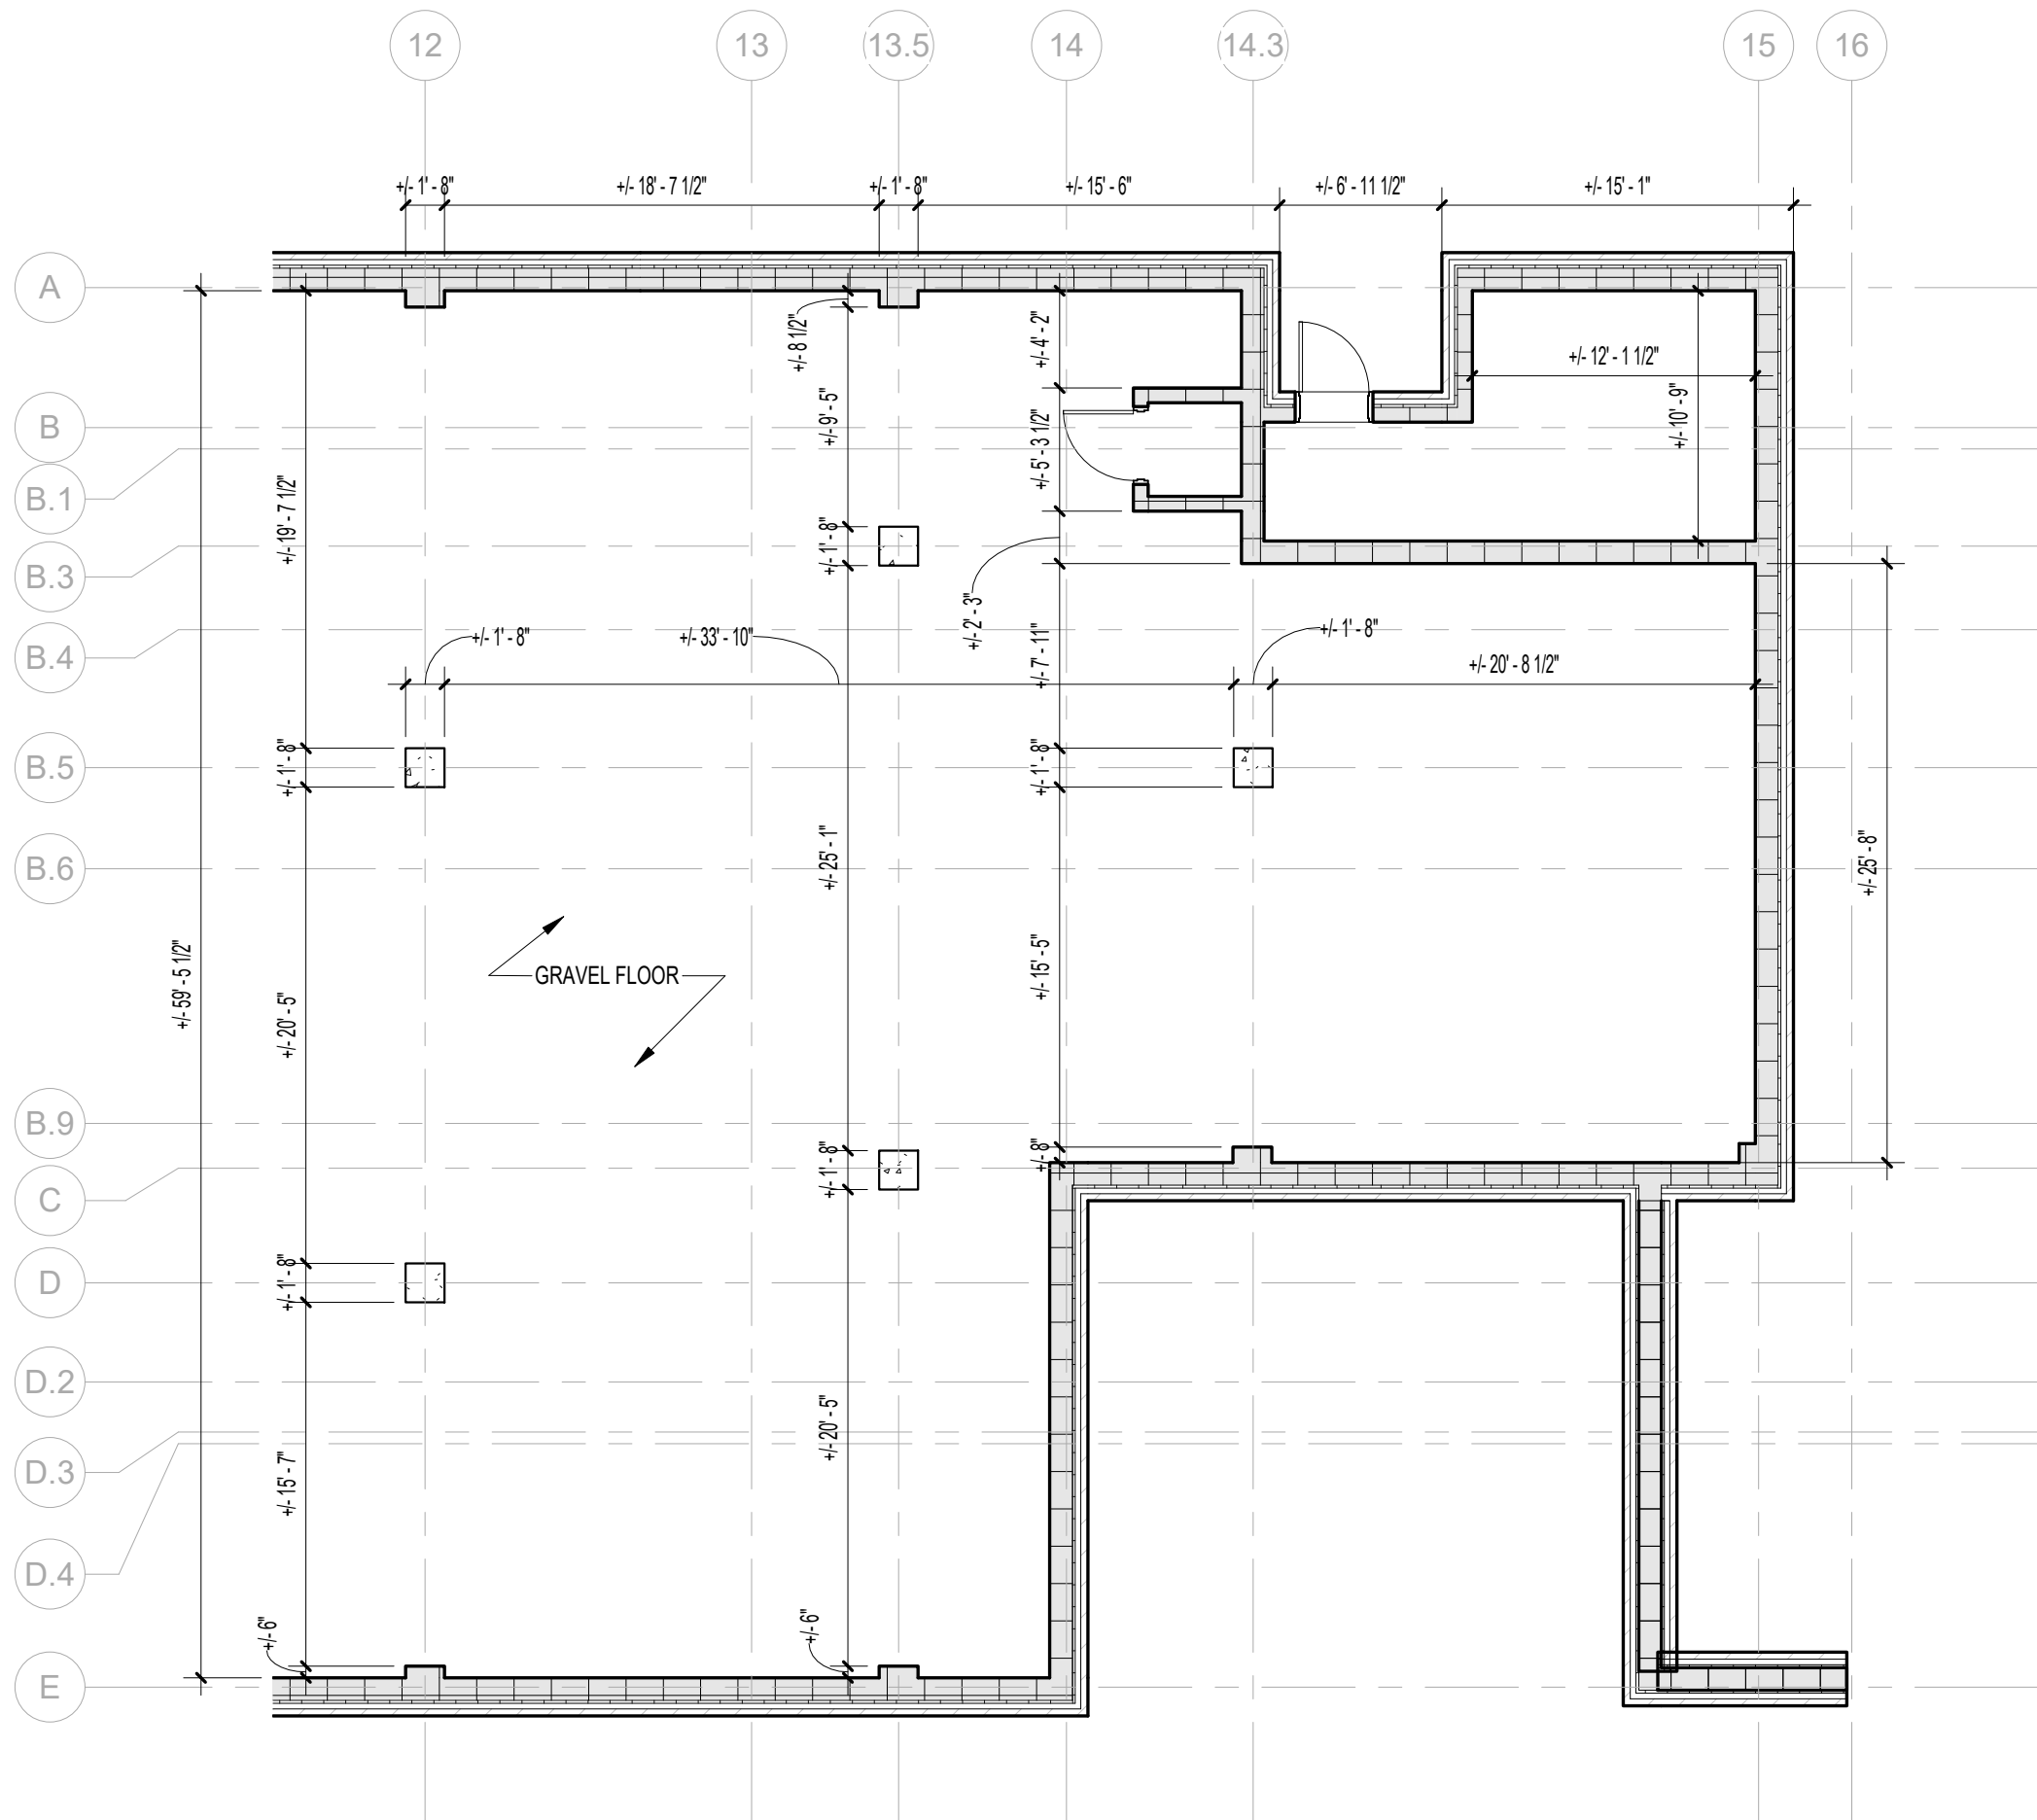
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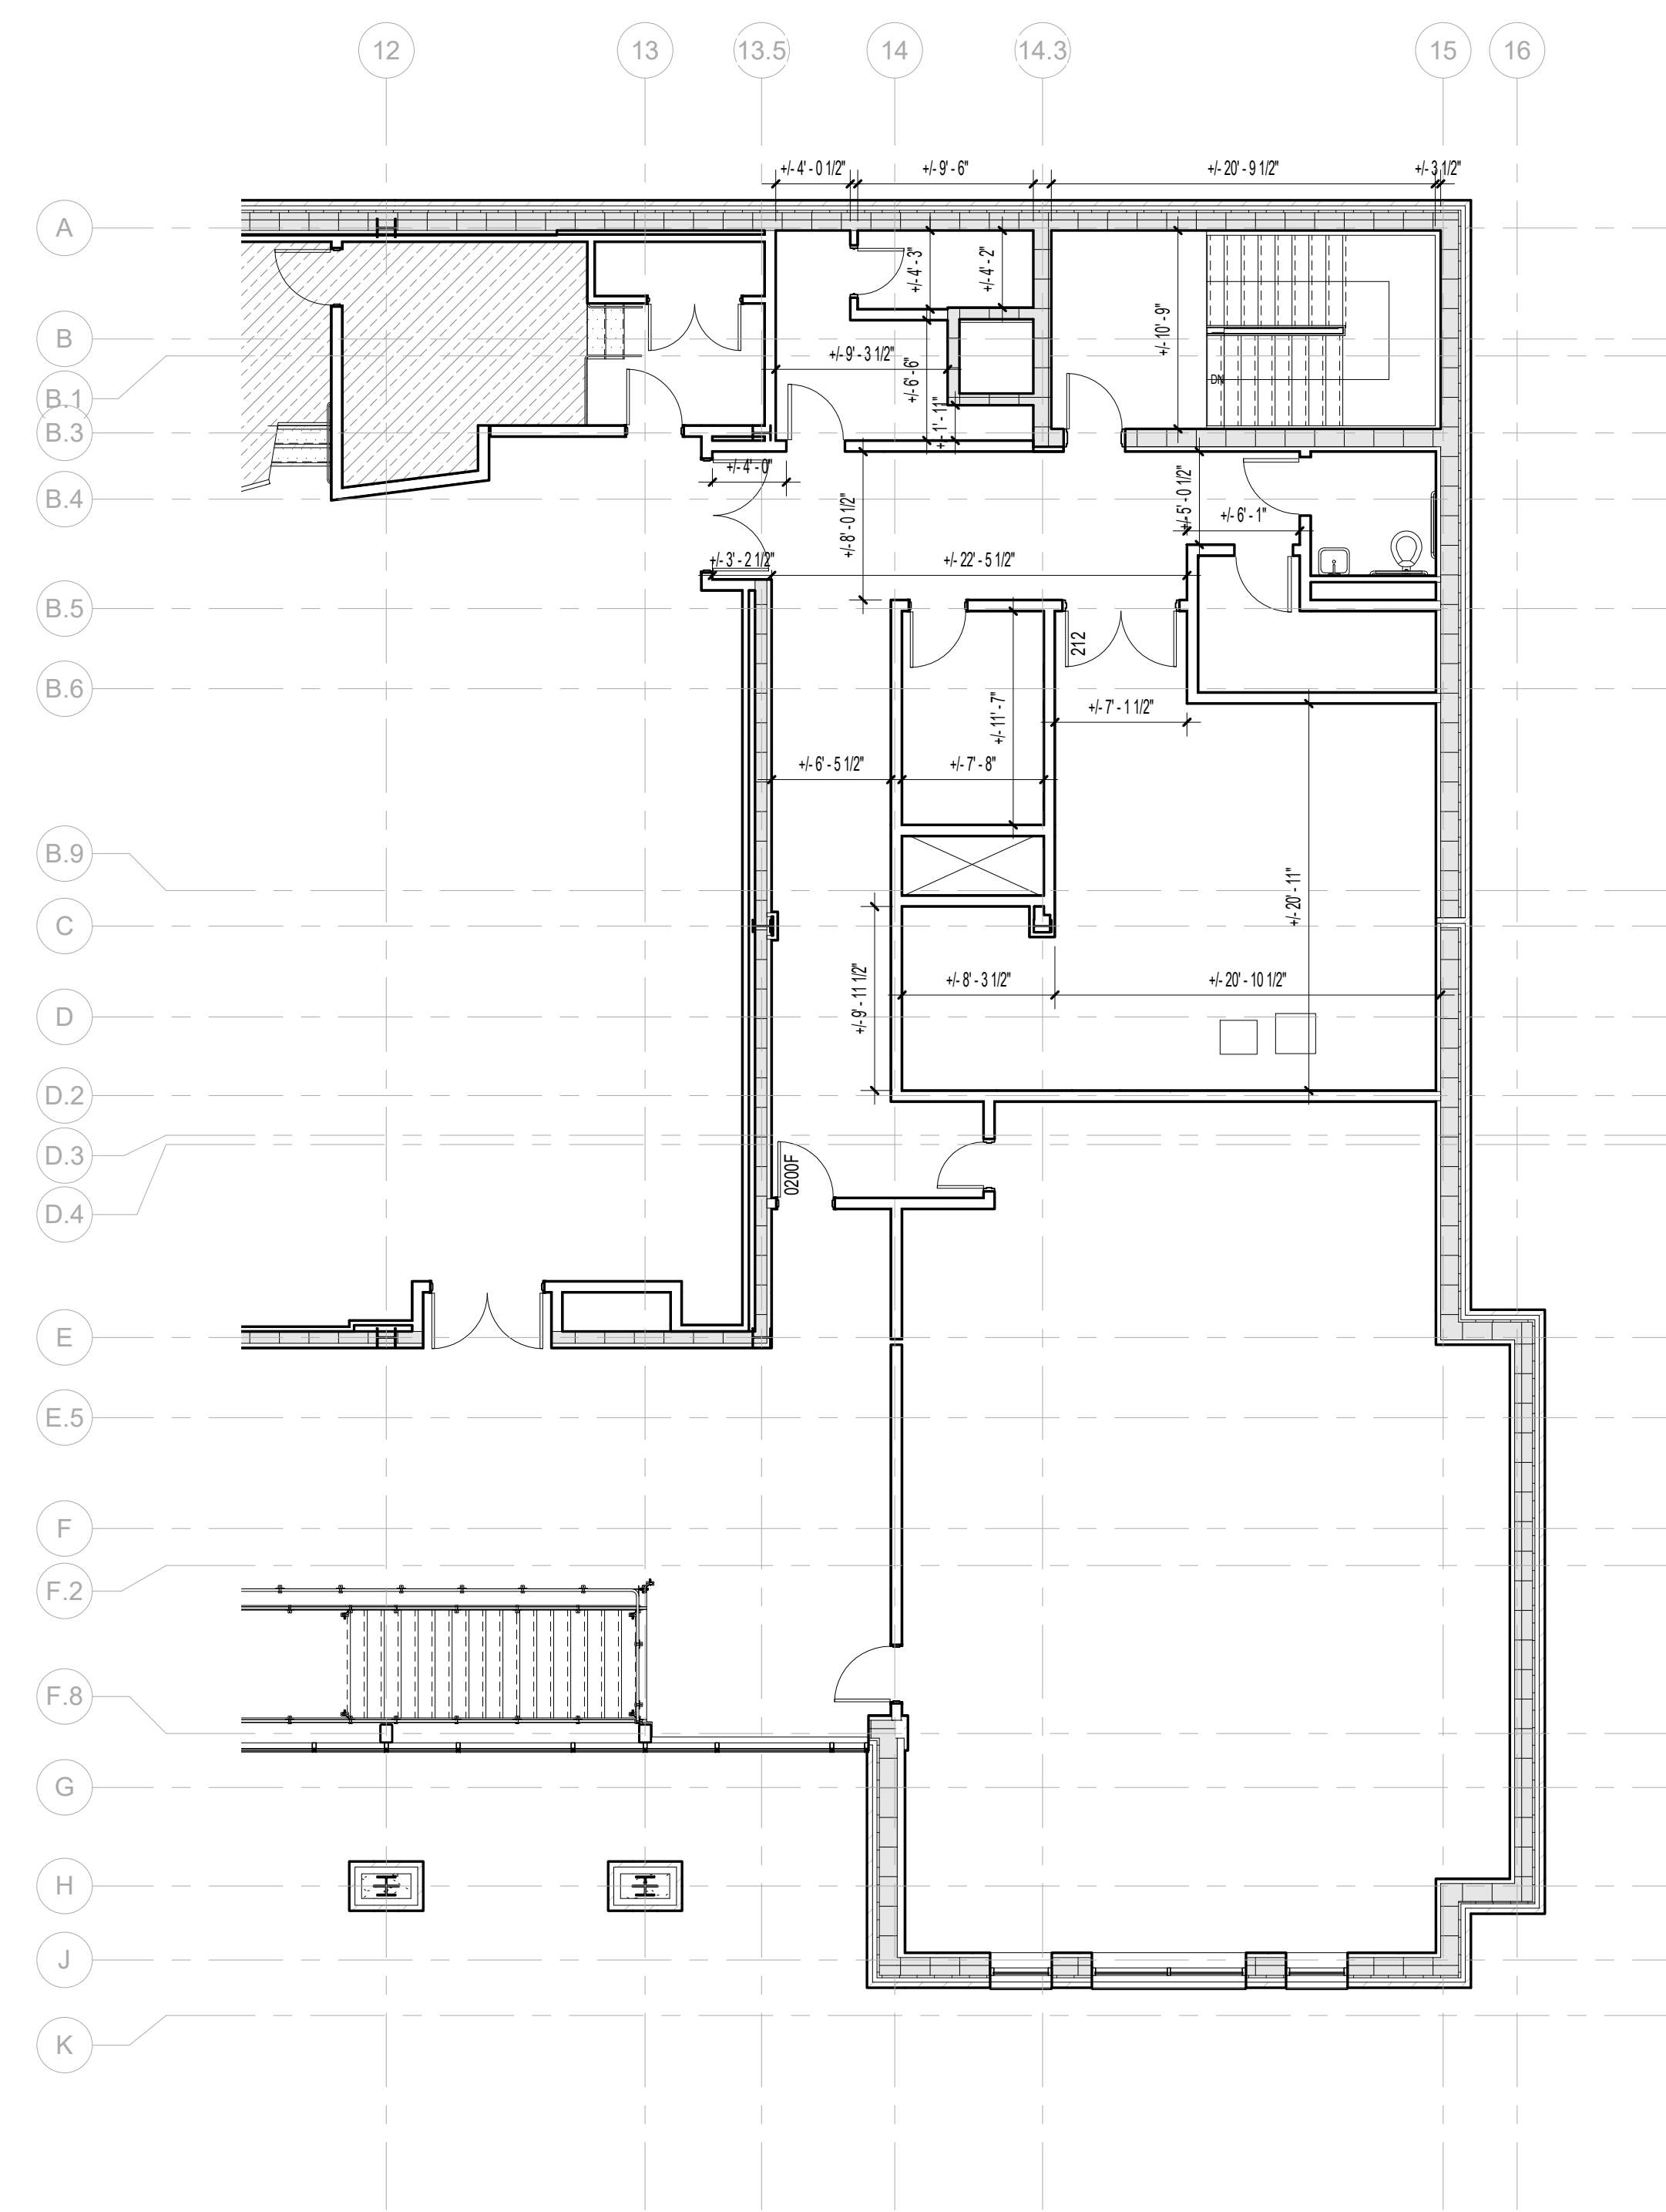
**LOWER LEVEL/SECOND
FLOOR PLAN-
MEASURED DRAWINGS**

SHEET NO
A100.2

REV NO




LOWER LEVEL PLAN- MEASURED DRAWINGS- EXISTING
1/8" = 1'-0"
NORTH




SECOND FLOOR PLAN- MEASURED DRAWINGS- EXISTING
1/8" = 1'-0"
NORTH

DOOR COORDINATION NOTE:
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PLAN AND DOOR SCHEDULE FOR LOCATIONS

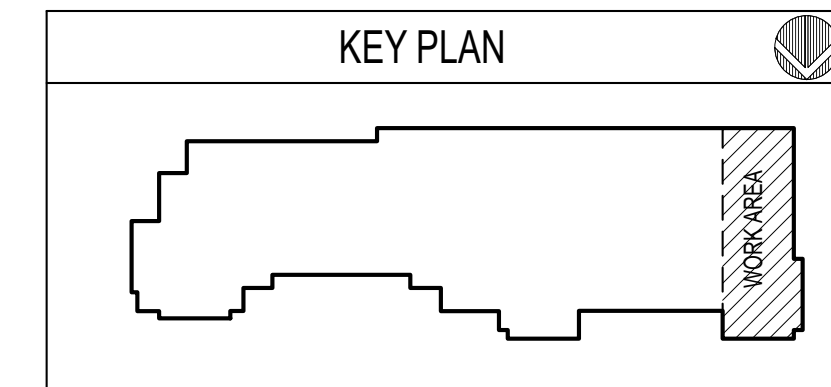


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FSU TURNBULL
CONFERENCE CENTER
RENOVATIONS

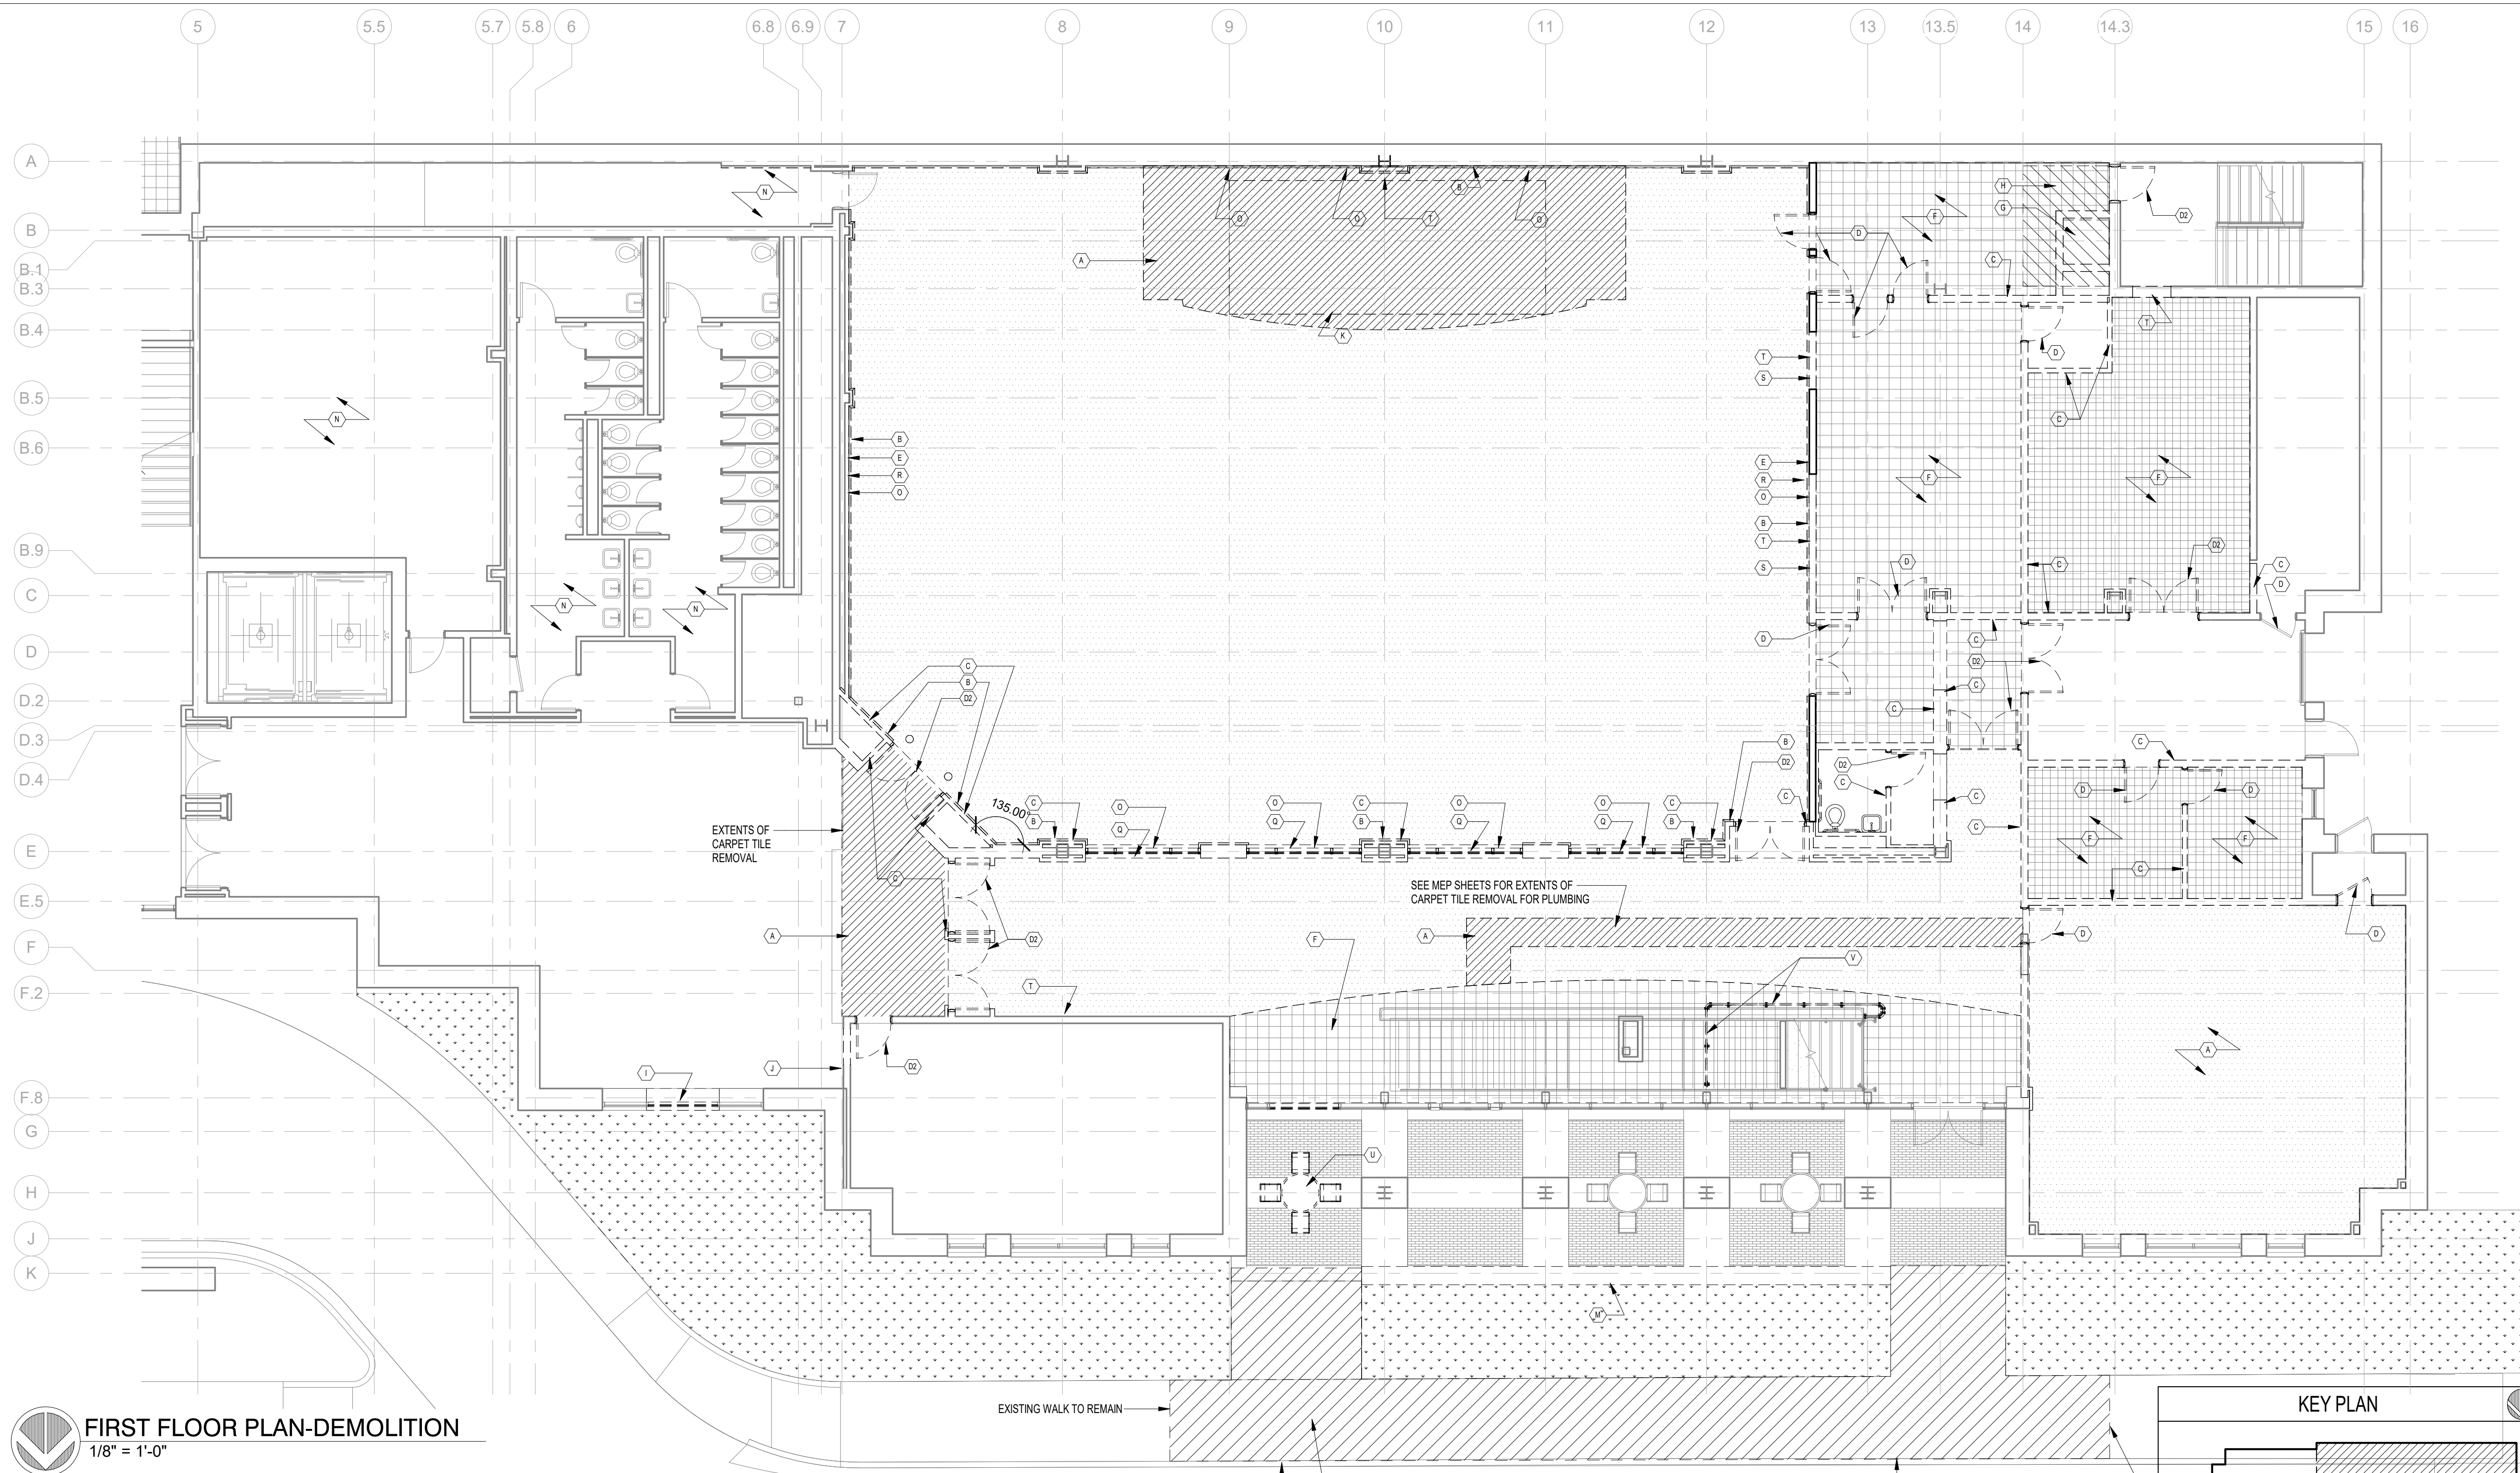

FIRST FLOOR PLAN-DEMOLITION
1/8" = 1'-0"
NORTH

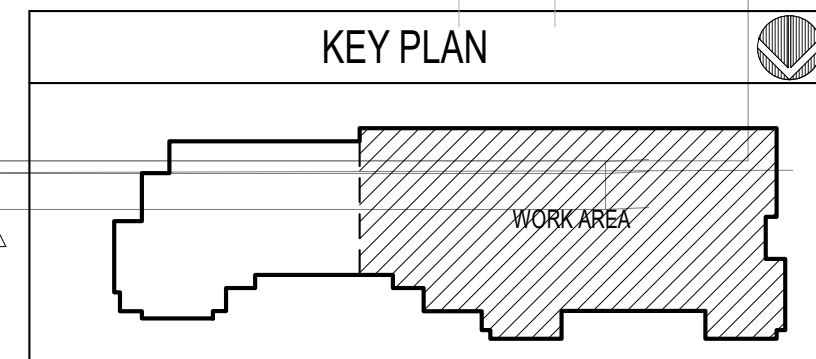

NOTE:
DEMOLITION NOTES INDICATE GENERAL AREA AND EXTENTS OF ITEMS TO BE REMOVED. IT IS THE CONTRACTOR'S RESPONSIBILITY TO VISIT THE SITE AND DETERMINE EXACT EXTENTS OF DEMOLITION WORK PRIOR TO SUBMITTING A PROPOSAL FOR THE COST OF THE WORK (TYP)

GENERAL DEMOLITION NOTES


- DEMOLITION NECESSARY AS A RESULT OF MEP WORK IS GENERALLY NOT INDICATED ON THE ARCHITECTURAL DRAWINGS. CONTRACTOR SHALL COORDINATE AND INCLUDE DEMOLITION WORK ASSOCIATED WITH MECHANICAL, PLUMBING AND ELECTRICAL DRAWINGS AND SPECIFICATIONS. COORDINATE DISCONNECTION AND ABANDONMENT OF ELECTRICAL, PLUMBING WASTE AND SUPPLY GAS AND OTHER UTILITIES WITH MECHANICAL, ELECTRICAL, AND PLUMBING DEMOLITION PLANS. COMPLY WITH APPLICABLE CODES FOR TERMINATION OF ALL UTILITIES.
- COORDINATE DEMOLITION OF EXISTING FIRE ALARM DEVICES WITH FIRE ALARM CONTRACTOR.
- REMOVE LOOSE AND FLAKING PAINT FROM EXISTING WALL AND HOLLOW METAL FRAME SURFACES SCHEDULED TO REMAIN AND PREP FOR NEW FINISH.
- ABANDONED FLOOR PENETRATIONS OF ELECTRICAL, PLUMBING EQUIPMENT, ANCHORS AND SIMILAR ITEMS SHALL BE REMOVED, CAPPED OR CUT OFF BELOW THE LEVEL OF NEW FINISHED FLOOR. FLOOR SHALL BE PATCHED TO RECEIVE NEW FLOOR FINISHES.
- EXISTING FIRE EXTINGUISHERS AND FIRE EXTINGUISHER CABINETS TO REMAIN.
- REMOVE DEMOLITION DEBRIS FROM SITE. DISPOSE IN ACCORDANCE WITH APPLICABLE LAWS AND REGULATIONS.
- COORDINATE PATCHING, INFILL, NEW CONSTRUCTION WITH DEMOLITION NOTES AND NEW WORK NOTES ON OTHER ARCHITECTURAL DRAWINGS.
- PATCH ABANDONED ROOF AND WALL PENETRATIONS IMMEDIATELY UPON REMOVAL OF EQUIPMENT TO WEATHERPROOF BUILDINGS.
- WHEN REMOVING ITEMS ATTACHED TO FINISH SURFACES TO REMAIN AND BE EXPOSED TO VIEW, REMOVE ALL EVIDENCE OF FASTENERS.
- WHERE REMOVAL OF EXISTING THRU WALL EQUIPMENT, LOUVERS, PIPING AND SIMILAR ITEMS IS NECESSARY, THE CONTRACTOR SHALL INFILL, PATCH AND MAKE WEATHERTIGHT ABANDONED WALL OPENINGS. FINISH BOTH INTERIOR AND EXTERIOR FINISH SURFACES TO MATCH EXISTING CONDITIONS. WEATHERPROOF THE OPENING IMMEDIATELY UPON REMOVAL OF THE DEMOLISHED ITEM.
- WHERE MISCELLANEOUS EXTERIOR MECHANICAL EQUIPMENT IS REMOVED, BUT NOT REPLACED, REMOVE ABANDONED CONCRETE EQUIPMENT PADS. RESTORE DISTURBED AREAS TO MATCH ADJACENT SURFACES.
- CONTRACTOR SHALL PROTECT ITEMS SCHEDULED TO REMAIN.
- OWNER WILL REMOVE AND RELOCATE MOVEABLE ITEMS OF VALUE, SUCH AS CHAIRS, DESKS, COMPUTERS, CLOCKS, MIRRORS, POSTERS, PICTURES, FLAGS, PROJECTION SCREENS, SUPPLIES, TABLES, CURTAINS, CURTAIN RODS, MICROWAVES, CURBIES, SHELVES AND ACTIVE BOARDS, ETC., EXCEPT AS SPECIFICALLY NOTED OTHERWISE. OWNER WILL PROVIDE STORAGE AS NECESSARY TO ACCOMMODATE OWNERS FURNISHINGS FOR DURATION OF PROJECT.

DEMOLITION NOTES: FLOOR PLAN


- (A) REMOVE CARPET TILES AS REQUIRED TO INSTALL NEW INTERIOR PARTITIONS. STORE SALVAGEABLE CARPET TILES FOR REINSTALLATION. PATCH AND OTHERWISE REPAIR ANY IRREGULARITIES IN EXISTING SUBSTRATE AS REQUIRED TO PREPARE FOR INSTALLATION OF NEW FLOOR FINISHES
- (B) REMOVE & DISPOSE OF PERIMETER WOOD WAINSCOT.
- (C) REMOVE & DISPOSE OF GWB AND METAL STUD PARTITION. PATCH GWB CEILING AS NECESSARY.
- (D) REMOVE & DISPOSE OF EXISTING DOOR, HINGES, HARDWARE, AND FRAME
- (DD) REMOVE EXISTING DOOR, HINGES AND ASSOCIATED HARDWARE TO BE REUSED. SEE NOTE ON SHEET A100.1 AND A100.2.
- (E) REMOVE AV SCREENS AND EQUIPMENT (REMOVAL BY CAPD STAFF)
- (F) REMOVE & DISPOSE OF EXISTING FLOOR FINISHES. PATCH AND/OR OTHERWISE REPAIR ANY IRREGULARITIES IN EXISTING SUBSTRATE AS REQUIRED TO PREPARE FOR PROPER INSTALLATION OF NEW FLOOR FINISHES
- (G) REMOVE EXISTING DUMBWAITER AND RETURN TO OWNER. REMOVE AND DISPOSE OF DUMBWAITER ENCLOSURE (CMU PARTITIONS)
- (H) REMOVE AND DISPOSE OF EXISTING CONCRETE FLOOR SLAB AS REQUIRED FOR INSTALLATION OF NEW FREIGHT ELEVATOR. EXTENTS OF DEMOLITION TO BE DETERMINED BY REQUIREMENTS OF NEW FREIGHT ELEVATOR HOISTWAY.
- (I) REMOVE AND DISPOSE OF EXISTING CURTAINWALL SYSTEM, GLAZING AND MULLIONS AS REQUIRED TO ACCOMMODATE FUTURE DOOR.
- (J) REMOVE & DISPOSE OF BASEBOARD.
- (K) REMOVE & DISPOSE OF EXISTING STAGE
- (L) REMOVE AND DISPOSE OF EXISTING CONCRETE SLAB AS REQUIRED TO ACCOMMODATE NEW FLOOR FINISHES. COORDINATE WITH STRUCTURAL & MEP FOR EXACT LOCATION AND SIZES
- (M) REMOVE AND DISPOSE OF EXISTING BRICK BENCH WITH PRECAST CAP. REPAIR EDGE OF PAVERS (AND/OR REPLACE) AS REQ. COORDINATE WITH NEW WORK AS SHOWN ON SHEET A105.
- (N) NO WORK IN THIS ROOM.
- (O) REMOVE AND DISPOSE OF EXISTING CURTAINS
- (P) REMOVE AND DISPOSE OF EXISTING CASED OPENING AND TRIM
- (Q) REMOVE AND DISPOSE OF EXISTING INTERIOR STOREFRONT SYSTEM
- (R) REMOVE AND DISPOSE OF EXISTING PLYWOOD SCREEN MOUNTING BOARD.
- (S) REMOVE & DISPOSE OF GWB AND METAL STUDS IN AREA FOR NEW OPENING AND PATCH ADJACENT GWB FINISH AS NECESSARY. SEE DOOR AND WINDOW ELEVATIONS FOR EXTENTS OF DEMOLITION.
- (T) REMOVE EXISTING PROJECTOR SCREEN AND ANY ADDITIONAL AV ACCESSORIES (REMOVAL BY CAPD STAFF)
- (U) REMOVE AND RETURN TO OWNER EXISTING CAROUSEL BENCH. PATCH EXISTING CONCRETE AND PAVERS AS REQUIRED.
- (V) REMOVE AND DISPOSE OF STAIR GUARDRAIL EXTENSION. PATCH AND OTHERWISE REPAIR ANY IRREGULARITIES IN EXISTING SUBSTRATE AS REQUIRED TO PREPARE FOR INSTALLATION OF NEW FLOOR FINISHES. CONFIRM OWNER DOES NOT WANT TO SALVAGE GUARDRAIL PRIOR TO DISPOSAL PROCESS.
- (W) REMOVE AND DISPOSE OF CMU PARTITIONS AS REQUIRED TO ACCOMMODATE NEW DOOR AND DOOR FRAME. PATCH CMU.

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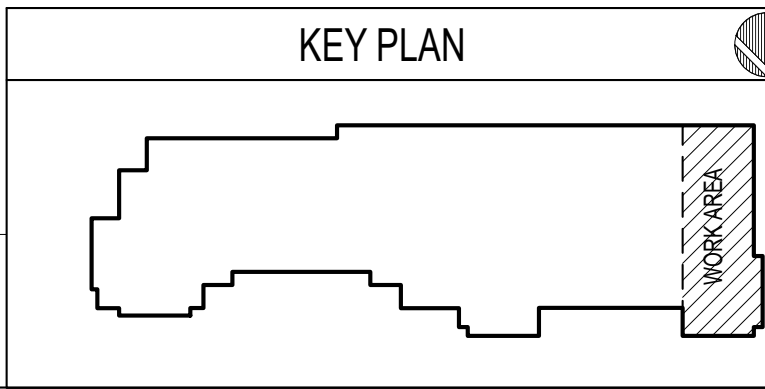
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PROJECT NO	CHECKED BY
74000	BI/RMP
SHEET TITLE	
FIRST FLOOR - DEMOLITION PLAN	
SHEET NO	REV NO
A101.1	

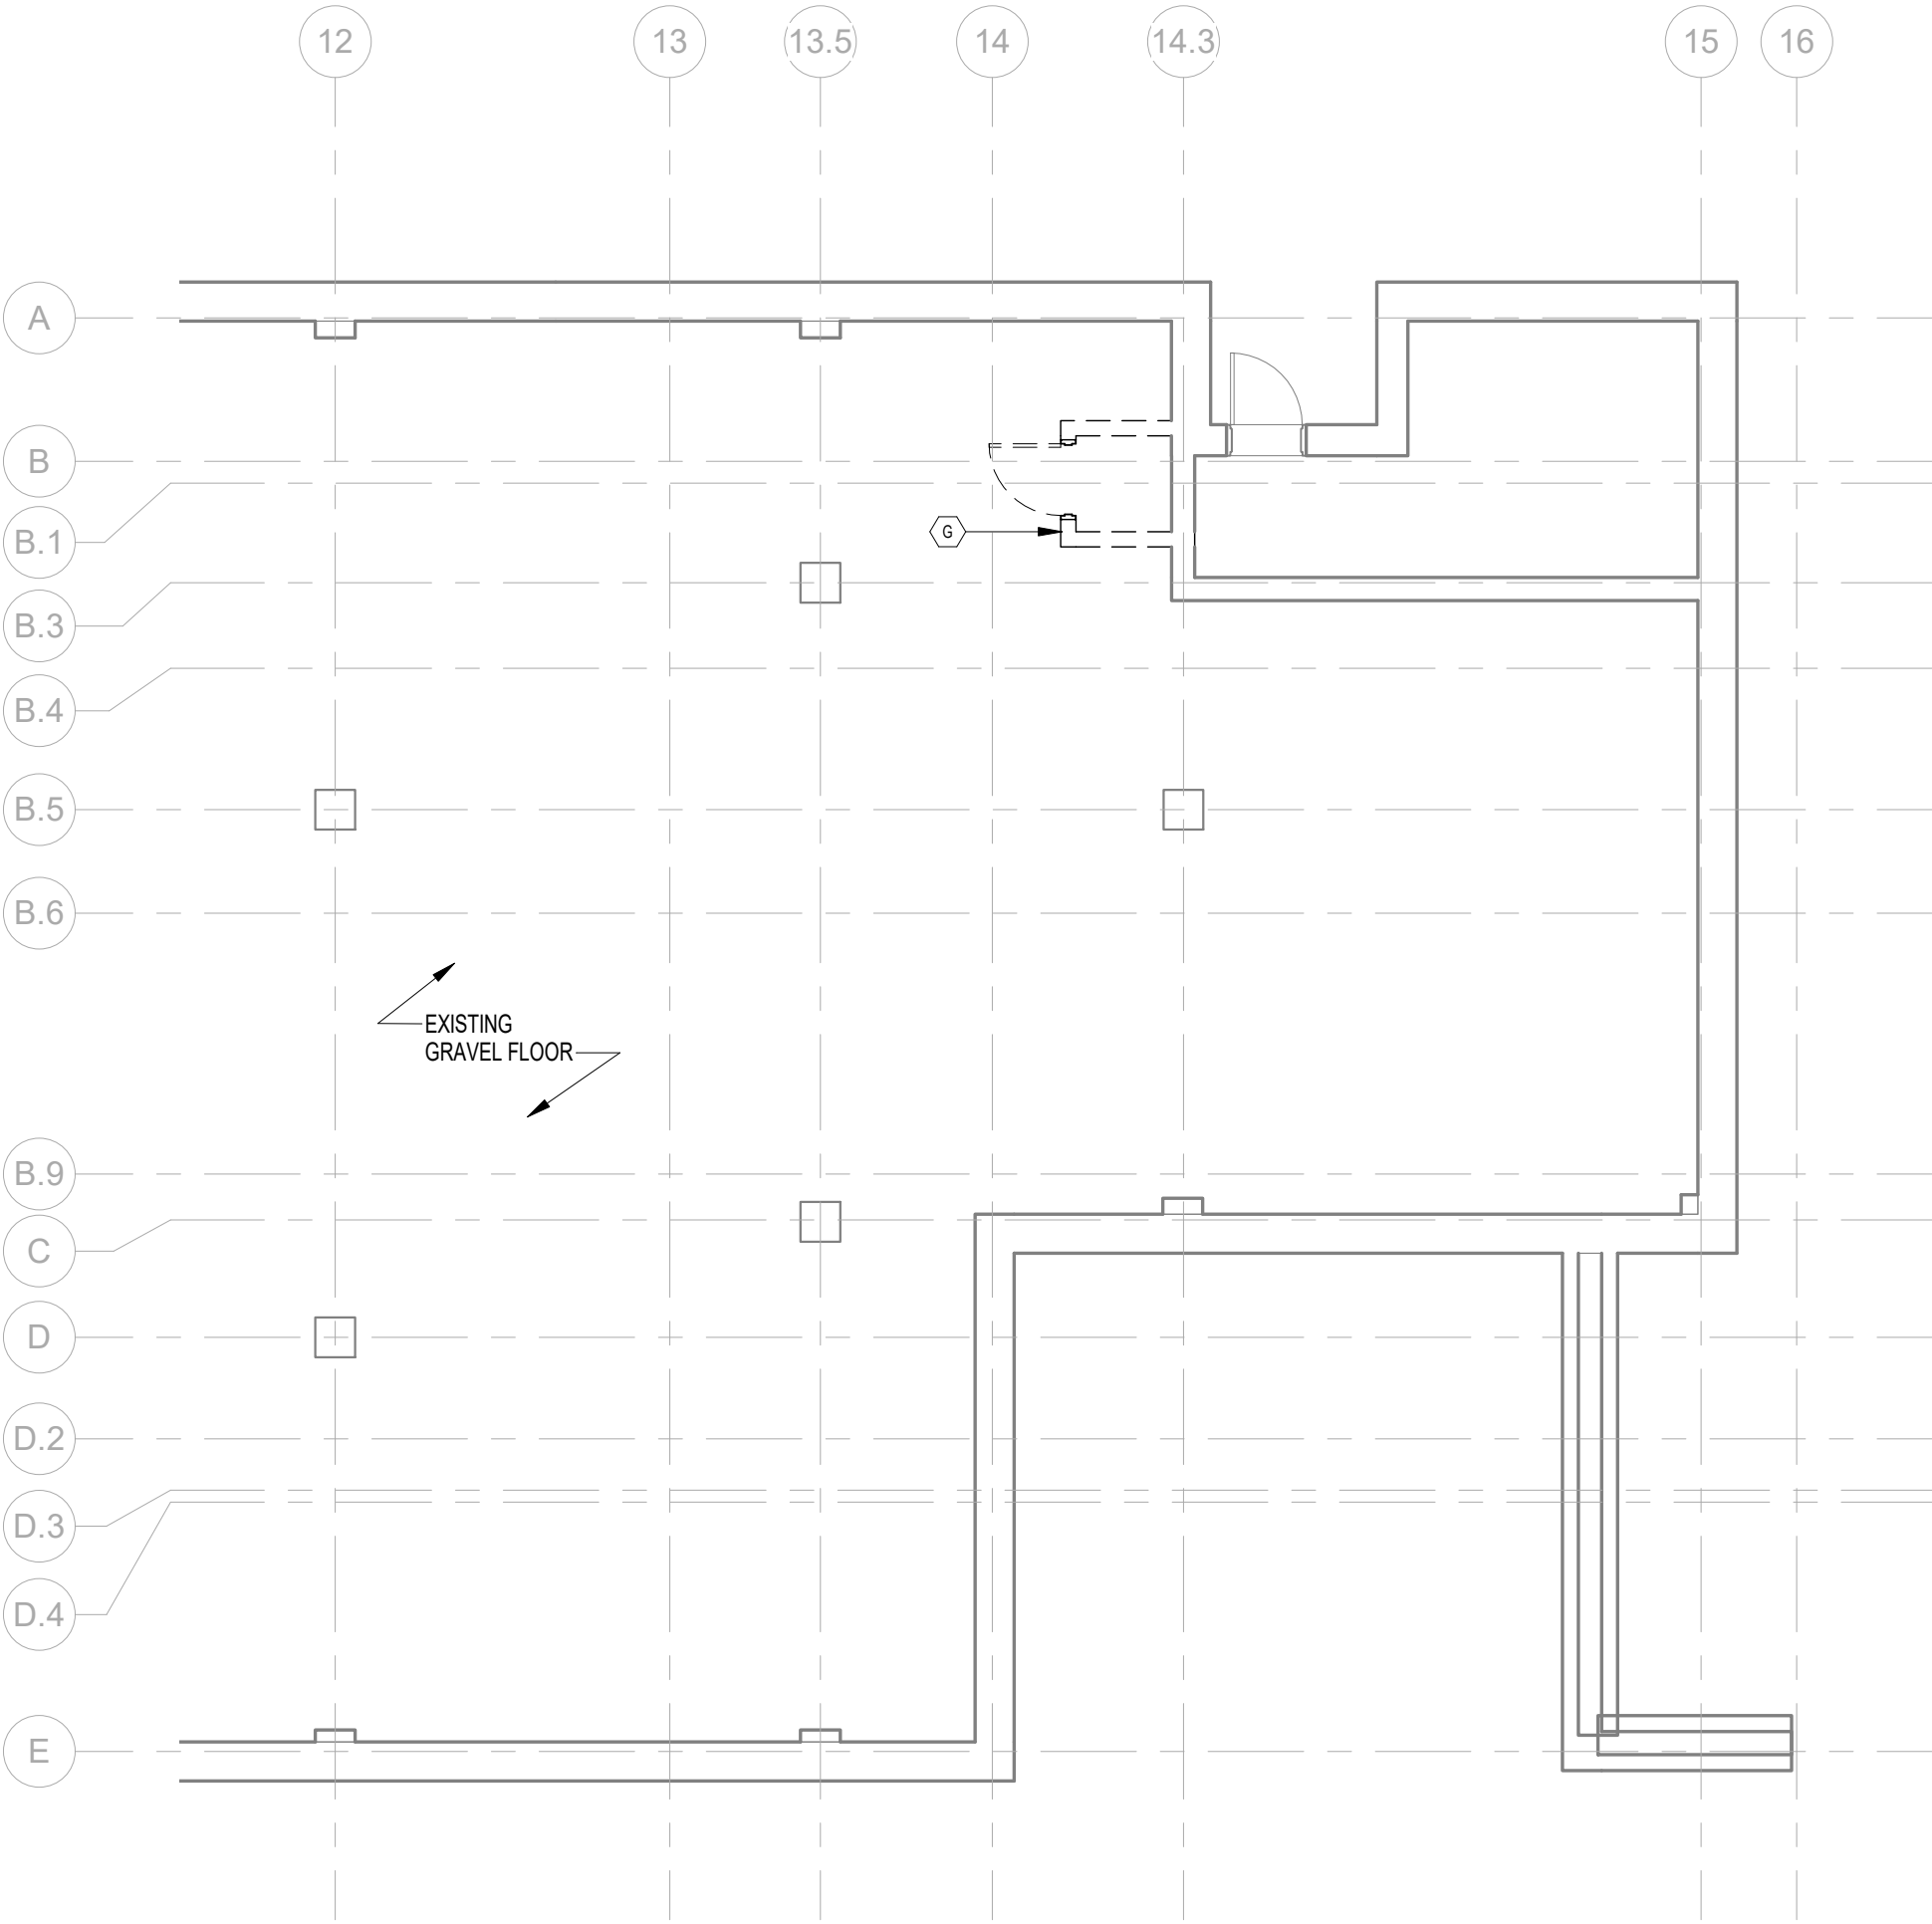

LOWER LEVEL PLAN - DEMOLITION
1/8" = 1'-0"
NORTH

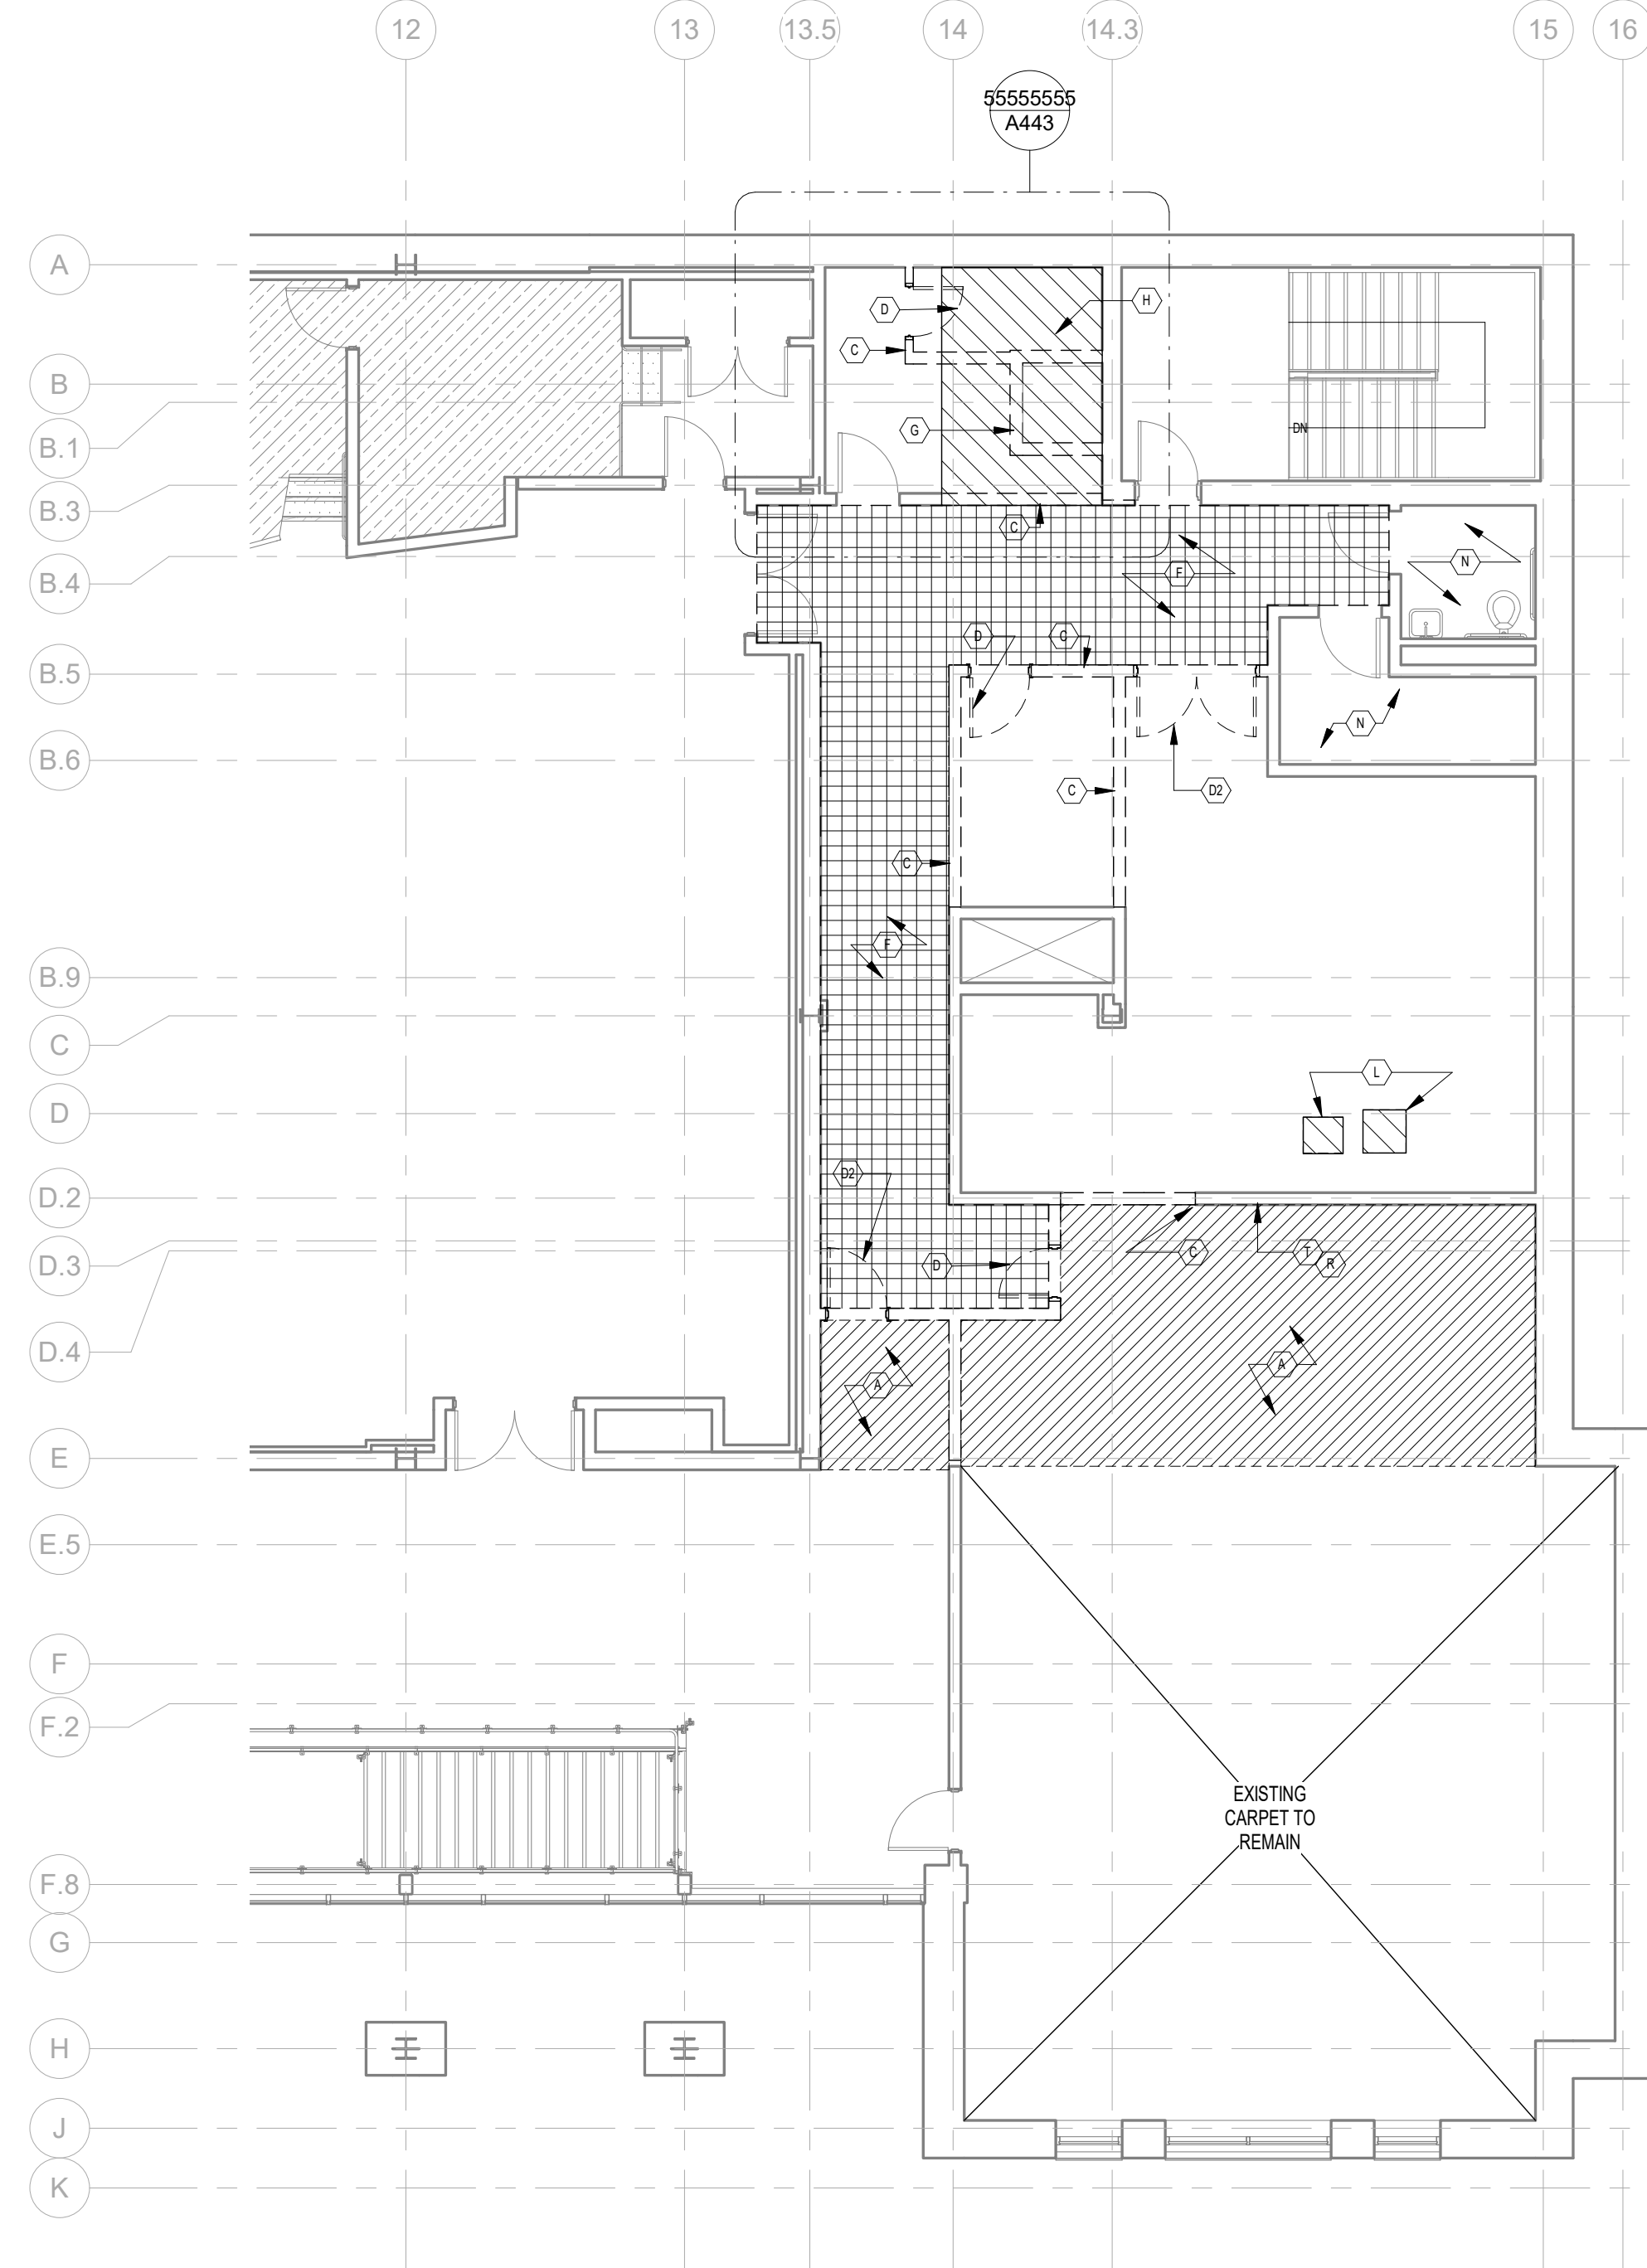

SECOND FLOOR PLAN- DEMOLITION
1/8" = 1'-0"
NORTH



ARCHITECTURE
PLANNING INTERIORS
GRAPHICS

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LICENSE #A-000640P IB 0200153

NOTE:
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**FSU TURNBULL
CONFERENCE CENTER
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DEMOLITION NOTES: FLOOR PLAN


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- (K) REMOVE & DISPOSE OF EXISTING STAGE
- (L) REMOVE AND DISPOSE OF EXISTING CONCRETE SLAB AS REQUIRED TO ACCOMMODATE NEW FLOOR CHASER. COORDINATE WITH STRUCTURAL & MEP FOR EXACT LOCATION AND SIZES
- (M) REMOVE AND DISPOSE OF EXISTING BRICK BENCH WITH PRECAST CAP. REPAIR EDGE OF PAVERS (AND/OR REPLACE) AS REQ. COORDINATE W/ NEW WORK AS SHOWN ON SHEET A105.
- (N) NO WORK IN THIS ROOM.
- (O) REMOVE AND DISPOSE OF EXISTING CURTAINS
- (P) REMOVE AND DISPOSE OF EXISTING CASED OPENING AND TRIM
- (Q) REMOVE AND DISPOSE OF EXISTING INTERIOR STOREFRONT SYSTEM
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PROJECT PHASE
CONSTRUCTION DOCUMENTS


DATE	DRAWN BY
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SHEET TITLE
LOWER LEVEL & 2ND FLOOR- DEMOLITION PLANS

SHEET NO	REV NO
A101.2	



NOTE:
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**FSU TURNBULL
CONFERENCE CENTER
RENOVATIONS**

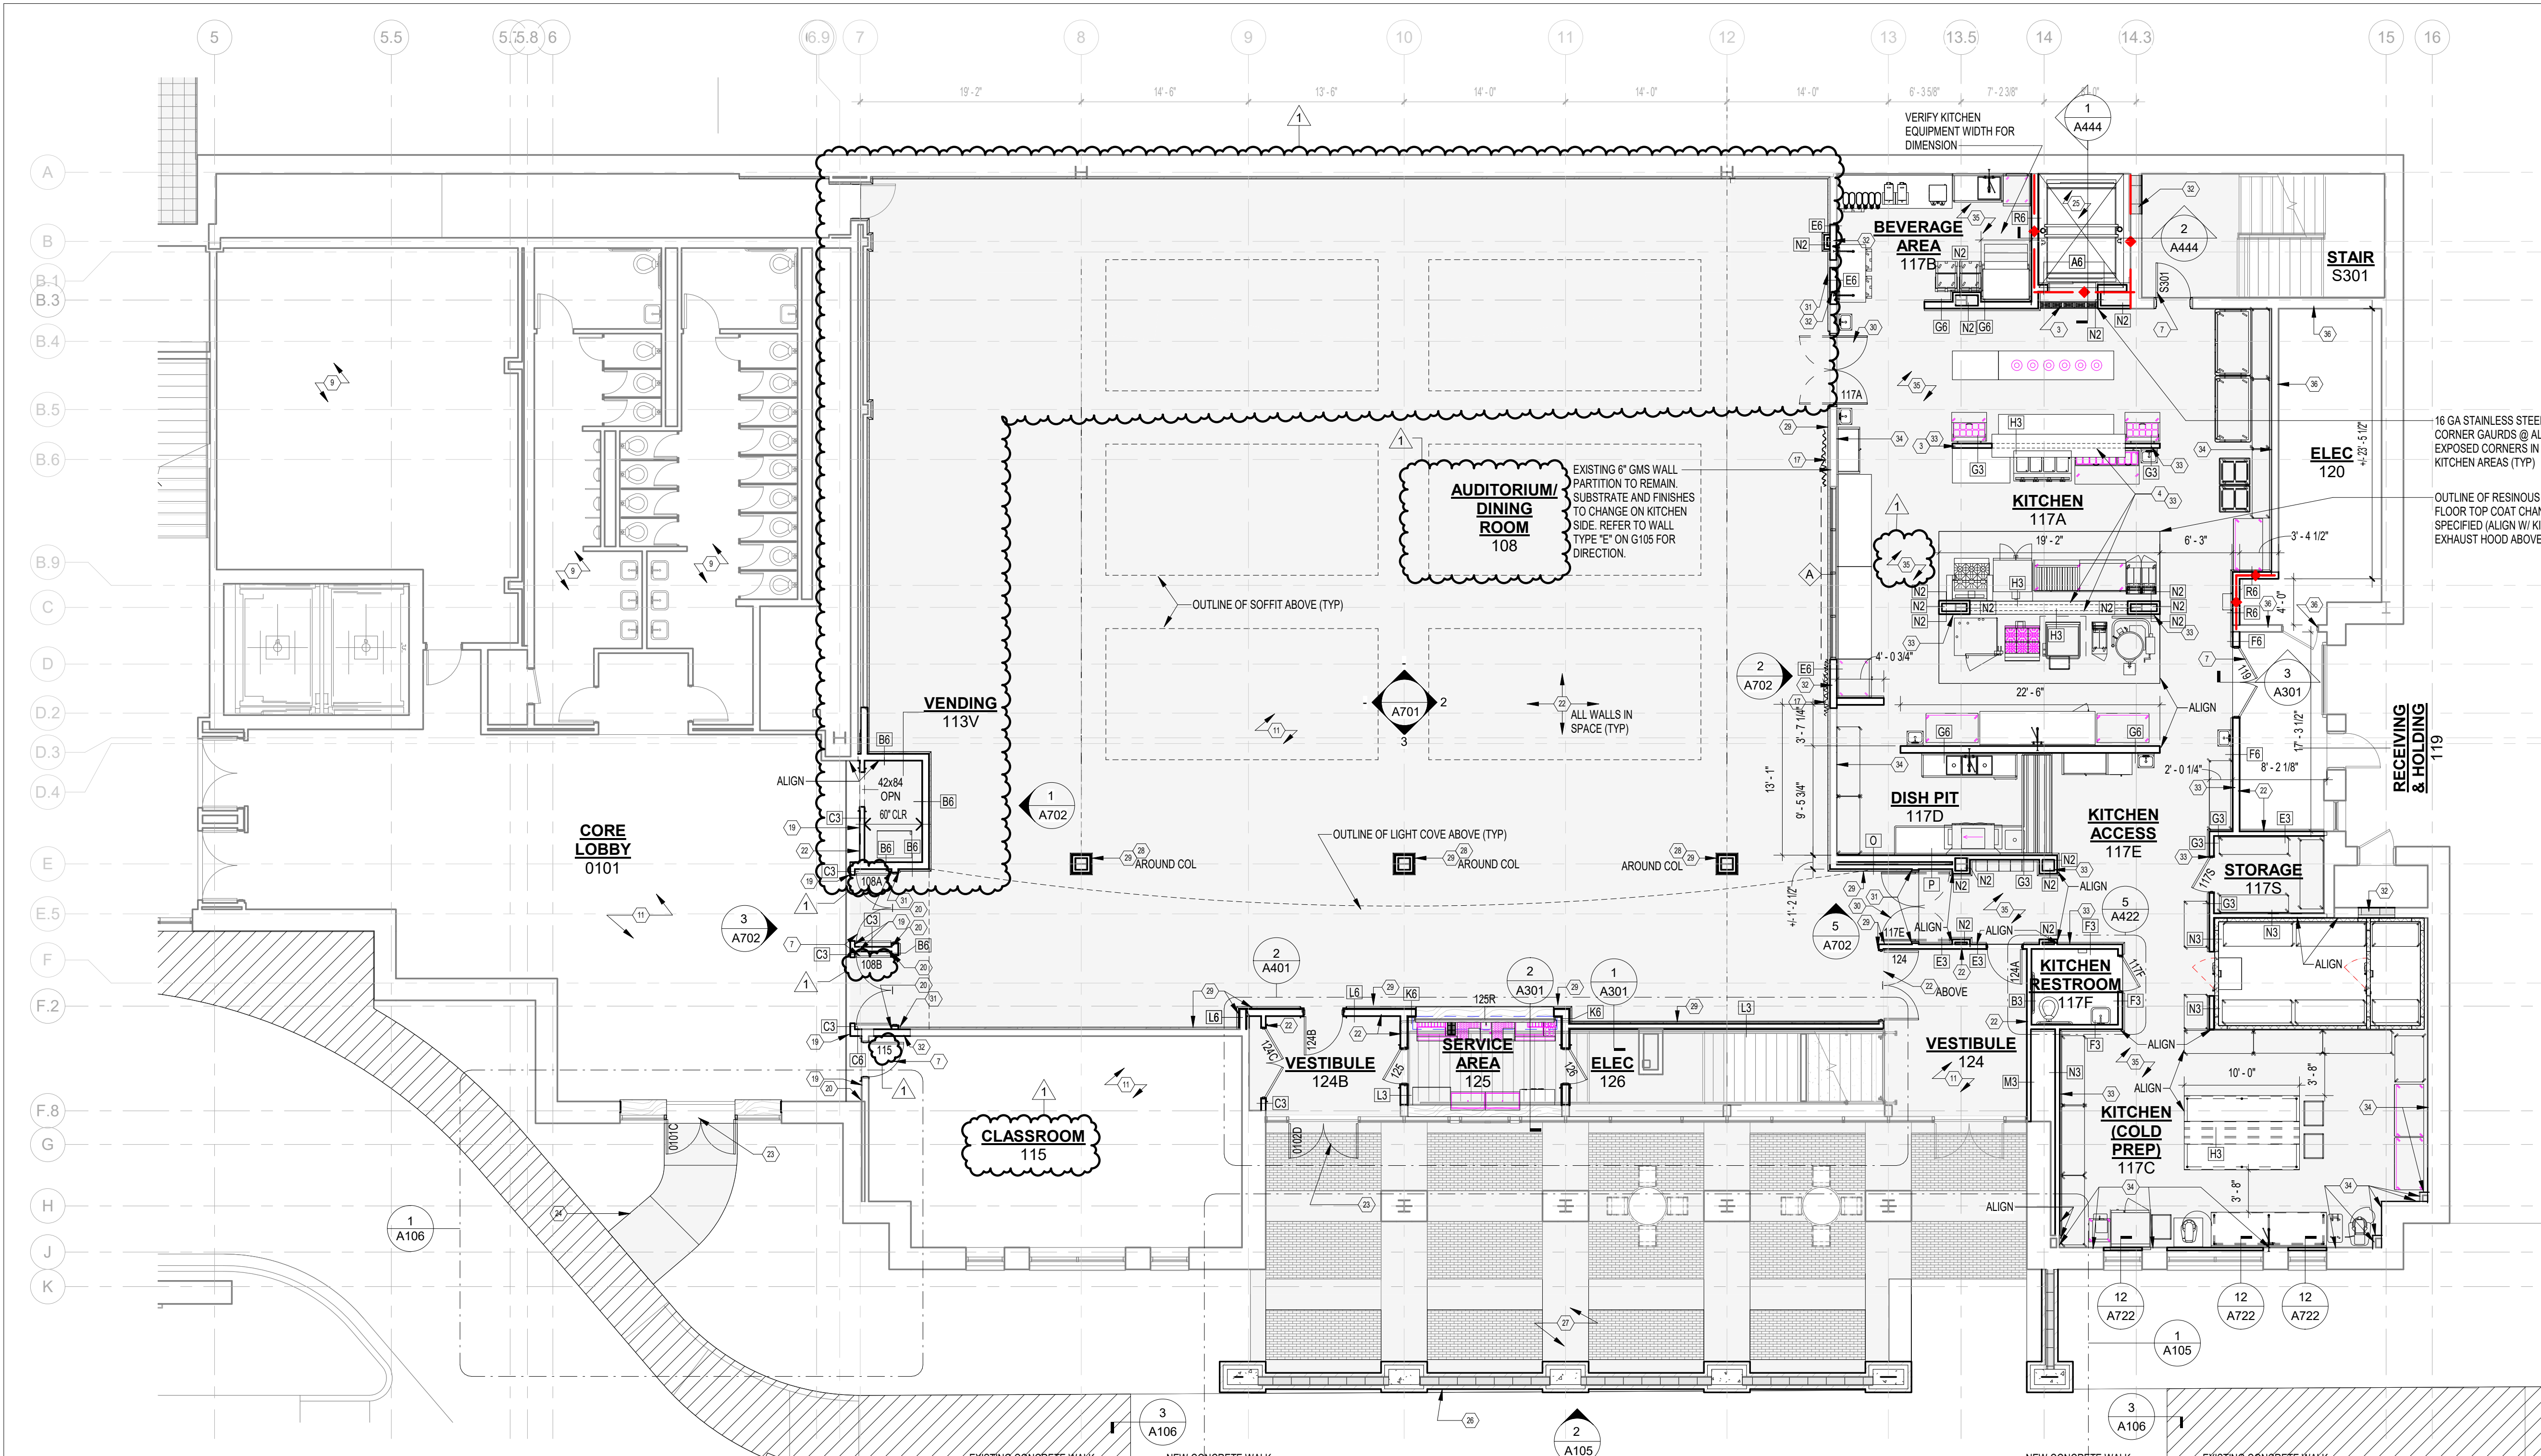REV	DATE	DESCRIPTION
1	04.17.24	FSU PERMIT

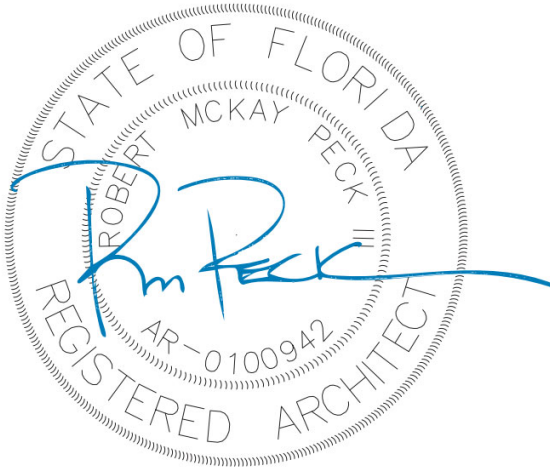PROJECT PHASE CONSTRUCTION DOCUMENTS	
DATE 18 OCTOBER 2023	DRAWN BY BI/RMP
PROJECT NO 74000	CHECKED BY RMP/BI

SHEET TITLE FIRST FLOOR PLAN- NEW WORK	
SHEET NO A102.1	REV NO 1

FIRST FLOOR PLAN-NEW WORK
1/8" = 1'-0"
NORTH

WALL SYMBOL LEGEND

	1 HOUR RATED
	2 HOUR RATED
	PARTIAL HEIGHT WALL
	FIRE EXTINGUISHER CABINET (FEC-1)
	FIRE EXTINGUISHER (FE-1)
	REFER TO PARTITION TYPE NOTES ON G102 REFER TO WALL TYPES ON SHEET G105

CONSTRUCTION NOTES: FLOOR PLAN

1. CONSTRUCT NEW STAGE STAIR PER SECTION	10. INSTALL NEW STAGE EDGE AND SKIRT PER ELEVATION SEE SHEET A701
2. CONSTRUCT NEW STAGE PER SECTION	11. EXISTING CARPET TO REMAIN.
3. INSTALL TRENCH DRAIN AT ELEVATOR ENTRANCE	12. INSTALL NEW FLOORING PER FINISH SCHEDULE.
4. CONSTRUCT NEW 0" GMS PARTIAL HEIGHT WALL. (SEE ELEVATIONS FOR HEIGHT OF WALL)	13. INSTALL EXISTING NEW A.V. RACKING AND EQUIPMENT INSTALLED BY VIDEO WALL VENDOR. CONSTRUCTION MANAGER SHALL COORDINATE AS NECESSARY FOR SCHEDULED INSTALLATION.
5. INSTALL NEW HANICAP LIFT PER MANUFACTURER'S RECOMMENDATIONS AND PROCEDURES.	14. 4" X 4" STEEL POST ANCHOR TO EXISTING FLOOR SLAB.
6. INSTALL NEW 3/4" PLYWOOD SCREEN MOUNTING BOARD (CONFIRM REQUIRED DIMENSIONS WITH SCREEN MANUFACTURER).	15. INSTALL NEW HANDRAIL PER DETAIL
7. INSTALL NEW DOOR	16. INSTALL NEW STAGE BASEBOARD WD-1
8. INSTALL NEW HIDDEN DOOR PER DETAIL	17. INSTALL NEW CEILING TRACK CURTAIN SYSTEM
9. NO WORK IN THIS ROOM	18. CONSTRUCT AND INSTALL NEW WOOD VIDEO SCREEN SHELF (PER DETAIL)

19. INSTALL NEW WD BASEBOARD TO MATCH EXISTING ADJACENT WD BASEBOARD	26. CONSTRUCT NEW GMS & GWB FULL HEIGHT COLUMN FURRING (EXTEND 6" ABOVE CEILING)
20. TERMINATE NEW BASEBOARD AT INSIDE CORNER	27. CONSTRUCT NEW WAINSCOT SEE APPLICABLE DETAILS AND ELEVATIONS FOR WAINSCOT HEIGHT
21. INSTALL NEW EXTERIOR DOOR	28. NEW DOUBLE SWINGING TRAFFIC DOOR WITH WOOD LAMINATE FINISH
22. PAINT EXISTING AND NEW PARTITIONS AS SCHEDULED. (TYP)	29. TERMINATE NEW WAINSCOTING AT THIS LOCATION
23. INSTALL NEW STOREFRONT DOOR AS SCHEDULED.	30. INFILL/PATCH WALL AS REQUIRED TO APPLY NEW FINISH, AS SCHEDULED
24. INSTALL NEW CONCRETE SIDEWALK AND PROVIDE ADDITIONAL LANDSCAPING AS REQUIRED TO RESTORE TO ORIGINAL CONDITION	31. PROVIDE FRP WALL PANELS IN KITCHEN AREA (TYP) (SEE FINISH SCHEDULE)
25. INSTALL FREIGHT ELEVATOR PER MANUFACTURER'S RECOMMENDATIONS AND PROCEDURES.	32. REMOVE EXISTING GWB AND REPLACE WITH PLYWOOD AND FRP PANELS (SEE FINISH SCHEDULE AND DETAILS)
26. CONSTRUCT COURTYARD WALL. SEE SHEET A105 FOR DETAILS	33. INSTALL NEW RESINOUS FLOORING WITH CONT 4" BASE TURNED UP WALL (SEE FINISH SCHEDULE)
27. CONSTRUCT NEW ADDITION TO COURTYARD. MATCH EXISTING PAVEMENT AND CONCRETE LAYOUT. SEE SHEET A105 FOR DETAILS	34. CONTRACTOR SHALL CONFIRM EXISTING PARTITIONS ARE (1) HR RATED. IF NOT, PROVIDE 5/8" TYPE X" GWB ON GMS FRAMING AS REQUIRED TO ENSURE (1) HR RATING INTEGRITY AROUND STORAGE ROOMS 113 & 112, ELECTRICAL ROOM 120, AND MECHANICAL 211M

FLOOR PLAN GENERAL NOTES:

- REFER TO SHEET G105 FOR WALL TYPES AND ADDITIONAL INFORMATION. REFER TO SHEETS A111 AND A401, ENLARGED PLANS FOR INTERIOR WALL TYPES (TYP, UNO)
- PRIOR TO FRAMING BUILDING, EACH TRADE SHALL VERIFY PROPOSED BUILDING FRAMING IS ADEQUATE TO ALLOW INSTALLATION OF PROPOSED SYSTEMS.

KEY PLAN

NOTE:
11" x 17" SHEETS ARE PLOTTED AT 1/2
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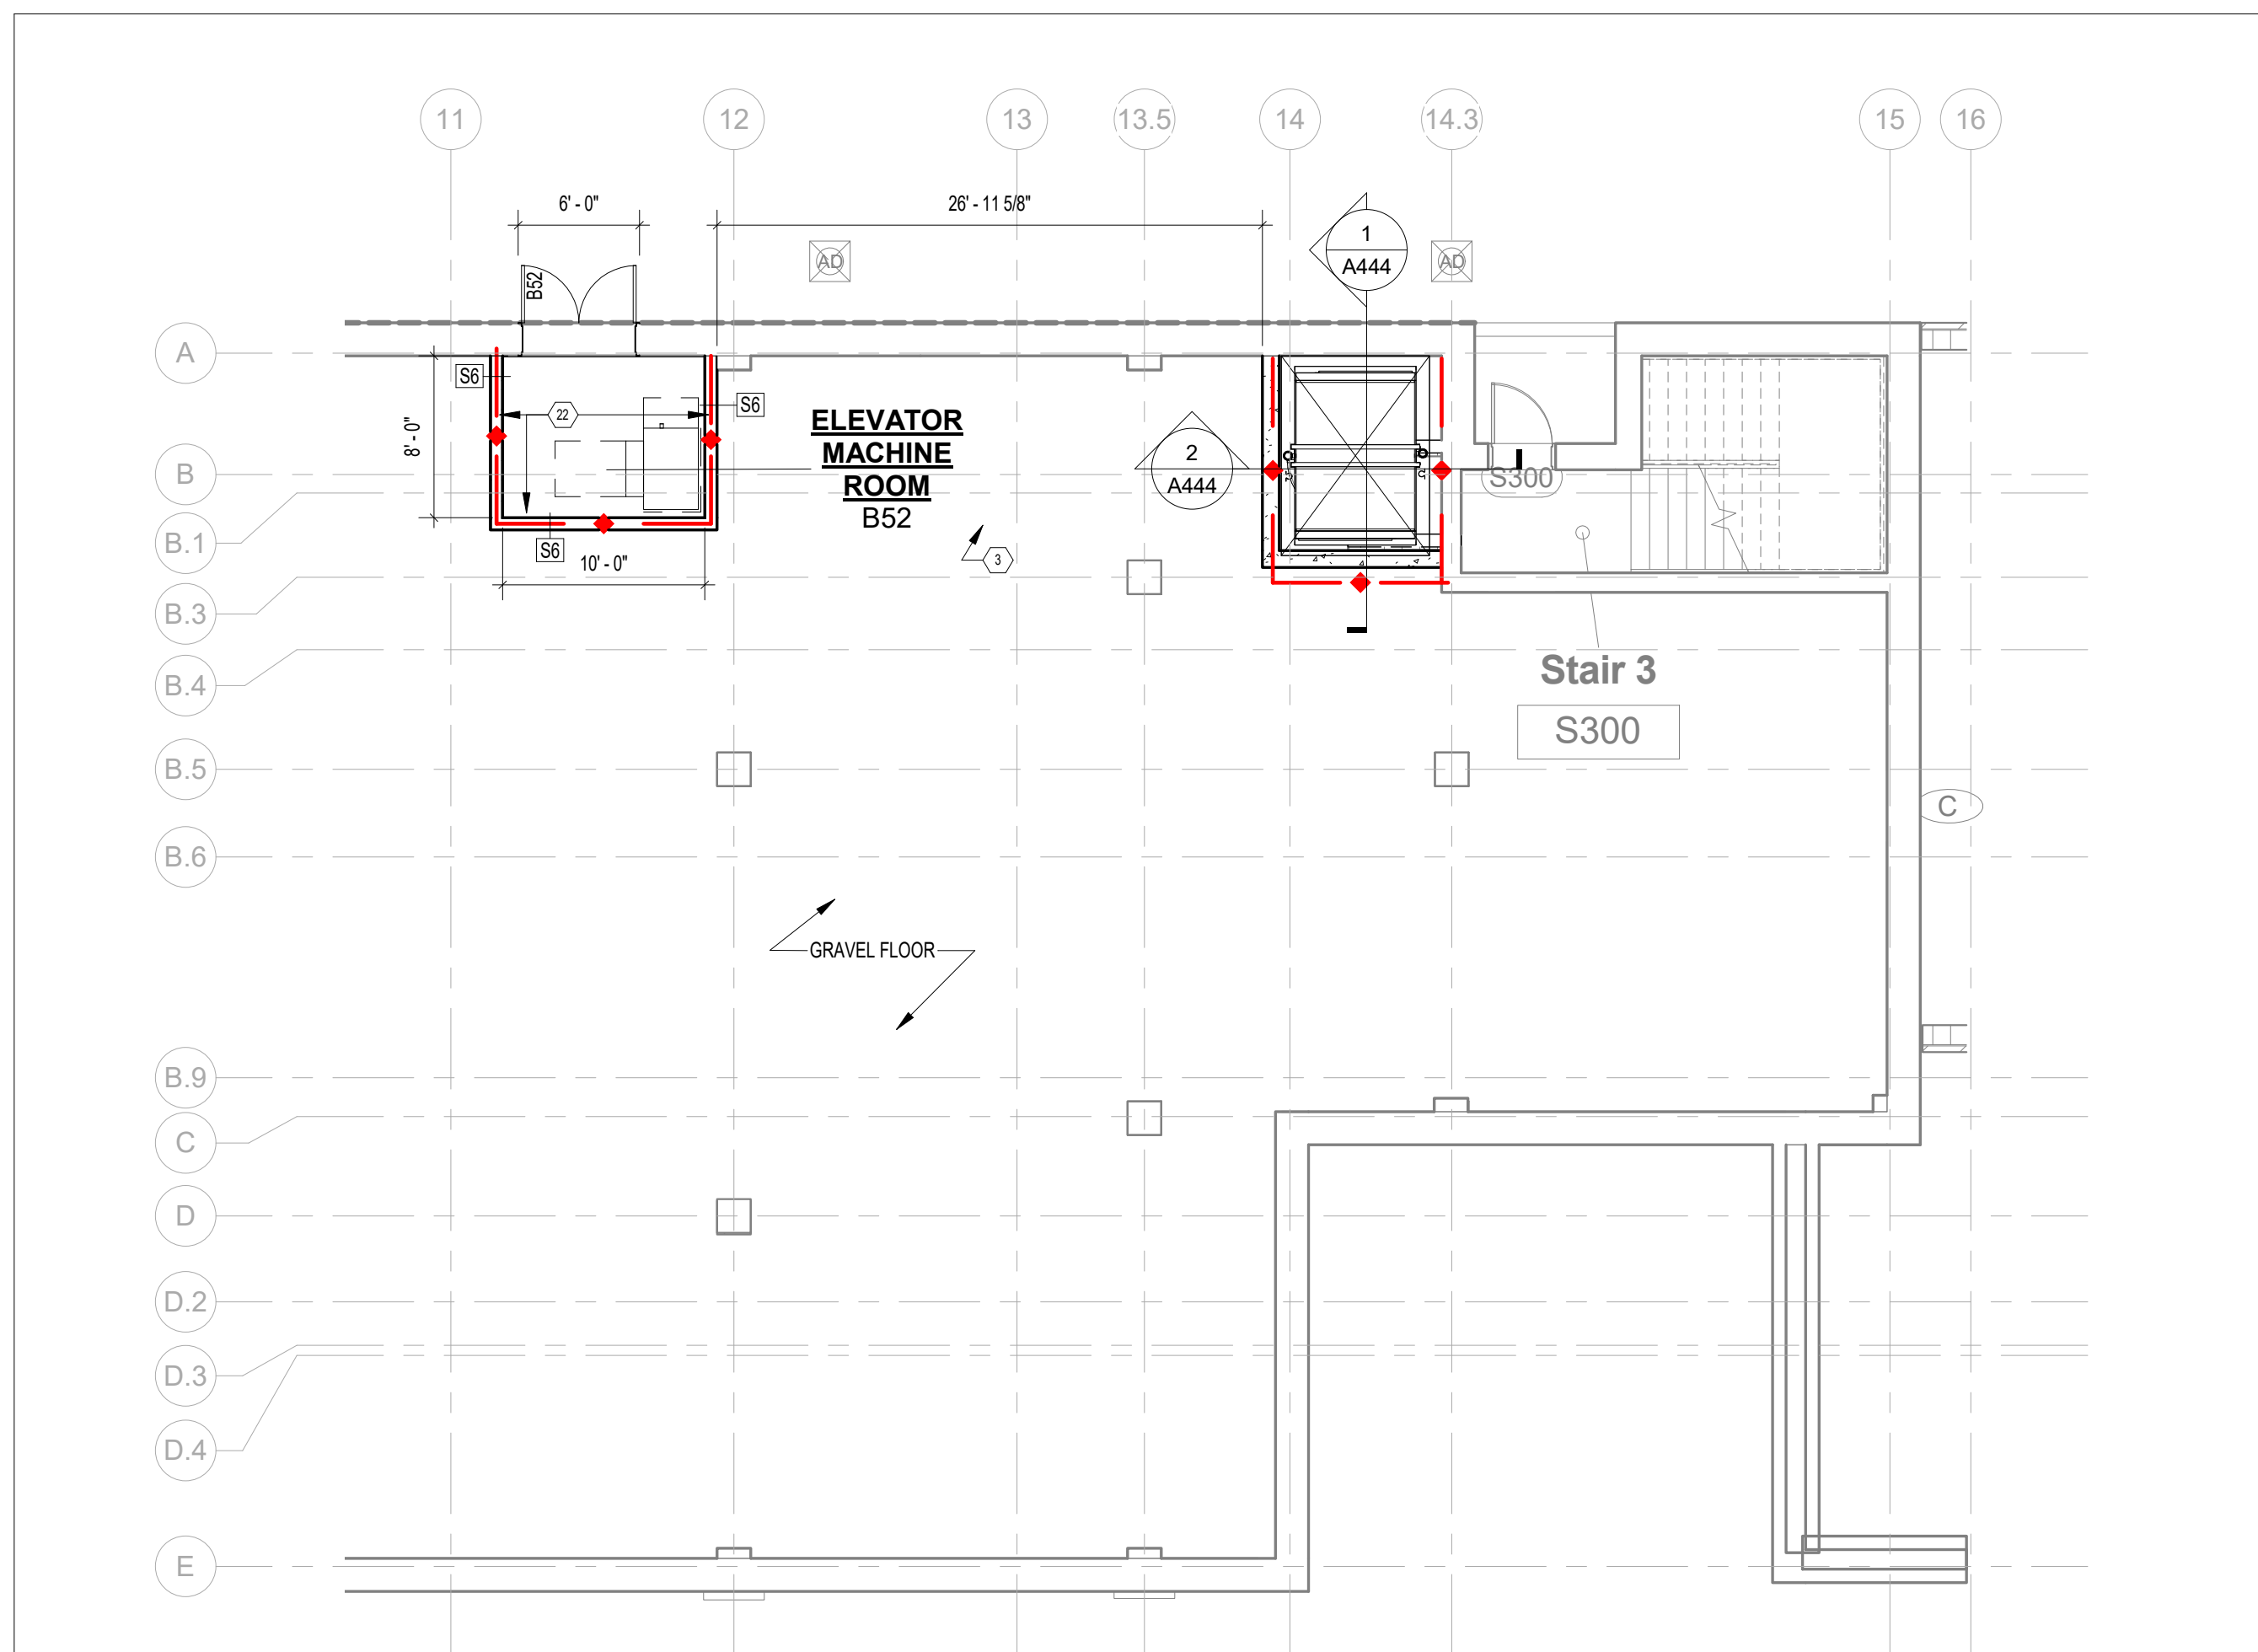
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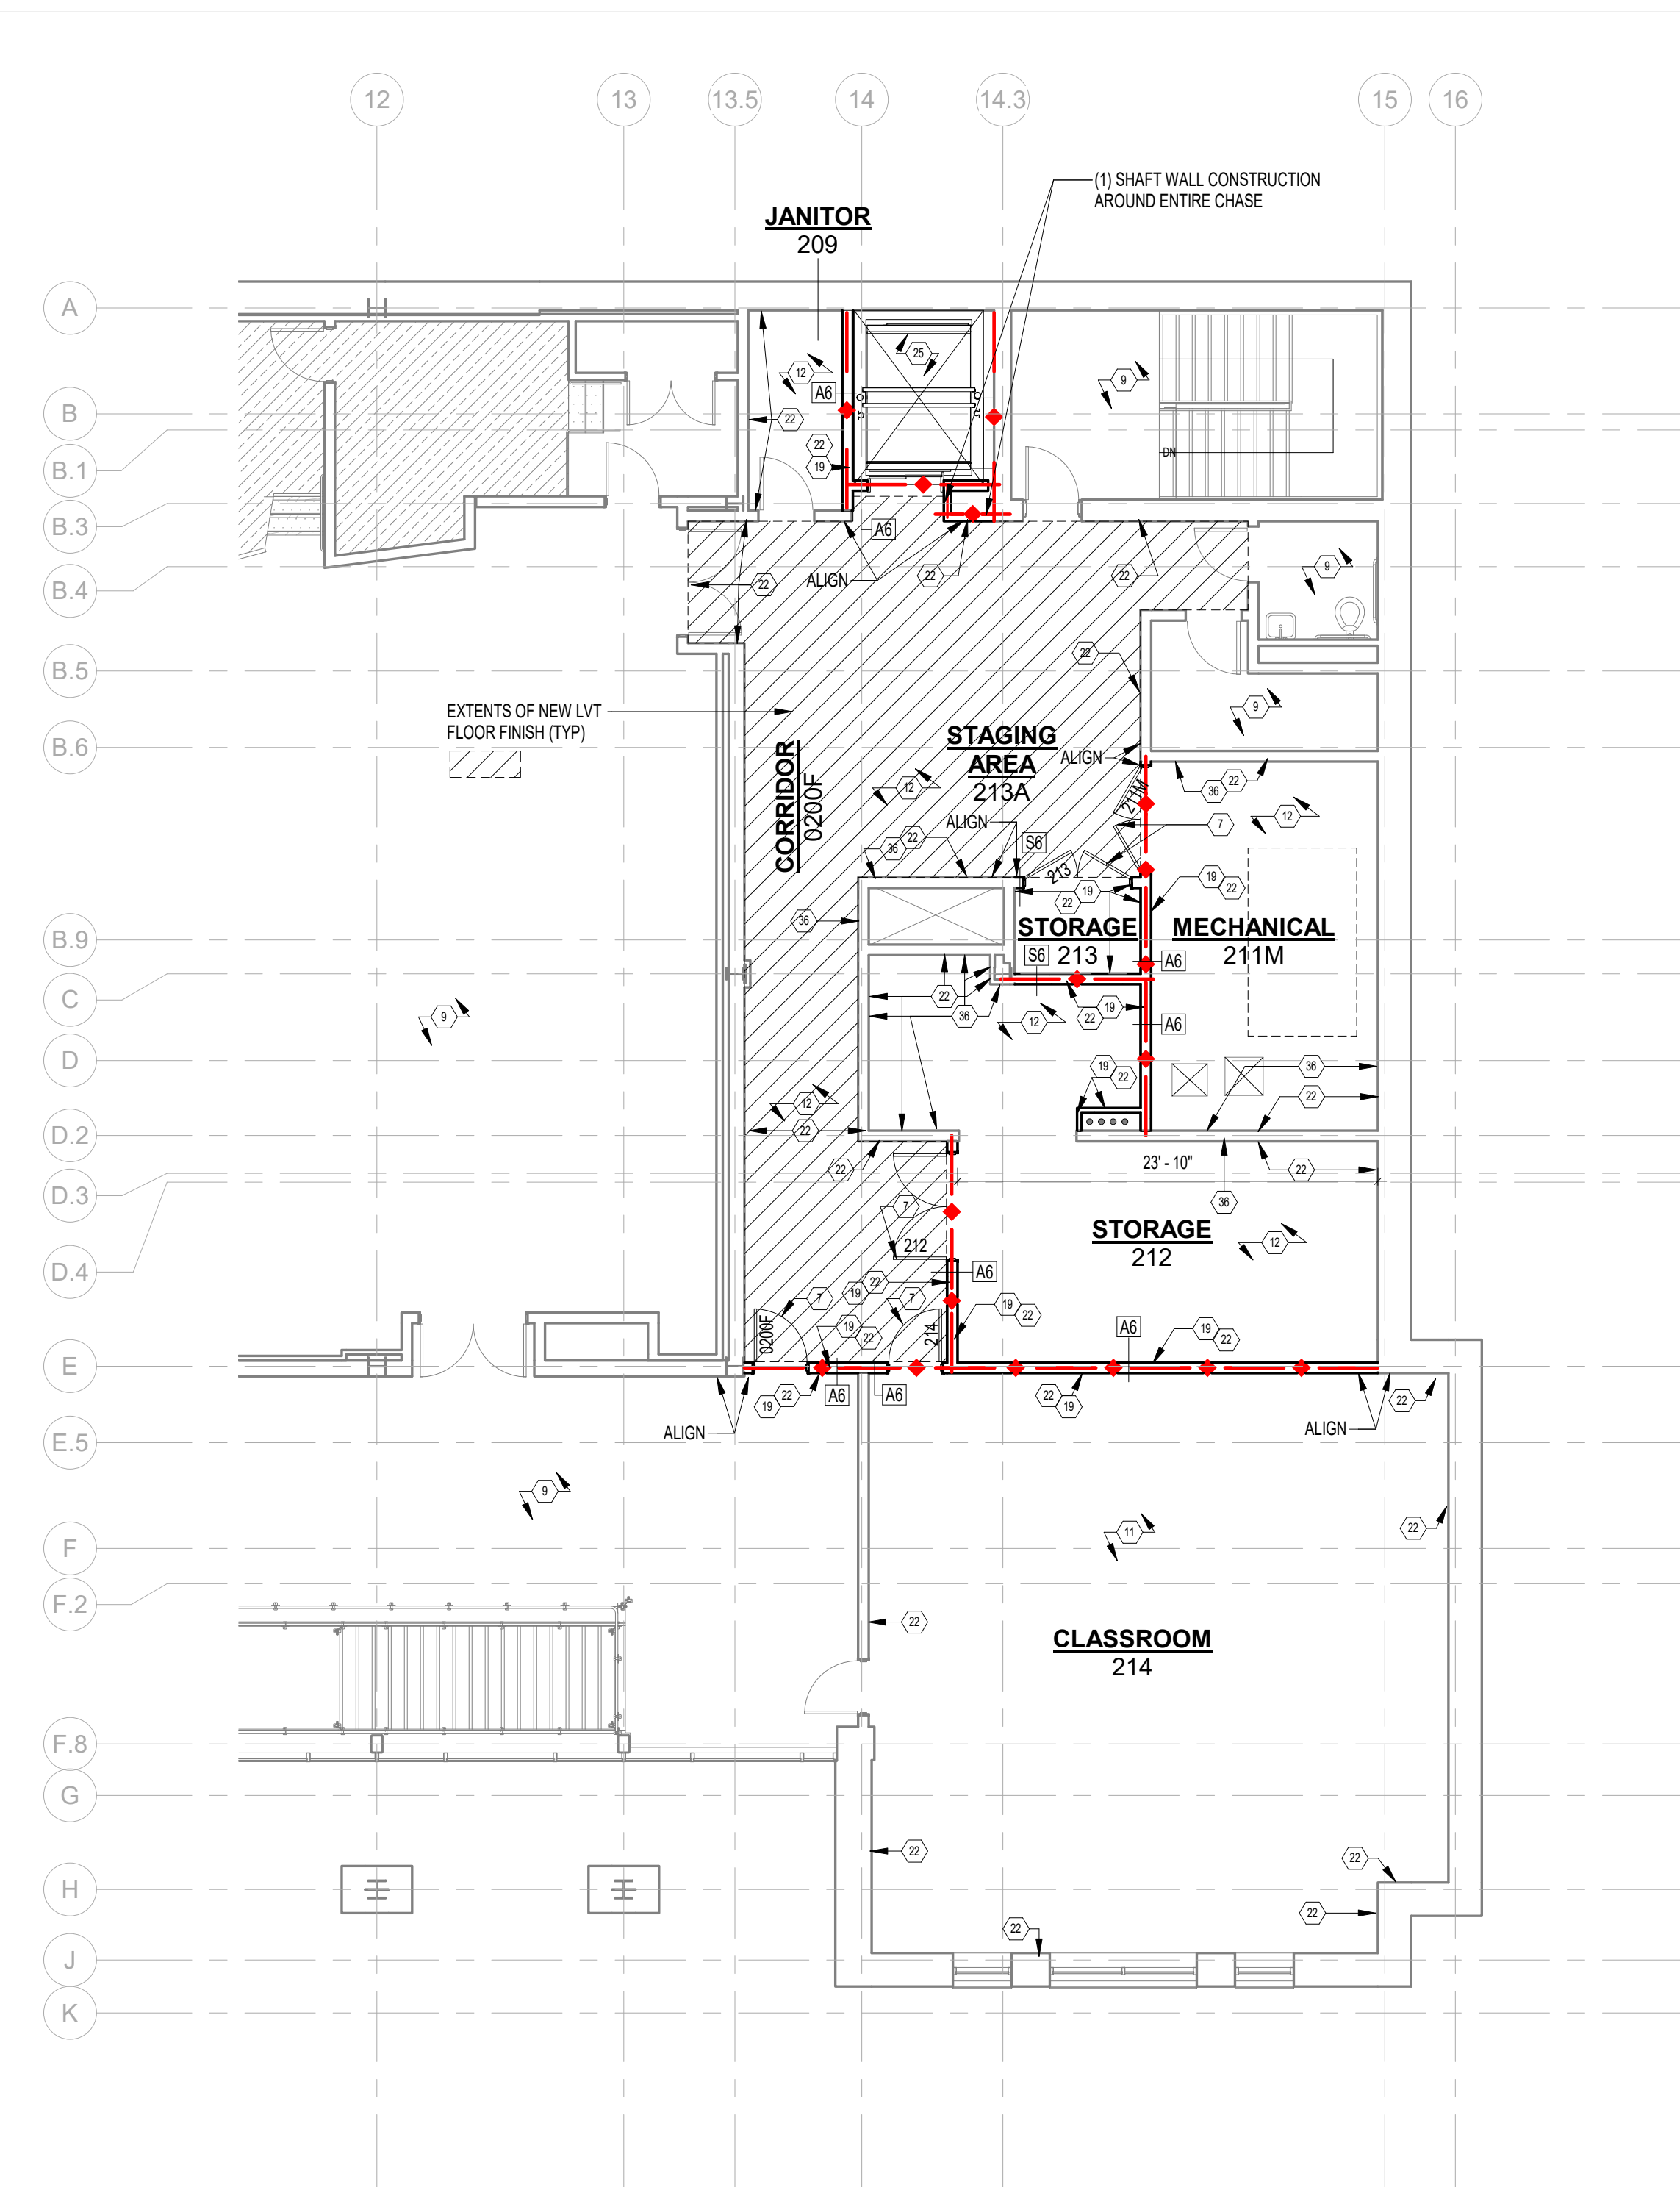
**LOWER LEVEL & 2ND
FLOOR PLAN- NEW
WORK**

SHEET NO
A102.2

REV NO



LOWER LEVEL PLAN-NEW WORK
1/8" = 1'-0"
NORTH



SECOND FLOOR PLAN- NEW WORK
1/8" = 1'-0"
NORTH

WALL SYMBOL LEGEND


- 1 HOUR RATED
- 2 HOUR RATED
- PARTIAL HEIGHT WALL
- FIRE EXTINGUISHER CABINET (FE-C-1)
- FIRE EXTINGUISHER (FE-1)
- REFER TO PARTITION TYPE NOTES ON G102 REFER TO WALL TYPES ON SHEET G105

CONSTRUCTION NOTES: FLOOR PLAN

- 1 CONSTRUCT NEW STAGE STAIR PER SECTION 2 / A511
- 2 CONSTRUCT NEW STAGE PER SECTION 1 / A511
- 3 INSTALL TRENCH DRAIN AT ELEVATOR ENTRANCE
- 4 CONSTRUCT NEW 6" GMS PARTIAL HEIGHT WALL. (SEE ELEVATIONS FOR HEIGHT OF WALL)
- 5 INSTALL NEW HANDICAP LIFT PER MANUFACTURE'S RECOMMENDATIONS AND PROCEDURES.
- 6 INSTALL NEW 3/4" PLYWOOD SCREEN MOUNTING BOARD (CONFIRM REQUIRED DIMENSIONS WITH SCREEN MANUFACTURER).
- 7 INSTALL NEW DOOR
- 8 INSTALL NEW HIDDEN DOOR PER DETAIL 4 / A621 & 2 / A621
- 9 NO WORK IN THIS ROOM
- 10 INSTALL NEW STAGE EDGE AND SKIRT PER ELEVATION SEE SHEET A701
- 11 EXISTING CARPET TO REMAIN.
- 12 INSTALL NEW FLOORING PER FINISH SCHEDULE.
- 13 INSTALL EXISTING NEW A.V. RACKING AND EQUIPMENT (INSTALLED BY VIDEO WALL VENDOR). CONSTRUCTION MANAGER SHALL COORDINATE AS NECESSARY FOR SCHEDULED INSTALLATION.
- 14 4"x4" STEEL POST ANCHOR TO EXISTING FLOOR SLAB.
- 15 INSTALL NEW HANDRAIL PER DETAIL 1 / A721
- 16 INSTALL NEW STAGE BASEBOARD, WD-1
- 17 INSTALL NEW CEILING TRACK CURTAIN SYSTEM
- 18 CONSTRUCT AND INSTALL NEW WOOD VIDEO SCREEN SHELF (PER DETAIL 8 / A721).
- 19 INSTALL NEW WD BASEBOARD TO MATCH EXISTING ADJACENT WD BASEBOARD
- 20 TERMINATE NEW BASEBOARD AT INSIDE CORNER
- 21 INSTALL NEW EXTERIOR DOOR
- 22 PAINT EXISTING AND NEW PARTITIONS AS SCHEDULED. (TYP)
- 23 INSTALL NEW STOREFRONT DOOR AS SCHEDULED.
- 24 INSTALL NEW CONCRETE SIDEWALK AND PROVIDE ADDITIONAL LANDSCAPING AS REQUIRED TO RESTORE TO ORIGINAL CONDITION
- 25 INSTALL FREIGHT ELEVATOR PER MANUFACTURE'S RECOMMENDATIONS AND PROCEDURES.
- 26 CONSTRUCT COURTYARD WALL. SEE SHEET A105 FOR DETAILS
- 27 CONSTRUCT NEW ADDITION TO COURTYARD. MATCH EXISTING PAVEMENT AND CONCRETE LAYOUT. SEE SHEET A105 FOR DETAILS
- 28 CONSTRUCT NEW GMS & GWB FULL HEIGHT COLUMN FURRING (EXTEND 6" ABOVE CEILING)
- 29 CONSTRUCT NEW WAINSCOT SEE APPLICABLE DETAILS AND ELEVATIONS FOR WAINSCOT HEIGHT
- 30 NEW DOUBLE SWINGING TRAFFIC DOOR WITH WOOD LAMINATE FINISH
- 31 TERMINATE NEW WAINSCOTING AT THIS LOCATION
- 32 INFILL/PATCH WALL AS REQUIRED TO APPLY NEW FINISH, AS SCHEDULED
- 33 PROVIDE FRP WALL PANELS IN KITCHEN AREA (TYP) (SEE FINISH SCHEDULE)
- 34 REMOVE EXISTING GWB AND REPLACE WITH PLYWOOD AND FRP PANELS (SEE FINISH SCHEDULE AND DETAILS)
- 35 INSTALL NEW RESINOUS FLOORING WITH CONT 4" BASE TURNED UP WALL (SEE FINISH SCHEDULE)
- 36 CONTRACTOR SHALL CONFIRM EXISTING PARTITIONS ARE (1) HR RATED. IF NOT, PROVIDE 5/8" TYP "X" GWB ON GMS FRAMING AS REQUIRED TO ENSURE (1) HR RATING INTEGRITY AROUND STORAGE ROOMS 113 & 112, ELECTRICAL ROOM 120, AND MECHANICAL 211M

FLOOR PLAN GENERAL NOTES:

- REFER TO SHEET G105 FOR WALL TYPES AND ADDITIONAL INFORMATION. REFER TO SHEETS A111 AND A401, ENLARGED PLANS FOR INTERIOR WALL TYPES (TYP, UNO)
- PRIOR TO FRAMING BUILDING, EACH TRADE SHALL VERIFY PROPOSED BUILDING FRAMING IS ADEQUATE TO ALLOW INSTALLATION OF PROPOSED SYSTEMS.

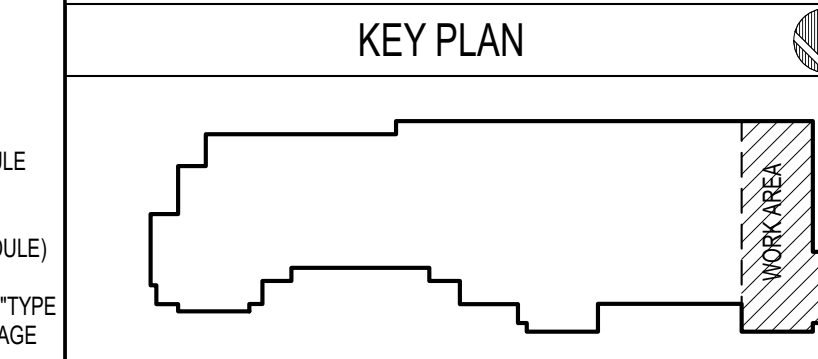

NOTE:
11' x 17" SHEETS ARE PLOTTED AT 1/2
THE SCALE NOTED ON THESE DRAWINGS

**FSU TURNBULL
CONFERENCE CENTER
RENOVATIONS**

REV	DATE	DESCRIPTION


PROJECT PHASE
CONSTRUCTION DOCUMENTS

DATE 18 OCTOBER 2023	DRAWN BY RMP/BI
PROJECT NO 74000	CHECKED BY Checker



SHEET TITLE
MEZZANINE LEVEL

SHEET NO A103	REV NO
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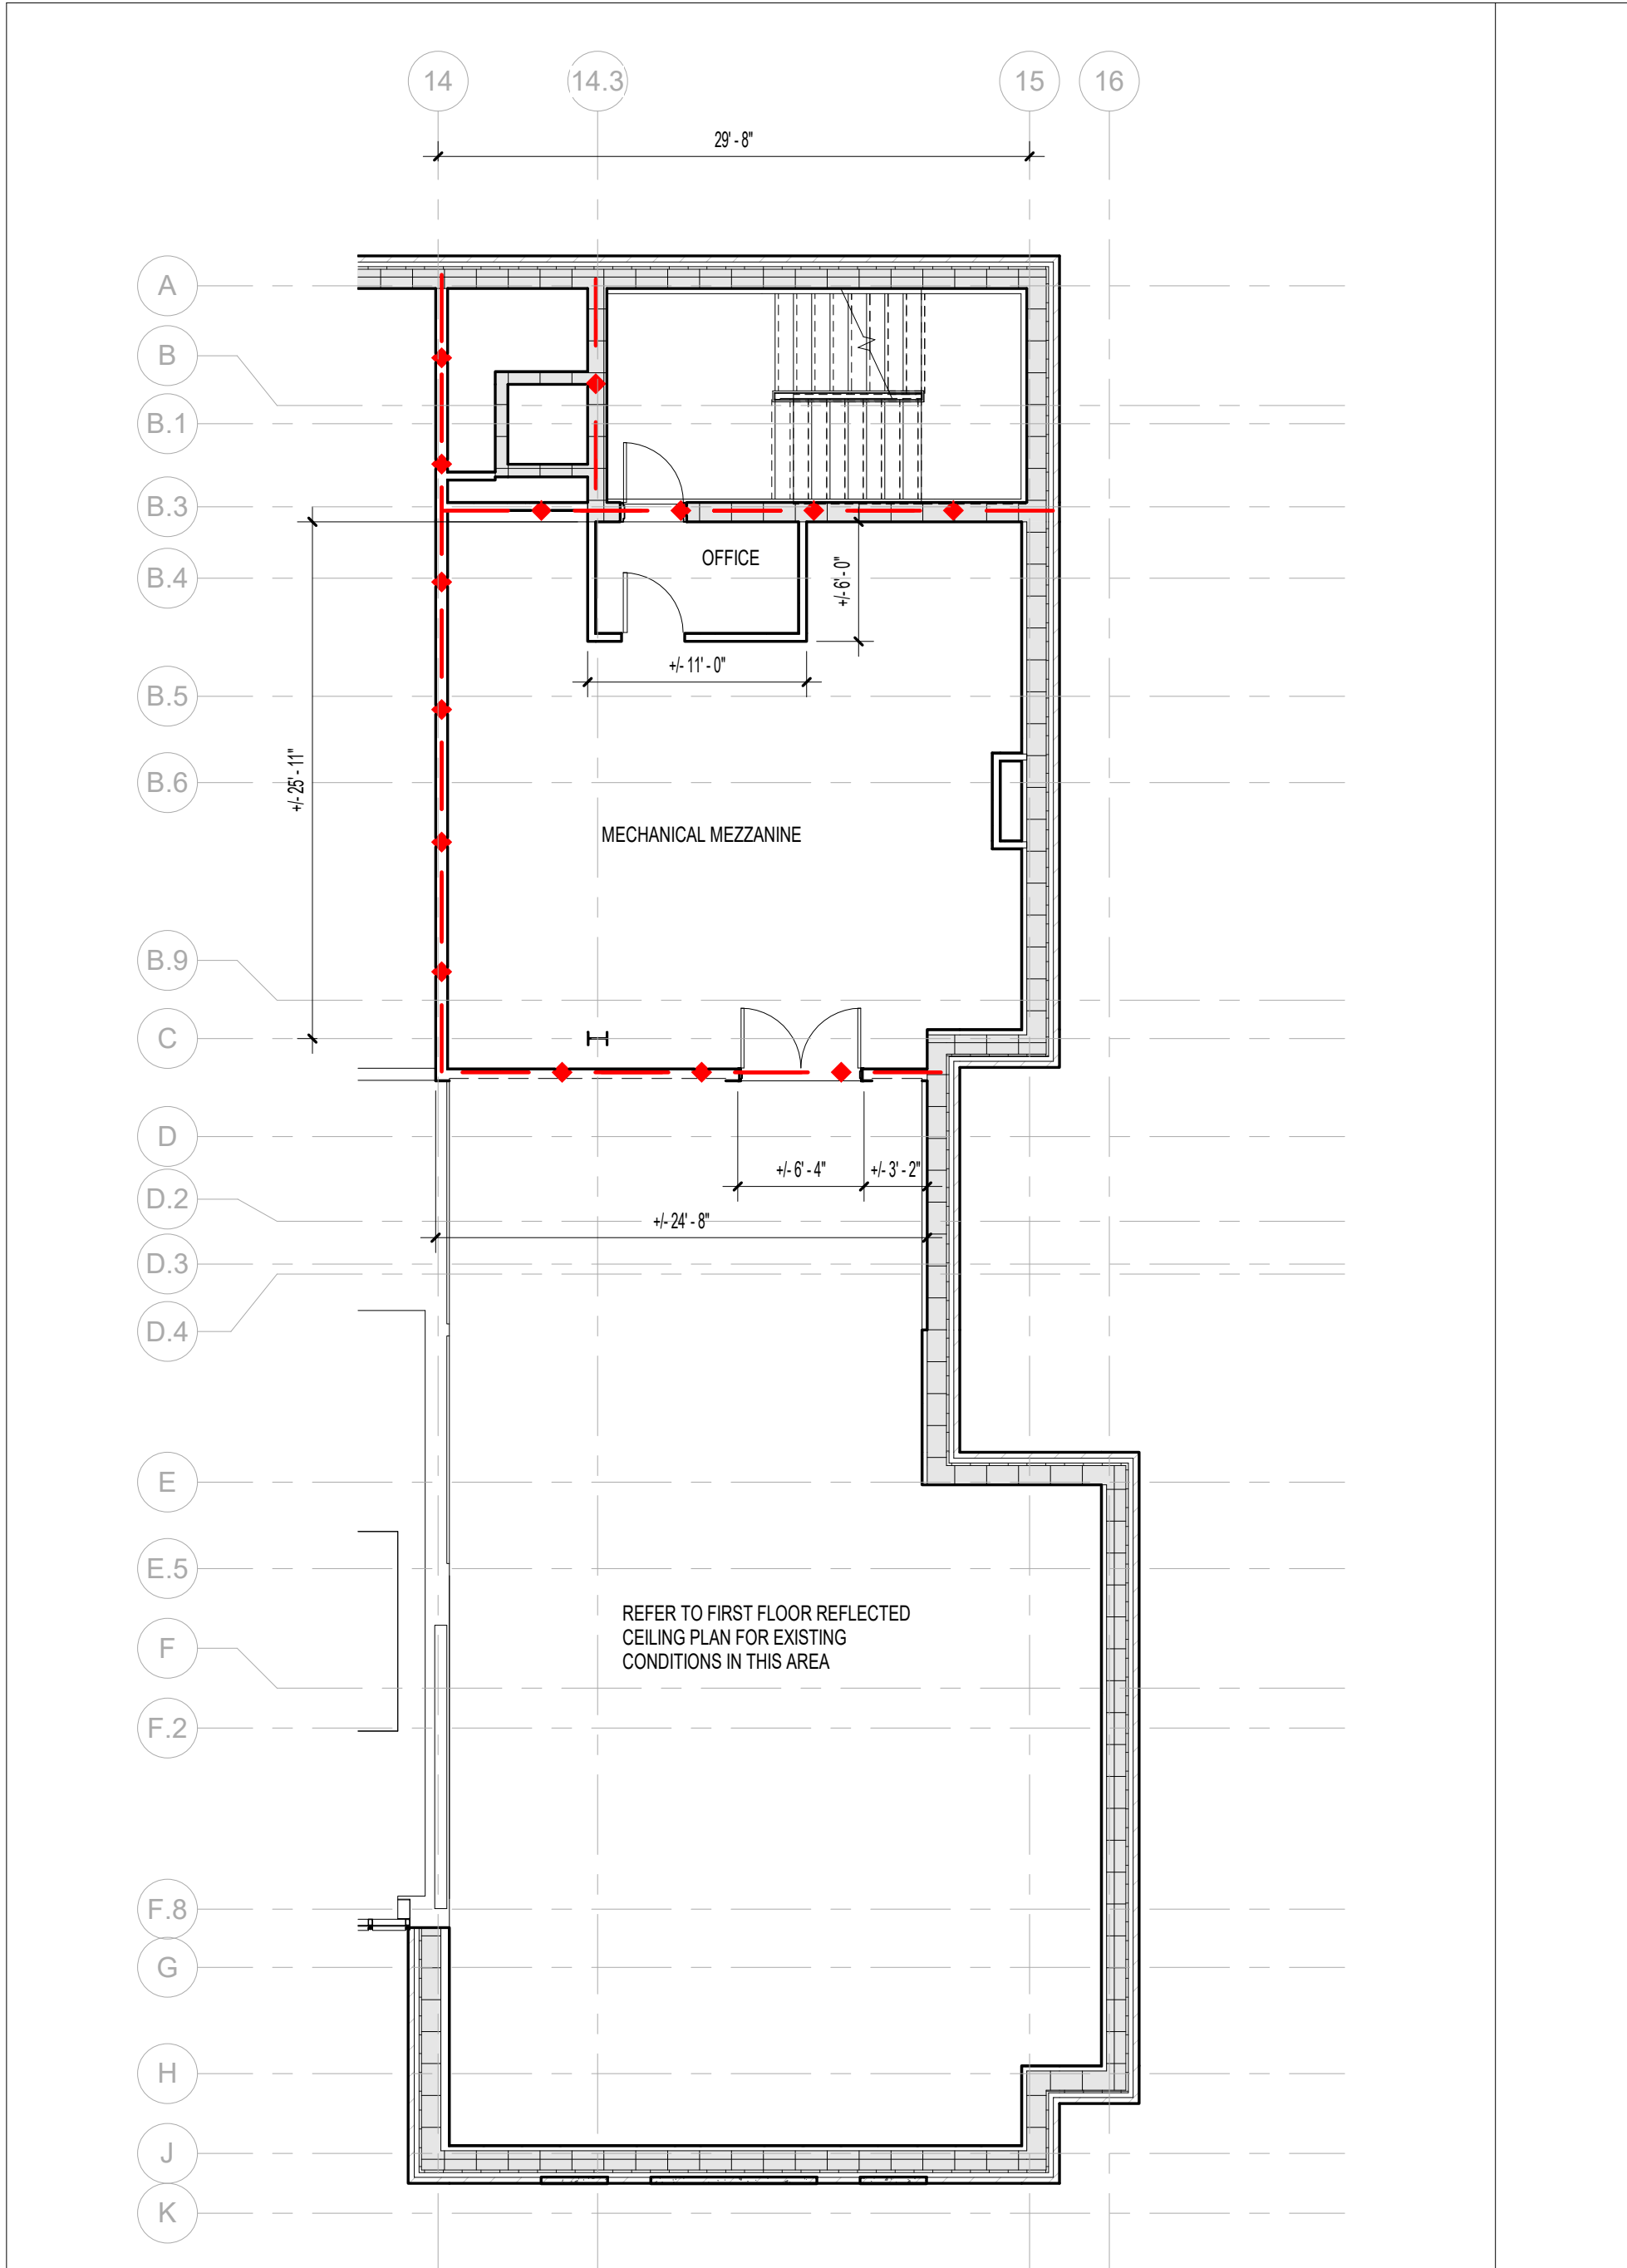
SHEET NO A103	REV NO
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MECHANICAL MEZZANINE - NEW WORK
1/8" = 1'-0"
NORTH

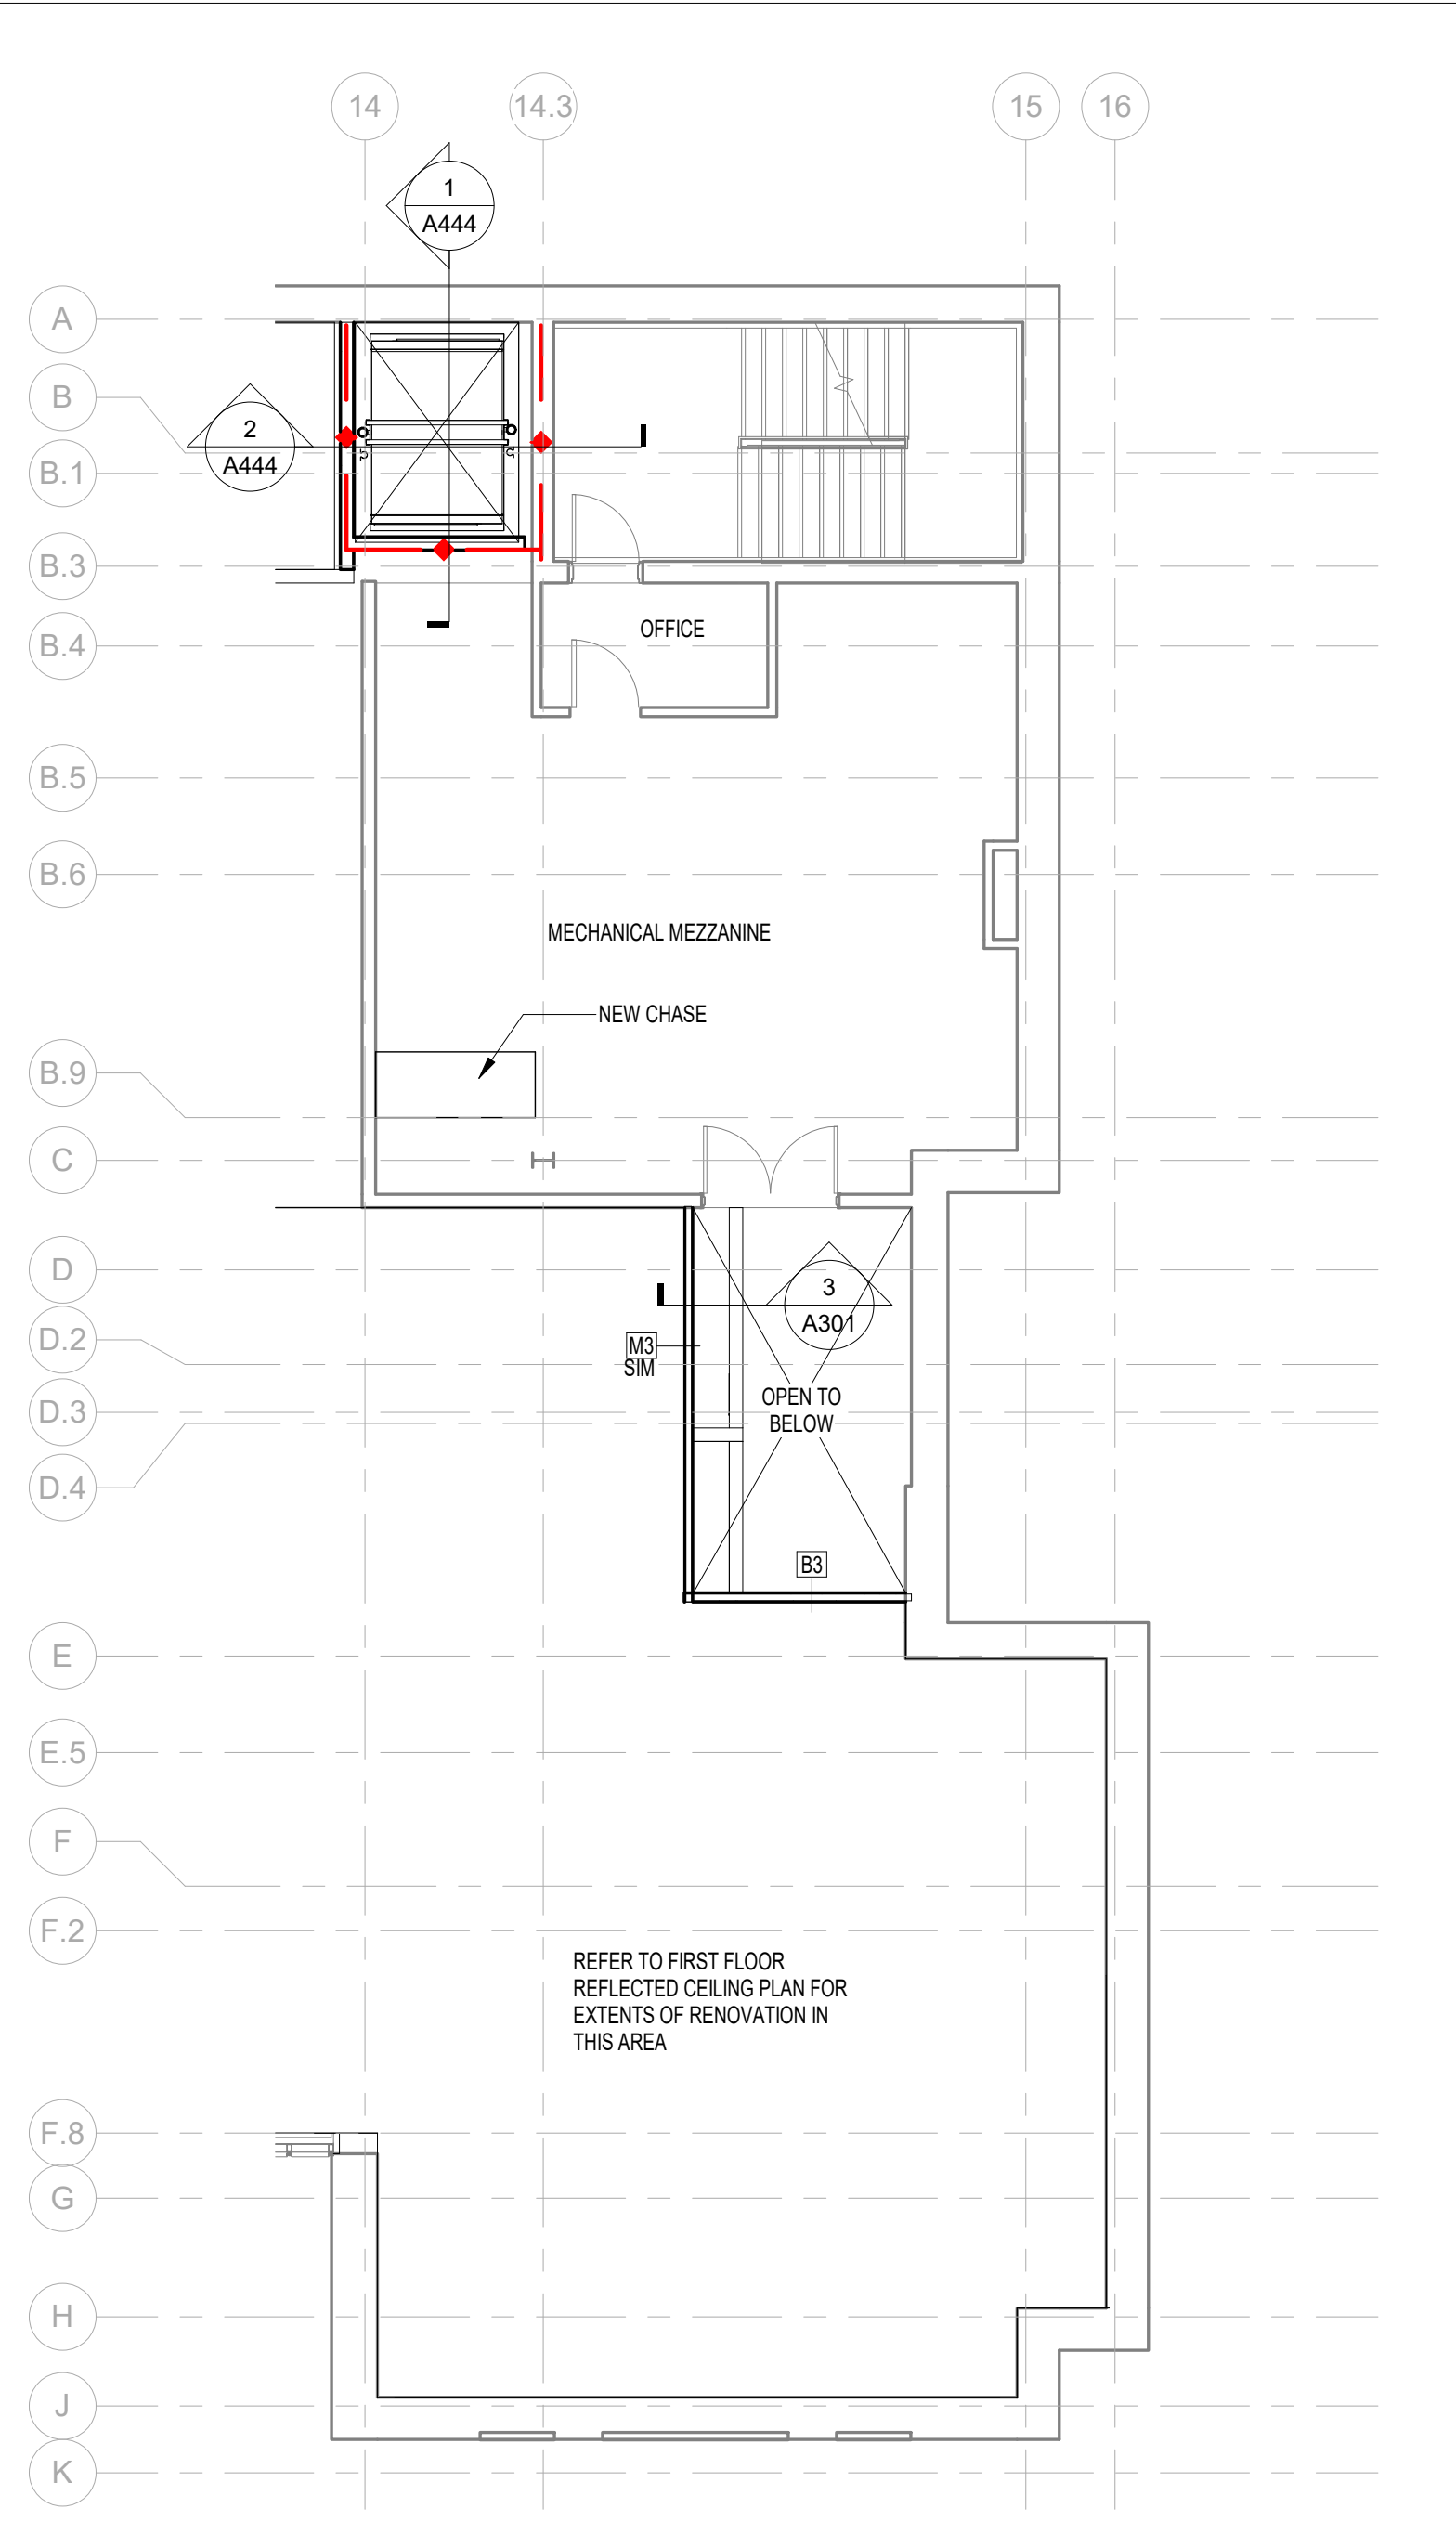

MECHANICAL MEZZANINE - DEMOLITION PLAN
1/8" = 1'-0"
NORTH

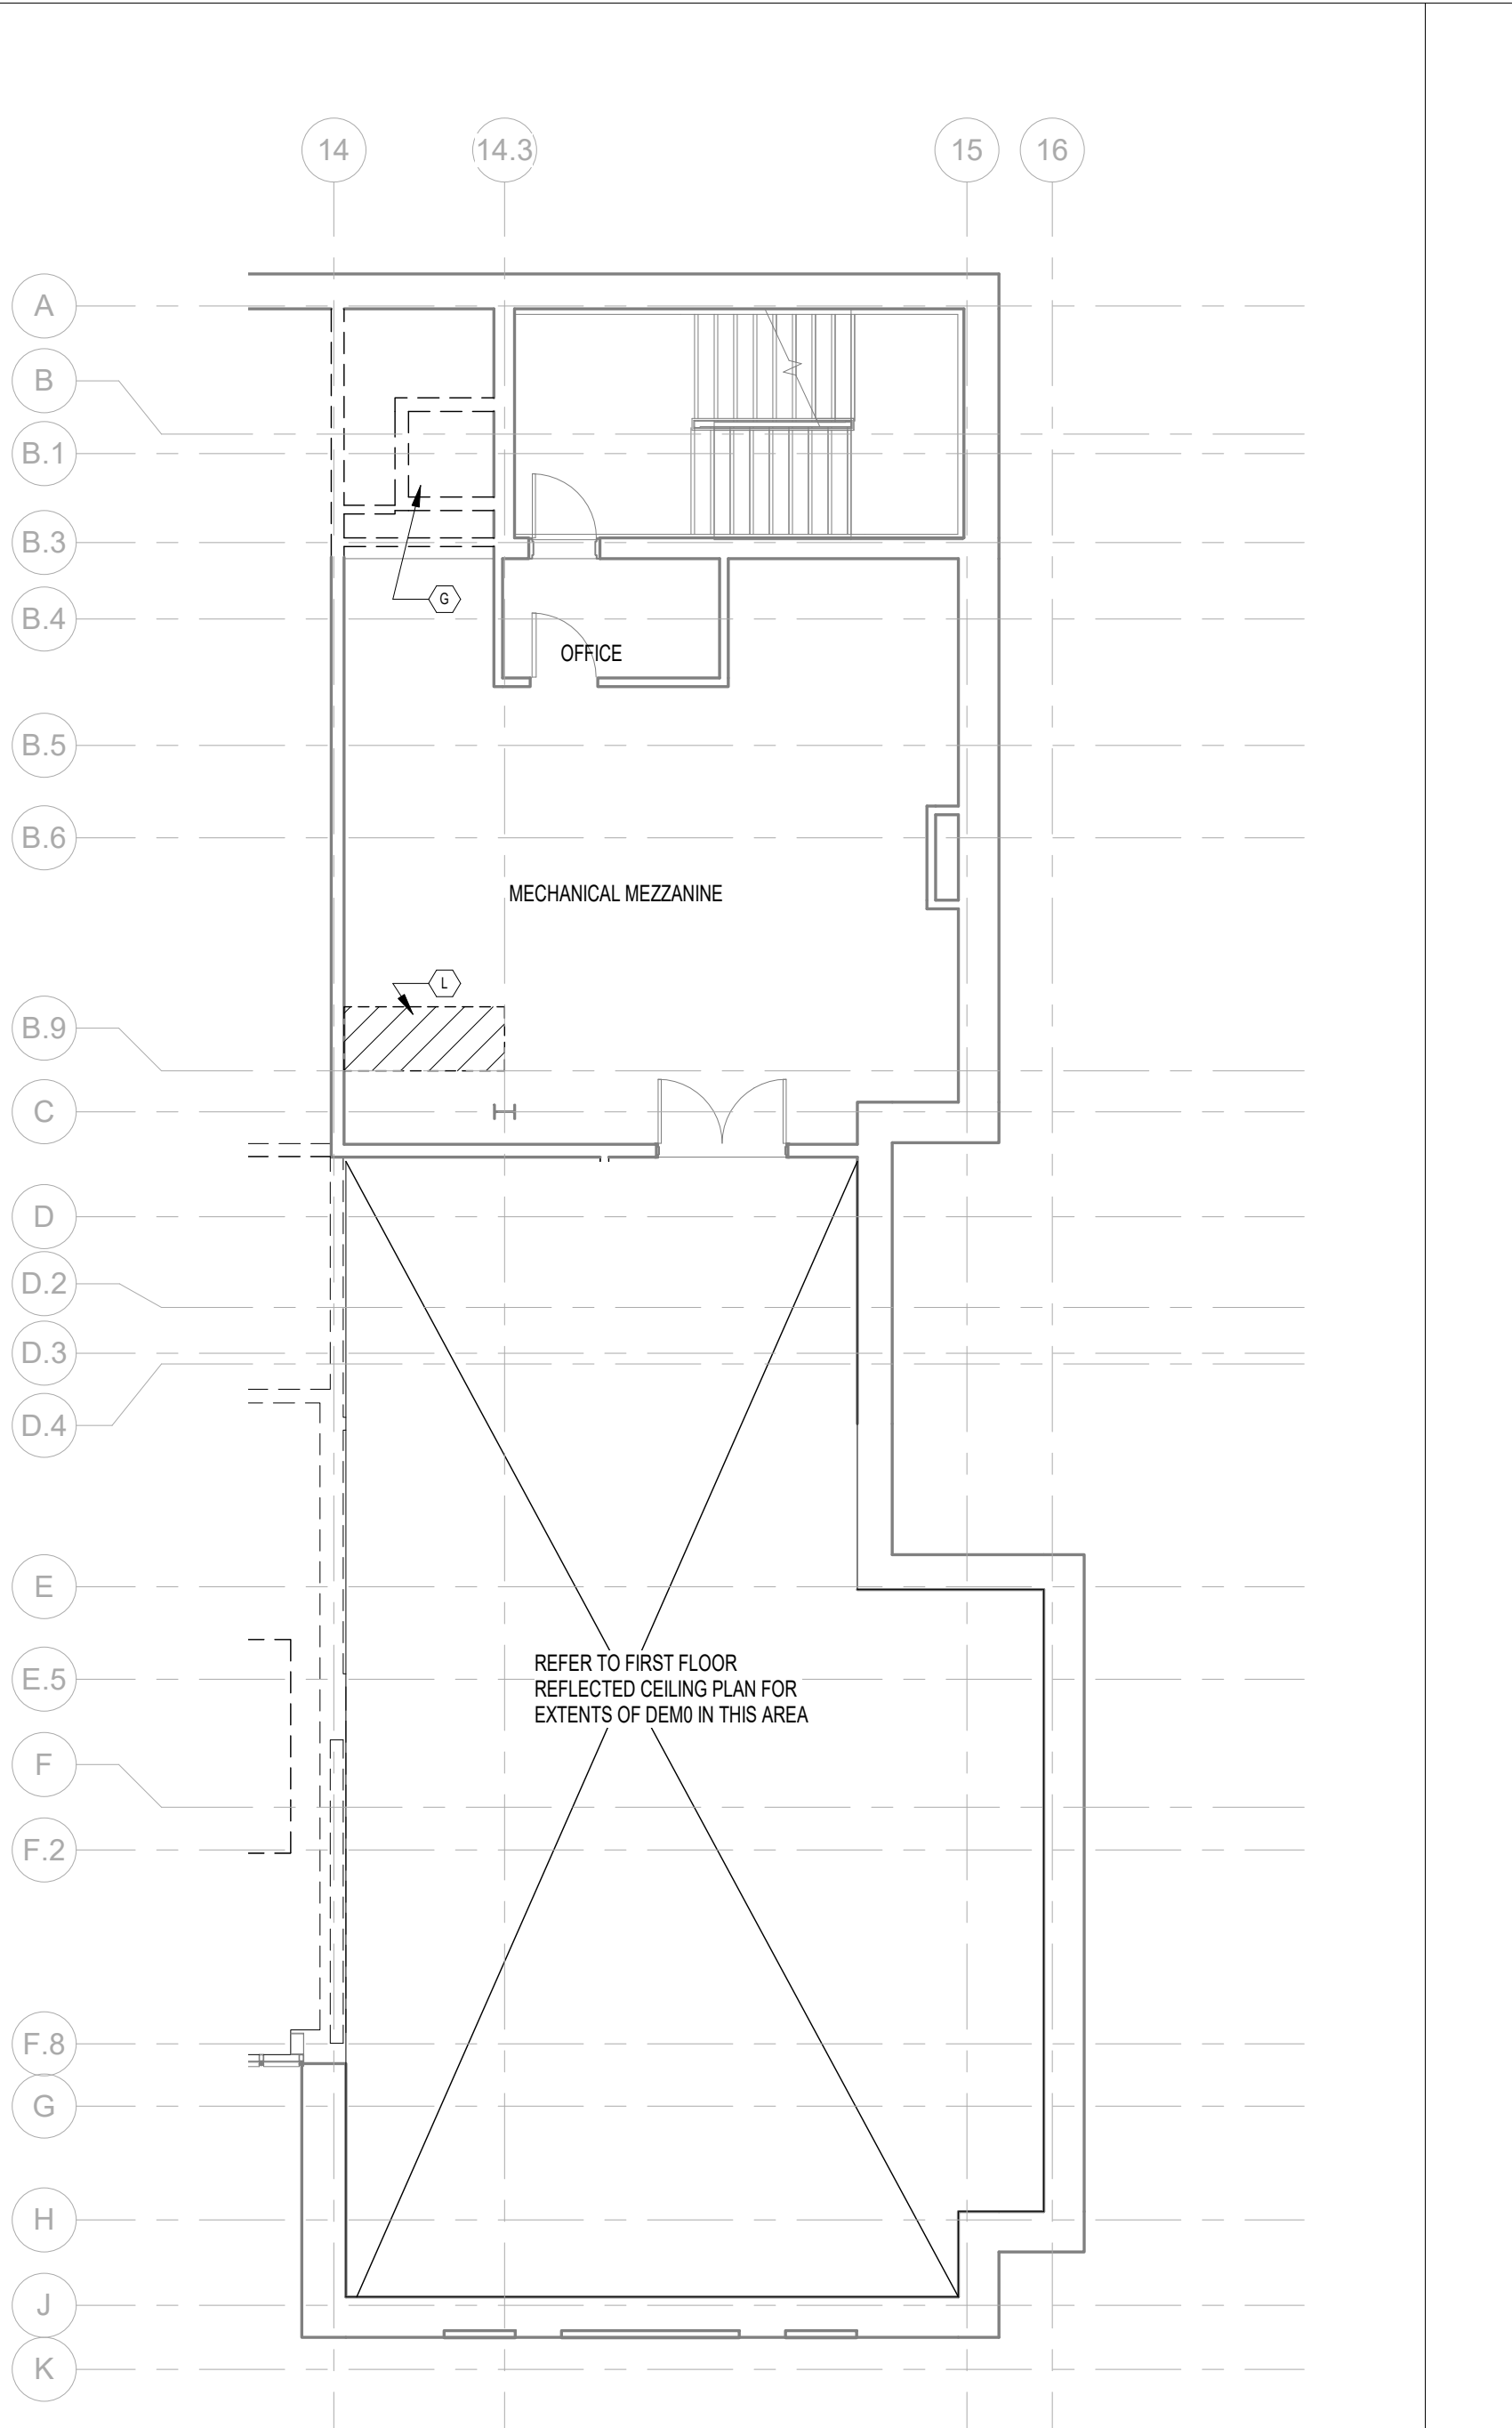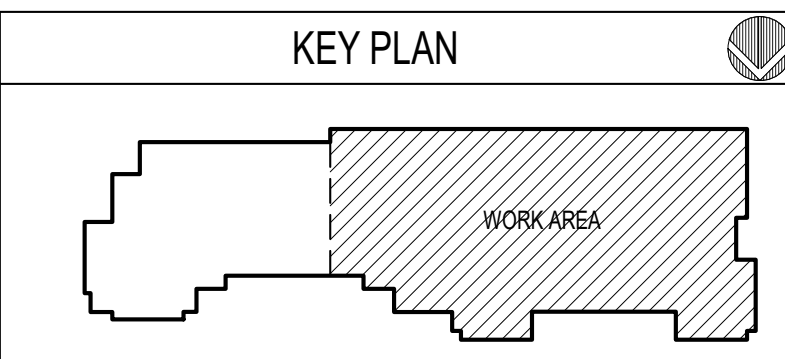

MECHANICAL MEZZANINE - EXISTING PLAN
1/8" = 1'-0"
NORTH

GENERAL DEMOLITION NOTES

- DEMOLITION NECESSARY AS A RESULT OF MEP WORK IS GENERALLY NOT INDICATED ON THE ARCHITECTURAL DRAWINGS. CONTRACTOR SHALL COORDINATE AND INCLUDE DEMOLITION WORK ASSOCIATED WITH MECHANICAL, PLUMBING AND ELECTRICAL DRAWINGS AND SPECIFICATIONS. COORDINATE DISCONNECTION AND ABANDONMENT OF ELECTRICAL, PLUMBING WASTE AND SUPPLY GAS AND OTHER UTILITIES WITH MECHANICAL, ELECTRICAL, AND PLUMBING DEMOLITION PLANS. COMPLY WITH APPLICABLE CODES FOR TERMINATION OF ALL UTILITIES.
- COORDINATE DEMOLITION OF EXISTING FIRE ALARM DEVICES WITH FIRE ALARM CONTRACTOR.
- REMOVE LOOSE AND FLAKING PAINT FROM EXISTING WALL AND HOLLOW METAL FRAME SURFACES SCHEDULED TO REMAIN AND PREP FOR NEW FINISH.
- ABANDONED FLOOR PENETRATIONS OF ELECTRICAL, PLUMBING EQUIPMENT, ANCHORS AND SIMILAR ITEMS SHALL BE REMOVED, CAPPED OR CUT OFF BELOW THE LEVEL OF NEW FINISHED FLOOR. FLOOR SHALL BE PATCHED TO RECEIVE NEW FLOOR FINISHES.
- EXISTING FIRE EXTINGUISHERS AND FIRE EXTINGUISHER CABINETS TO REMAIN.
- REMOVE DEMOLITION DEBRIS FROM SITE. DISPOSE IN ACCORDANCE WITH APPLICABLE LAWS AND REGULATIONS.
- COORDINATE PATCHING, INFILL, NEW CONSTRUCTION WITH DEMOLITION NOTES AND NEW WORK NOTES ON OTHER ARCHITECTURAL DRAWINGS.
- PATCH ABANDONED ROOF AND WALL PENETRATIONS IMMEDIATELY UPON REMOVAL OF EQUIPMENT TO WEATHERPROOF BUILDINGS.

DEMOLITION NOTES: FLOOR PLAN

- WHEN REMOVING ITEMS ATTACHED TO FINISH SURFACES TO REMAIN AND BE EXPOSED TO VIEW, REMOVE ALL EVIDENCE OF FASTENERS.
- WHERE REMOVAL OF EXISTING THRU WALL EQUIPMENT, LOUVERS, PIPING AND SIMILAR ITEMS IS NECESSARY, THE CONTRACTOR SHALL INFILL, PATCH AND MAKE WEATHERTIGHT ABANDONED WALL OPENINGS. FINISH BOTH INTERIOR AND EXTERIOR FINISH SURFACES TO MATCH EXISTING CONDITIONS. WEATHERPROOF THE OPENING IMMEDIATELY UPON REMOVAL OF THE DEMOLISHED ITEM.
- WHERE MISCELLANEOUS EXTERIOR MECHANICAL EQUIPMENT IS REMOVED, BUT NOT REPLACED, REMOVE ABANDONED CONCRETE EQUIPMENT PADS. RESTORE DISTURBED AREAS TO MATCH ADJACENT SURFACES.
- CONTRACTOR SHALL PROTECT ITEMS SCHEDULED TO REMAIN.
- OWNER WILL REMOVE AND RELOCATE MOVEABLE ITEMS OF VALUE, SUCH AS CHAIRS, DESKS, COMPUTERS, CLOCKS, MIRRORS, POSTERS, PICTURES, FLAGS, PROJECTION SCREENS, SUPPLIES, TABLES, CURTAINS, CURTAIN RODS, MICROWAVES, CUBBIES, SHELVES AND ACTIVE BOARDS, ETC., EXCEPT AS SPECIFICALLY NOTED OTHERWISE. OWNER WILL PROVIDE STORAGE AS NECESSARY TO ACCOMMODATE OWNERS FURNISHINGS FOR DURATION OF PROJECT.

DEMOLITION NOTES: FLOOR PLAN


- REMOVE CARPET TILES AS REQUIRED TO INSTALL NEW INTERIOR PARTITIONS. STORE SALVAGEABLE CARPET TILES FOR REINSTALLATION. PATCH AND OTHERWISE REPAIR ANY IRREGULARITIES IN EXISTING SUBSTRATE AS REQUIRED TO PREPARE FOR INSTALLATION OF NEW FLOOR FINISHES.
- REMOVE & DISPOSE OF PERIMETER WOOD WAINSCOT.
- REMOVE & DISPOSE OF GWB AND METAL STUD PARTITION. PATCH GWB CEILING AS NECESSARY.
- REMOVE & DISPOSE OF EXISTING DOOR, HINGES, HARDWARE, AND FRAME.
- REMOVE EXISTING DOOR, HINGES AND ASSOCIATED HARDWARE TO BE REUSED. SEE NOTE ON SHEET A100.1 AND A100.2.
- REMOVE AV SCREENS AND EQUIPMENT (REMOVAL BY CAPD STAFF).
- REMOVE & DISPOSE OF EXISTING FLOOR FINISHES. PATCH AND/OR OTHERWISE REPAIR ANY IRREGULARITIES IN EXISTING SUBSTRATE AS REQUIRED TO PREPARE FOR PROPER INSTALLATION OF NEW FLOOR FINISHES.
- REMOVE EXISTING DUMBWAITER AND RETURN TO OWNER. REMOVE AND DISPOSE OF DUMBWAITER ENCLOSURE (CMU PARTITIONS).
- REMOVE AND DISPOSE OF EXISTING CONCRETE FLOOR SLAB AS REQUIRED FOR INSTALLATION OF NEW FREIGHT ELEVATOR. EXTENTS OF DEMOLITION TO BE DETERMINED BY REQUIREMENTS OF NEW FREIGHT ELEVATOR HOISTWAY.

DEMOLITION NOTES: FLOOR PLAN


- REMOVE AND DISPOSE OF EXISTING CURTAINWALL SYSTEM, GLAZING AND MULLIONS AS REQUIRED TO ACCOMMODATE FUTURE DOOR.
- REMOVE & DISPOSE OF BASEBOARD.
- REMOVE & DISPOSE OF EXISTING STAGE.
- REMOVE AND DISPOSE OF EXISTING CONCRETE SLAB AS REQUIRED TO ACCOMMODATE NEW FLOOR CHASER. COORDINATE WITH STRUCTURAL & MEP FOR EXACT LOCATION AND SIZES.
- REMOVE AND DISPOSE OF EXISTING BRICK BENCH WITH PRECAST CAP. REPAIR EDGE OF PAVERS (AND/OR REPLACE) AS REQ. COORDINATE WITH NEW WORK AS SHOWN ON SHEET A105.
- NO WORK IN THIS ROOM.
- REMOVE AND DISPOSE OF EXISTING CURTAINS.
- REMOVE AND DISPOSE OF EXISTING CASED OPENING AND TRIM.
- REMOVE AND DISPOSE OF EXISTING INTERIOR STOREFRONT SYSTEM.

DEMOLITION NOTES: FLOOR PLAN


- REMOVE AND DISPOSE OF EXISTING PLYWOOD SCREEN MOUNTING BOARD.
- REMOVE & DISPOSE OF GWB AND METAL STUDS IN AREA FOR NEW OPENING AND PATCH ADJACENT GWB FINISH AS NECESSARY. SEE DOOR AND WINDOW ELEVATIONS FOR EXTENTS OF DEMOLITION.
- REMOVE EXISTING PROJECTOR SCREEN AND ANY ADDITIONAL AV ACCESSORIES (REMOVAL BY CAPD STAFF).
- REMOVE AND RETURN TO OWNER EXISTING CAROUSEL BENCH. PATCH EXISTING CONCRETE AND PAVERS AS REQUIRED.
- REMOVE AND DISPOSE OF STAIR GUARDRAIL EXTENSION. PATCH AND OTHERWISE REPAIR ANY IRREGULARITIES IN EXISTING SUBSTRATE AS REQUIRED TO PREPARE FOR INSTALLATION OF NEW FLOOR FINISHES. CONFIRM OWNER DOES NOT WANT TO SALVAGE GUARDRAIL PRIOR TO DISPOSAL PROCESS.
- REMOVE AND DISPOSE OF CMU PARTITIONS AS REQUIRED TO ACCOMMODATE NEW DOOR AND DOOR FRAME. PATCH CMU.

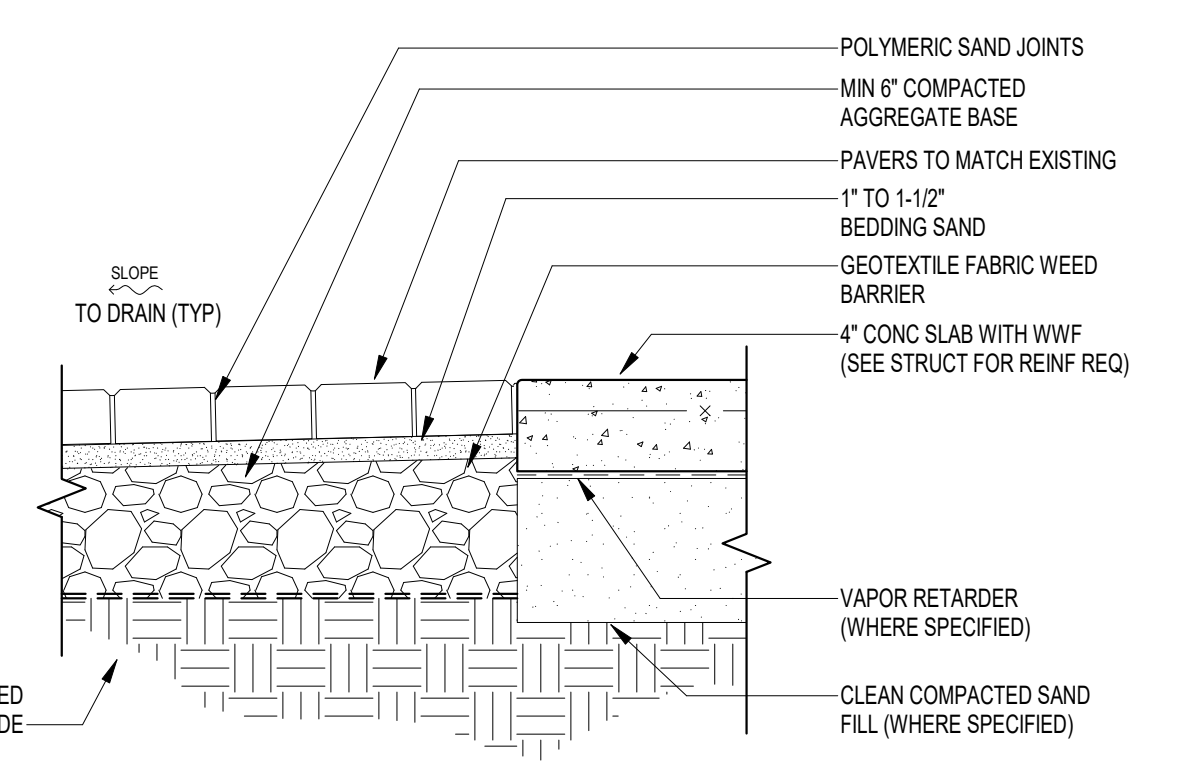


3 PAVER DETAIL
A105 / 1 1/2" = 1'-0"

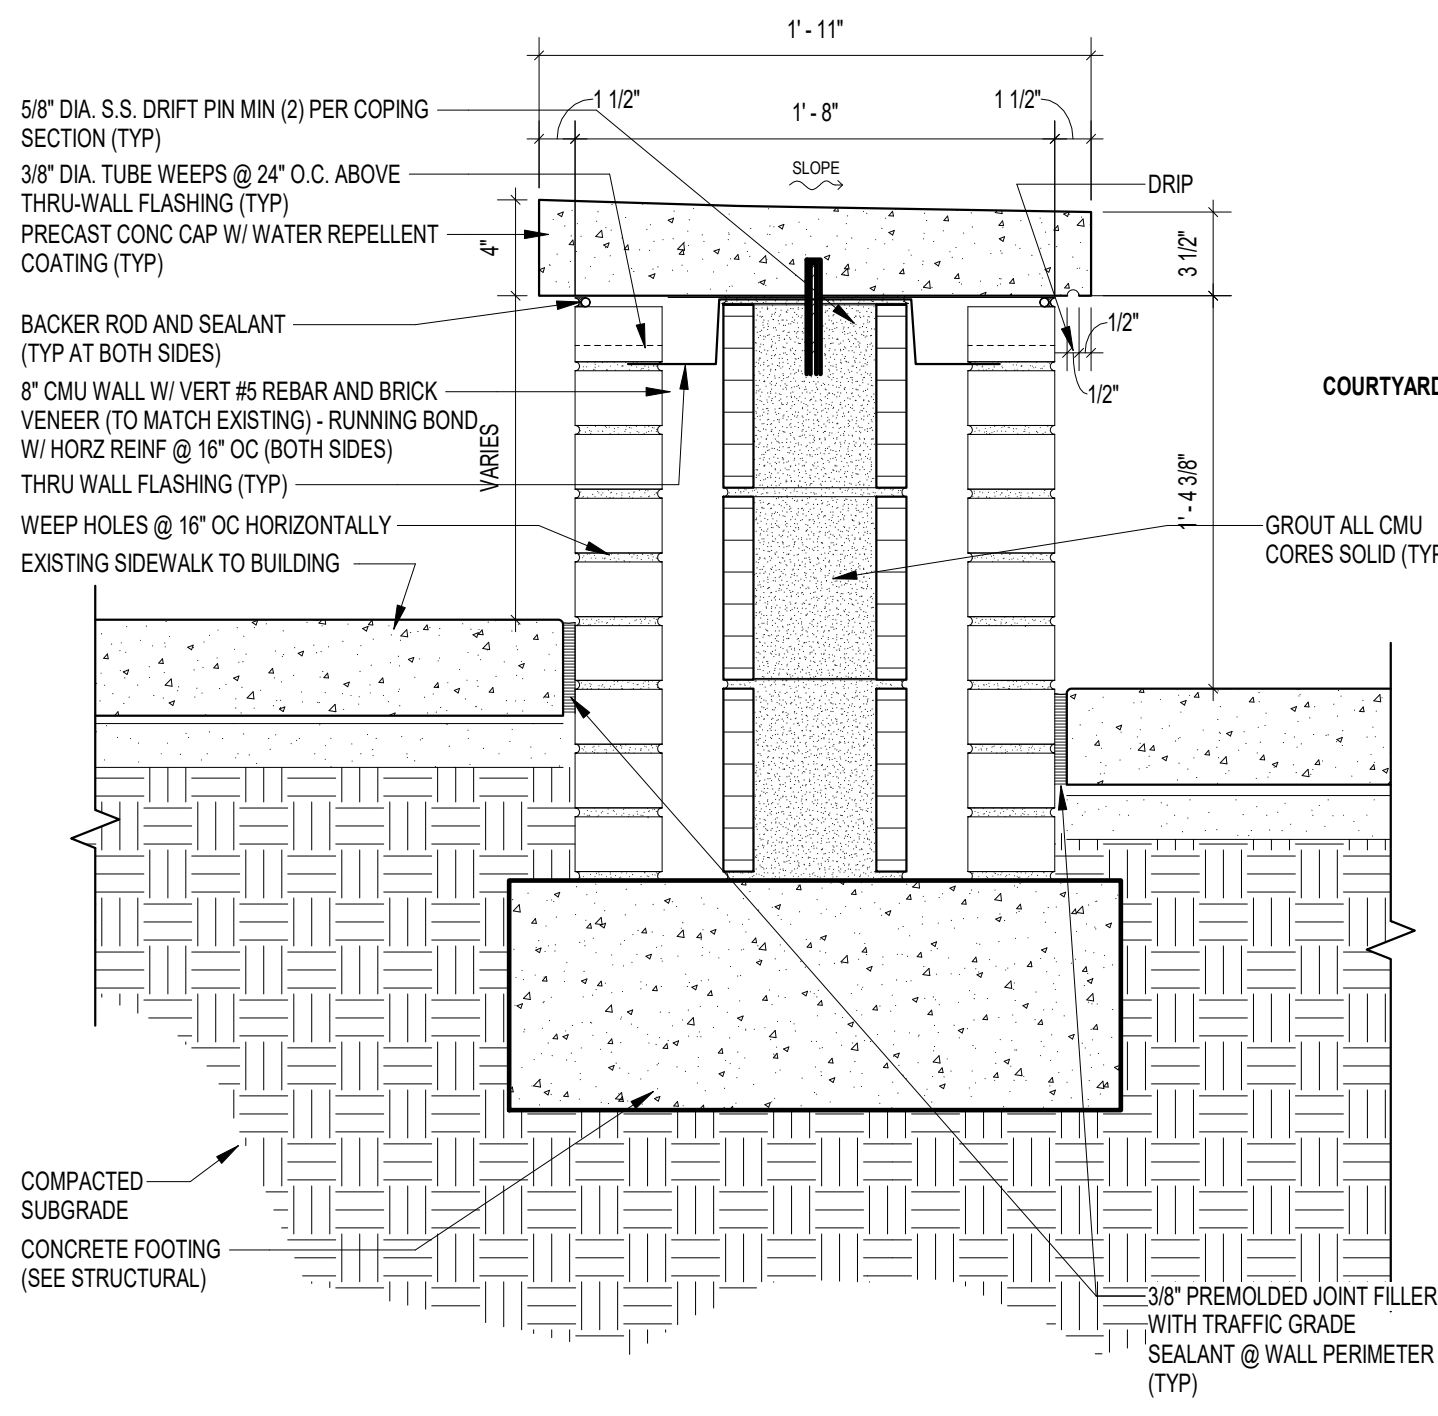


4 BENCH
A105 / 1 1/2" = 1'-0"

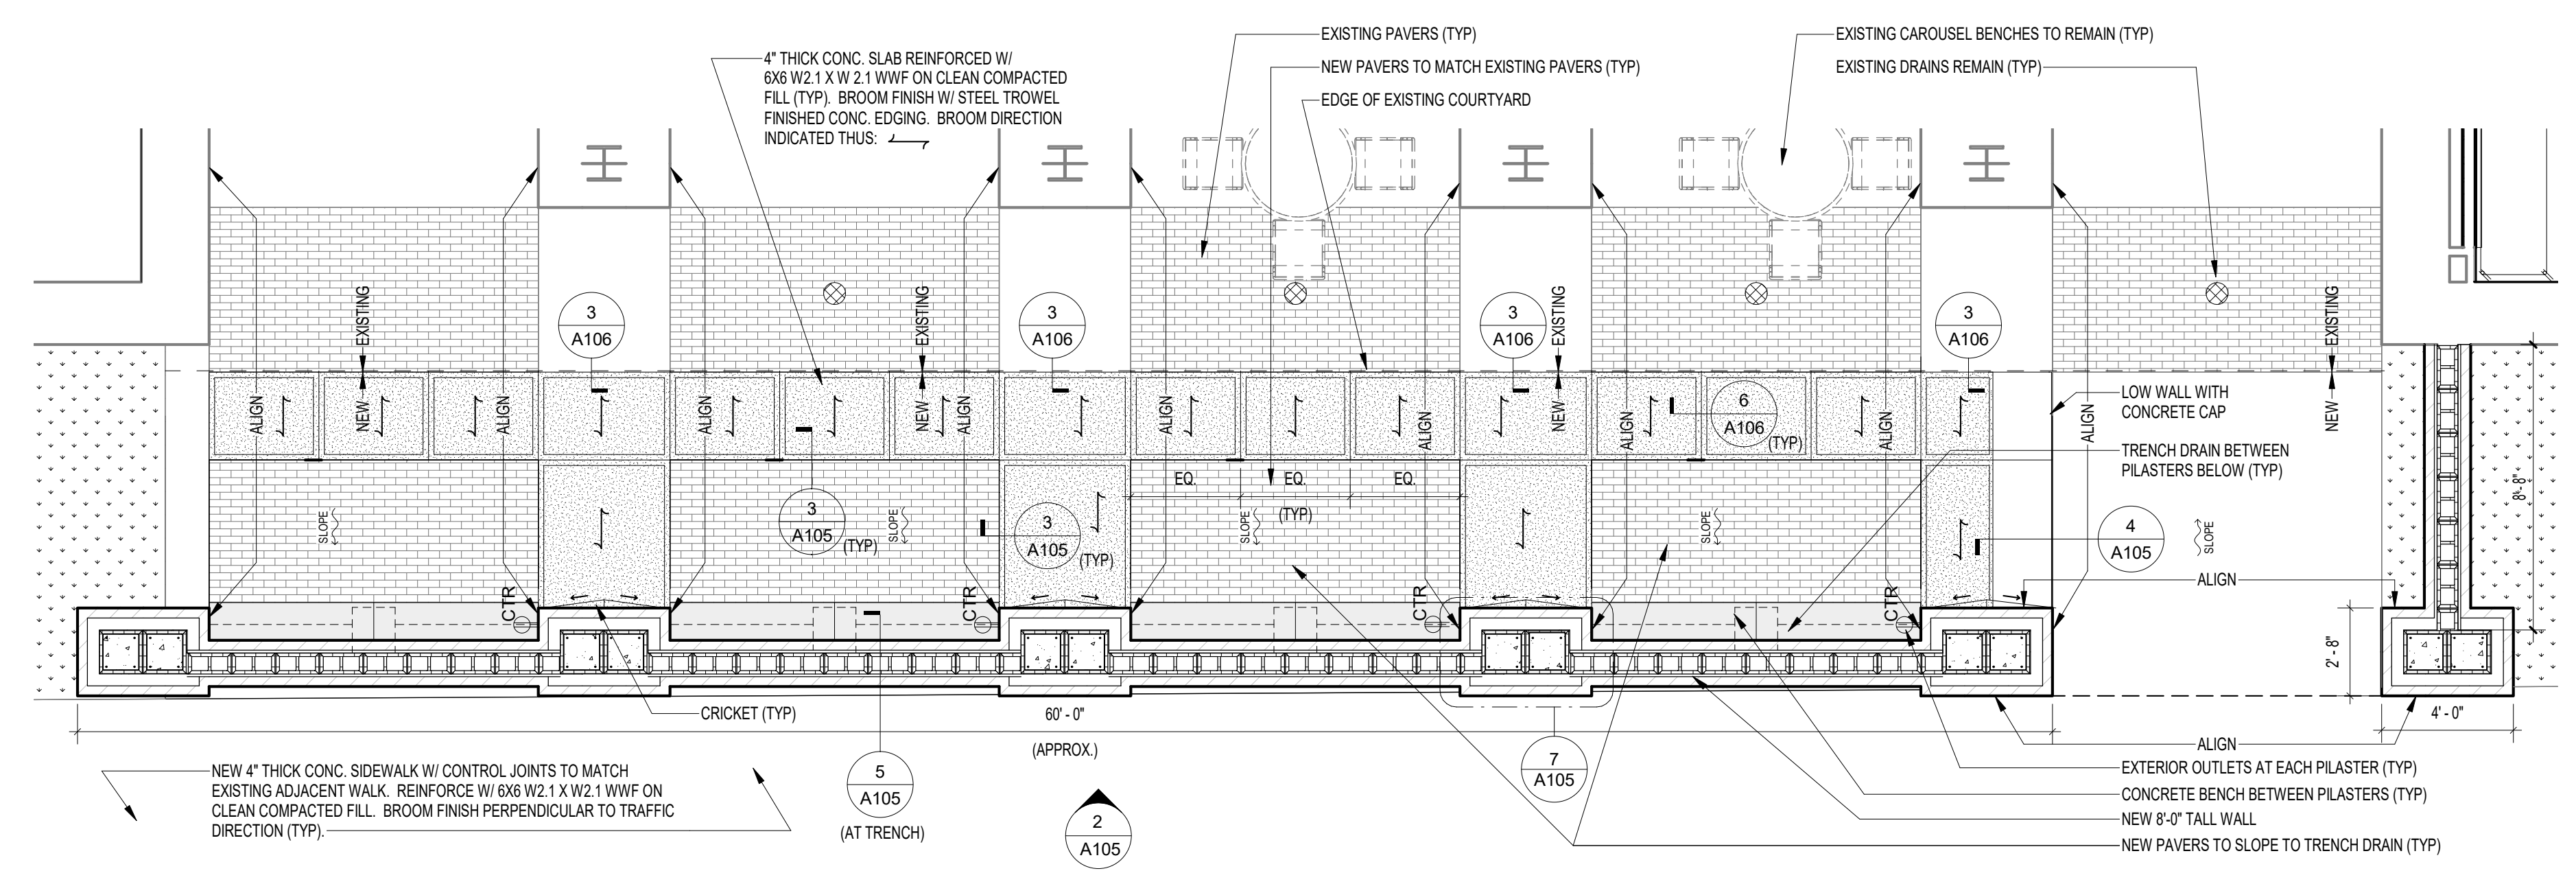


1 SITE-COURTYARD ENLARGED PLAN
A105 / 1/4" = 1'-0" (SEE NEW FLOOR PLAN FOR LOCATION)

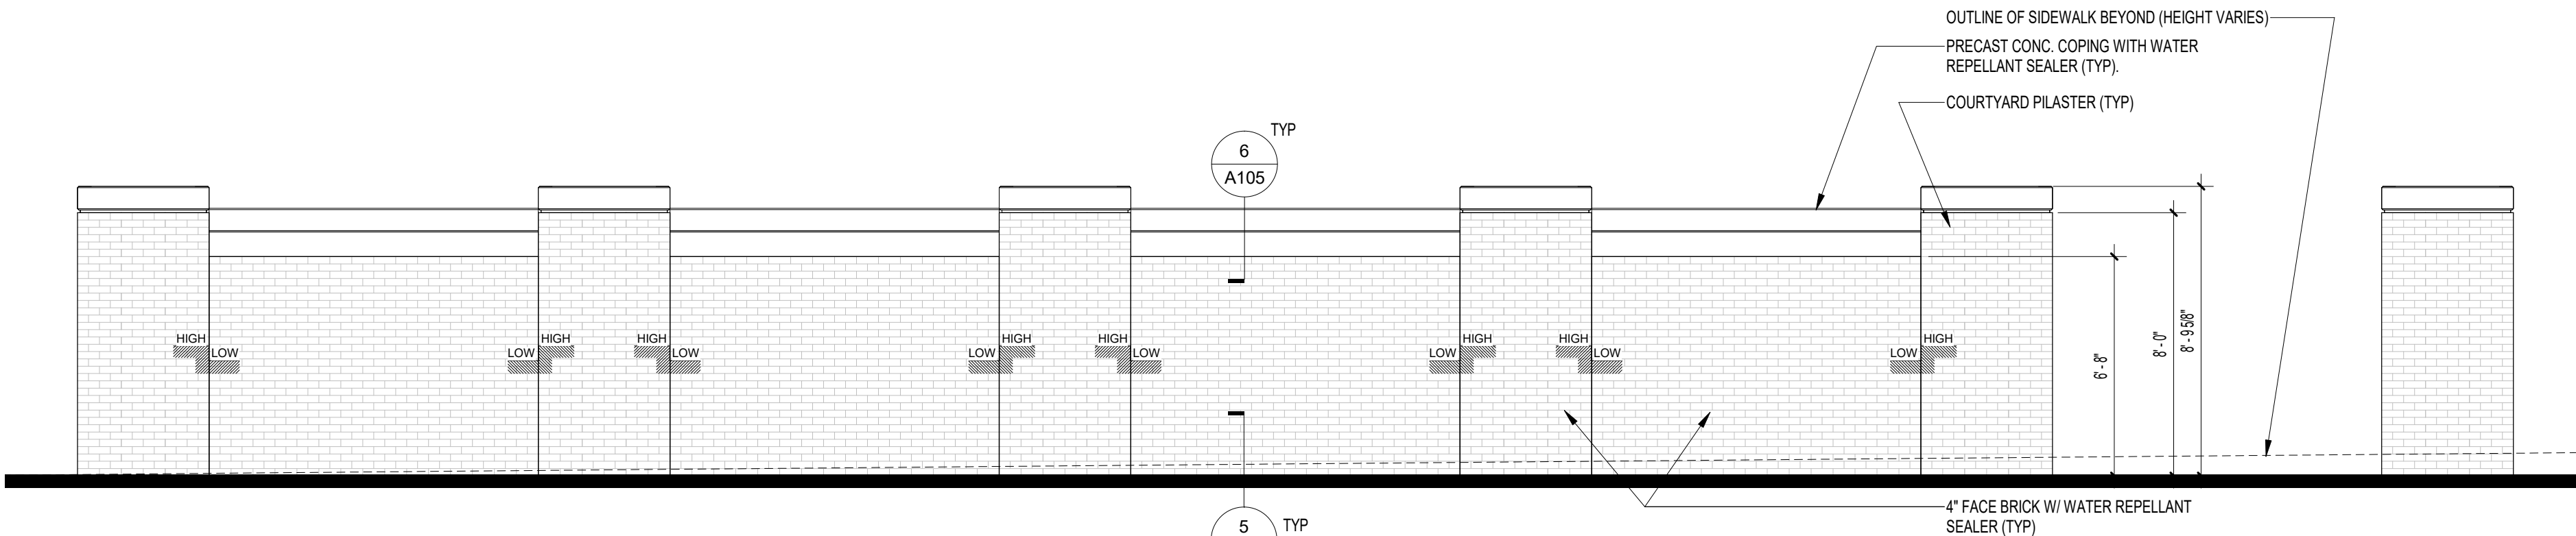


2 COURTYARD WALL ELEVATION
A105 / 1/4" = 1'-0"

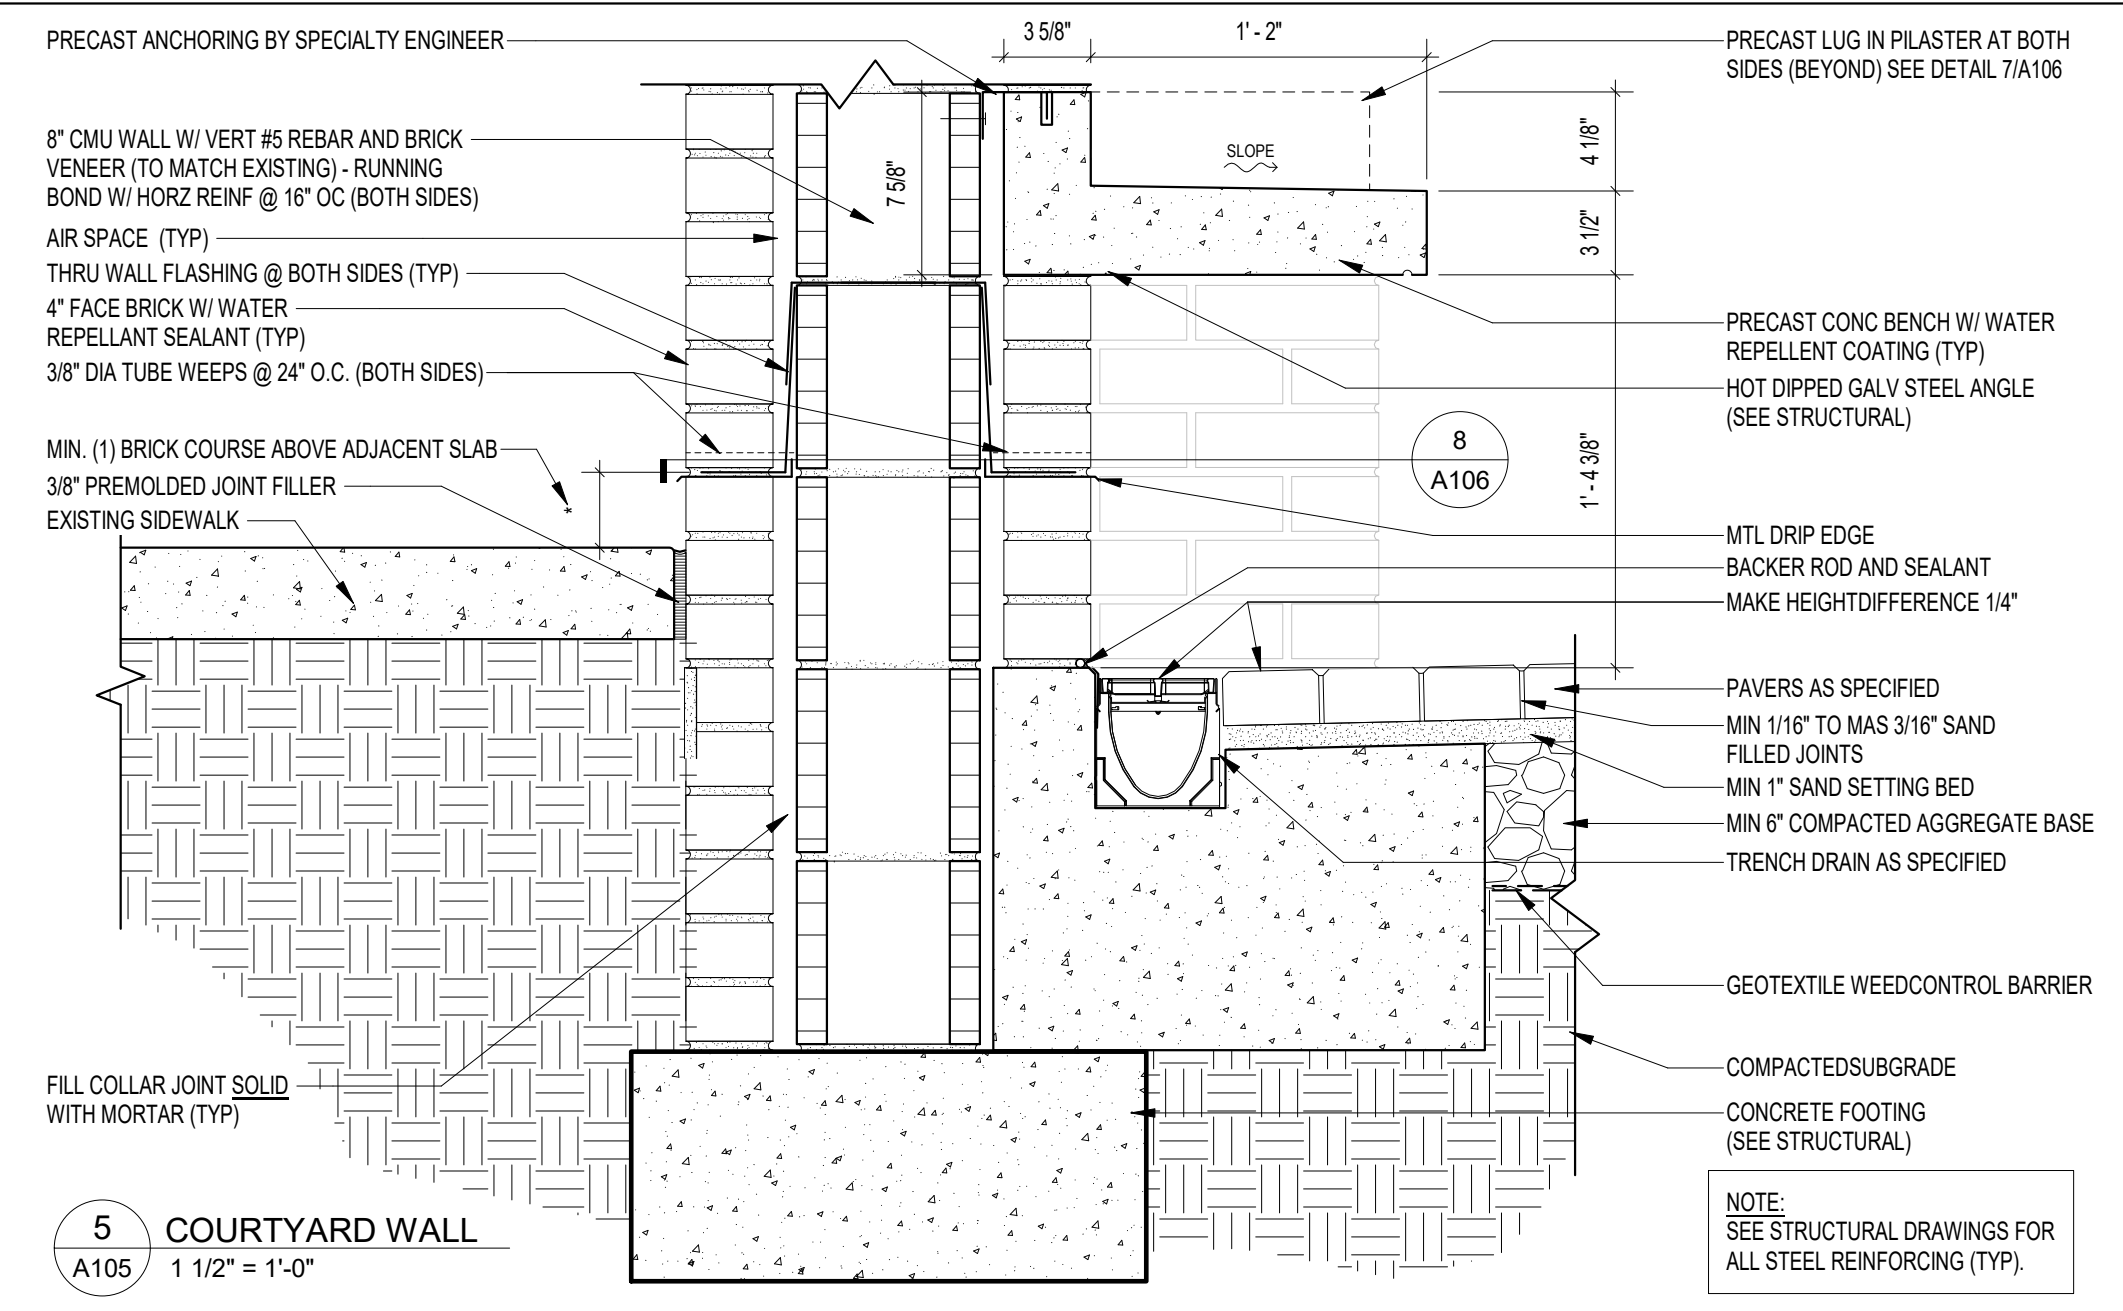

5 COURTYARD WALL
A105 / 1 1/2" = 1'-0"

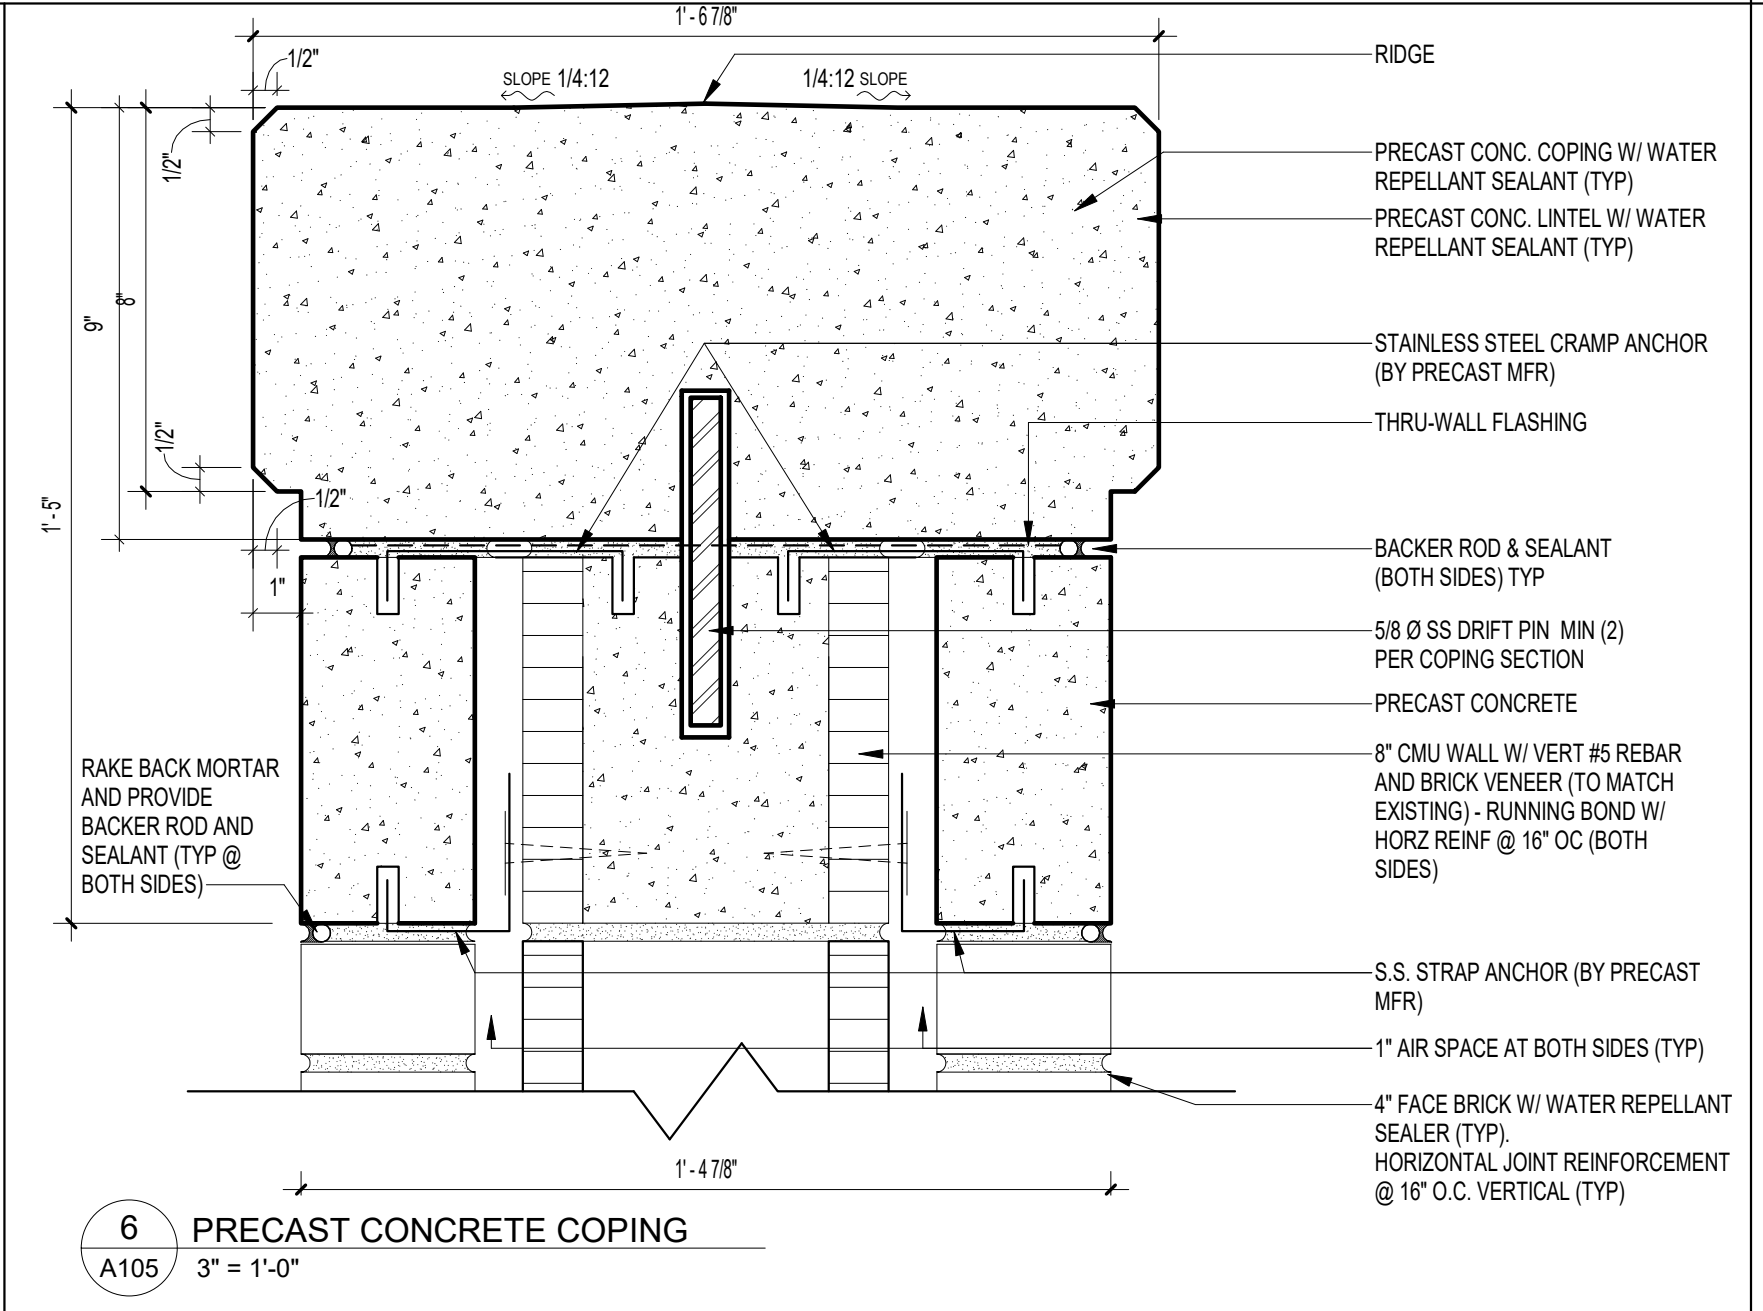

6 PRECAST CONCRETE COPING
A105 / 3" = 1'-0"

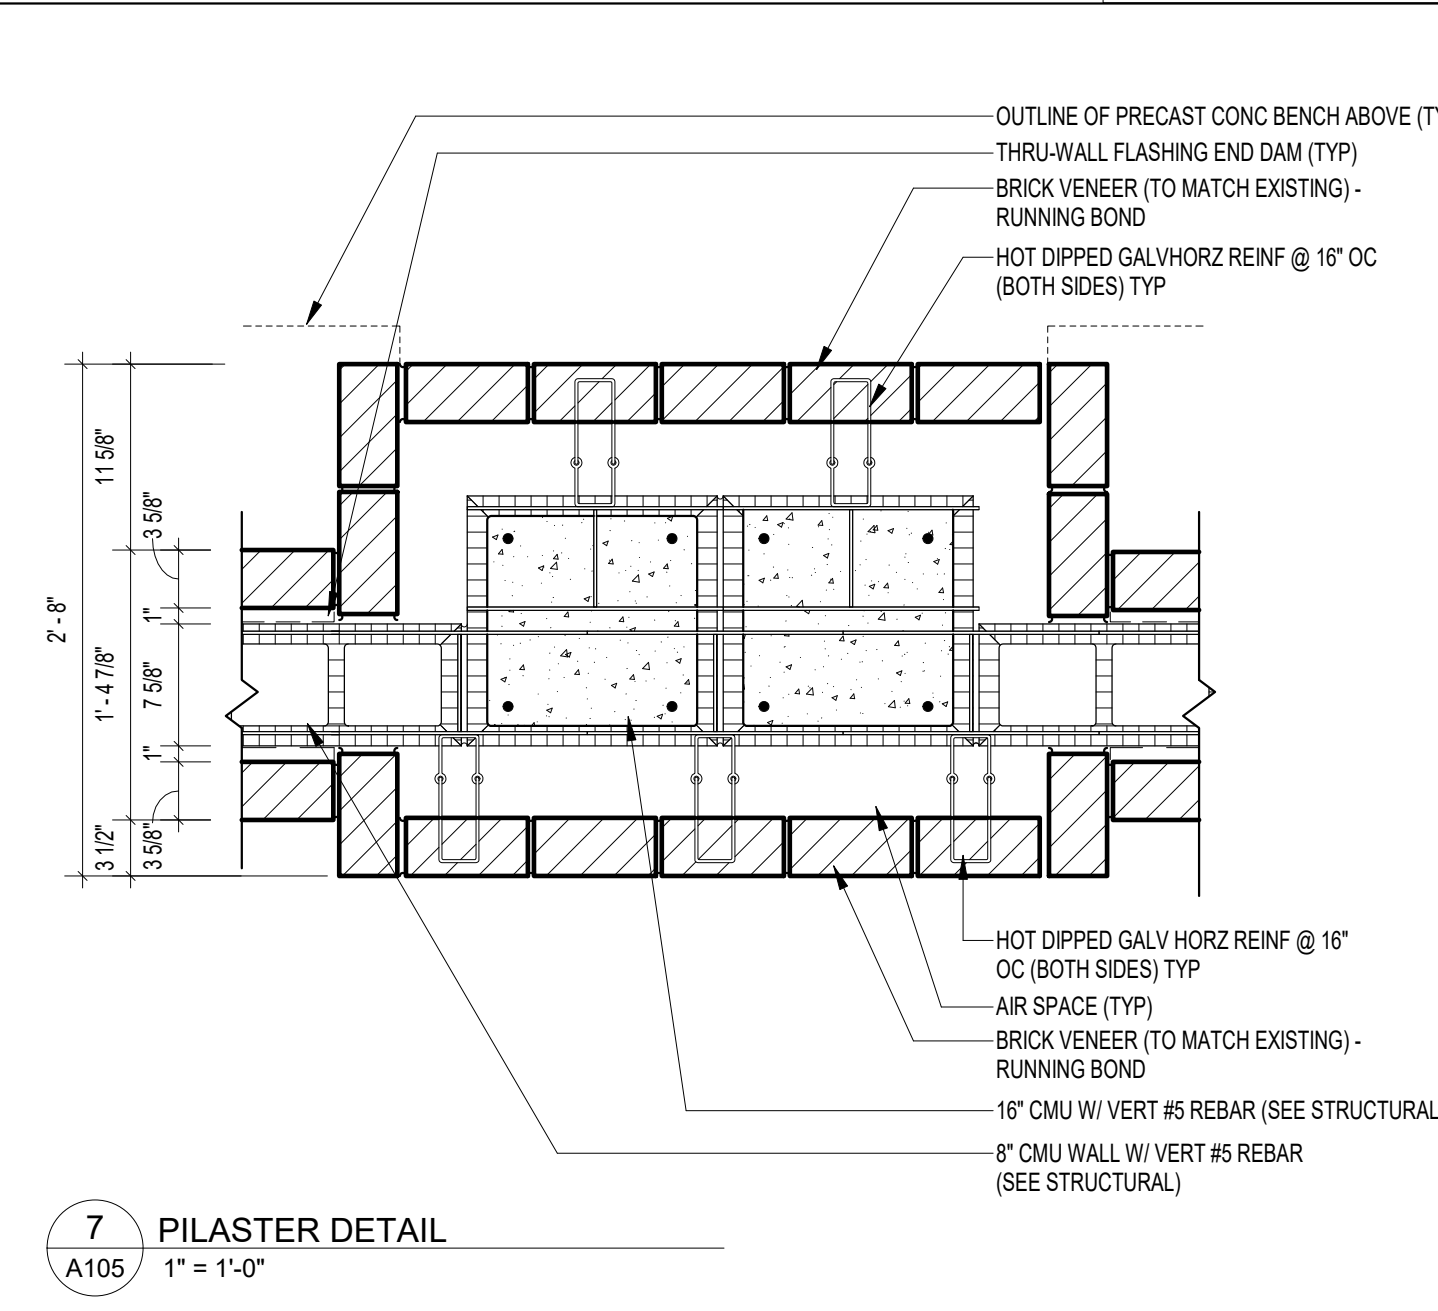

7 PILASTER DETAIL
A105 / 1" = 1'-0"

NOTE:
11" x 17" SHEETS ARE PLOTTED AT 1/2
THE SCALE NOTED ON THESE DRAWINGS

FSU TURNBULL CONFERENCE CENTER RENOVATIONS

REV	DATE	DESCRIPTION

PROJECT PHASE CONSTRUCTION DOCUMENTS	
DATE 18 OCTOBER 2023	DRAWN BY RMP/BI
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SHEET TITLE SITE DETAILS	
SHEET NO A105	REV NO

NOTE:
11' x 17" SHEETS ARE PLOTTED AT 1/2
THE SCALE NOTED ON THESE DRAWINGS

**FSU TURNBULL
CONFERENCE CENTER
RENOVATIONS**









REV	DATE	DESCRIPTION

PROJECT PHASE
CONSTRUCTION DOCUMENTS

DATE 18 OCTOBER 2023	DRAWN BY RMP
PROJECT NO 74000	CHECKED BY RMP/BI

SHEET TITLE
SITE DETAILS

SHEET NO A106	REV NO
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NOTE:
11' x 17' SHEETS ARE PLOTTED AT 1/2
THE SCALE NOTED ON THESE DRAWINGS

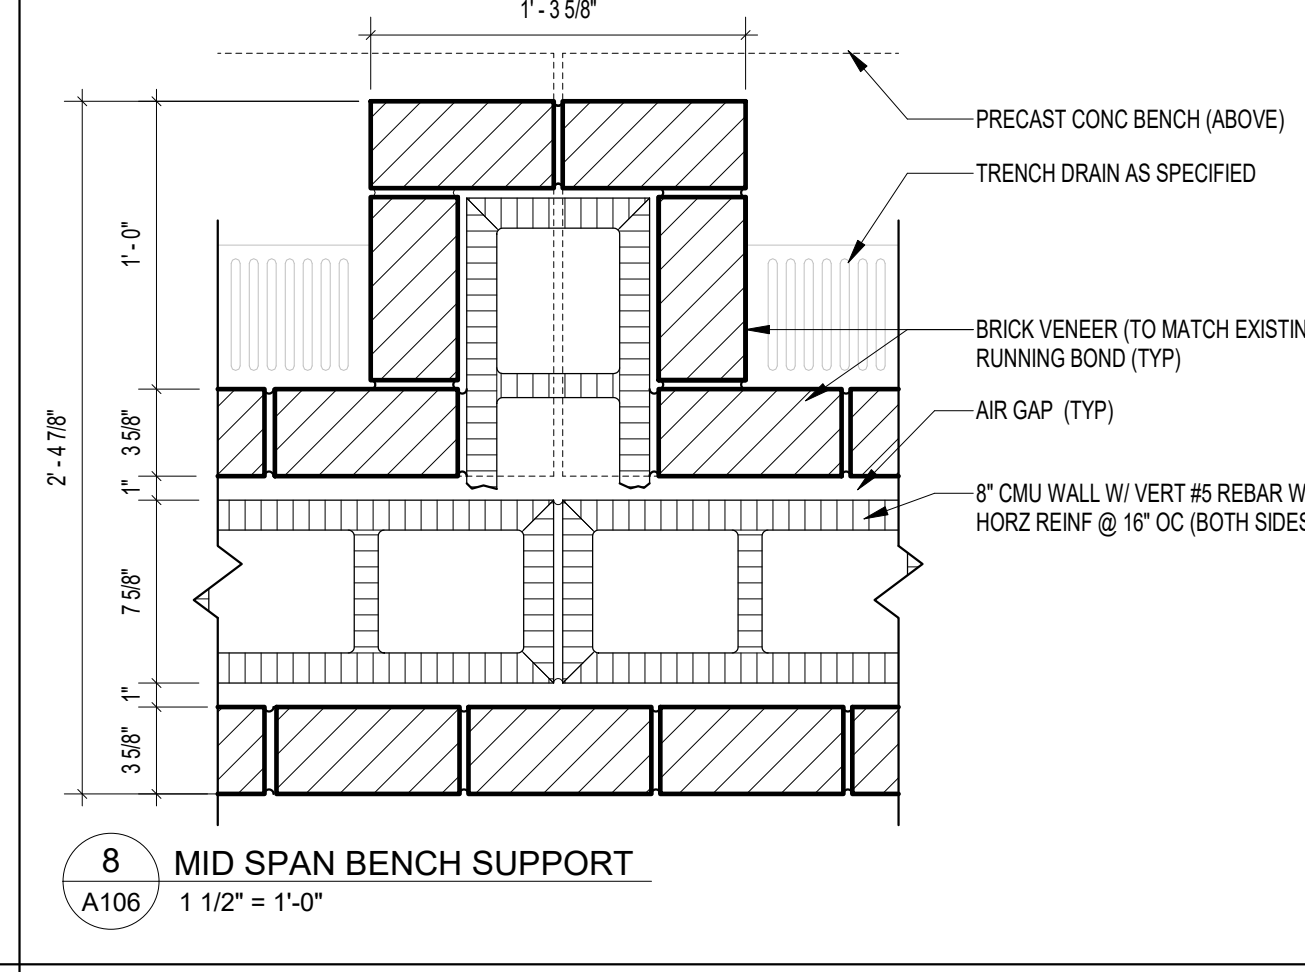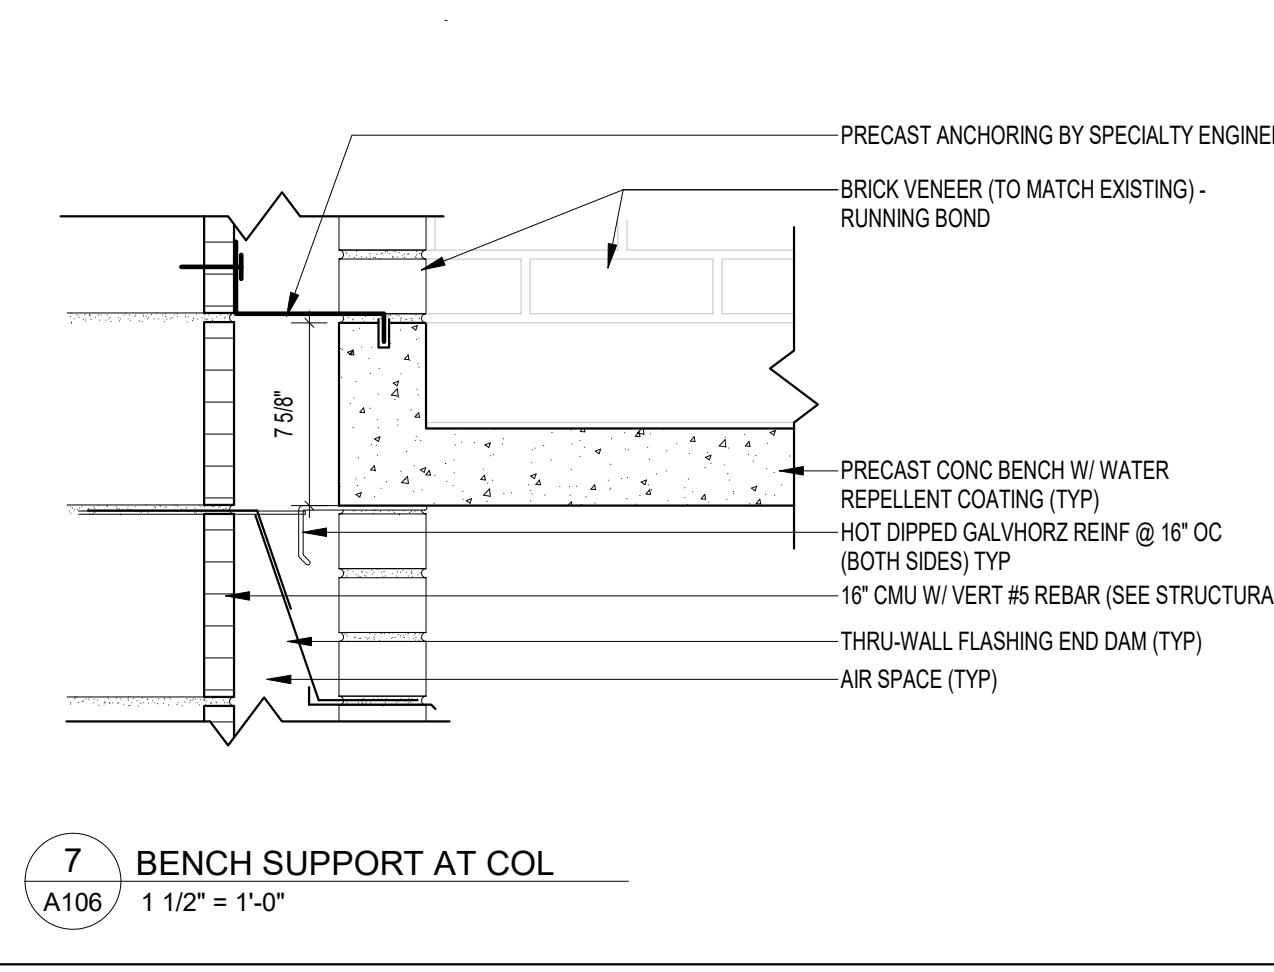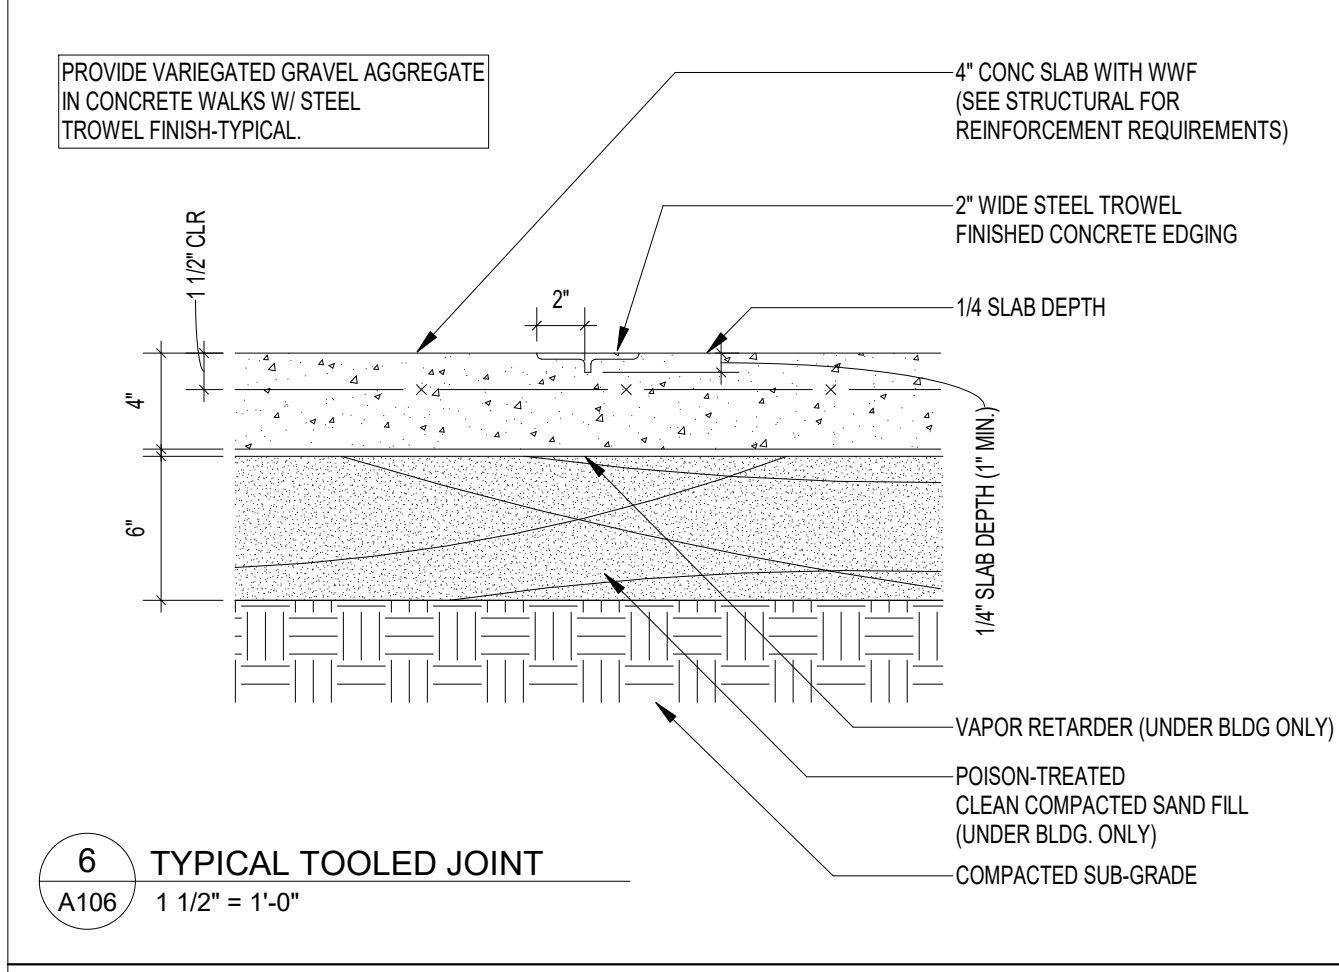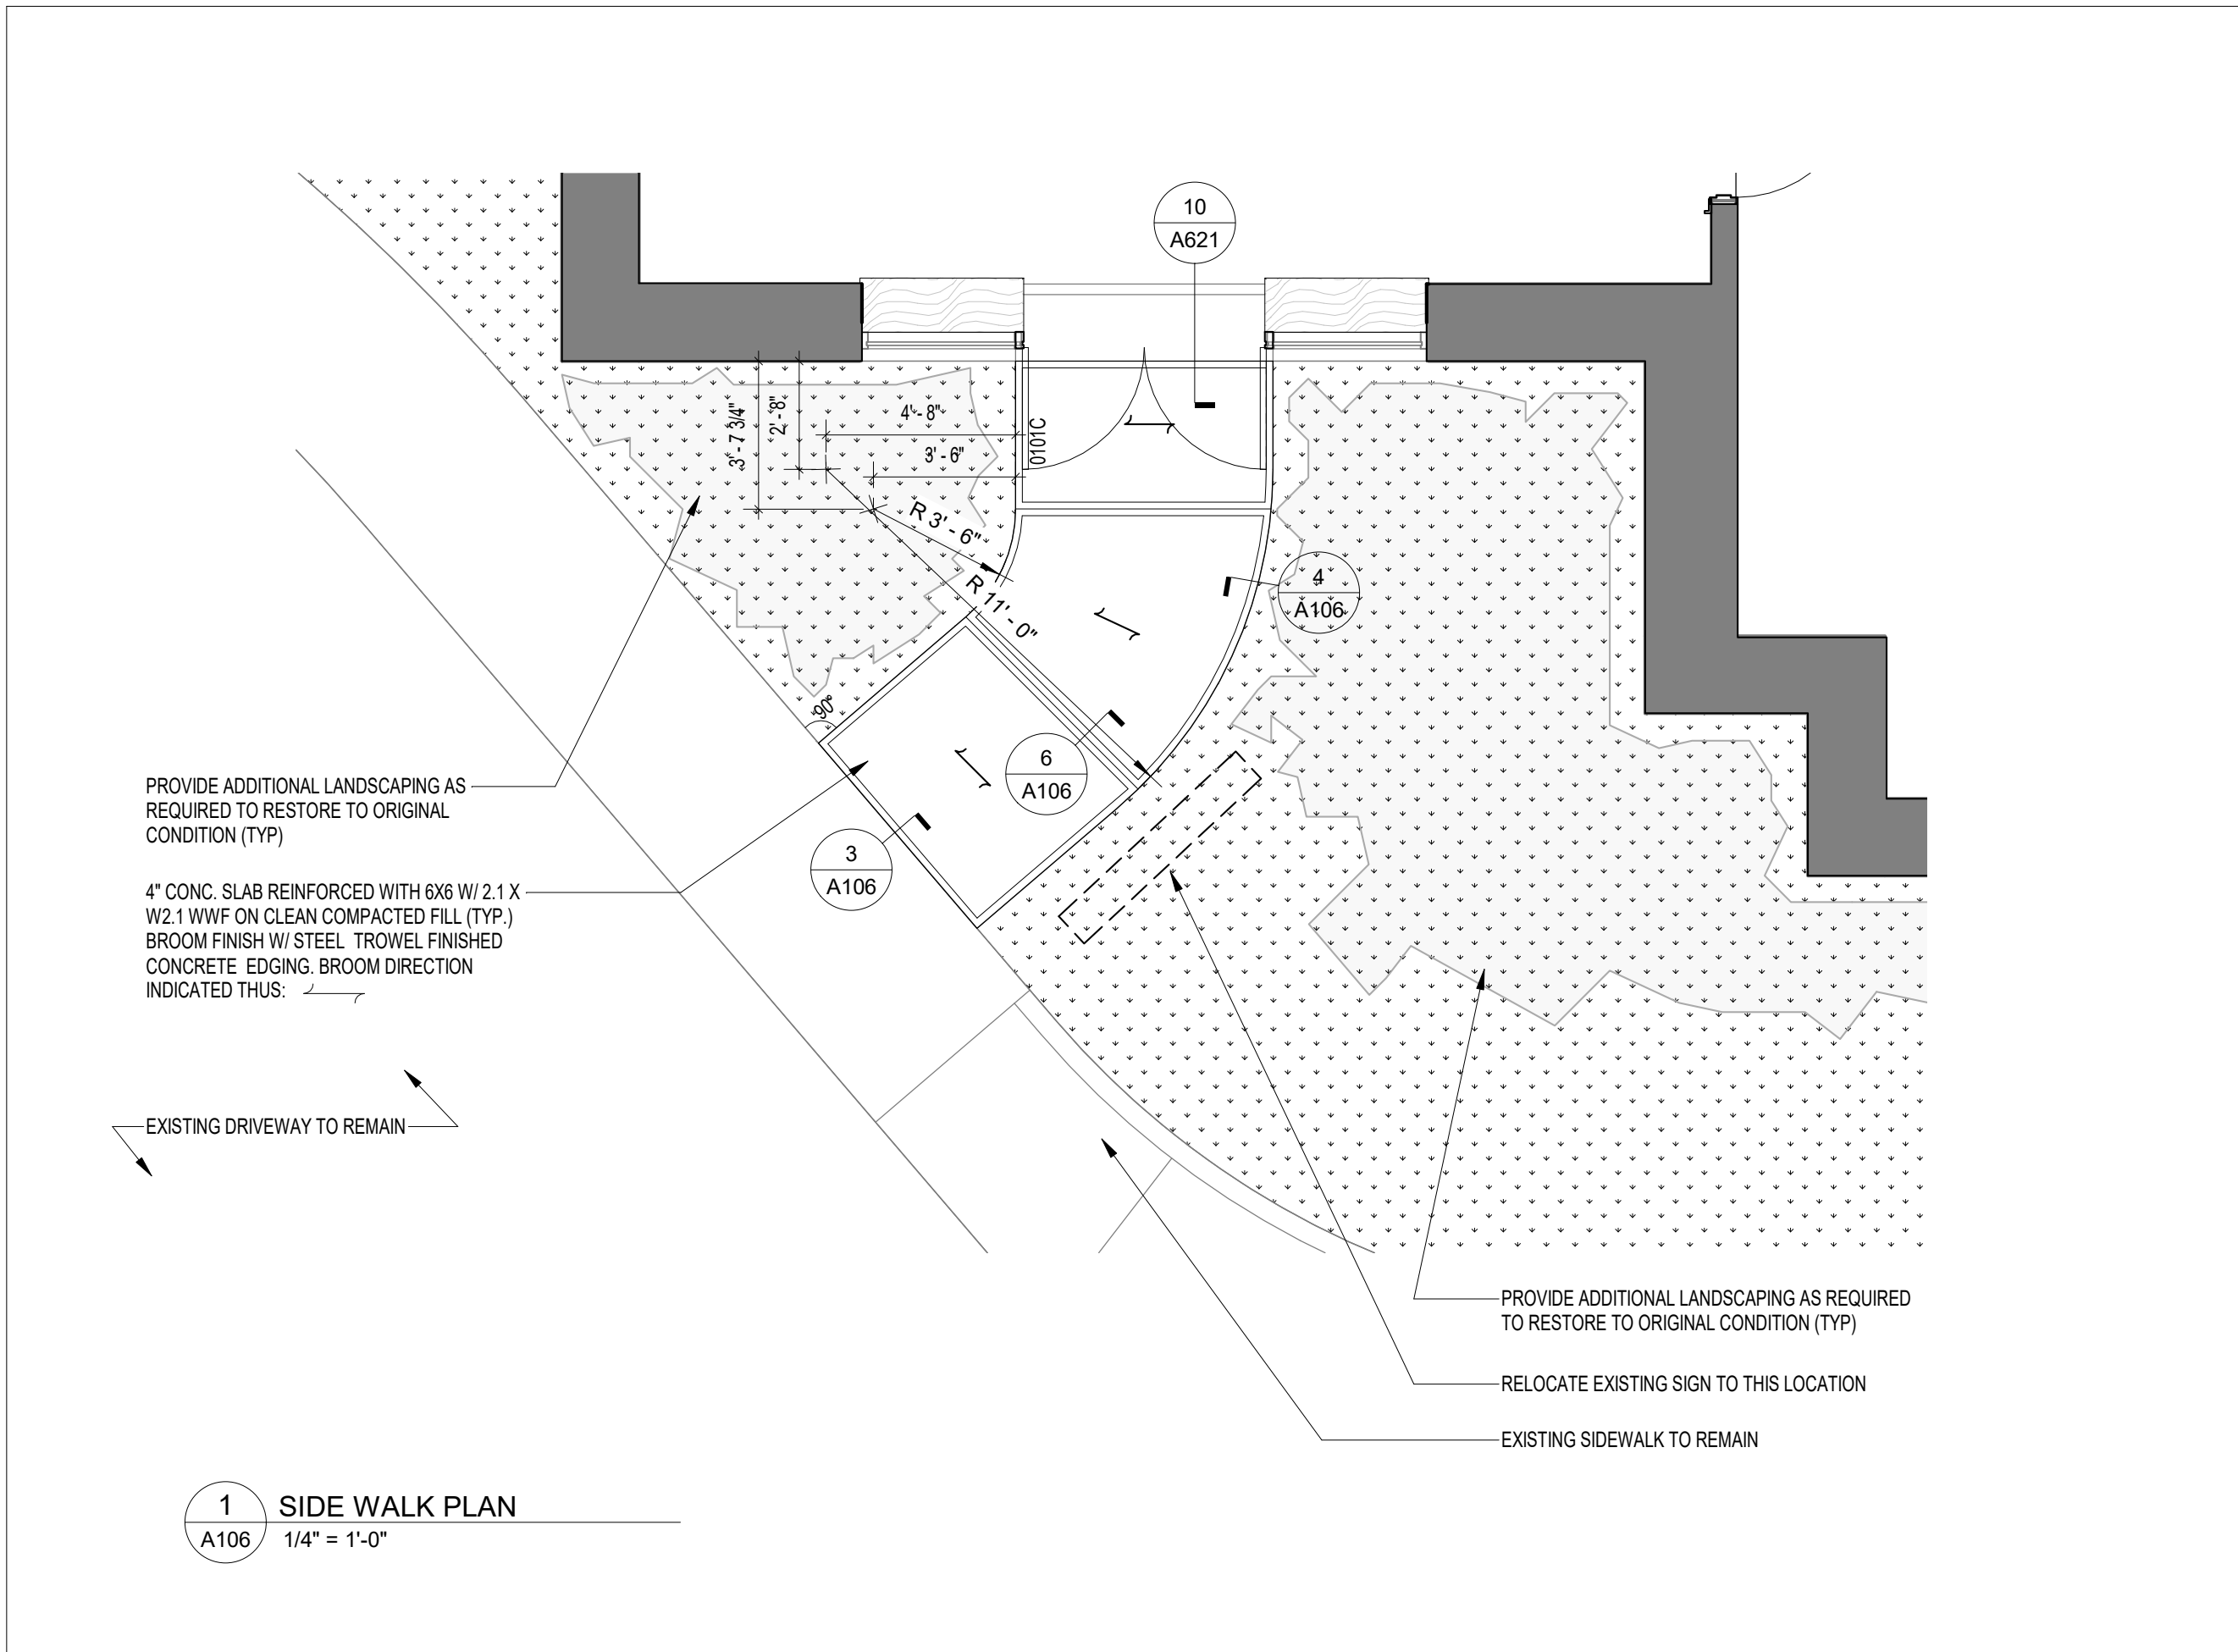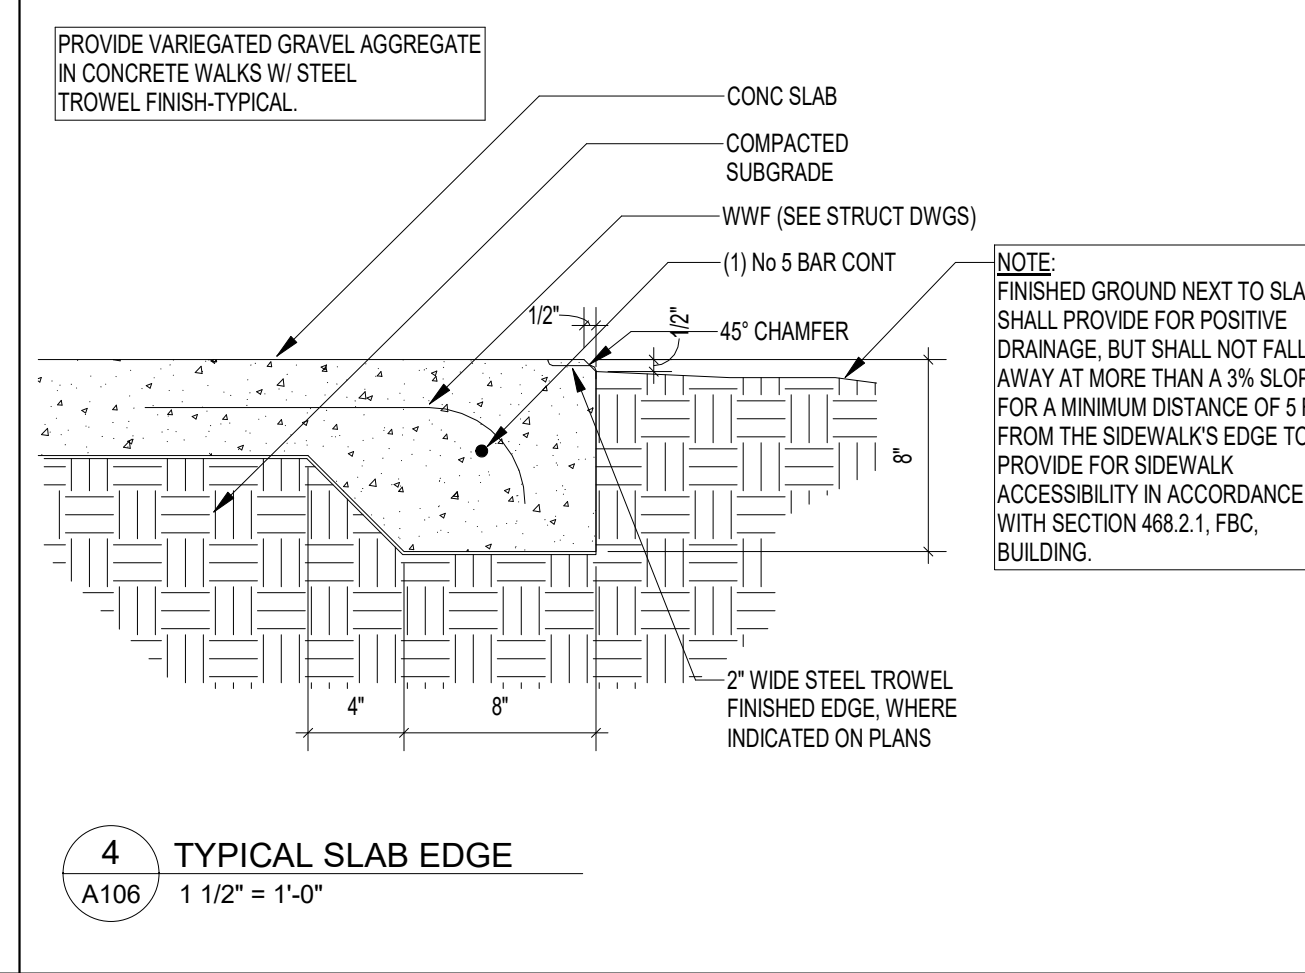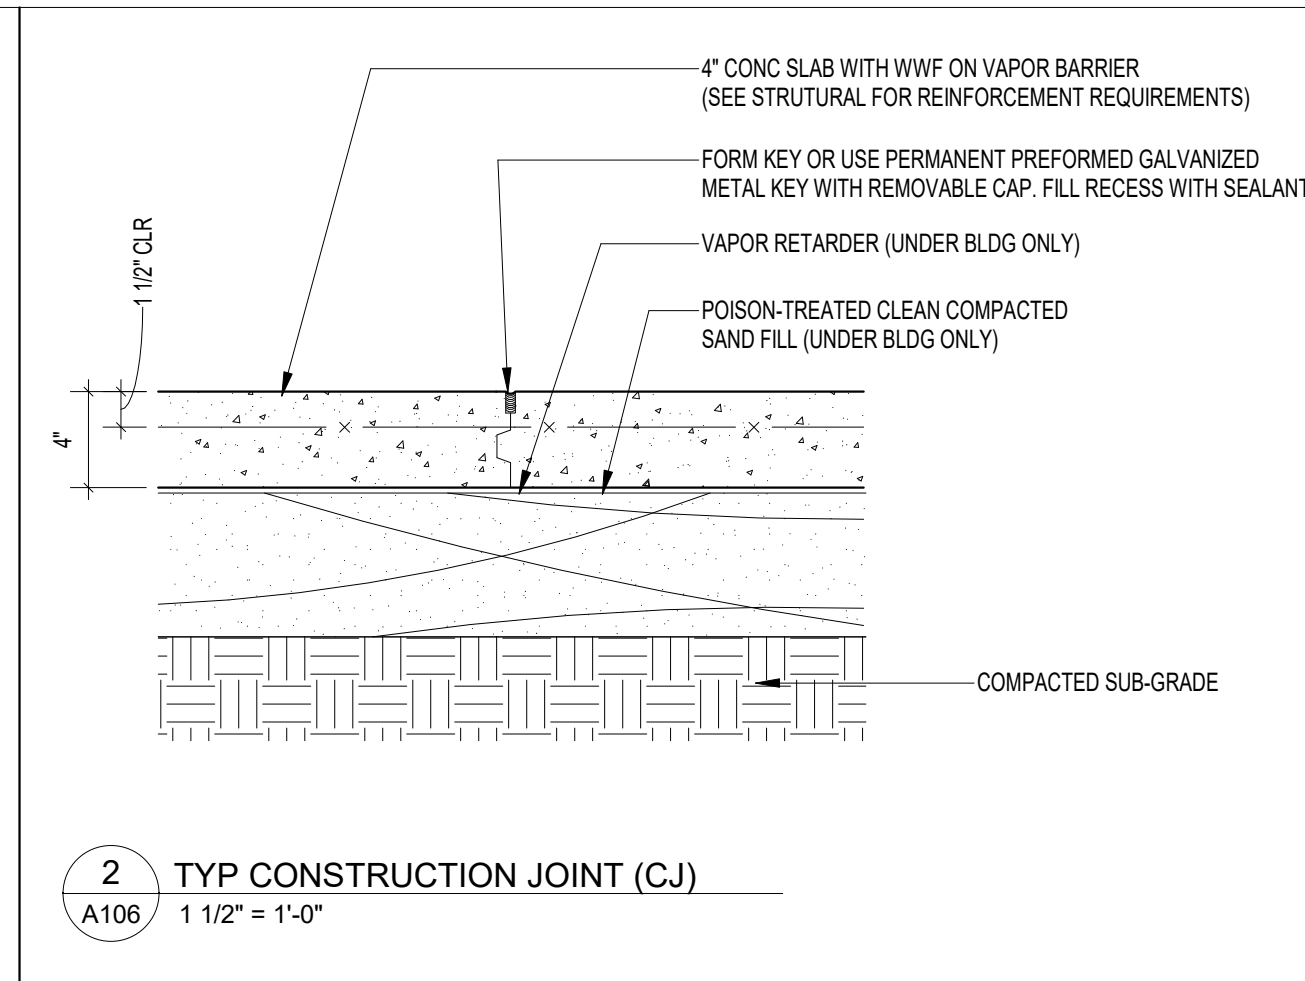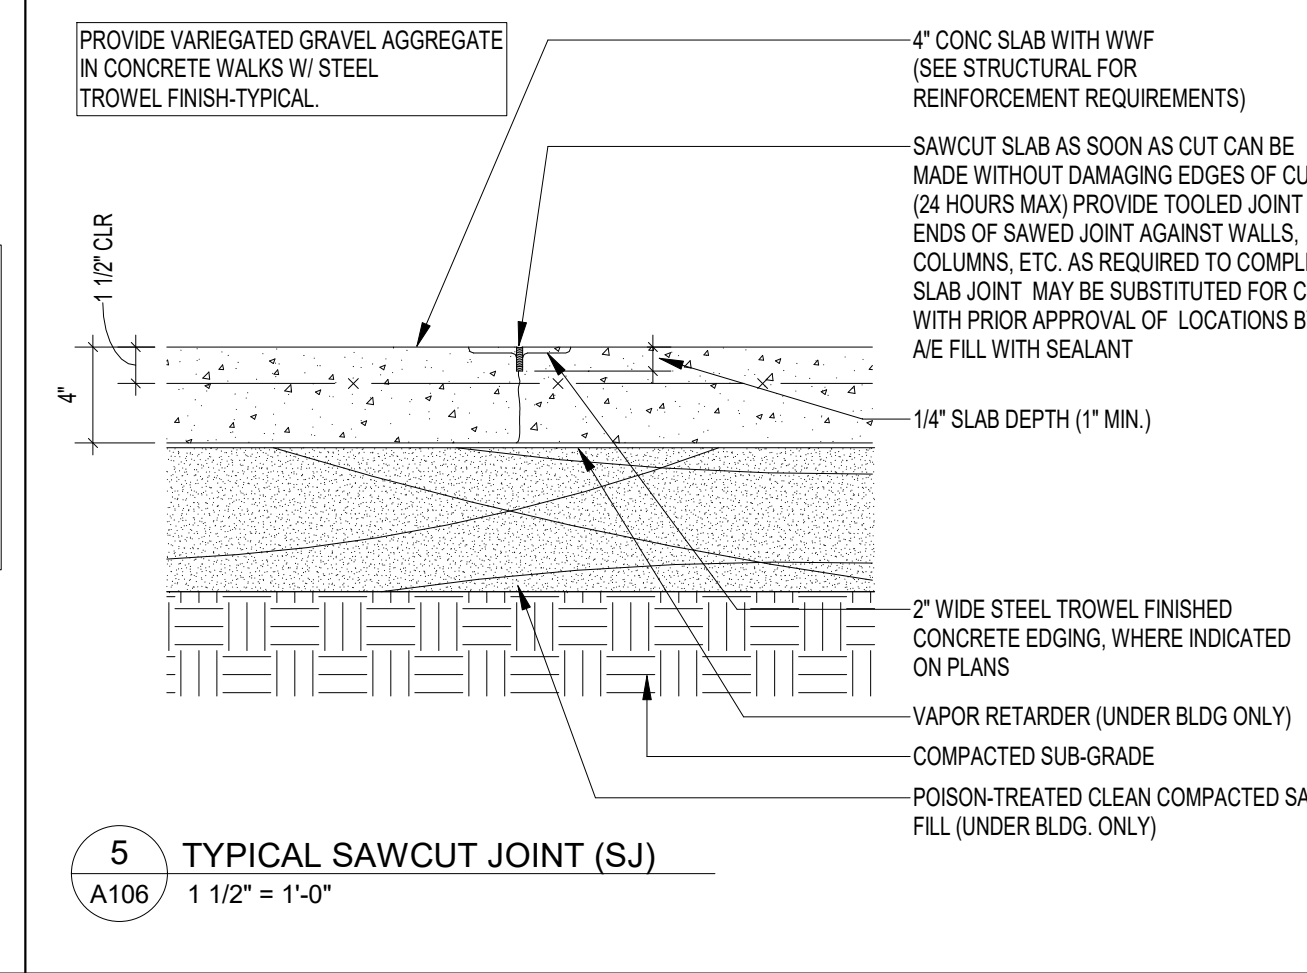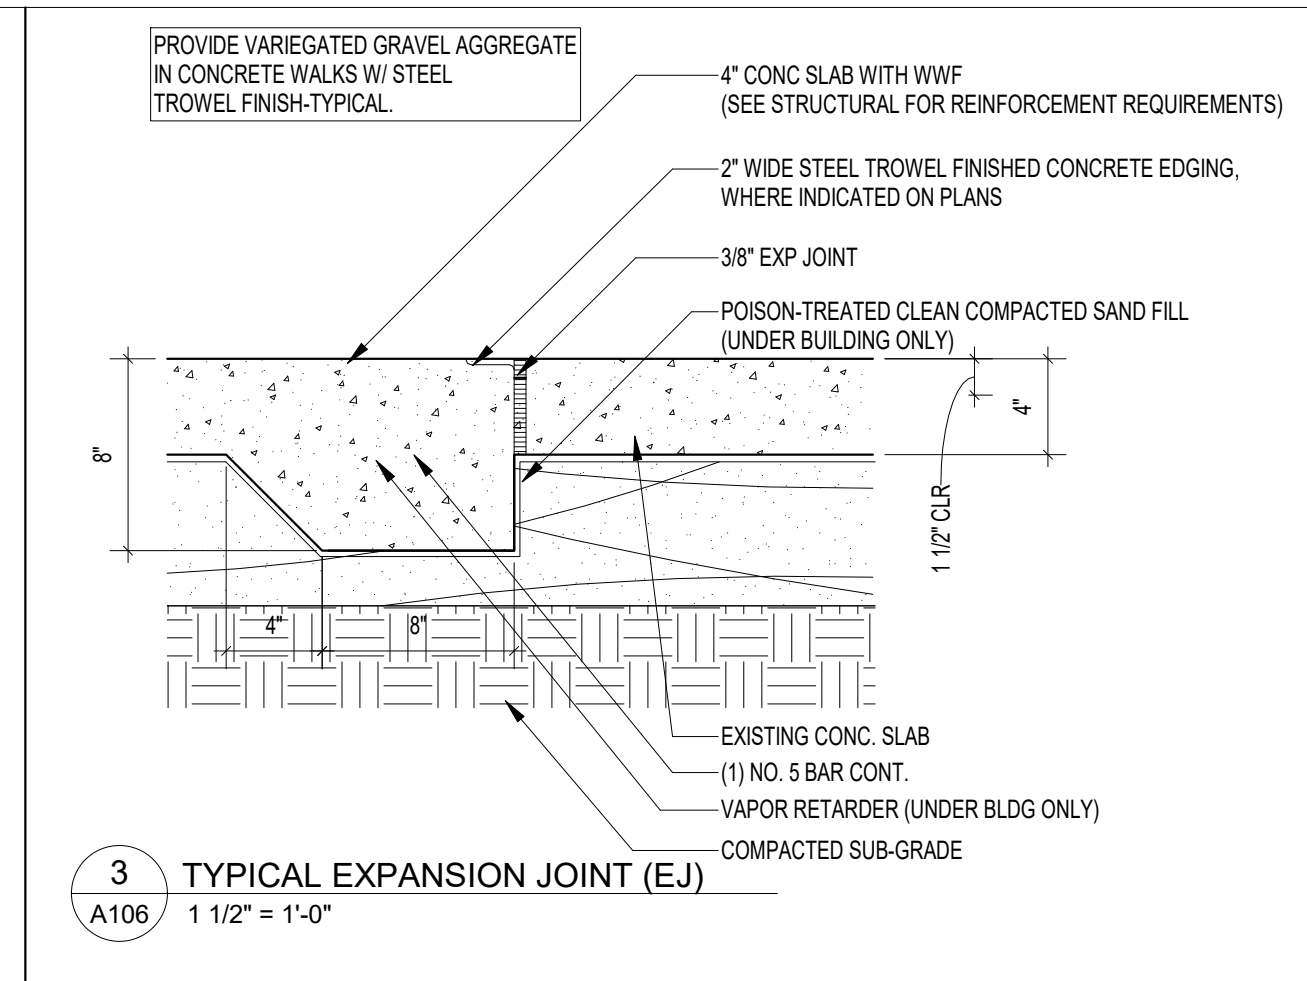**FSU TURNBULL
CONFERENCE CENTER
RENOVATIONS**

REV	DATE	DESCRIPTION


PROJECT PHASE
CONSTRUCTION DOCUMENTS

DATE 18 OCTOBER 2023	DRAWN BY Checker
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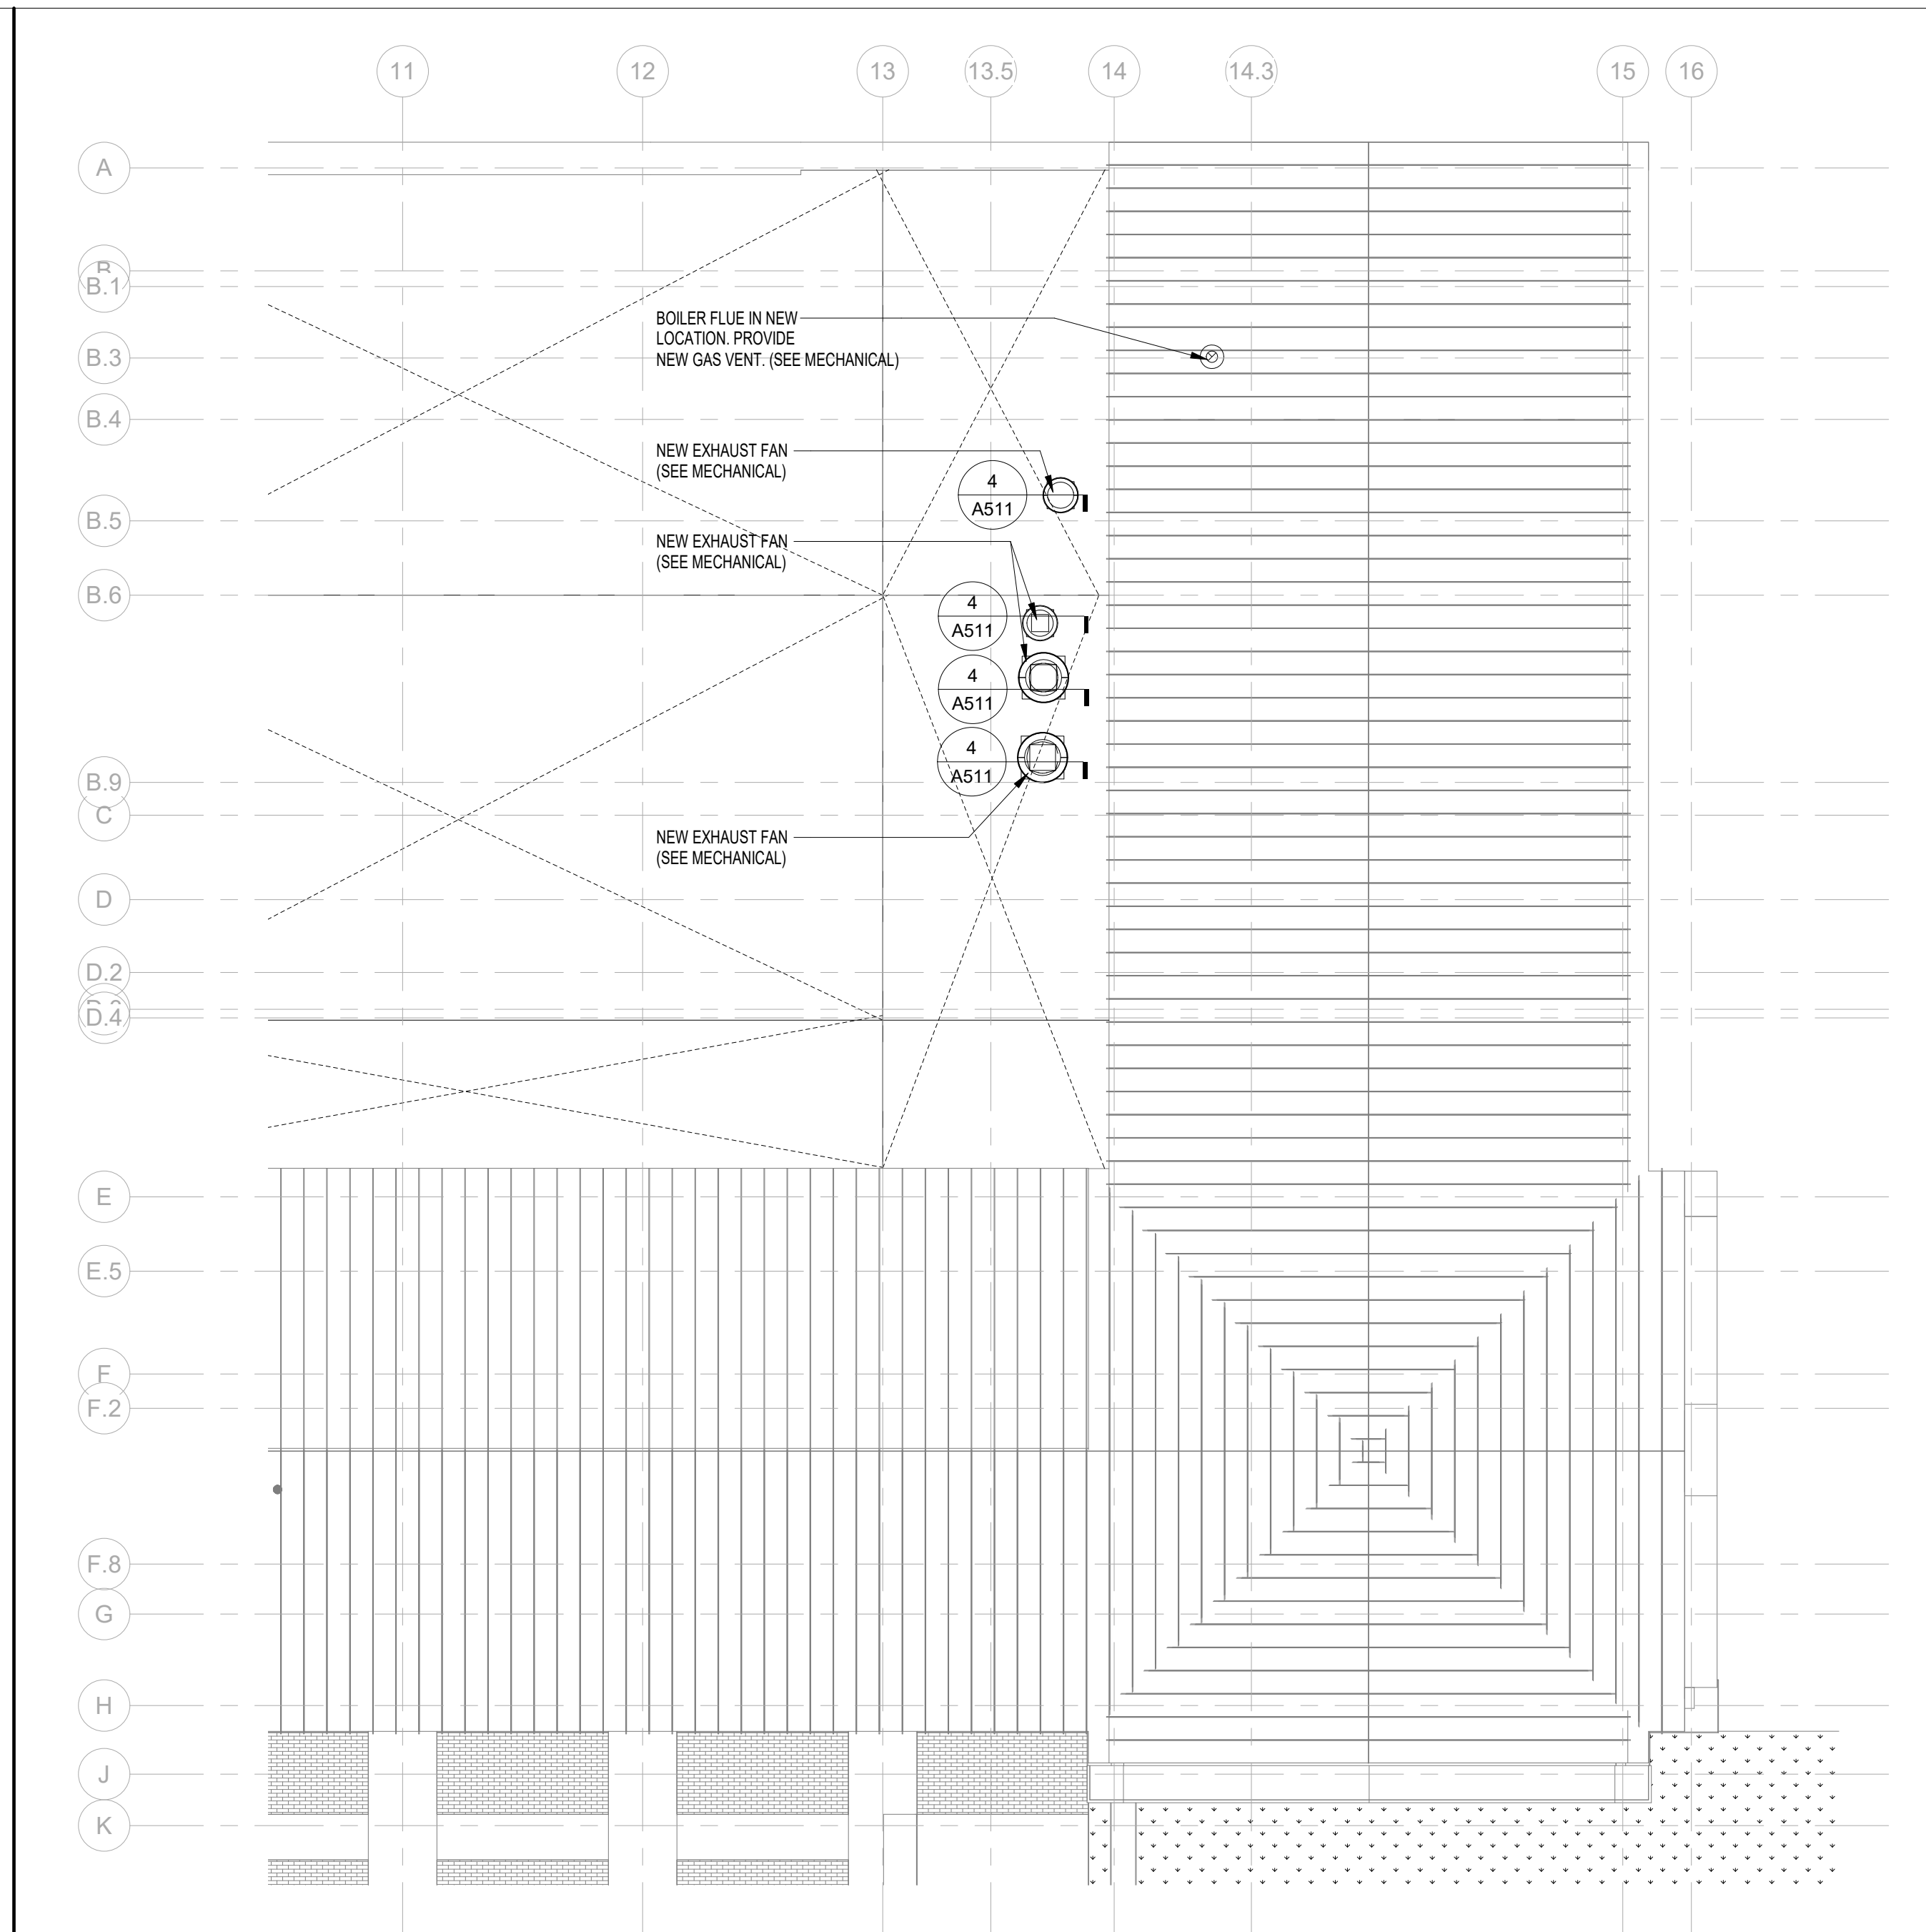
PROJECT NO 74000	CHECKED BY RMP/BI
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SHEET TITLE
**ROOF PLAN - NEW
WORK**

SHEET NO A115	REV NO
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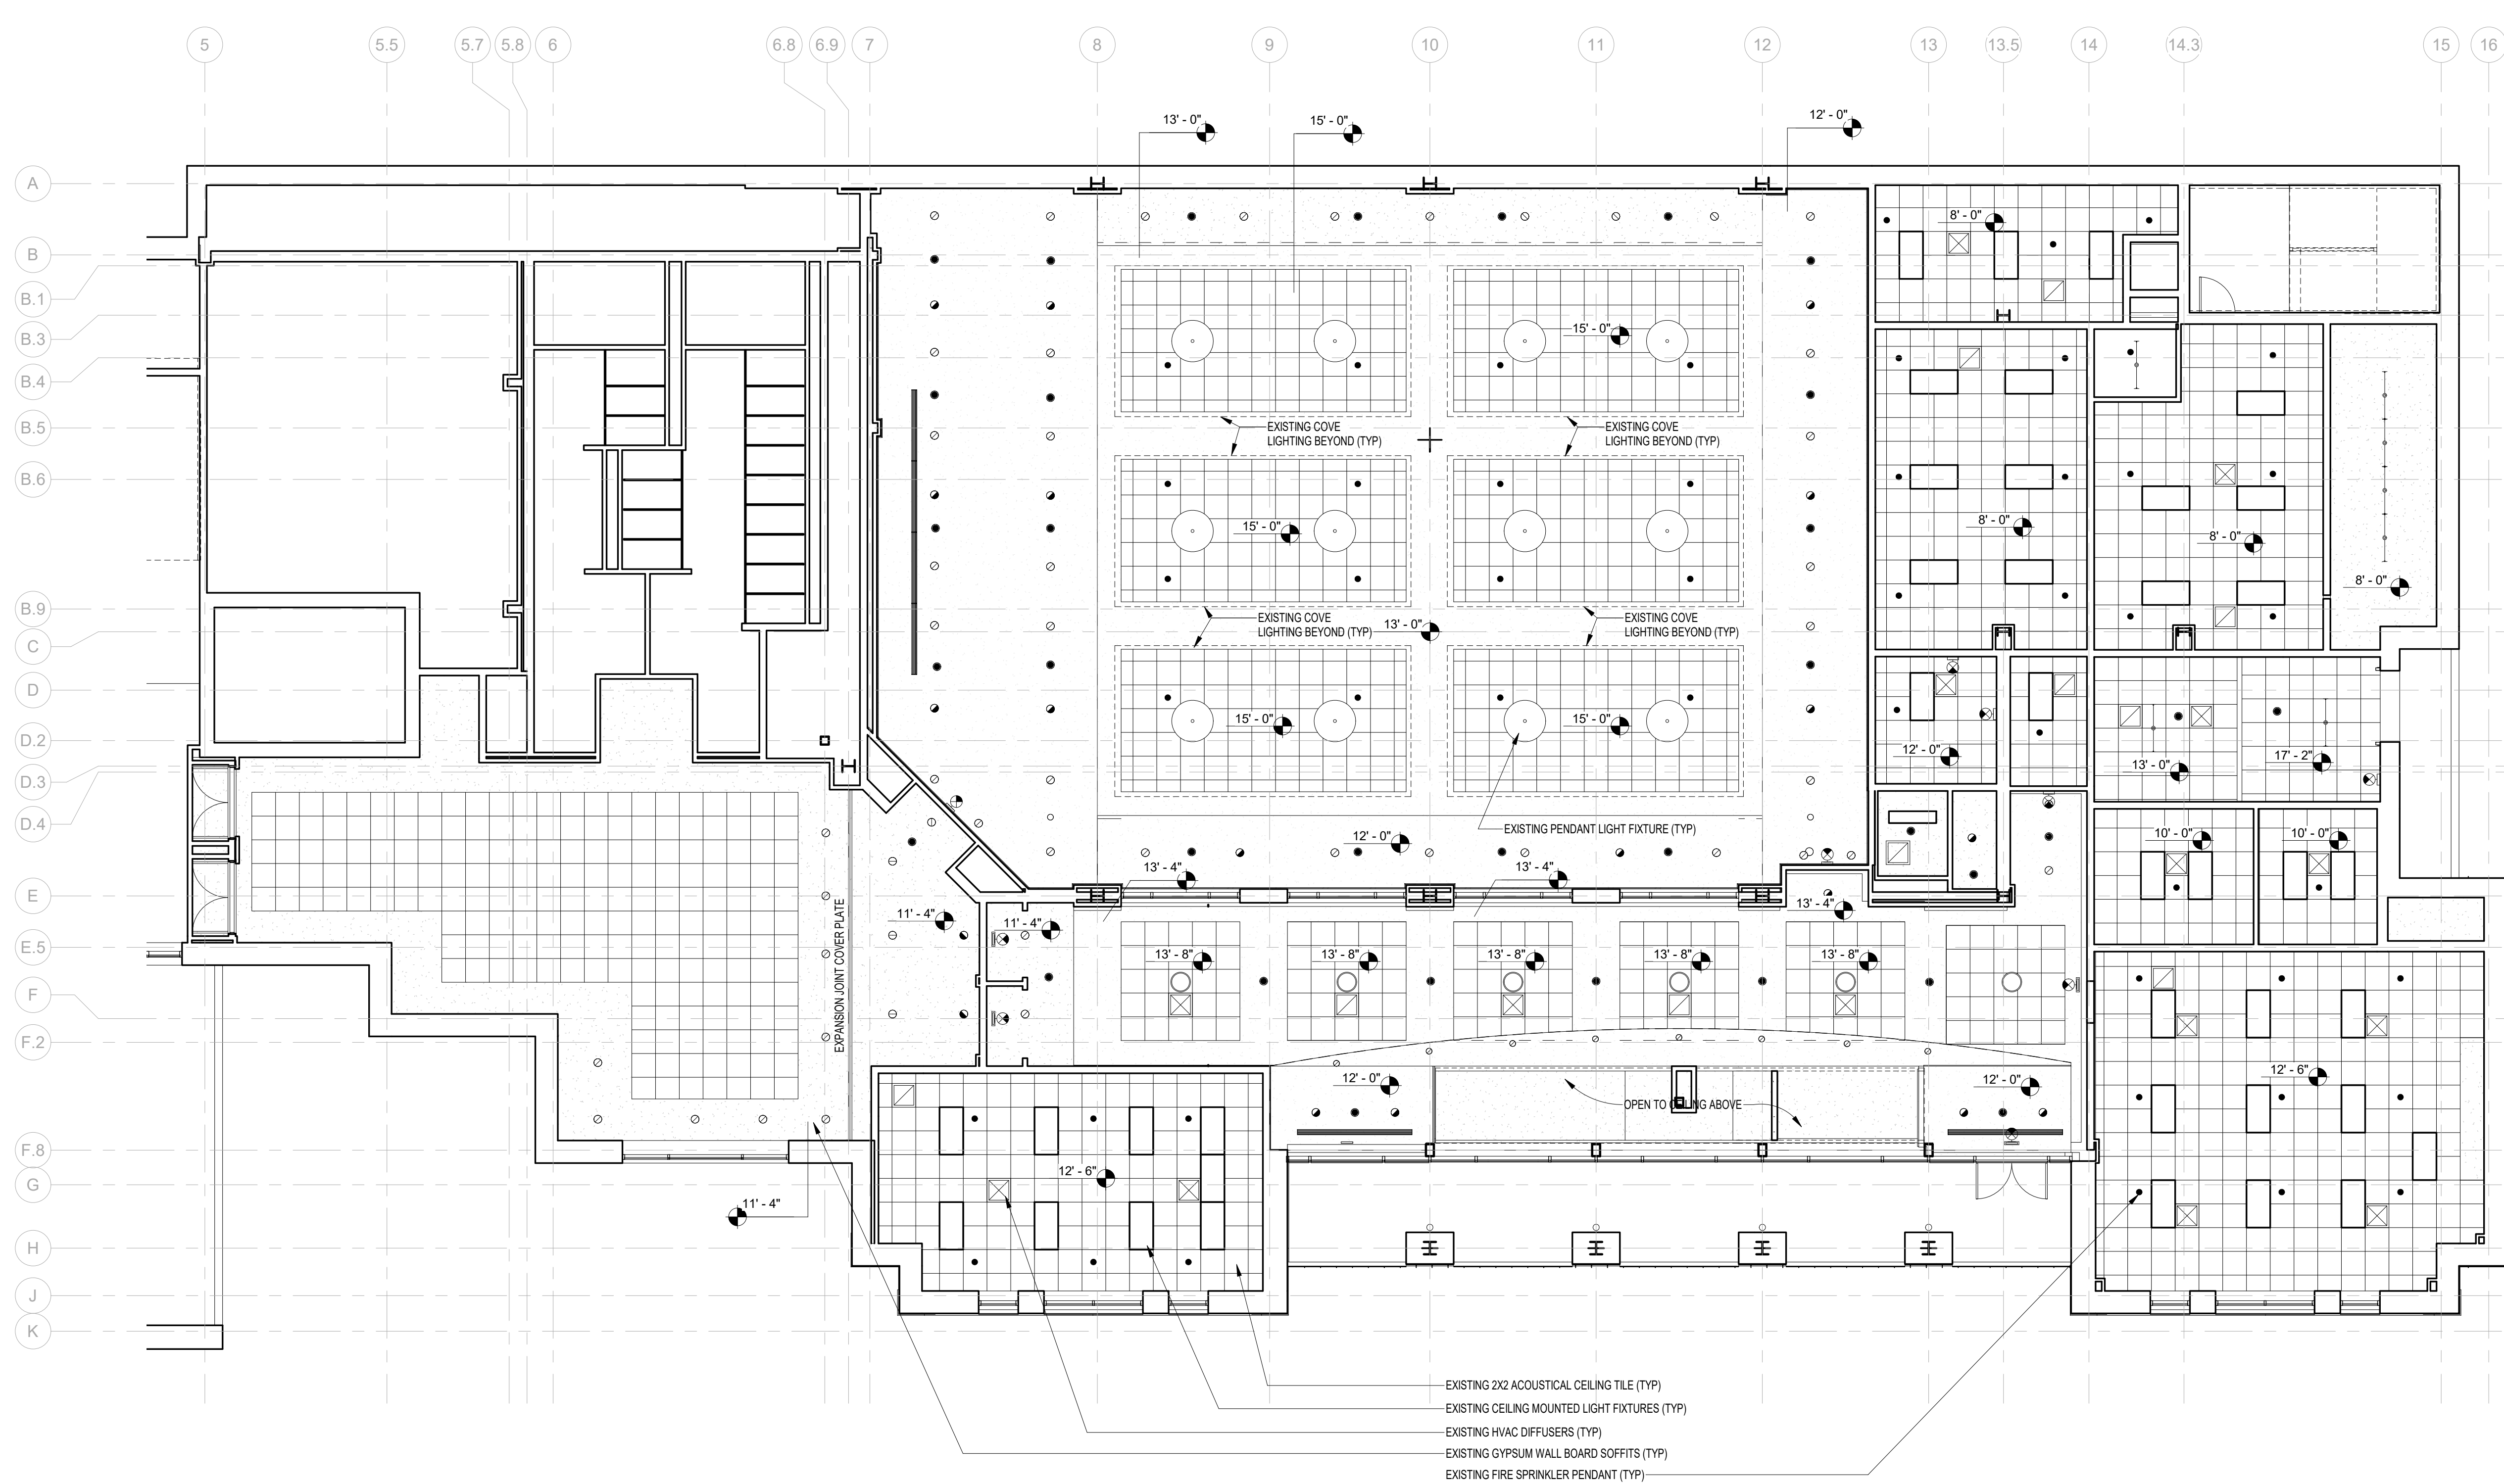
ROOF PLAN - DEMOLITION
1/8" = 1'-0"
NORTH



ROOF PLAN - NEW WORK
1/8" = 1'-0"
NORTH

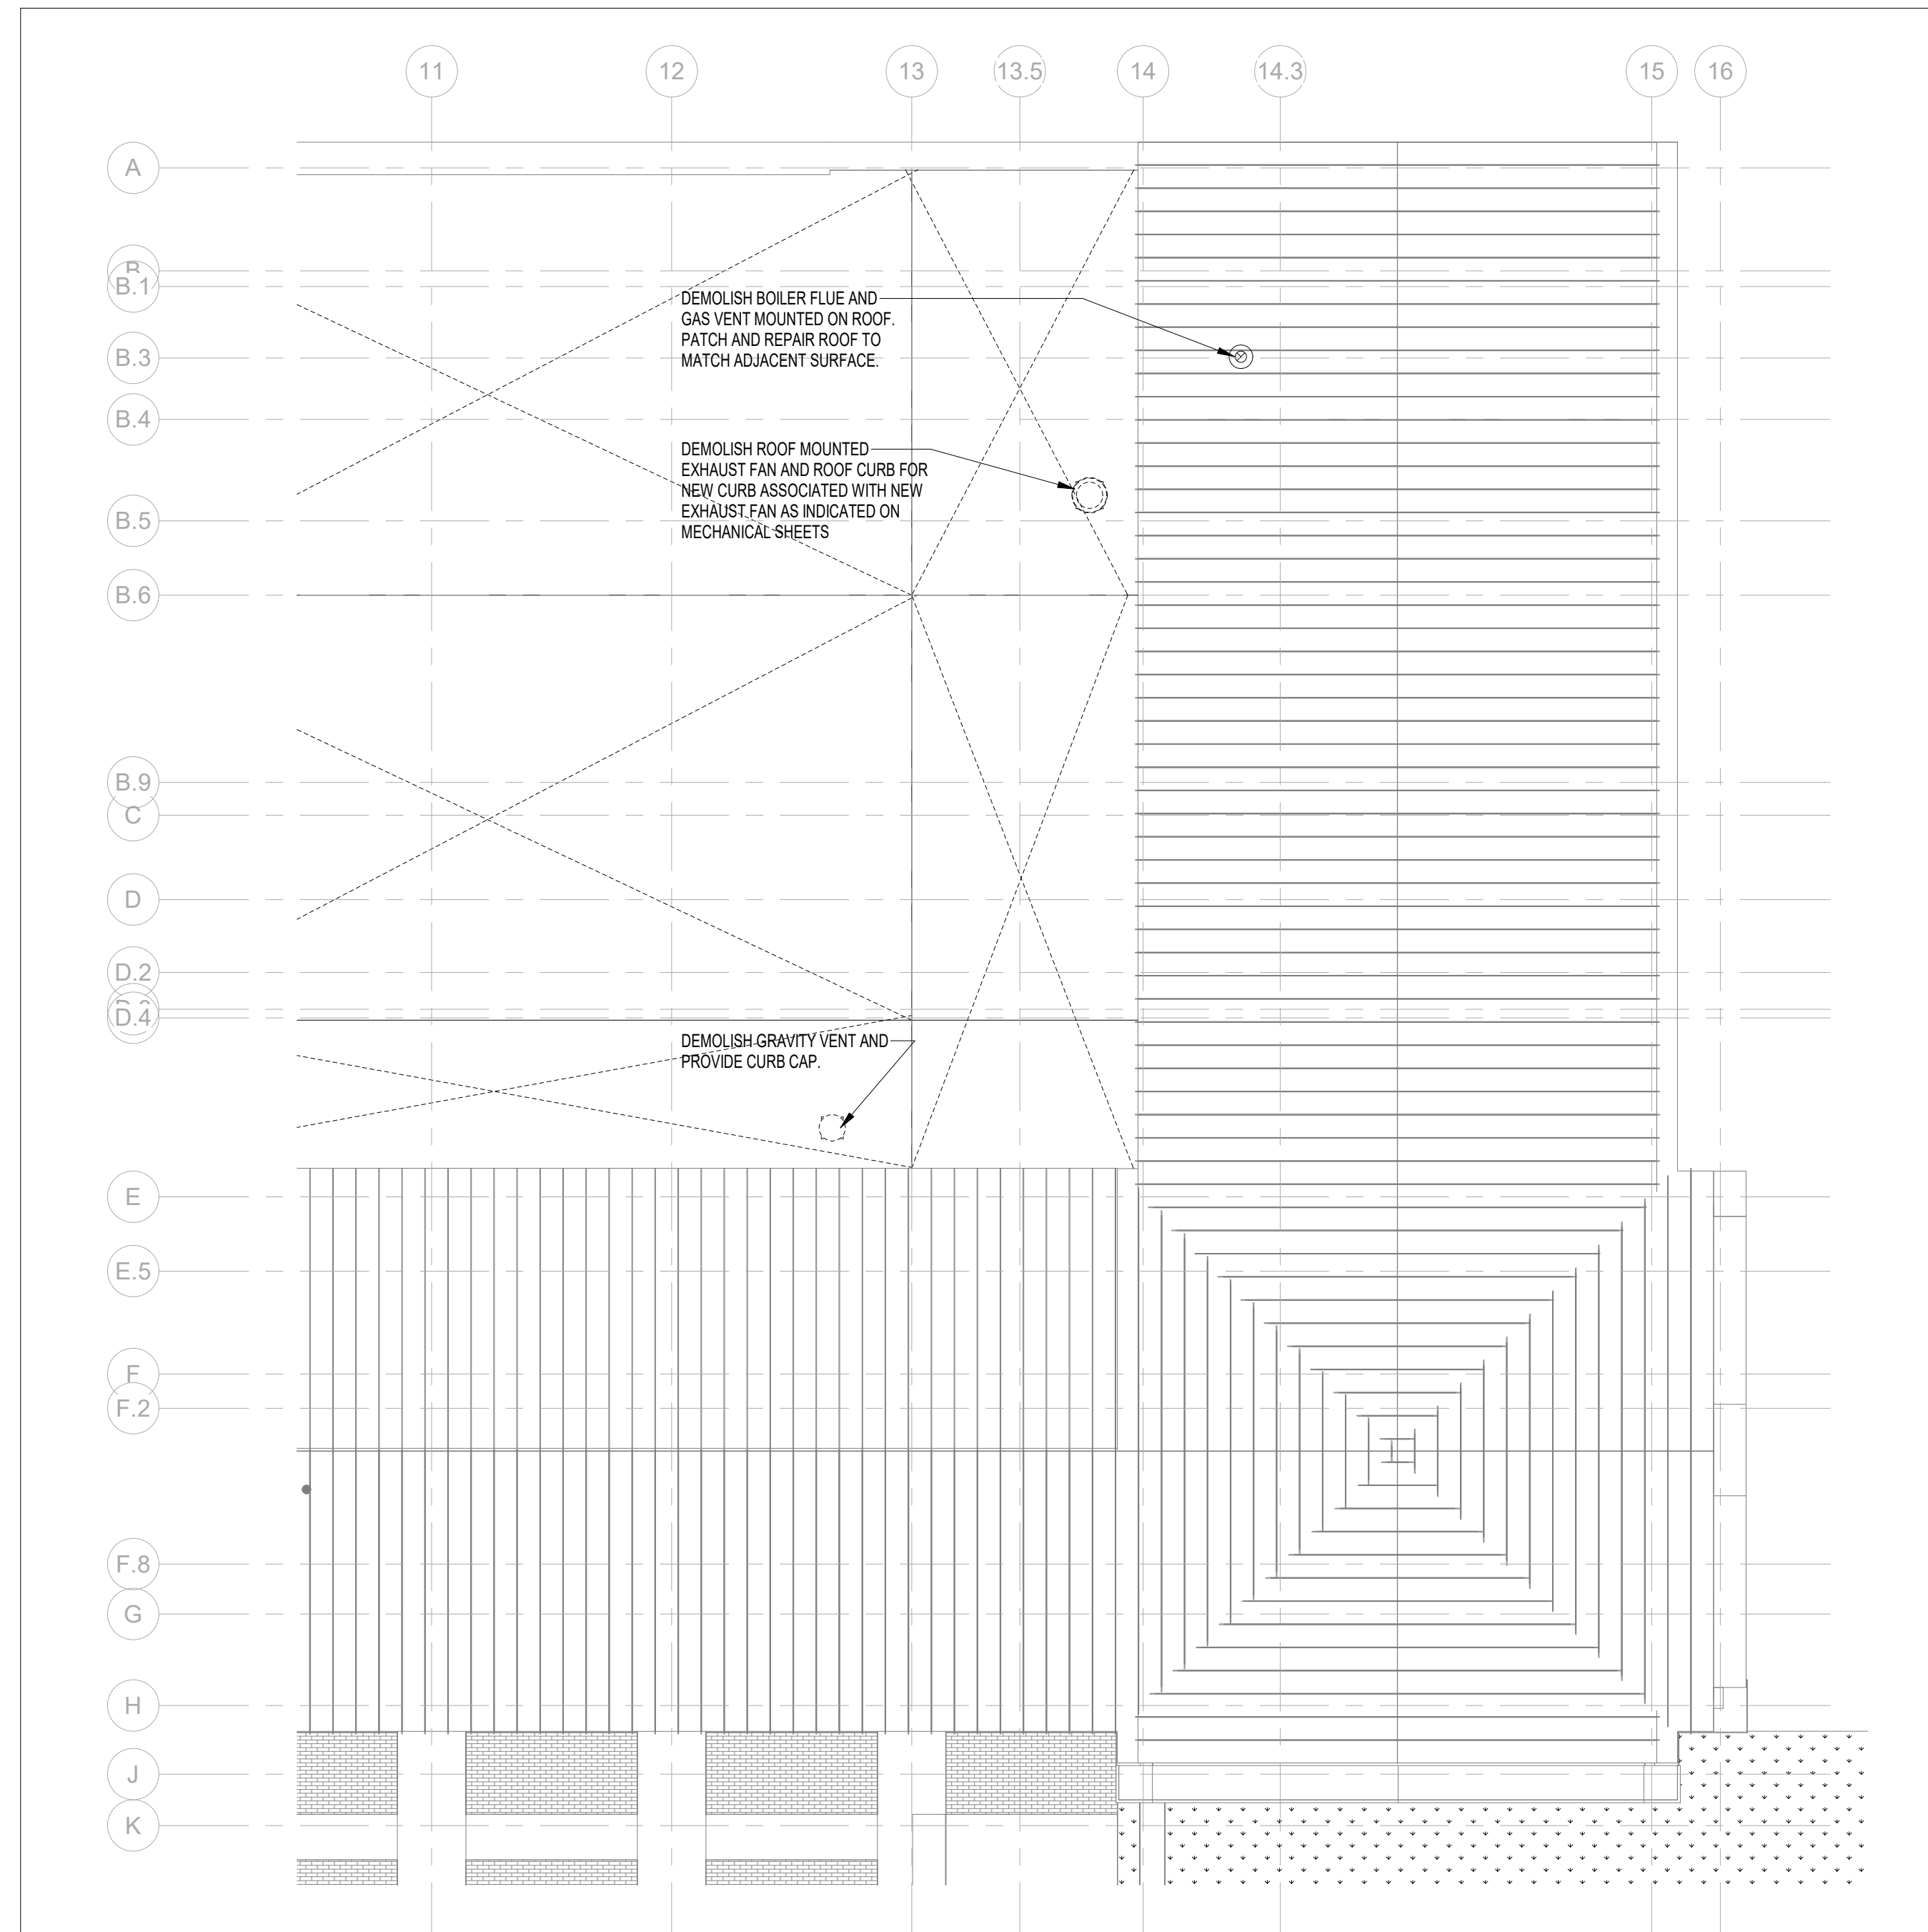NOTE:
11' x 17' SHEETS ARE PLOTTED AT 1/2
THE SCALE NOTED ON THESE DRAWINGS

FSU TURNBULL
CONFERENCE CENTER
RENOVATIONS




EXISTING 2X2 ACOUSTICAL CEILING TILE (TYP)
EXISTING CEILING MOUNTED LIGHT FIXTURES (TYP)
EXISTING HVAC DIFFUSERS (TYP)
EXISTING GYPSUM WALL BOARD SOFFITS (TYP)
EXISTING FIRE SPRINKLER PENDANT (TYP)

FIRST FLOOR REFLECTED CEILING PLAN- EXISTING
1/8" = 1'-0"
NORTH

REFLECTED CEILING LEGEND:

GWB CEILING	CONTINUOUS LIGHT SLOT	WALL MOUNTED INCANDESCENT, FLUORESCENT, OR HID LIGHT FIXTURE (LED FOR NEW FIXTURES)
LAY-IN ACOUSTICAL CLG	LINEAR PENDANT FIXTURE	WALL MOUNTED EMERGENCY INCANDESCENT, FLUORESCENT, OR HID LIGHT FIXTURE (LED FOR NEW FIXTURES)
LINEAR DIFFUSER	PENDANT FIXTURE	INCANDESCENT, FLUORESCENT, OR HID LIGHT FIXTURE (LED FOR NEW FIXTURES)
LINEAR SIDEWALL DIFFUSER	FEATURE PENDANT FIXTURE	EMERGENCY INCANDESCENT, FLUORESCENT, OR HID LIGHT FIXTURE (LED FOR NEW FIXTURES)
CEILING DIFFUSER	LED UPLIGHT COVE FIXTURE	EMERGENCY EXIT LIGHT FIXTURE (PROVIDE ARROWS WHERE SHOWN)
CEILING RETURN	STAGE TRACK LIGHTING	PENDANT SPRINKLER HEAD
CEILING EXHAUST	EXISTING CEILING MOUNT PROJECTOR	RECESSED SPRINKLER HEAD
		NO CEILING - EXPOSED UNDERSIDE OF STRUCTURE


NOTE:
REFER TO MECHANICAL, ELECTRICAL, PLUMBING, AND FIRE PROTECTION PLANS FOR SPECIFIC NOTES REGARDING ALL DEVICES, FIXTURES, DIFFUSERS, GRILLES, ETC.

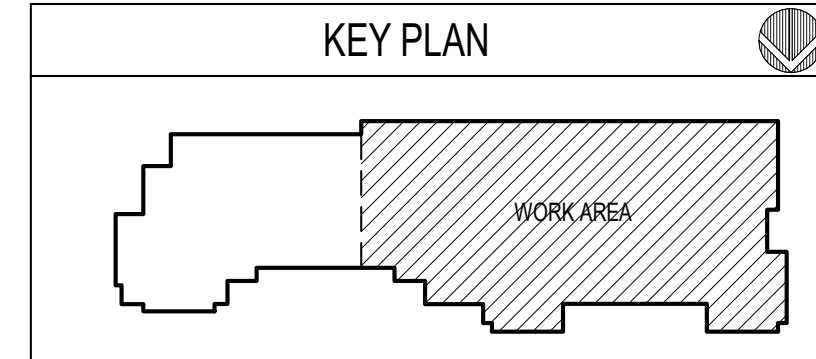

REV	DATE	DESCRIPTION

PROJECT PHASE CONSTRUCTION DOCUMENTS	
DATE 18 OCTOBER 2023	DRAWN BY RMP
PROJECT NO 74000	CHECKED BY RMP/BI
SHEET TITLE FIRST FLOOR REFLECTED CEILING - EXISTING	
SHEET NO A130.1	REV NO

NOTE:
11' x 17" SHEETS ARE PLOTTED AT 1/2
THE SCALE NOTED ON THESE DRAWINGS

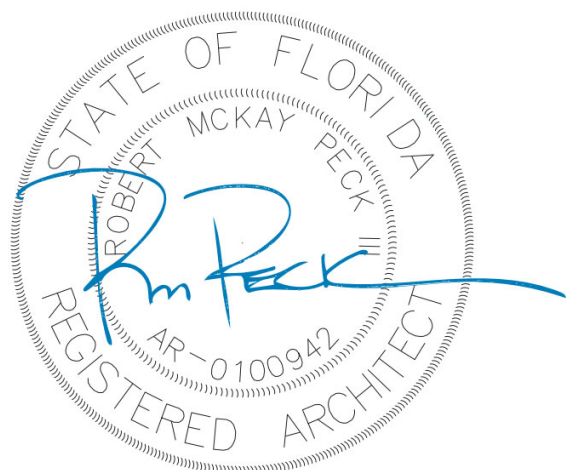

**FSU TURNBULL
CONFERENCE CENTER
RENOVATIONS**


REV	DATE	DESCRIPTION
1	04.17.24	FSU PERMIT

NOTE:
REFER TO MECHANICAL, ELECTRICAL, PLUMBING AND FIRE PROTECTION PLANS FOR SPECIFIC NOTES REGARDING ALL DEVICES, FIXTURES, DIFFUSERS, GRILLES, ETC.

PROJECT PHASE
CONSTRUCTION DOCUMENTS

DATE	DRAWN BY
18 OCTOBER 2023	Checker
PROJECT NO	CHECKED BY
74000	RMP/BI


SHEET TITLE	
FIRST FLOOR REFLECTED CEILING - DEMOLITION PLAN	
SHEET NO	REV NO
A131.1	1

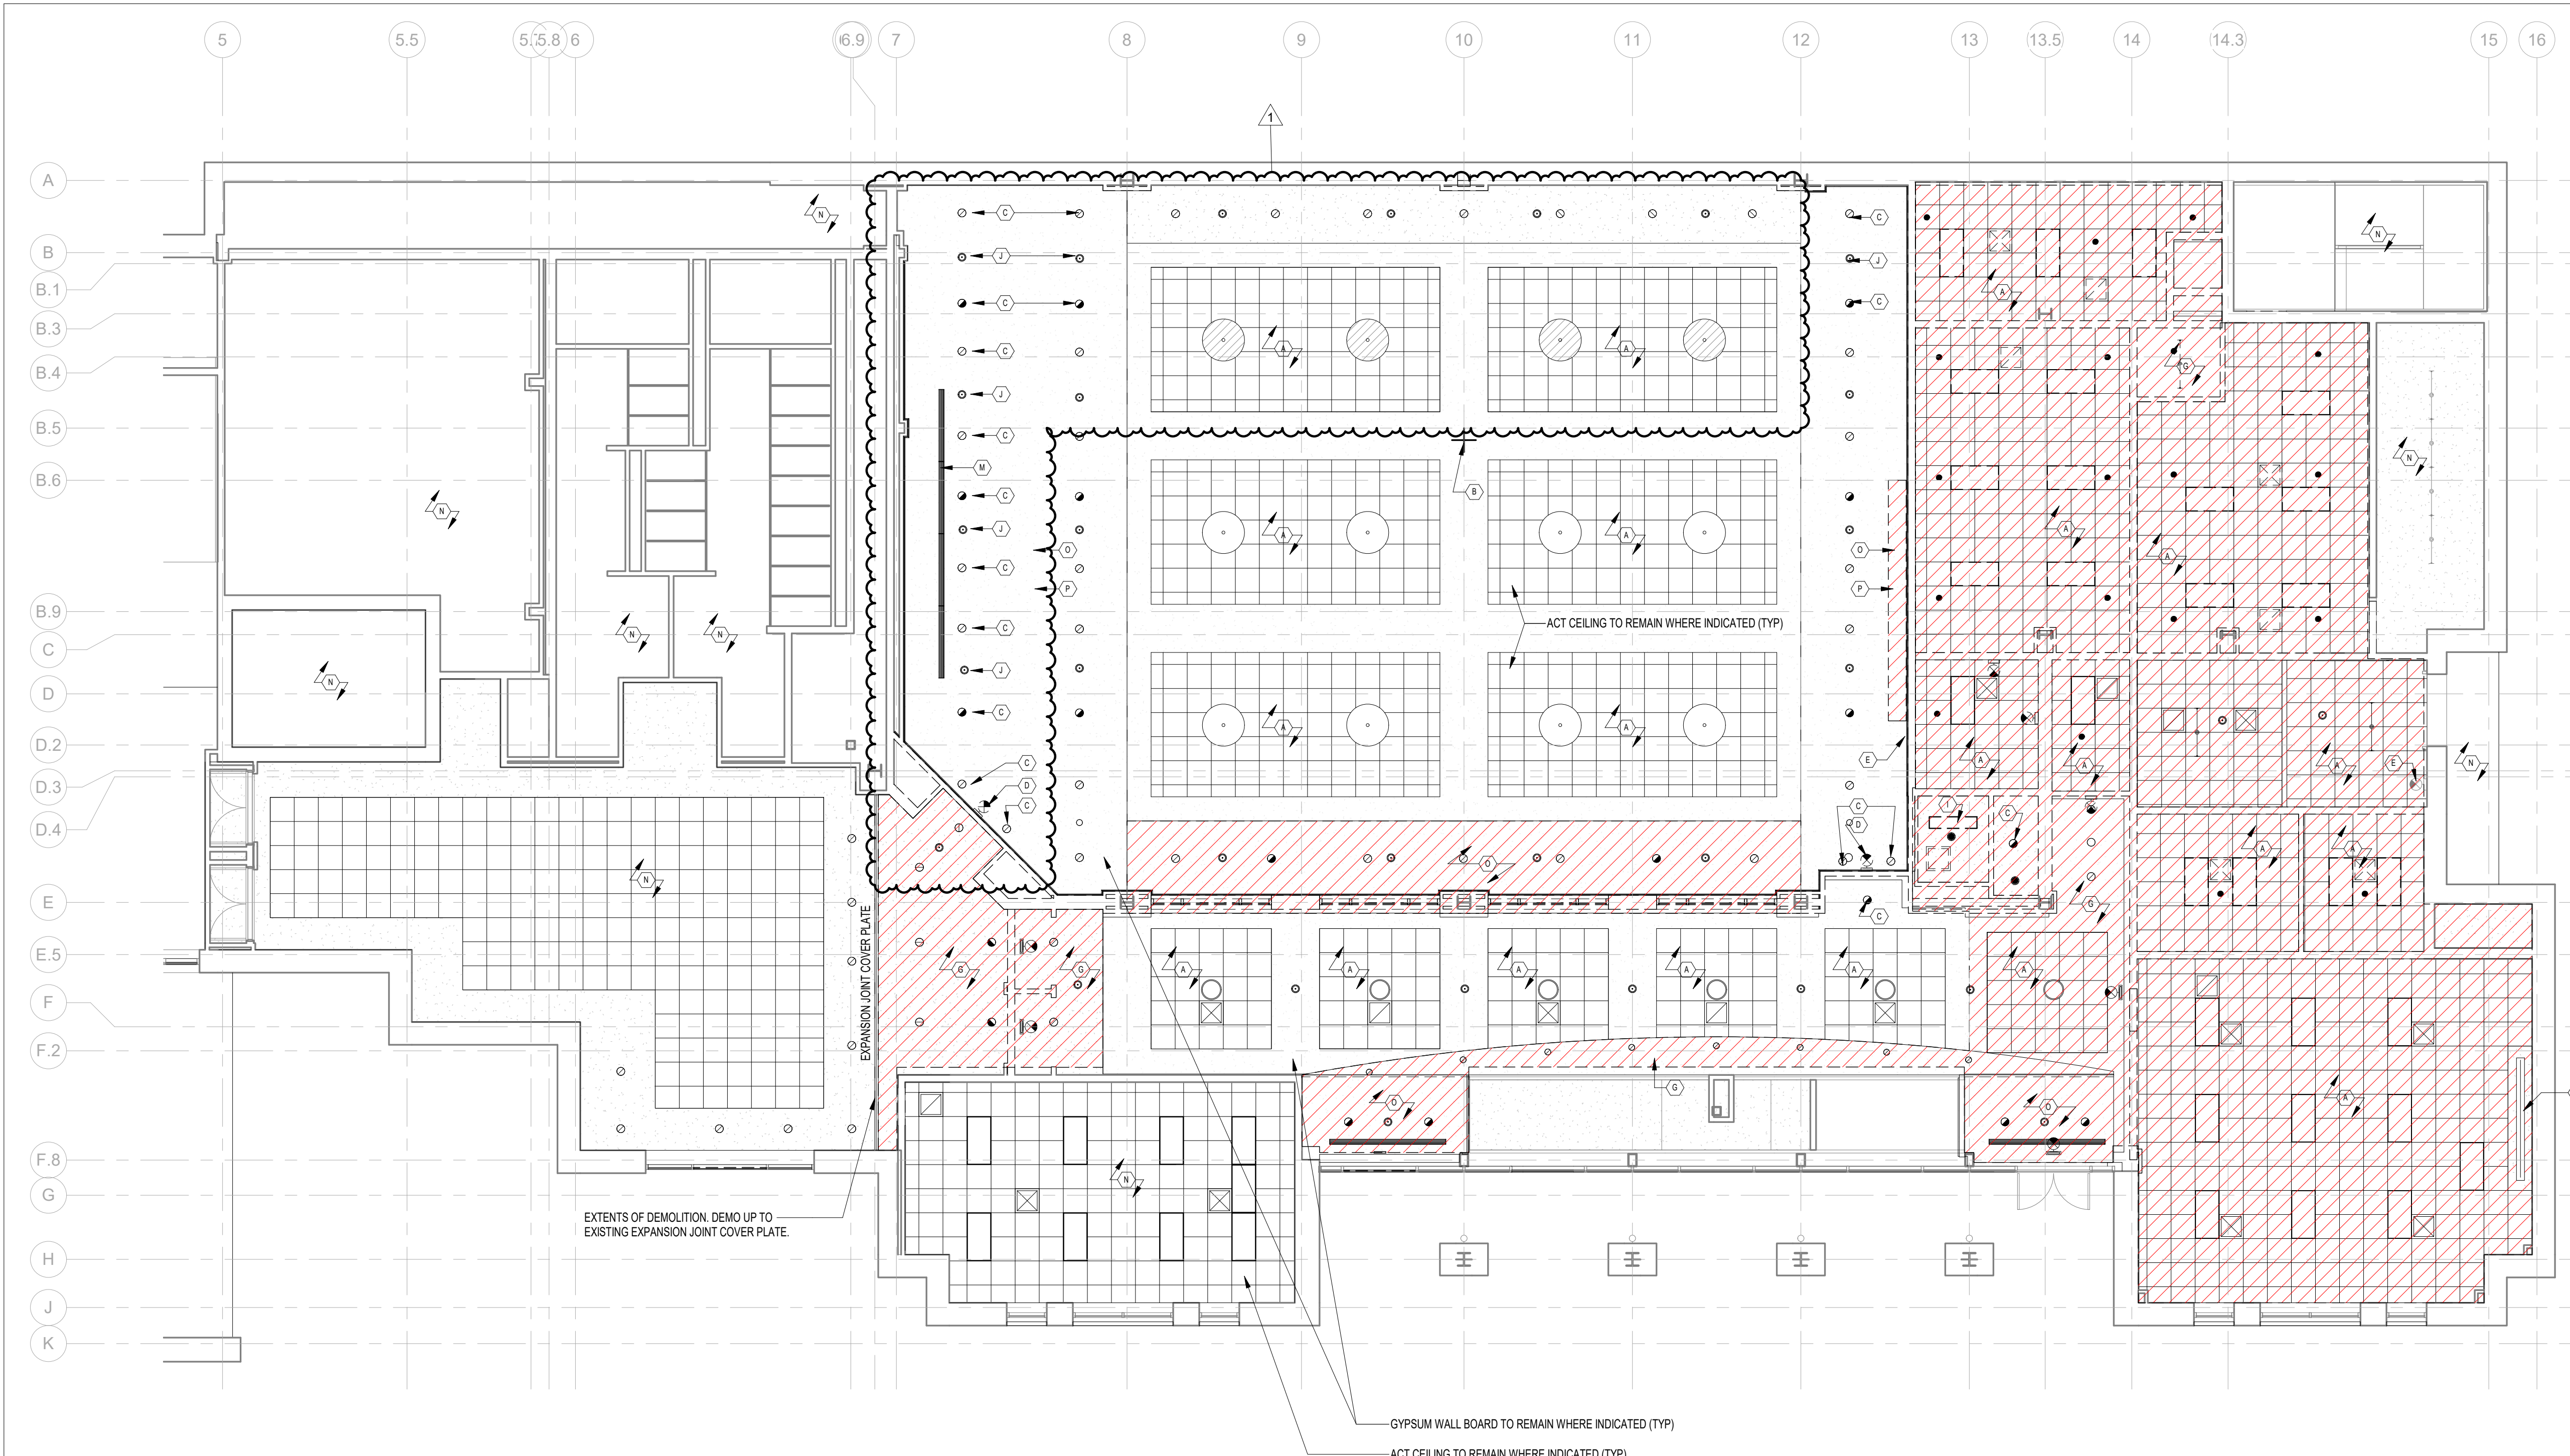

FIRST FLOOR REFLECTED CEILING PLAN- DEMOLITION
1/8" = 1'-0"
NORTH

- GENERAL DEMOLITION NOTES**
- DEMOLITION NECESSARY AS A RESULT OF MPE WORK IS GENERALLY NOT INDICATED ON THE ARCHITECTURAL DRAWINGS. CONTRACTOR SHALL COORDINATE AND INCLUDE DEMOLITION WORK ASSOCIATED WITH MECHANICAL, PLUMBING AND ELECTRICAL DRAWINGS AND SPECIFICATIONS. COORDINATE DISCONNECTION AND ABANDONMENT OF ELECTRICAL, PLUMBING WASTE AND SUPPLY GAS AND OTHER UTILITIES WITH MECHANICAL, ELECTRICAL, AND PLUMBING DEMOLITION PLANS. COMPLY WITH APPLICABLE CODES FOR TERMINATION OF ALL UTILITIES.
 - COORDINATE DEMOLITION OF EXISTING FIRE ALARM DEVICES WITH FIRE ALARM CONTRACTOR.
 - REMOVE LOOSE AND FLAKING PAINT FROM EXISTING WALL AND HOLLOW METAL FRAME SURFACES SCHEDULED TO REMAIN AND PREP FOR NEW FINISH.
 - ABANDONED FLOOR PENETRATIONS OF ELECTRICAL, PLUMBING EQUIPMENT, ANCHORS AND SIMILAR ITEMS SHALL BE REMOVED, CAPPED OR CUT OFF BELOW THE LEVEL OF NEW FINISHED FLOOR. FLOOR SHALL BE PATCHED TO RECEIVE NEW FLOOR FINISHES.
 - EXISTING FIRE EXTINGUISHERS AND FIRE EXTINGUISHER CABINETS TO REMAIN.
 - REMOVE DEMOLITION DEBRIS FROM SITE. DISPOSE IN ACCORDANCE WITH APPLICABLE LAWS AND REGULATIONS.
 - COORDINATE PATCHING, INFILL, NEW CONSTRUCTION W/DEMOLITION NOTES AND NEW WORK NOTES ON OTHER ARCHITECTURAL DRAWINGS.
 - PATCH ABANDONED ROOF AND WALL PENETRATIONS IMMEDIATELY UPON REMOVAL OF EQUIPMENT TO WEATHERPROOF BUILDINGS.
 - WHEN REMOVING ITEMS ATTACHED TO FINISH SURFACES TO REMAIN AND BE EXPOSED TO VIEW, REMOVE ALL EVIDENCE OF FASTENERS.
 - WHERE REMOVAL OF EXISTING THRU WALL EQUIPMENT, LOUVERS, PIPING AND SIMILAR ITEMS IS NECESSARY, THE CONTRACTOR SHALL INFILL, PATCH AND MAKE WEATHERTIGHT ABANDONED WALL OPENINGS. FINISH BOTH INTERIOR AND EXTERIOR FINISH SURFACES TO MATCH EXISTING CONDITIONS. WEATHERPROOF THE OPENING IMMEDIATELY UPON REMOVAL OF THE DEMOLISHED ITEM.
 - WHERE MISCELLANEOUS EXTERIOR MECHANICAL EQUIPMENT IS REMOVED, BUT NOT REPLACED, REMOVE ABANDONED CONCRETE EQUIPMENT PADS. RESTORE DISTURBED AREAS TO MATCH ADJACENT SURFACES.
 - CONTRACTOR SHALL PROTECT ITEMS SCHEDULED TO REMAIN.
 - OWNER WILL REMOVE AND RELOCATE MOVEABLE ITEMS OF VALUE, SUCH AS CHAIRS, DESKS, COMPUTERS, CLOCKS, MIRRORS, POSTERS, PICTURES, FLAGS, PROJECTION SCREENS, SUPPLIES, TABLES, CURTAINS, CURTAIN RODS, MICROWAVES, CUBBIES, SHELVES AND ACTIVE BOARDS, ETC., EXCEPT AS SPECIFICALLY NOTED OTHERWISE. OWNER WILL PROVIDE STORAGE AS NECESSARY TO ACCOMMODATE OWNERS FURNISHINGS FOR DURATION OF PROJECT.

- DEMOLITION NOTES: REFLECTED CEILING PLAN**
- (A) REMOVE AND DISPOSE OF ACT CEILING AND CEILING SUSPENSION/SUPPORT SYSTEM.
 - (B) REMOVE AND STORE EXISTING PROJECTOR AND SOUND EQUIPMENT (REMOVAL BY CAPD STAFF)
 - (C) REMOVE AND DISPOSE OF EXISTING CAN LIGHTS
 - (D) REMOVE AND DISPOSE OF EXISTING FIRE SAFETY EQUIPMENT (EXIT SIGNS, STROBES, ETC.)
 - (E) NOT USED
 - (F) REMOVE AND DISPOSE OF WOOD CROWN MOLDING.
 - (G) REMOVE AND DISPOSE OF EXISTING GYPSUM CEILING AND CEILING SUSPENSION/SUPPORT SYSTEM
 - (H) REMOVE AND STORE ROLL UP PROJECTOR SCREEN AND ANY ADDITIONAL AV ACCESSORIES (REMOVAL BY CAPD STAFF)
 - (I) REMOVE AND DISPOSE OF EXISTING LINEAR LIGHT. PATCH AND PAINT CEILING AS NECESSARY TO MATCH ADJACENT CEILING
 - (J) REMOVE AND DISPOSE OF SPRINKLER HEAD. PATCH AND PAINT CEILING AS NECESSARY TO MATCH ADJACENT CEILING
 - (K) REMOVE AND DISPOSE OF STAIR GYPSUM SOFFIT AND SPRINKLER HEADS.
 - (L) UNINSTALL SPRINKLER HEAD AND COORDINATE WITH THE MPE SHEETS TO DETERMINE WHETHER THE COMPONENT CAN BE REPURPOSED. ASSESS WHETHER THE SPRINKLER HEAD SHOULD BE DISPOSED OF OR IF IT CAN BE EFFECTIVELY REUSED.
 - (M) REMOVE AND DISPOSE OF LINEAR DIFFUSER
 - (N) NO WORK IN THIS ROOM.
 - (O) REMOVE AND DISPOSE OF EXISTING GYPSUM CEILING BOARD. LEAVE CEILING SUSPENSION SYSTEM IN PLACE. PREPARE EXISTING SUPPORT SYSTEM FOR INSTALLATION OR NEW 5/8" GWB CEILING (SEE REFLECTED CEILING PLAN - NEW WORK) EXISTING CEILING MOUNTED MPE DEVICES TO REMAIN FOR RE-INSTALLATION IN NEW CEILING IN SAME LOCATIONS (TYP)
 - (P) REMOVE AND DISPOSE OF EXISTING GYPSUM WALL BOARD CEILING BOARD. LEAVE CEILING SUSPENSION SYSTEM IN PLACE. PREPARE EXISTING SUPPORT SYSTEM FOR INSTALLATION OF CURTAIN TRACK SYSTEM.

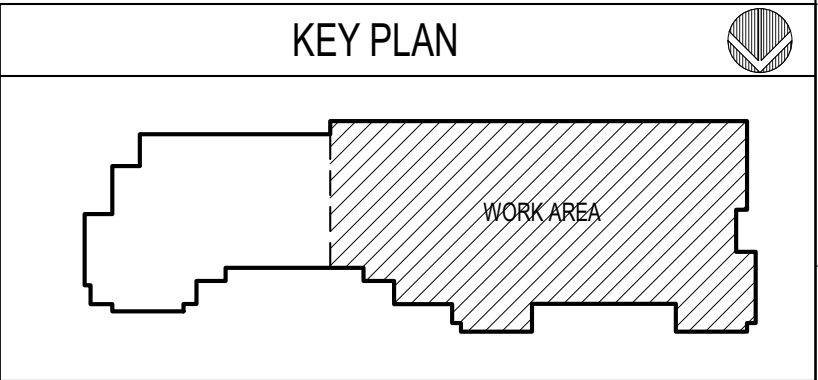

NOTE:
11' x 17" SHEETS ARE PLOTTED AT 1/2
THE SCALE NOTED ON THESE DRAWINGS

FSU TURNBULL
CONFERENCE CENTER
RENOVATIONS

REV	DATE	DESCRIPTION

PROJECT PHASE
CONSTRUCTION DOCUMENTS

DATE
18 OCTOBER 2023

DRAWN BY
RMP

PROJECT NO
74000


CHECKED BY
RMP/BI

SHEET TITLE

**SECOND FLOOR
REFLECTED CEILING -
EXISTING + DEMO**

SHEET NO
A131.2

REV NO

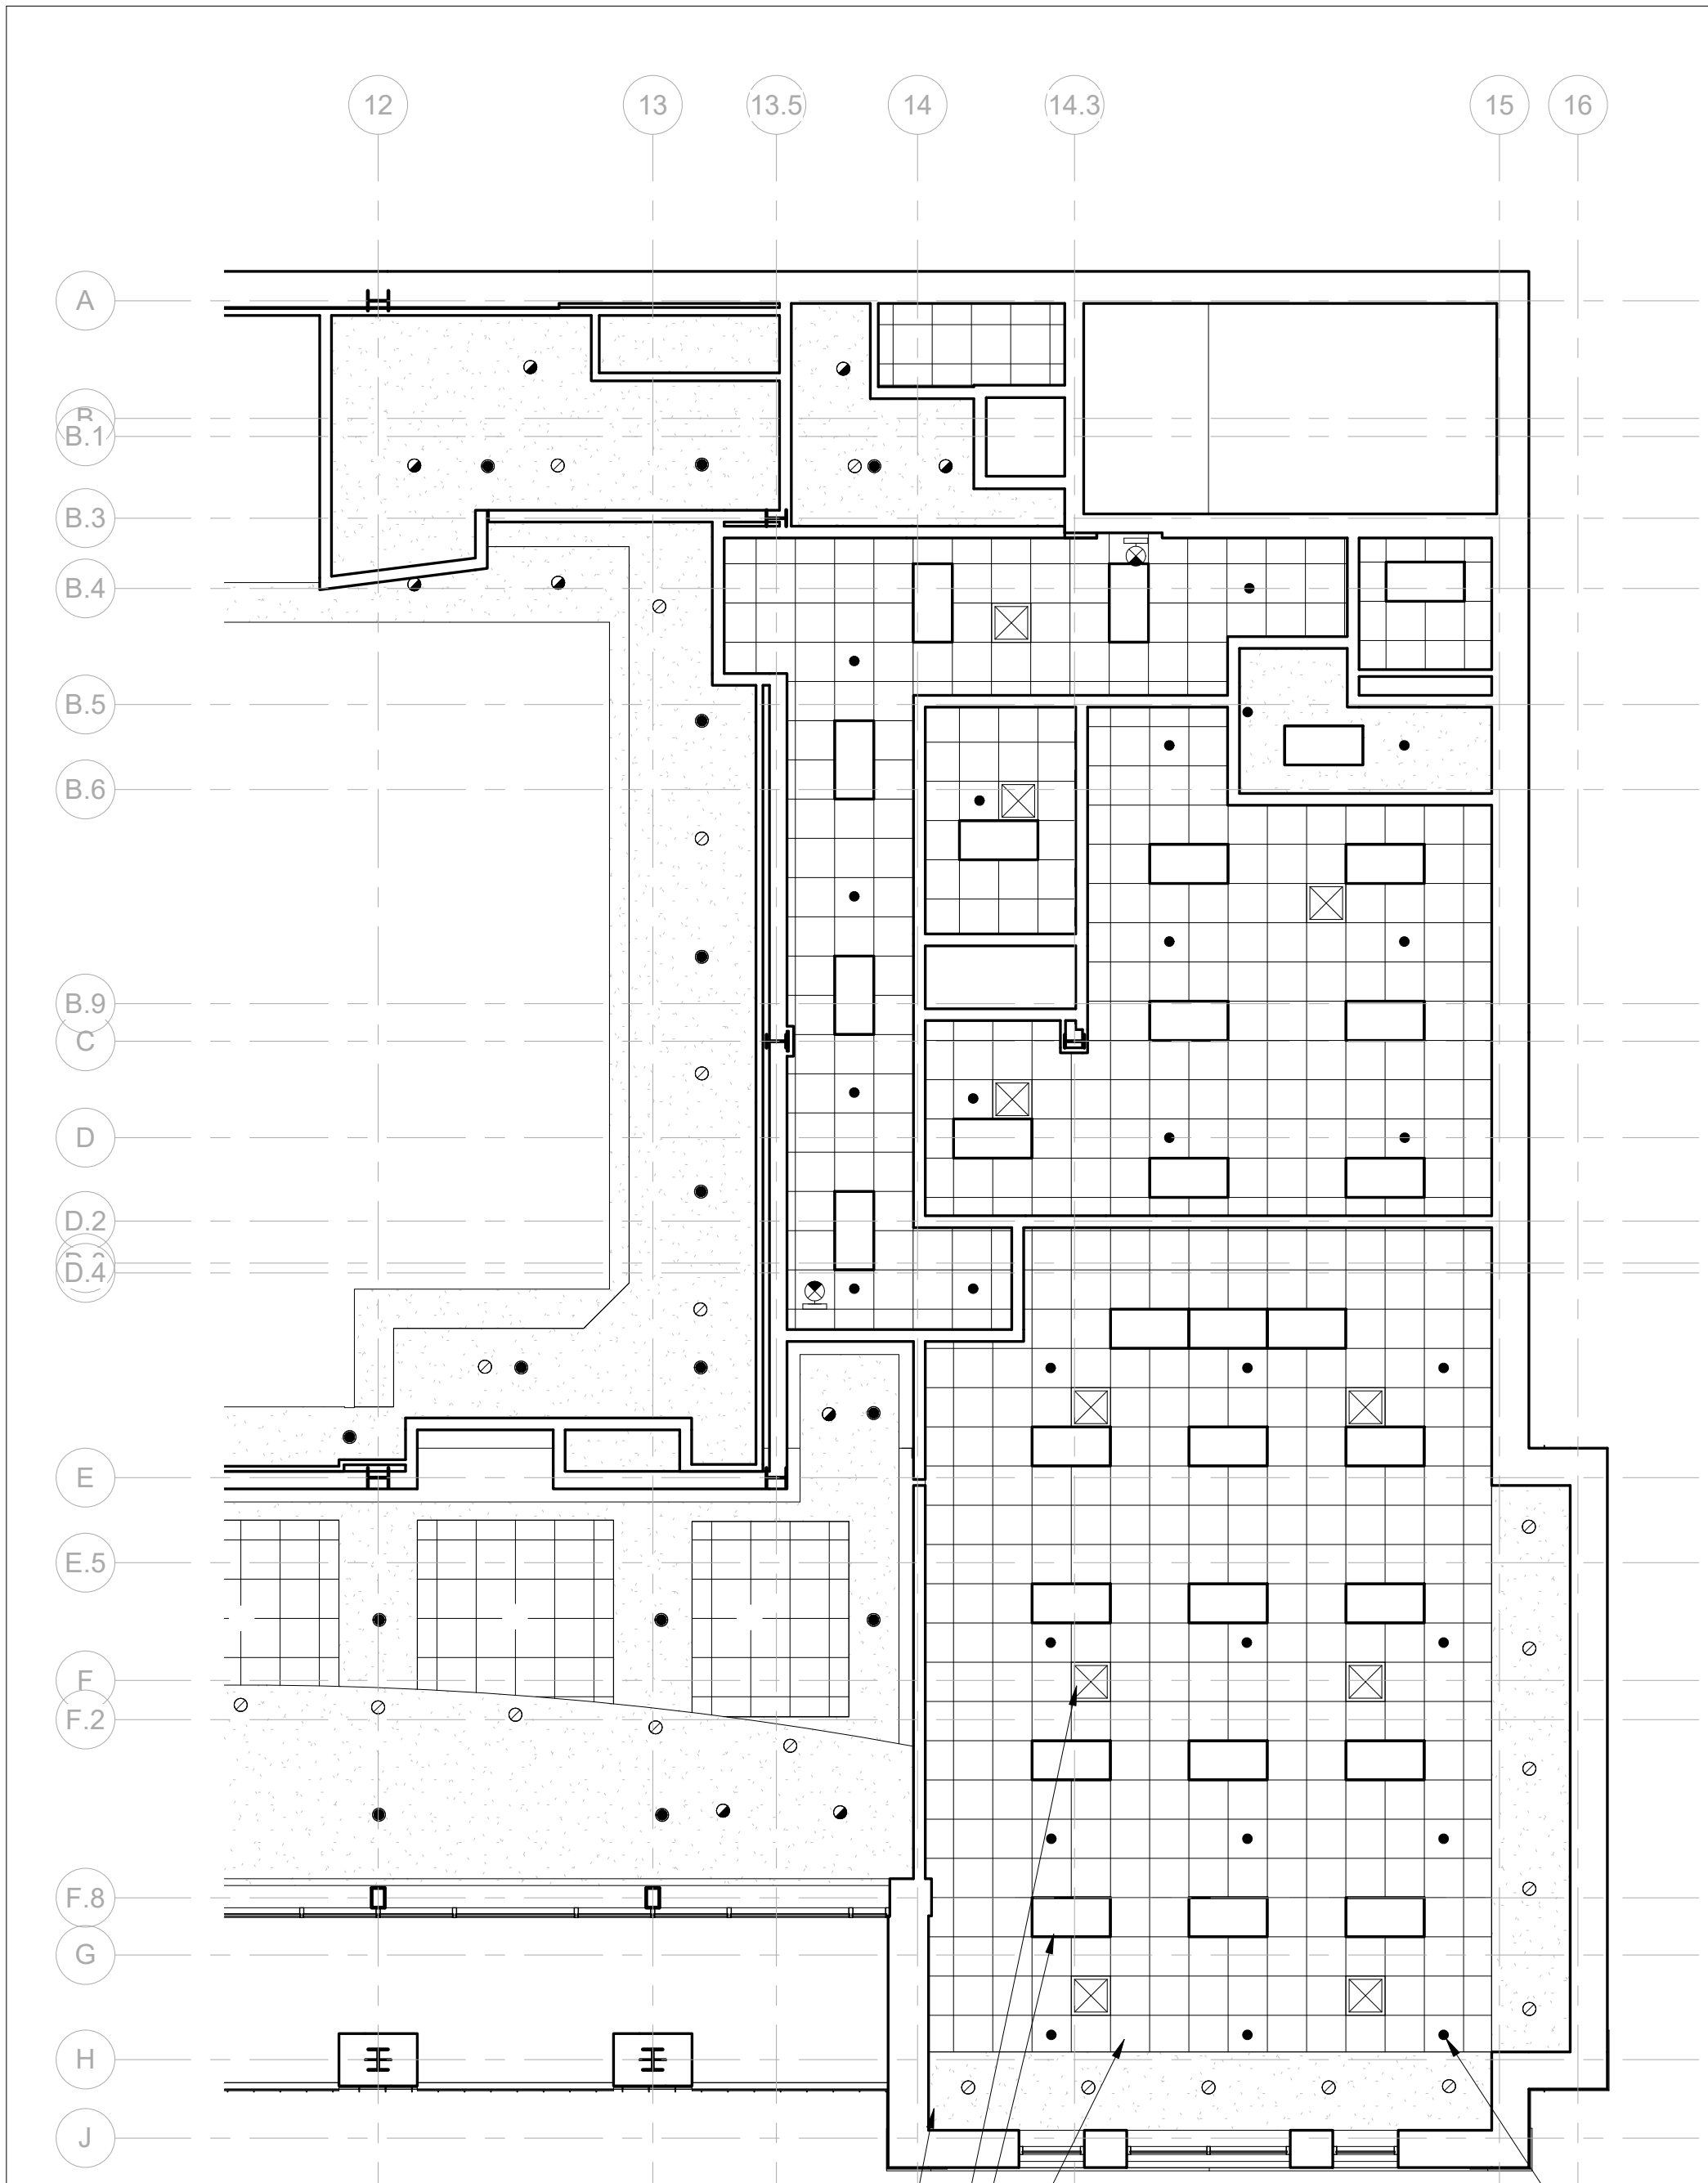


- EXISTING 2X2 ACOUSTICAL CEILING TILE (TYP)
- EXISTING CEILING MOUNTED LIGHT FIXTURES (TYP)
- EXISTING HVAC DIFFUSERS (TYP)
- EXISTING GYPSUM WALL BOARD SOFFITS (TYP)
- EXISTING FIRE SPRINKLER PENDANT (TYP)

SECOND FLOOR REFLECTED CEILING PLAN- EXISTING
1/8" = 1'-0"
NORTH

REFLECTED CEILING LEGEND:

	GWB CEILING		CONTINUOUS LIGHT SLOT		WALL MOUNTED INCANDESCENT, FLUORESCENT, OR HID LIGHT FIXTURE (LED FOR NEW FIXTURES)
	LAY-IN ACOUSTICAL CLG		LINEAR PENDANT FIXTURE		WALL MOUNTED EMERGENCY INCANDESCENT, FLUORESCENT, OR HID LIGHT FIXTURE (LED FOR NEW FIXTURES)
	LINEAR DIFFUSER		PENDANT FIXTURE		INCANDESCENT, FLUORESCENT, OR HID LIGHT FIXTURE (LED FOR NEW FIXTURES)
	LINEAR SIDEWALL DIFFUSER		FEATURE PENDANT FIXTURE		EMERGENCY INCANDESCENT, FLUORESCENT, OR HID LIGHT FIXTURE (LED FOR NEW FIXTURES)
	CEILING DIFFUSER		LED UPLIGHT COVE FIXTURE		EMERGENCY EXIT LIGHT FIXTURE (PROVIDE ARROWS WHERE SHOWN)
	CEILING RETURN		STAGE TRACK LIGHTING		PENDANT SPRINKLER HEAD
	CEILING EXHAUST		EXISTING CEILING MOUNT PROJECTOR		RECESSED SPRINKLER HEAD
			NO CEILING - EXPOSED UNDERSIDE OF STRUCTURE		

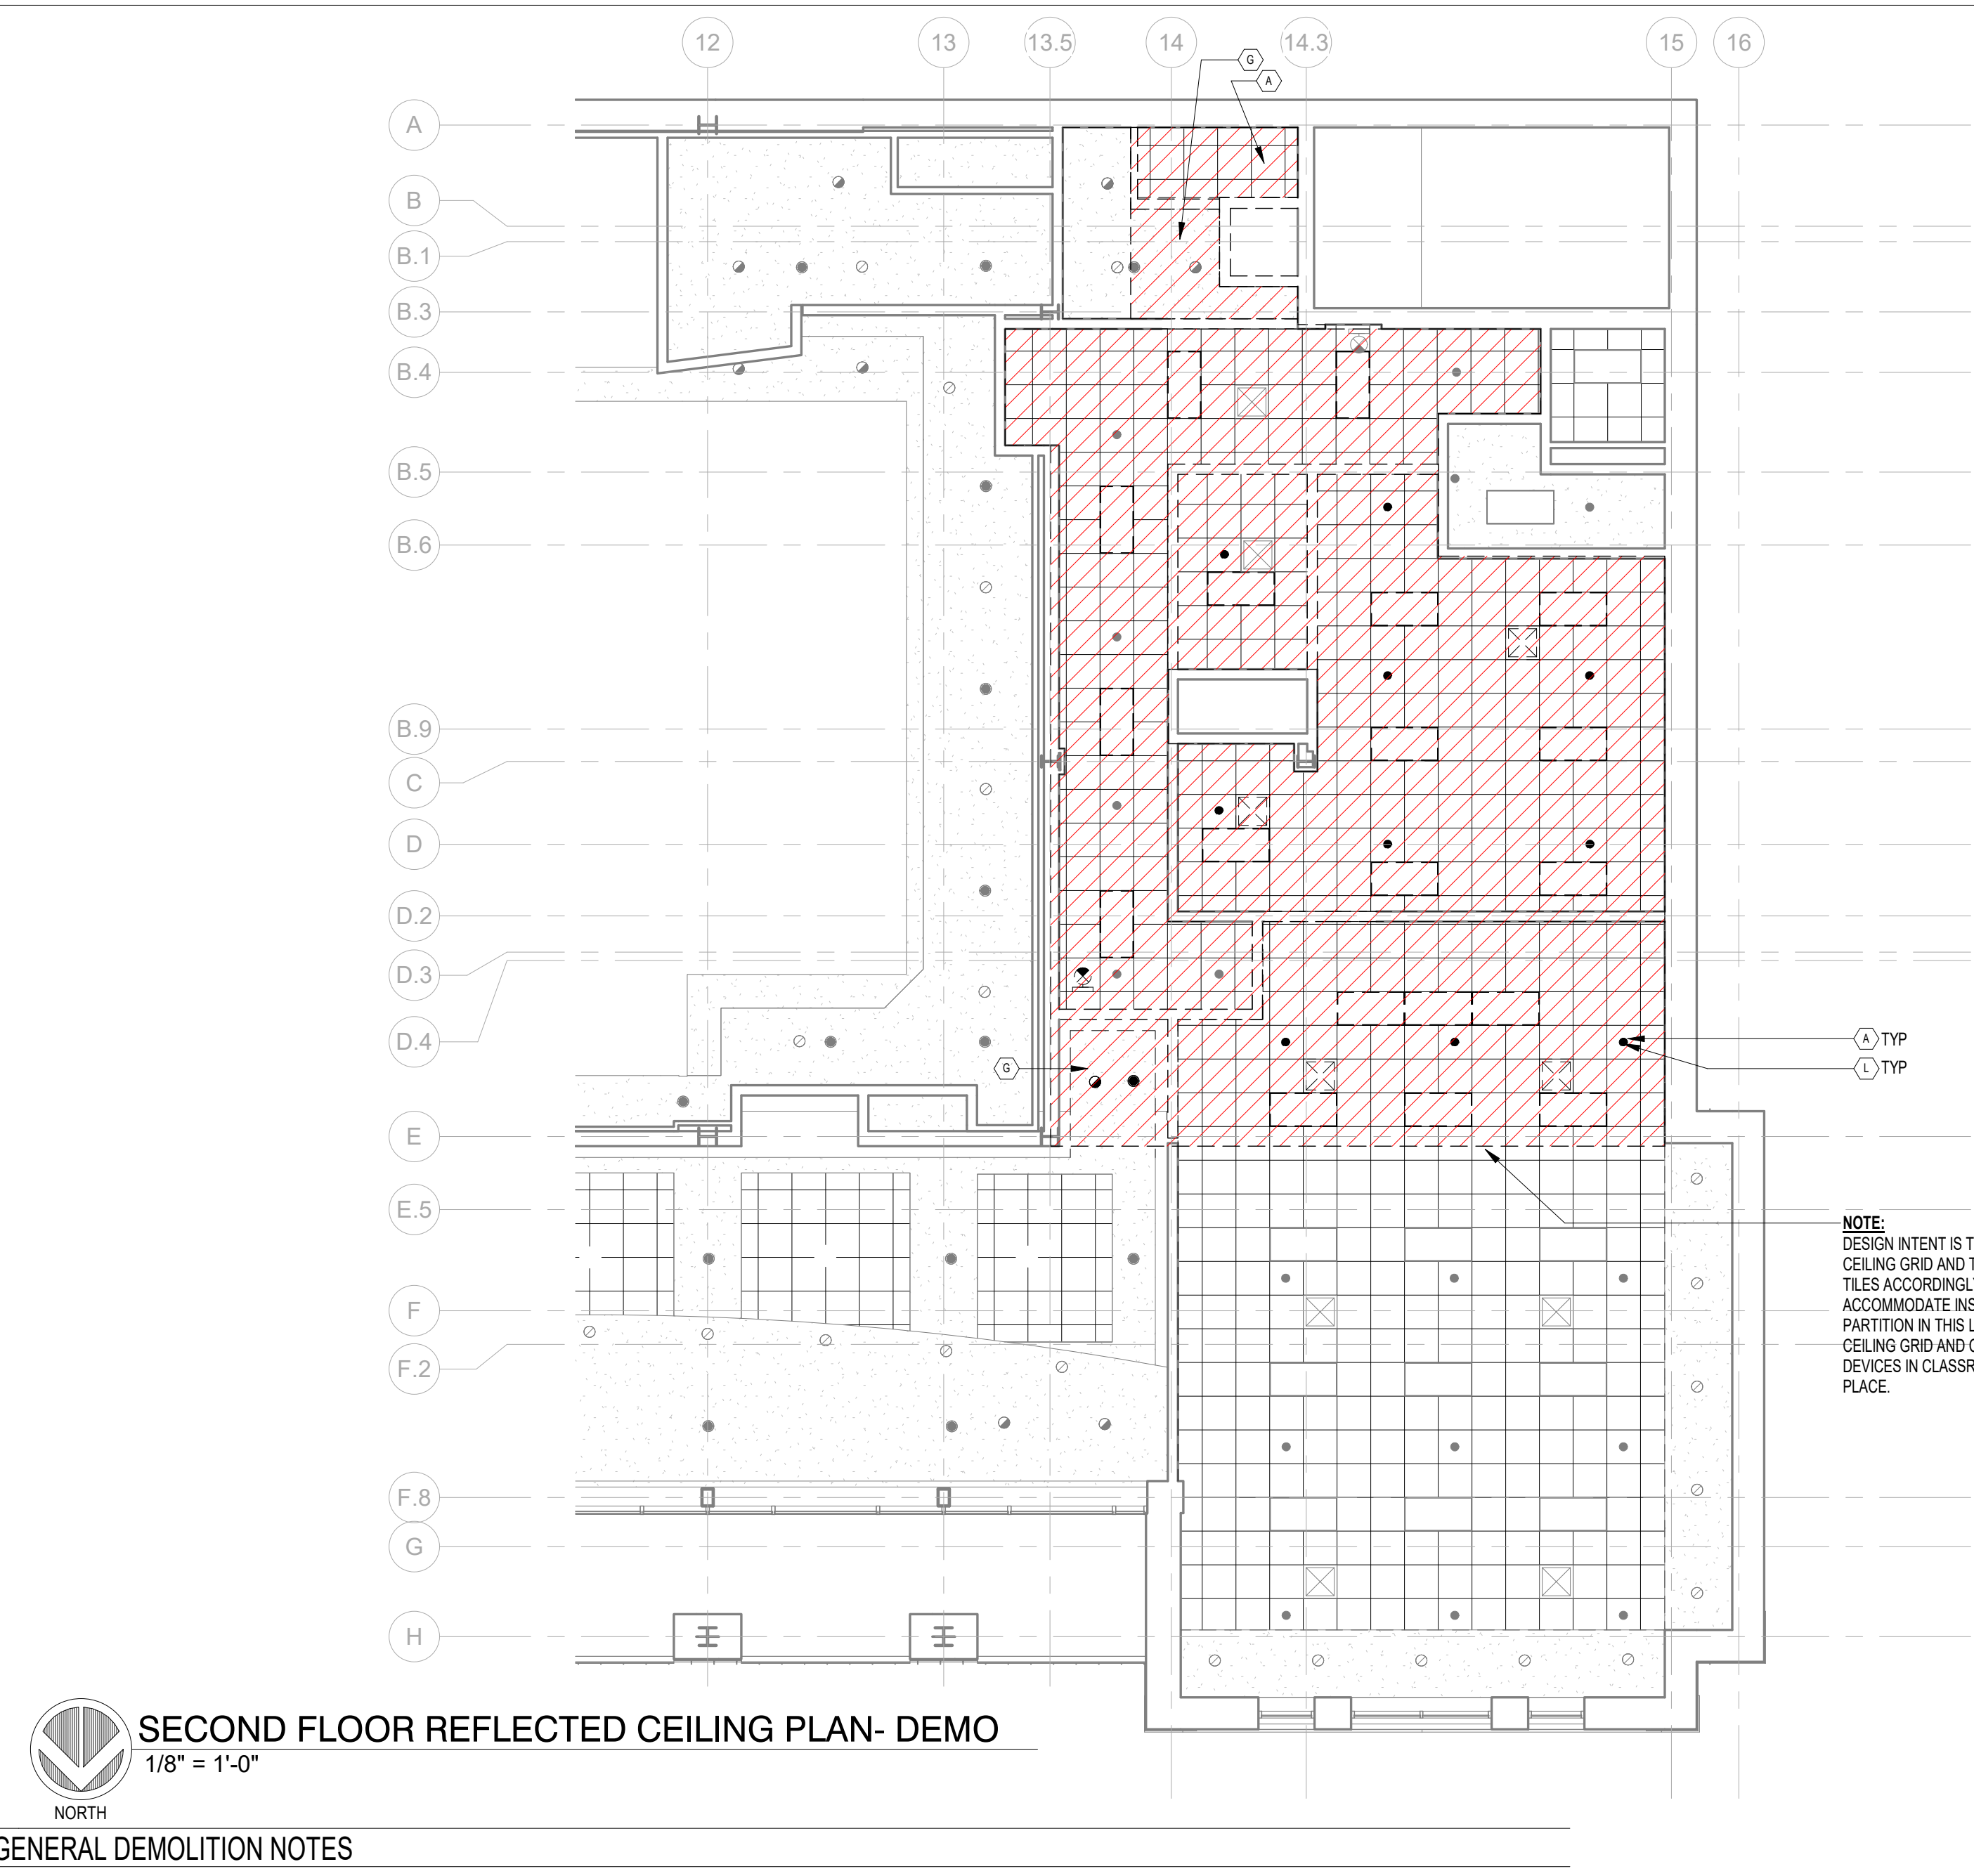

- GENERAL DEMOLITION NOTES**
- DEMOLITION NECESSARY AS A RESULT OF MPE WORK IS GENERALLY NOT INDICATED ON THE ARCHITECTURAL DRAWINGS. CONTRACTOR SHALL COORDINATE AND INCLUDE DEMOLITION WORK ASSOCIATED WITH MECHANICAL, PLUMBING AND ELECTRICAL DRAWINGS AND SPECIFICATIONS. COORDINATE DISCONNECTION AND ABANDONMENT OF ELECTRICAL, PLUMBING WASTE AND SUPPLY GAS AND OTHER UTILITIES WITH MECHANICAL, ELECTRICAL, AND PLUMBING DEMOLITION PLANS. COMPLY WITH APPLICABLE CODES FOR TERMINATION OF ALL UTILITIES.
 - COORDINATE DEMOLITION OF EXISTING FIRE ALARM DEVICES WITH FIRE ALARM CONTRACTOR.
 - REMOVE LOOSE AND FLAKING PAINT FROM EXISTING WALL AND HOLLOW METAL FRAME SURFACES SCHEDULED TO REMAIN AND PREP FOR NEW FINISH.
 - ABANDONED FLOOR PENETRATIONS OF ELECTRICAL, PLUMBING EQUIPMENT, ANCHORS AND SIMILAR ITEMS SHALL BE REMOVED, CAPPED OR CUT OFF BELOW THE LEVEL OF NEW FINISHED FLOOR. FLOOR SHALL BE PATCHED TO RECEIVE NEW FLOOR FINISHES.
 - EXISTING FIRE EXTINGUISHERS AND FIRE EXTINGUISHER CABINETS TO REMAIN.
 - REMOVE DEMOLITION DEBRIS FROM SITE. DISPOSE IN ACCORDANCE WITH APPLICABLE LAWS AND REGULATIONS.
 - COORDINATE PATCHING, INFILL, NEW CONSTRUCTION WITH DEMOLITION NOTES AND NEW WORK NOTES ON OTHER ARCHITECTURAL DRAWINGS.
 - PATCH ABANDONED ROOF AND WALL PENETRATIONS IMMEDIATELY UPON REMOVAL OF EQUIPMENT TO WEATHERPROOF BUILDINGS.
 - WHEN REMOVING ITEMS ATTACHED TO FINISH SURFACES TO REMAIN AND BE EXPOSED TO VIEW, REMOVE ALL EVIDENCE OF FASTENERS.
 - WHERE REMOVAL OF EXISTING THRU WALL EQUIPMENT, LOUVERS, PIPING AND SIMILAR ITEMS IS NECESSARY, THE CONTRACTOR SHALL INFILL, PATCH AND MAKE WEATHERTIGHT ABANDONED WALL OPENINGS. FINISH BOTH INTERIOR AND EXTERIOR FINISH SURFACES TO MATCH EXISTING CONDITIONS. WEATHERPROOF THE OPENING IMMEDIATELY UPON REMOVAL OF THE DEMOLISHED ITEM.
 - WHERE MISCELLANEOUS EXTERIOR MECHANICAL EQUIPMENT IS REMOVED, BUT NOT REPLACED, REMOVE ABANDONED CONCRETE EQUIPMENT PADS. RESTORE DISTURBED AREAS TO MATCH ADJACENT SURFACES.
 - CONTRACTOR SHALL PROTECT ITEMS SCHEDULED TO REMAIN.
 - OWNER WILL REMOVE AND RELOCATE MOVEABLE ITEMS OF VALUE, SUCH AS CHAIRS, DESKS, COMPUTERS, CLOCKS, MIRRORS, POSTERS, PICTURES, FLAGS, PROJECTION SCREENS, SUPPLIES, TABLES, CURTAINS, CURTAIN RODS, MICROWAVES, CUBBIES, SHELVES AND ACTIVE BOARDS, ETC., EXCEPT AS SPECIFICALLY NOTED OTHERWISE. OWNER WILL PROVIDE STORAGE AS NECESSARY TO ACCOMMODATE OWNERS FURNISHINGS FOR DURATION OF PROJECT.


SECOND FLOOR REFLECTED CEILING PLAN- DEMO
1/8" = 1'-0"
NORTH

DEMOLITION NOTES: REFLECTED CEILING PLAN


	REMOVE AND DISPOSE OF ACT CEILING AND CEILING SUSPENSION/SUPPORT SYSTEM.		REMOVE AND DISPOSE OF SPRINKLER HEAD. PATCH AND PAINT CEILING AS NECESSARY TO MATCH ADJACENT CEILING.
	REMOVE AND STORE EXISTING PROJECTOR AND SOUND EQUIPMENT (REMOVAL BY CAPD STAFF)		REMOVE AND DISPOSE OF STAIR GYPSUM SOFFIT AND SPRINKLER HEADS.
	REMOVE AND DISPOSE OF EXISTING CAN LIGHTS		UNINSTALL SPRINKLER HEAD AND COORDINATE WITH THE MPE SHEETS TO DETERMINE WHETHER THE COMPONENT CAN BE REPURPOSED. ASSESS WHETHER THE SPRINKLER HEAD SHOULD BE DISPOSED OF OR IF IT CAN BE EFFECTIVELY REUSED.
	REMOVE AND DISPOSE OF EXISTING FIRE SAFETY EQUIPMENT (EXIT SIGNS, STROBES, ETC.)		REMOVE AND DISPOSE OF LINEAR DIFFUSER
	NOT USED		NO WORK IN THIS ROOM.
	REMOVE AND DISPOSE OF WOOD CROWN MOLDING.		REMOVE AND DISPOSE OF EXISTING GYPSUM CEILING BOARD. LEAVE CEILING SUSPENSION SYSTEM IN PLACE. PREPARE EXISTING SUPPORT SYSTEM FOR INSTALLATION OF CURTAIN TRACK SYSTEM.
	REMOVE AND DISPOSE OF EXISTING GYPSUM CEILING AND CEILING SUSPENSION/SUPPORT SYSTEM		
	REMOVE AND STORE ROLL UP PROJECTOR SCREEN AND ANY ADDITIONAL AV ACCESSORIES (REMOVAL BY CAPD STAFF)		
	REMOVE AND DISPOSE OF EXISTING LINEAR LIGHT. PATCH AND PAINT CEILING AS NECESSARY TO MATCH ADJACENT CEILING		

NOTE:
DESIGN INTENT IS TO MODIFY EXISTING CEILING GRID AND TRIM EXISTING ACOUSTICAL TILES ACCORDINGLY AS NECESSARY TO ACCOMMODATE INSTALLATION OF NEW PARTITION IN THIS LOCATION. REMAINDER OF CEILING GRID AND CEILING MOUNTED MPE DEVICES IN CLASSROOM 214 SHALL REMAIN IN PLACE.

NOTE:
REFER TO MECHANICAL, ELECTRICAL, PLUMBING AND FIRE PROTECTION PLANS FOR SPECIFIC NOTES REGARDING ALL DEVICES, FIXTURES, DIFFUSERS, GRILLES, ETC.

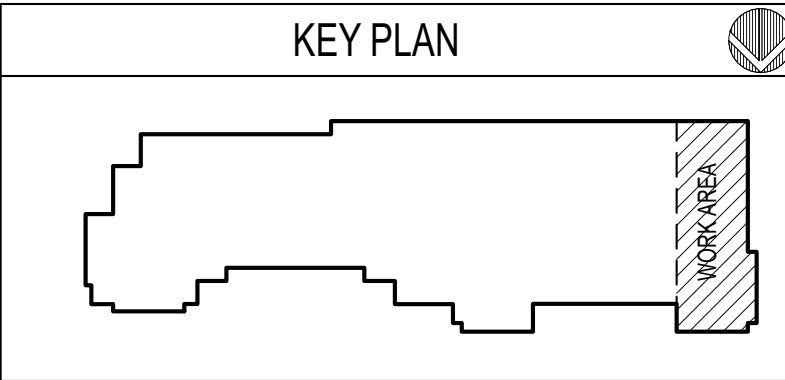

NOTE:
11' x 17' SHEETS ARE PLOTTED AT 1/2
THE SCALE NOTED ON THESE DRAWINGS

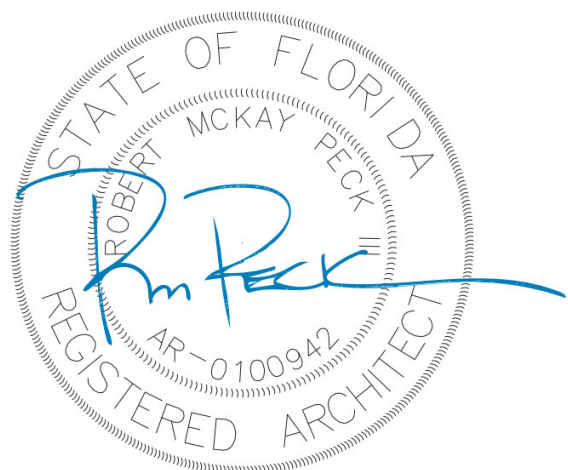


**FSU TURNBULL
CONFERENCE CENTER
RENOVATIONS**

REV	DATE	DESCRIPTION
1	04.17.24	FSU PERMIT

PROJECT PHASE
CONSTRUCTION DOCUMENTS

DATE 18 OCTOBER 2023	DRAWN BY B/RMP
PROJECT NO 74000	CHECKED BY RMP/BI

SHEET TITLE FIRST FLOOR REFLECTED CEILING - NEW WORK	
SHEET NO A132.1	REV NO ▲

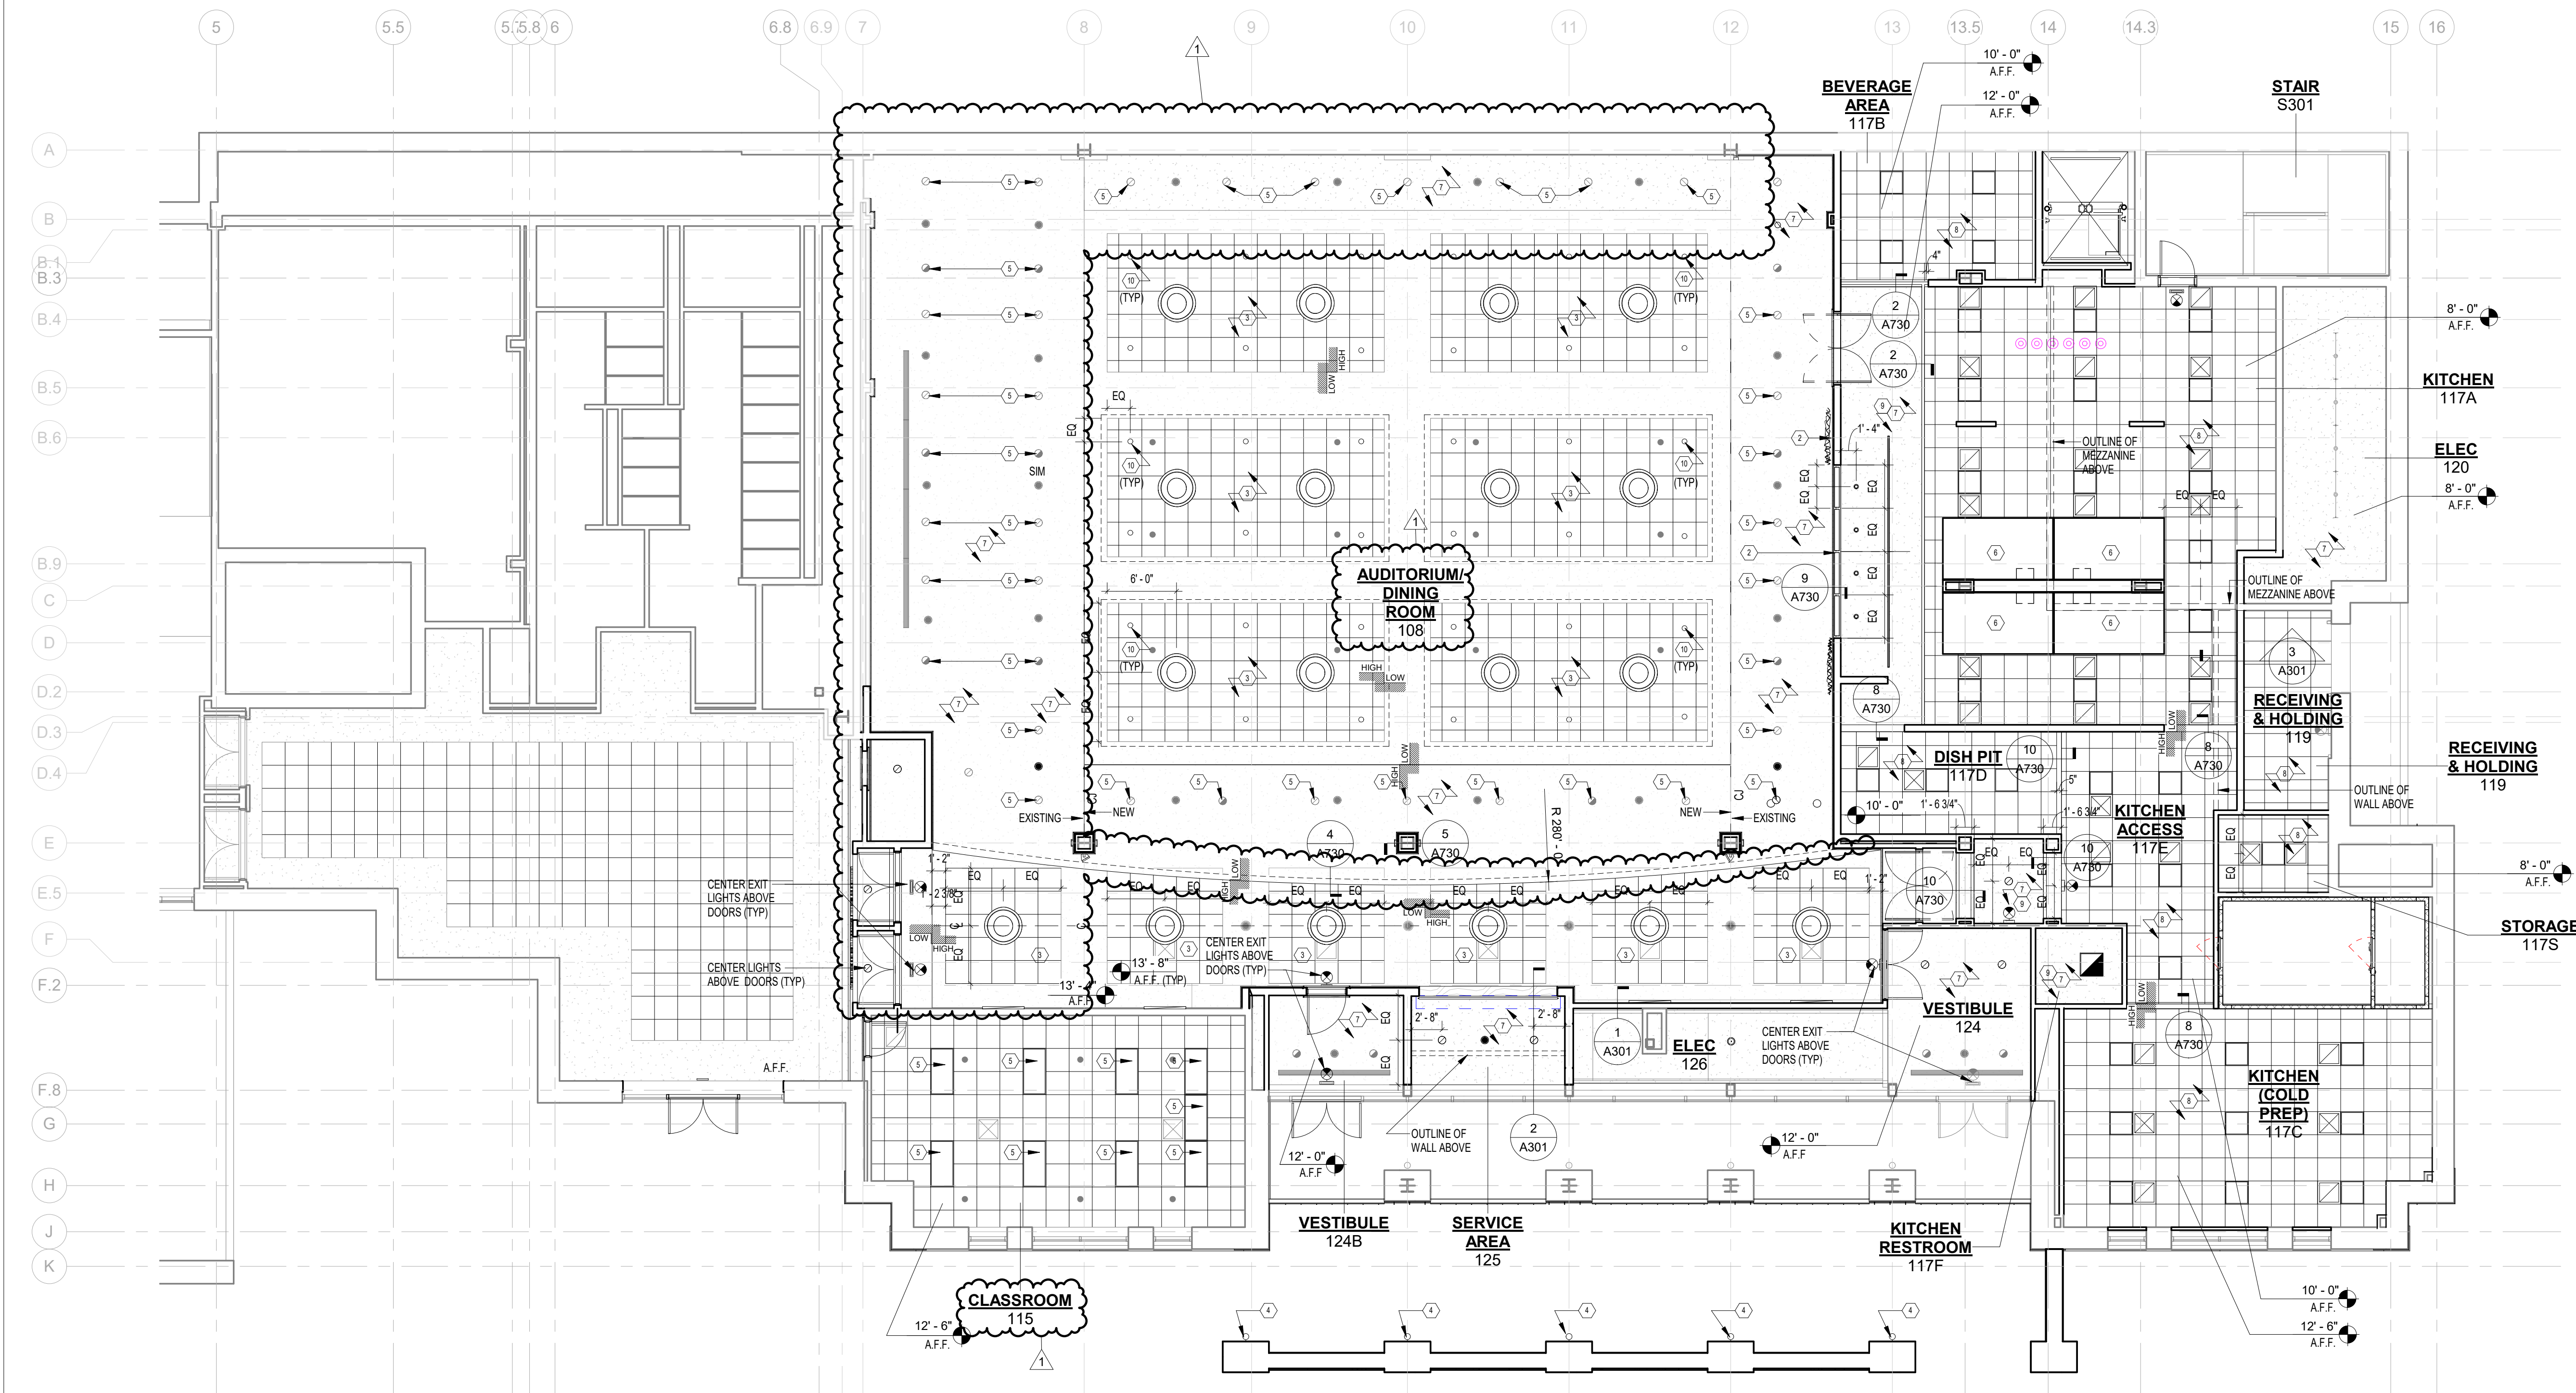


FIRST FLOOR REFLECTED CEILING PLAN-NEW WORK
1/8" = 1'-0"
NORTH

REFLECTED CEILING LEGEND:

	GWB CEILING		CONTINUOUS LIGHT SLOT		WALL MOUNTED INCANDESCENT, FLUORESCENT, OR HID LIGHT FIXTURE (LED FOR NEW FIXTURES)
	LAY-IN ACOUSTICAL CLG		LINEAR PENDANT FIXTURE		WALL MOUNTED EMERGENCY INCANDESCENT, FLUORESCENT, OR HID LIGHT FIXTURE (LED FOR NEW FIXTURES)
	LINEAR DIFFUSER		PENDANT FIXTURE		INCANDESCENT, FLUORESCENT, OR HID LIGHT FIXTURE (LED FOR NEW FIXTURES)
	LINEAR SIDEWALL DIFFUSER		FEATURE PENDANT FIXTURE		EMERGENCY INCANDESCENT, FLUORESCENT, OR HID LIGHT FIXTURE (LED FOR NEW FIXTURES)
	CEILING DIFFUSER		LED UPLIGHT COVE FIXTURE		EMERGENCY EXIT LIGHT FIXTURE (PROVIDE ARROWS WHERE SHOWN)
	CEILING RETURN		STAGE TRACK LIGHTING		PENDANT SPRINKLER HEAD
	CEILING EXHAUST		EXISTING CEILING MOUNT PROJECTOR		RECESSED SPRINKLER HEAD
			NO CEILING - EXPOSED UNDERSIDE OF STRUCTURE		

CONSTRUCTION NOTES: REFLECTED CEILING PLAN

- UPLIGHT LED FIXTURE IN SOFFIT
- RECESSED TRACK CURTAINS SEE DETAIL 9 / A730
- EXISTING CEILING FINISH TO REMAIN
- EXTERIOR WALL MOUNTED LIGHT ON COURTYARD PILASTERS (TO BE SELECTED BY OWNERS)
- REPLACE EXISTING INCANDESCENT, FLUORESCENT, OR HID LIGHT FIXTURE WITH NEW LED FIXTURE
- NEW SS KITCHEN EXHAUST HOOD (SEE FOOD SERVICE EQUIP SCHEDULE)
- PAINT GYP CEILING (SEE FINISH SCHEDULE)
- INSTALL NEW CEILING TILES ACT-2 (SEE FINISH SCHEDULE)
- GYP CEILING PAINTED WITH EPOXY (SEE FINISH SCHEDULE)
- INSTALL NEW "PIN" LIGHT IN EXISTING CEILING TILE TAKE EXTRA PRECAUTION TO INSURE CEILING TILES ARE NOT DAMAGED AS A RESULT OF THE NEW LIGHT INSTALLATION

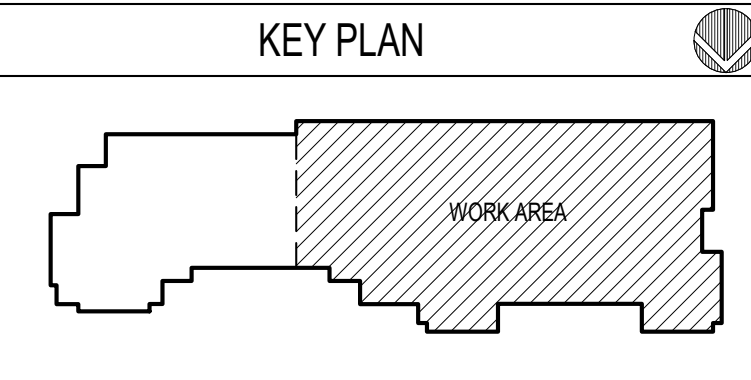

NOTE:
11" x 17" SHEETS ARE PLOTTED AT 1/2
THE SCALE NOTED ON THESE DRAWINGS

**FSU TURNBULL
CONFERENCE CENTER
RENOVATIONS**

REV	DATE	DESCRIPTION

PROJECT PHASE
CONSTRUCTION DOCUMENTS

DATE
18 OCTOBER 2023


PROJECT NO
74000

SHEET TITLE
**L.L. & 2ND FLOOR
REFLECTED CEILING
PLAN - NEW WORK**


DRAWN BY
RMP

CHECKED BY
RMP/BI

SHEET NO
A132.2

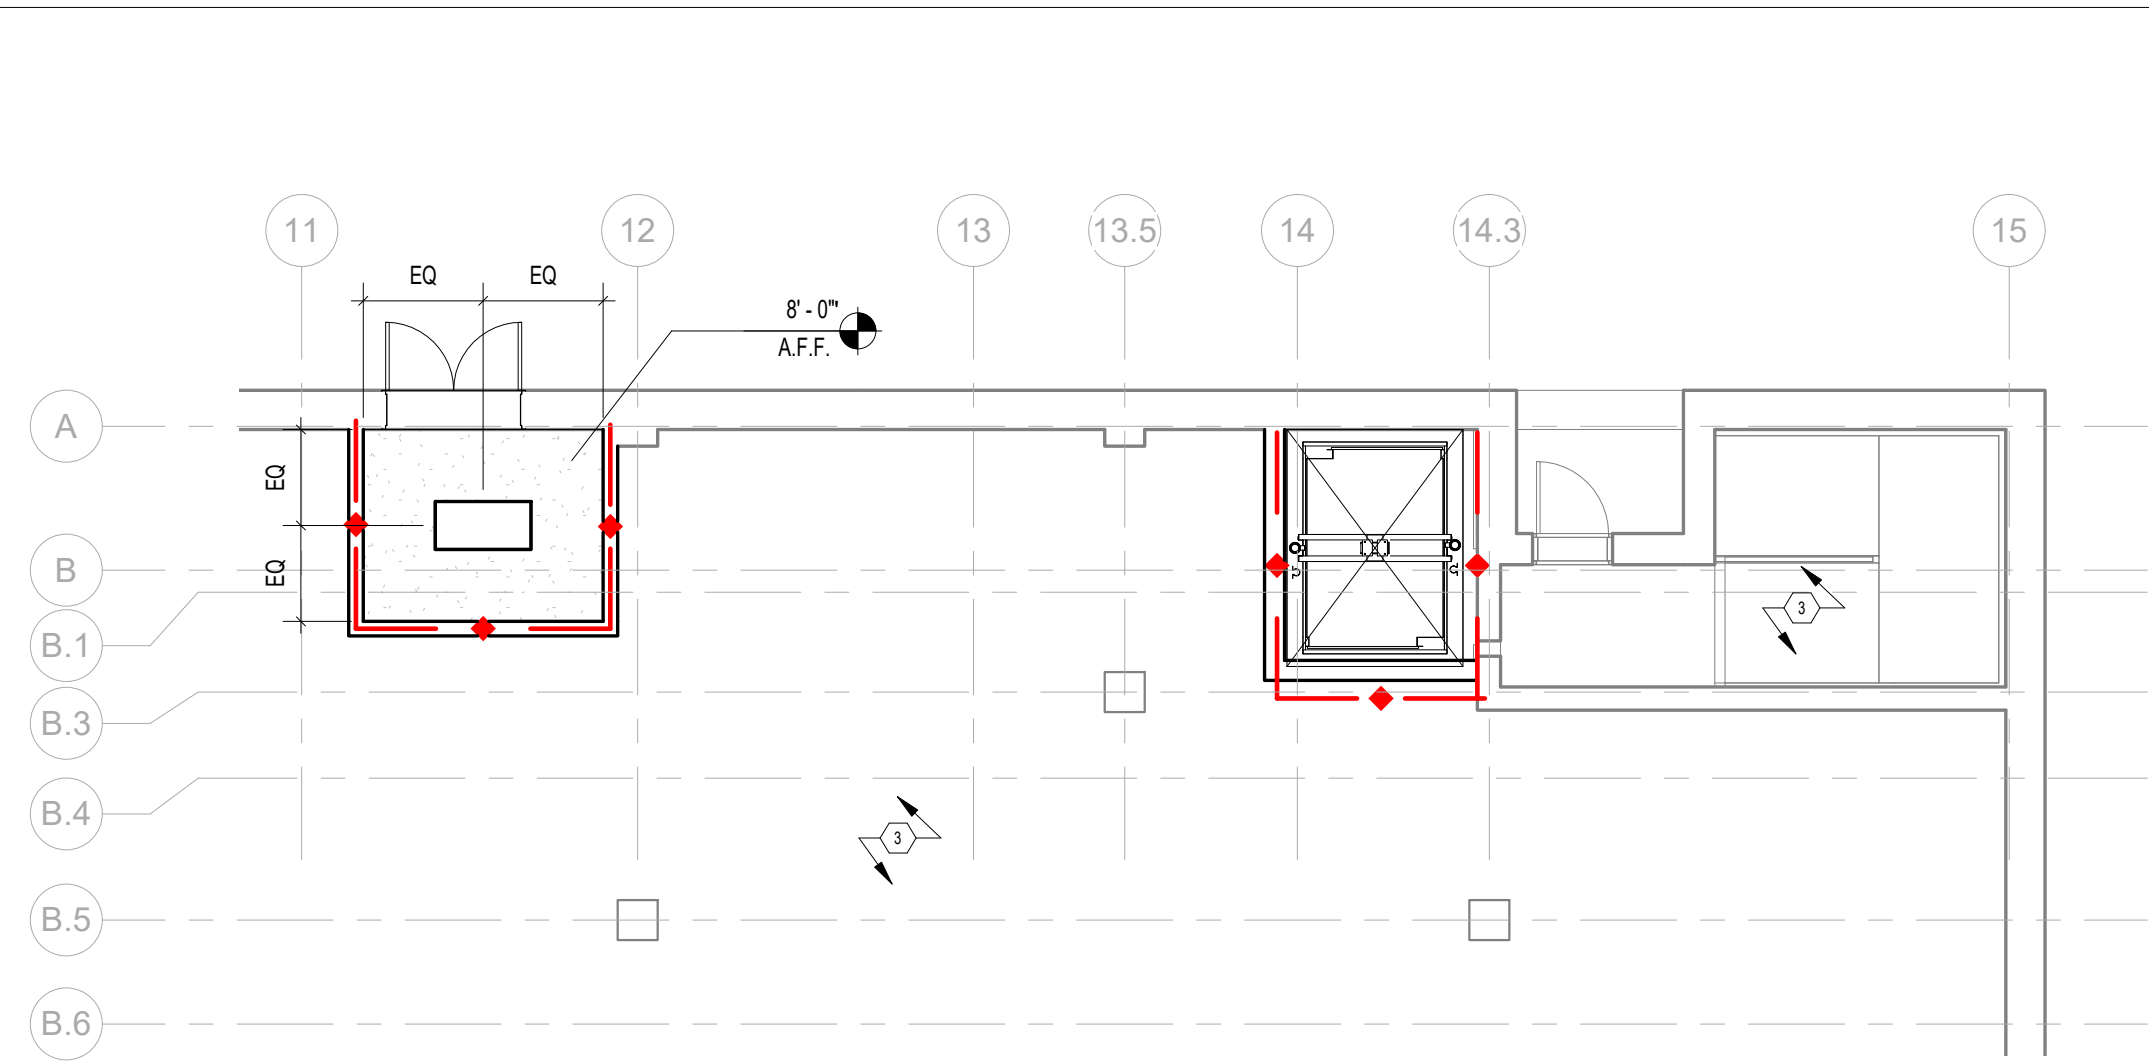

LOWER LEVEL REFLECTED CEILING PLAN- NEW WORK
1/8" = 1'-0"
NORTH

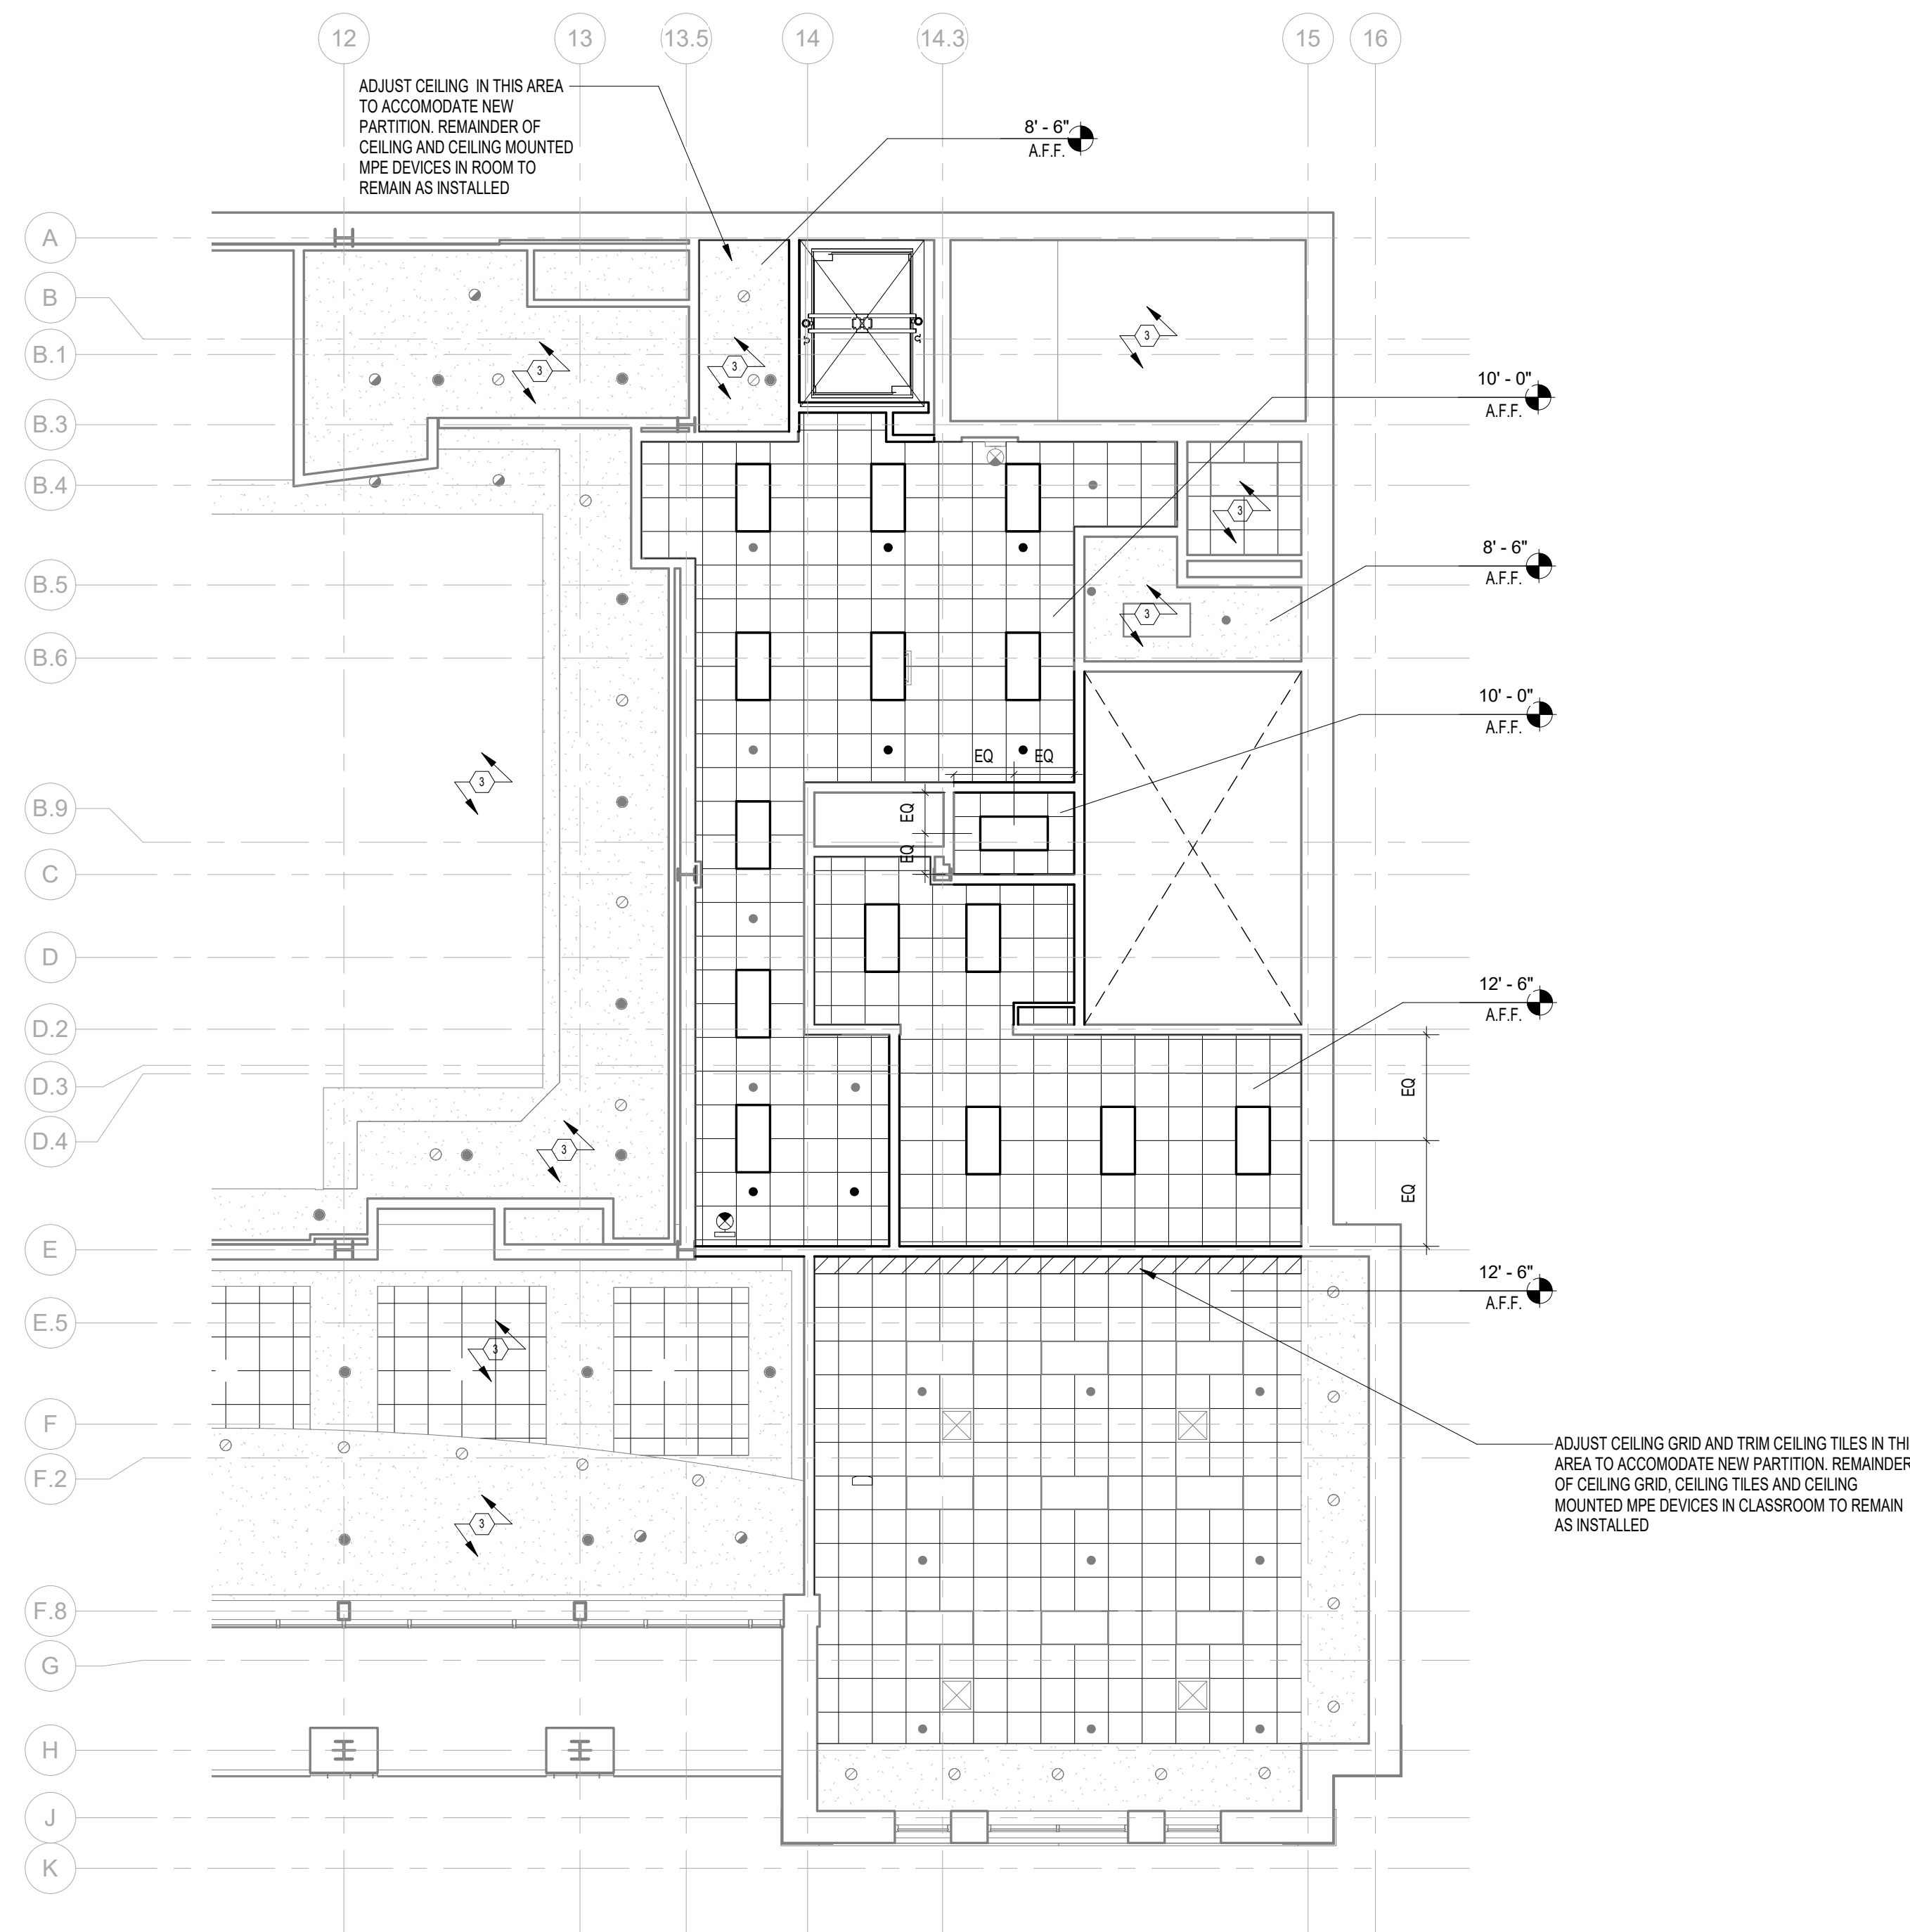

SECOND FLOOR REFLECTED CEILING PLAN-NEW WORK
1/8" = 1'-0"
NORTH


REFLECTED CEILING LEGEND:

GWB CEILING	CONTINUOUS LIGHT SLOT	WALL MOUNTED INCANDESCENT, FLUORESCENT, OR HID LIGHT FIXTURE (LED FOR NEW FIXTURES)
LAY-IN ACOUSTICAL CLG	LINEAR PENDANT FIXTURE	WALL MOUNTED EMERGENCY INCANDESCENT, FLUORESCENT, OR HID LIGHT FIXTURE (LED FOR NEW FIXTURES)
LINEAR DIFFUSER	PENDANT FIXTURE	INCANDESCENT, FLUORESCENT, OR HID LIGHT FIXTURE (LED FOR NEW FIXTURES)
LINEAR SIDEWALL DIFFUSER	FEATURE PENDANT FIXTURE	EMERGENCY INCANDESCENT, FLUORESCENT, OR HID LIGHT FIXTURE (LED FOR NEW FIXTURES)
CEILING DIFFUSER	LED UPLIGHT COVE FIXTURE	EMERGENCY EXIT LIGHT FIXTURE (PROVIDE ARROWS WHERE SHOWN)
CEILING RETURN	STAGE TRACK LIGHTING	PENDANT SPRINKLER HEAD
CEILING EXHAUST	EXISTING CEILING MOUNT PROJECTOR	RECESSED SPRINKLER HEAD
		NO CEILING - EXPOSED UNDERSIDE OF STRUCTURE


CONSTRUCTION NOTES: REFLECTED CEILING PLAN

- ① UPLIGHT LED FIXTURE IN SOFFIT
 - ② RECESSED TRACK CURTAINS SEE DETAIL 9 / A730
 - ③ EXISTING CEILING FINISH TO REMAIN
 - ④ EXTERIOR WALL MOUNTED LIGHT ON COURTYARD PILASTERS (TO BE SELECTED BY OWNERS)
 - ⑤ REPLACE EXISTING INCANDESCENT, FLUORESCENT, OR HID LIGHT FIXTURE WITH NEW LED FIXTURE
 - ⑥ NEW SS KITCHEN EXHAUST HOOD (SEE FOOD SERVICE EQUIP SCHEDULE)
 - ⑦ PAINT GYP CEILING (SEE FINISH SCHEDULE)
 - ⑧ INSTALL NEW CEILING TILES ACT-2 (SEE FINISH SCHEDULE)
 - ⑨ GYP CEILING PAINTED WITH EPOXY (SEE FINISH SCHEDULE)
- ⑩ INSTALL NEW "PIN" LIGHT IN EXISTING CEILING TILE TAKE EXTRA PRECAUTION TO INSURE CEILING TILES ARE NOT DAMAGED AS A RESULT OF THE NEW LIGHT INSTALLATION

KEY PLAN

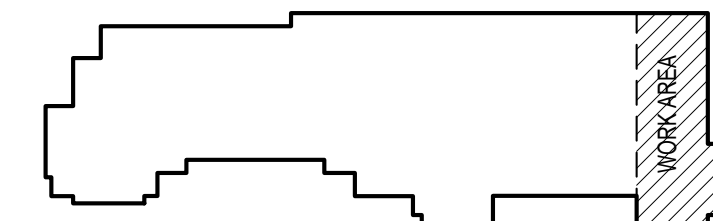

NOTE:
11" x 17" SHEETS ARE PLOTTED AT 1/2
THE SCALE NOTED ON THESE DRAWINGS

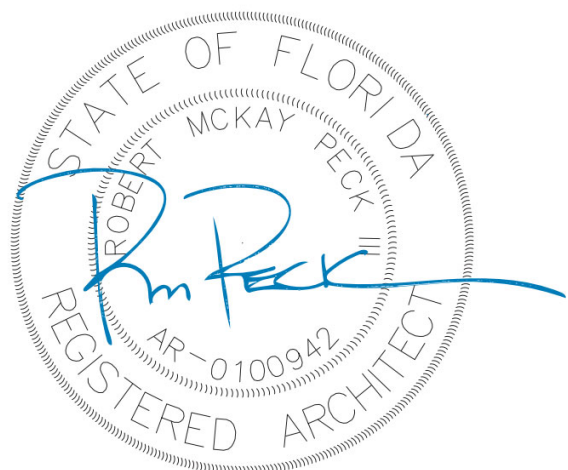

**FSU TURNBULL
CONFERENCE CENTER
RENOVATIONS**

REV	DATE	DESCRIPTION
1	04.17.24	FSU PERMIT

PROJECT PHASE
CONSTRUCTION DOCUMENTS


DATE
18 OCTOBER 2023

PROJECT NO
74000


SHEET TITLE
WALL SECTIONS

SHEET NO
A301


REV NO
A

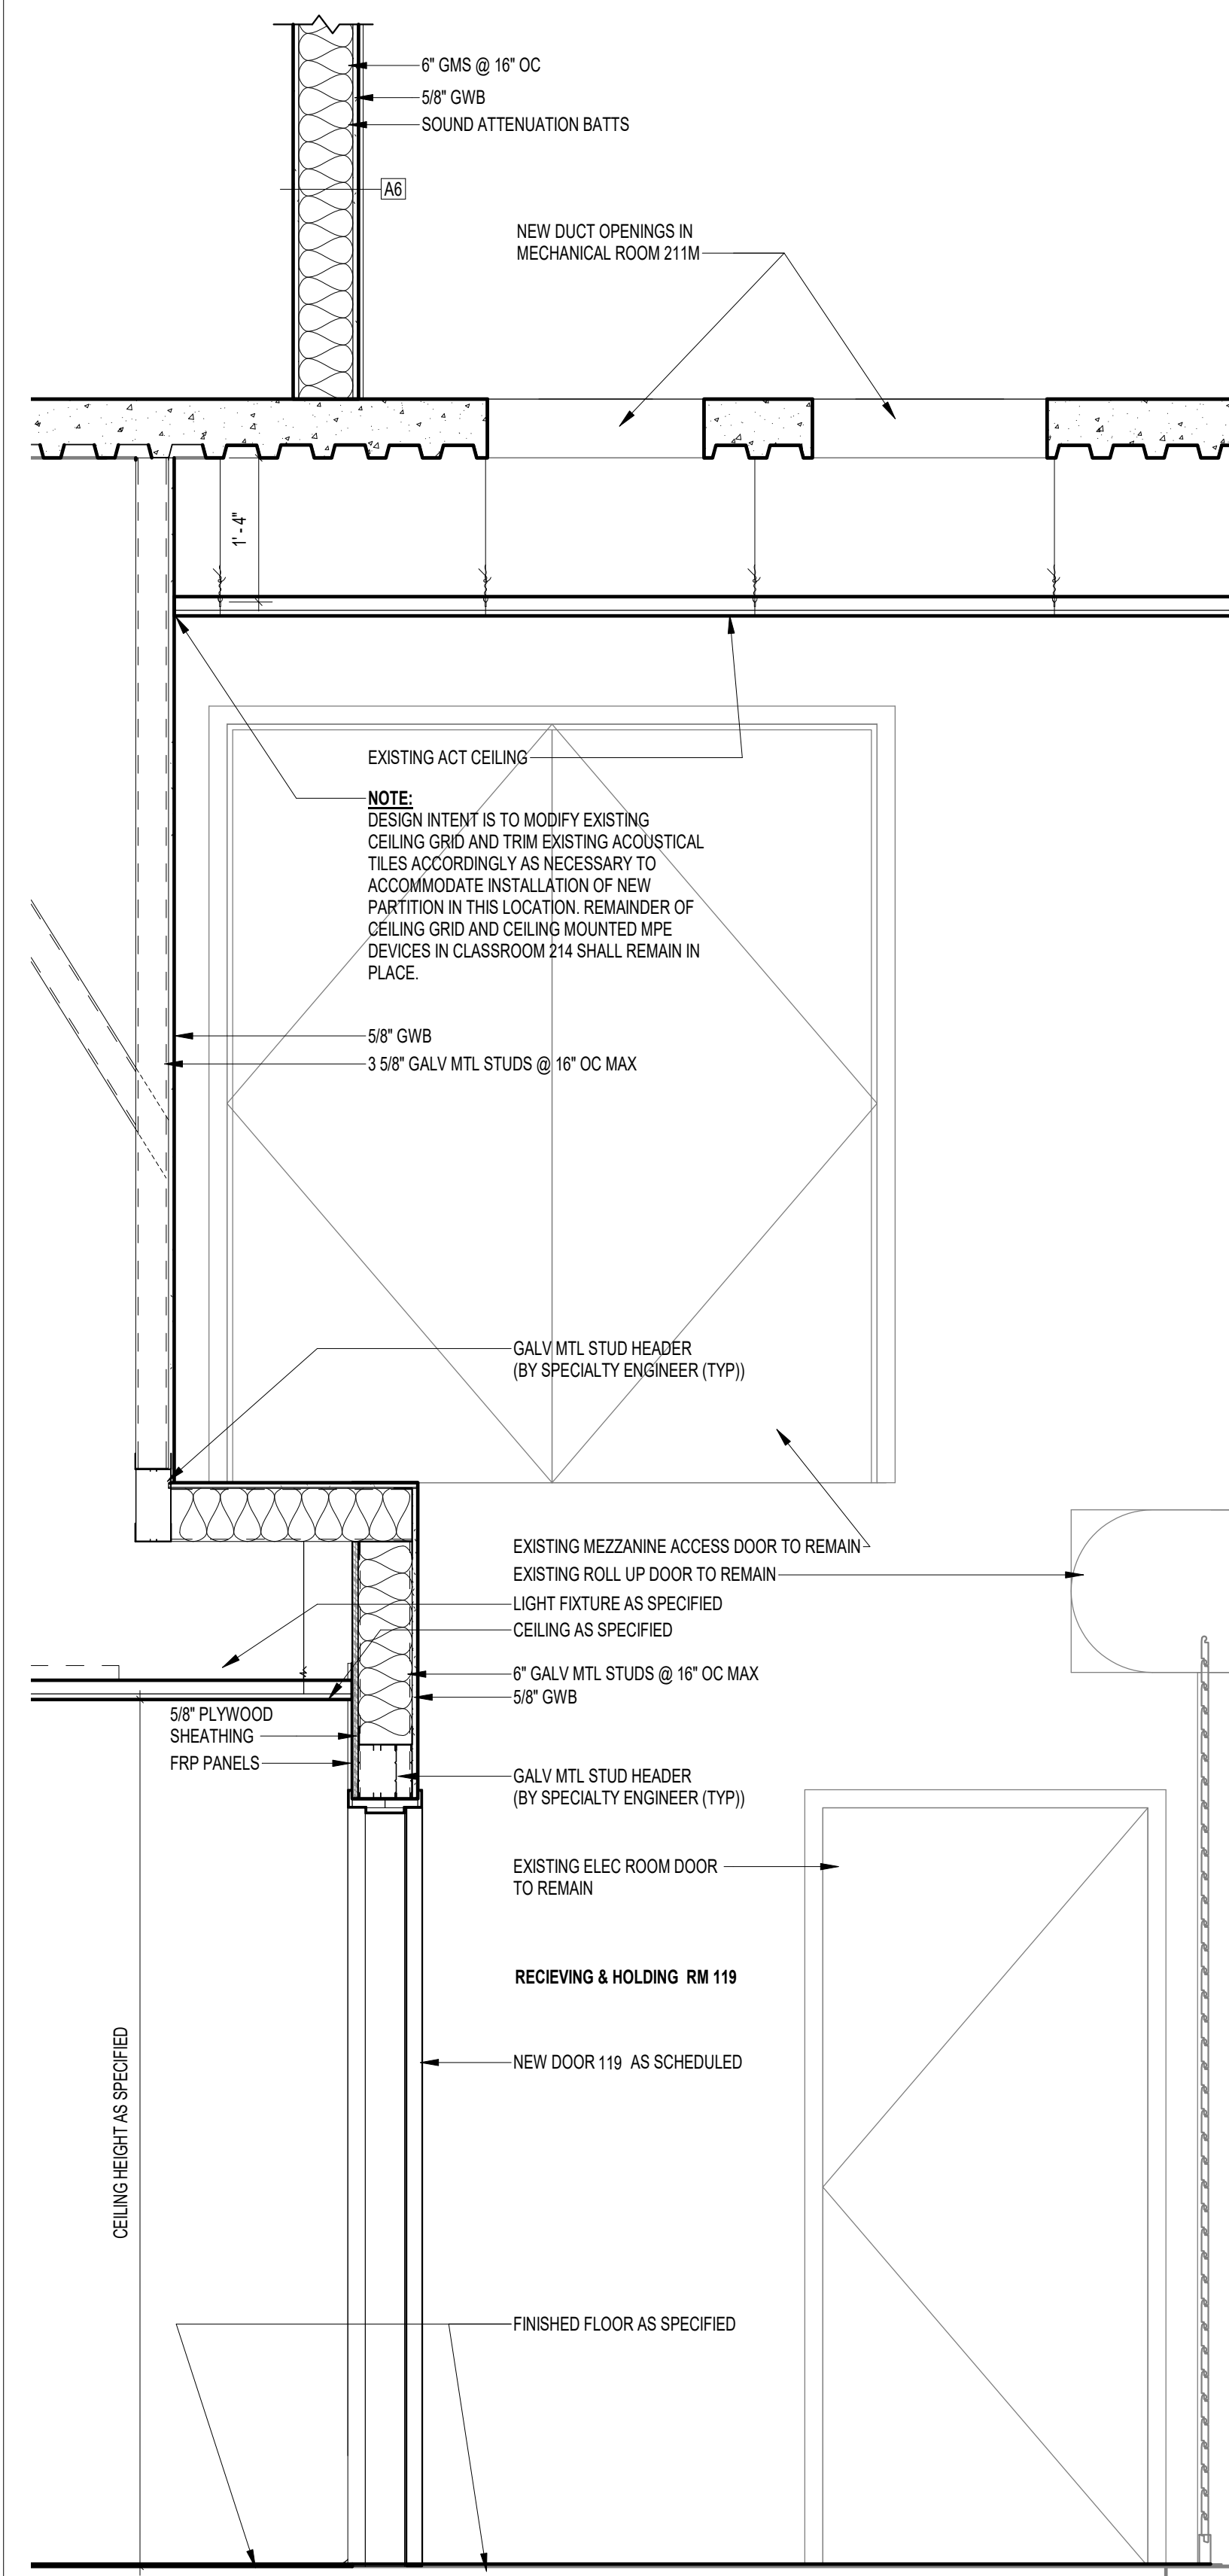

3 SECTION THRU RECIEVING & HOLDING
3/4" = 1'-0"

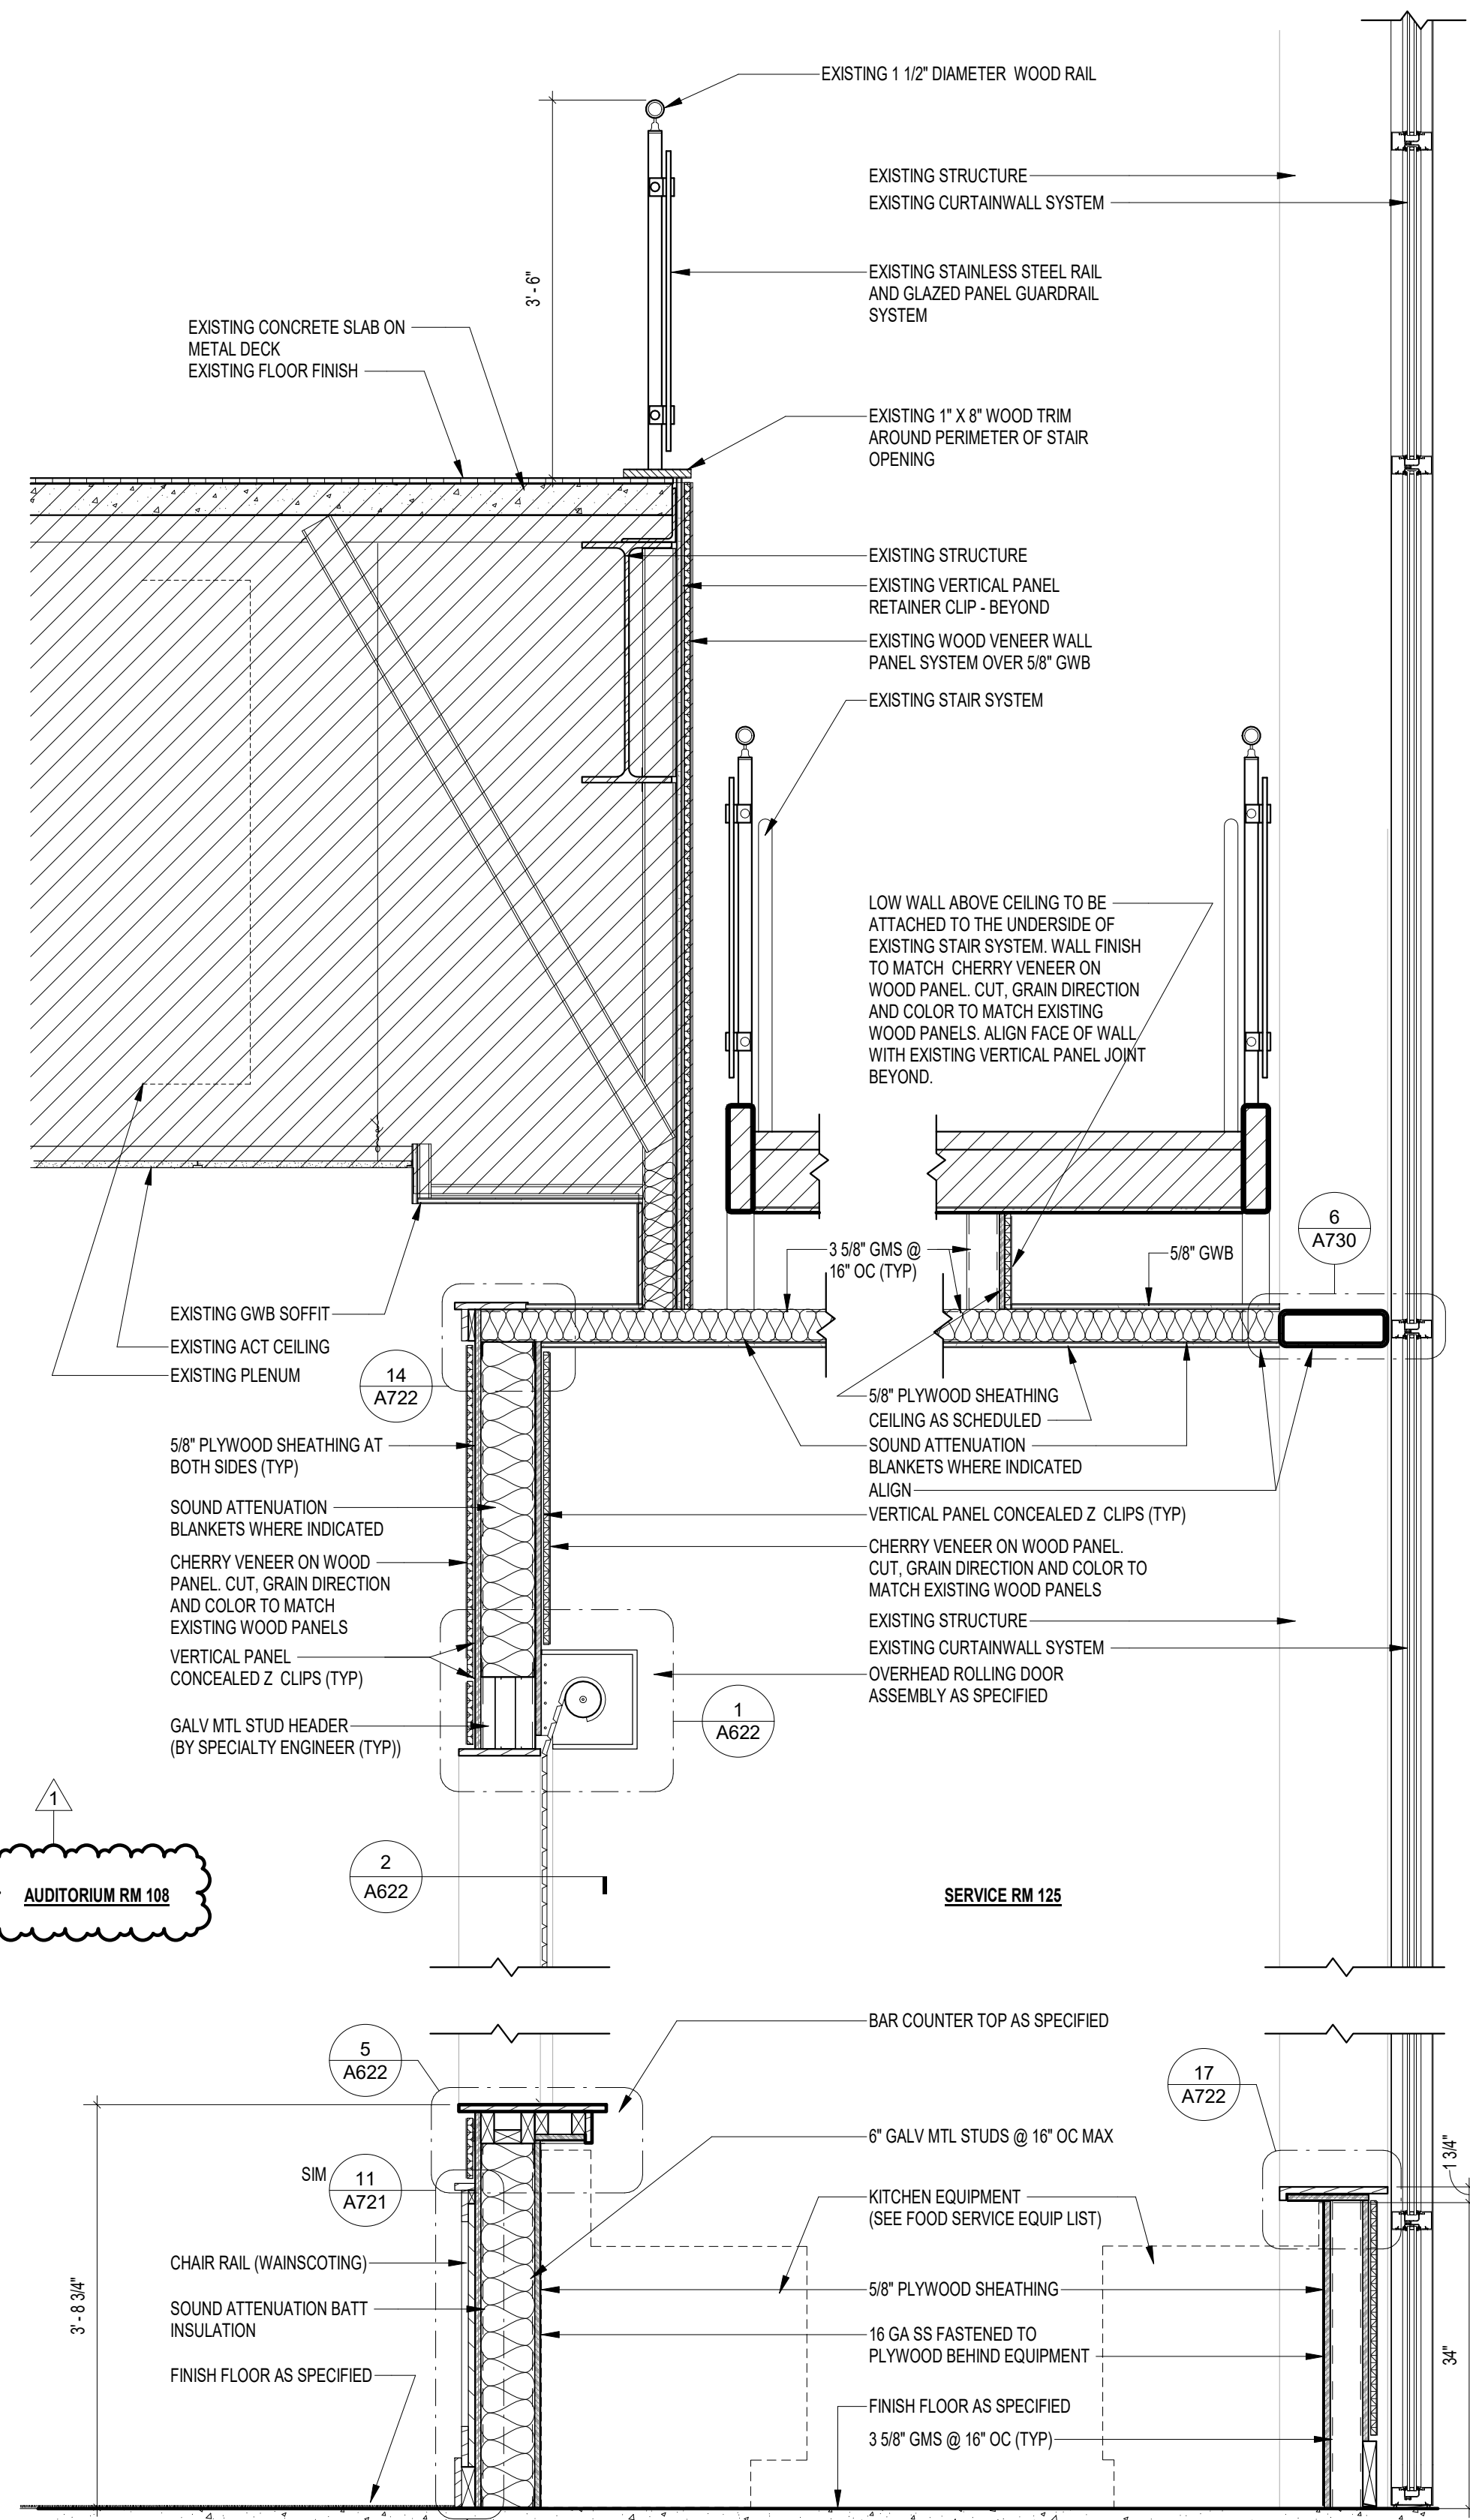

2 SECTION THRU STAIR WALL @ SERVICE AREA
3/4" = 1'-0"

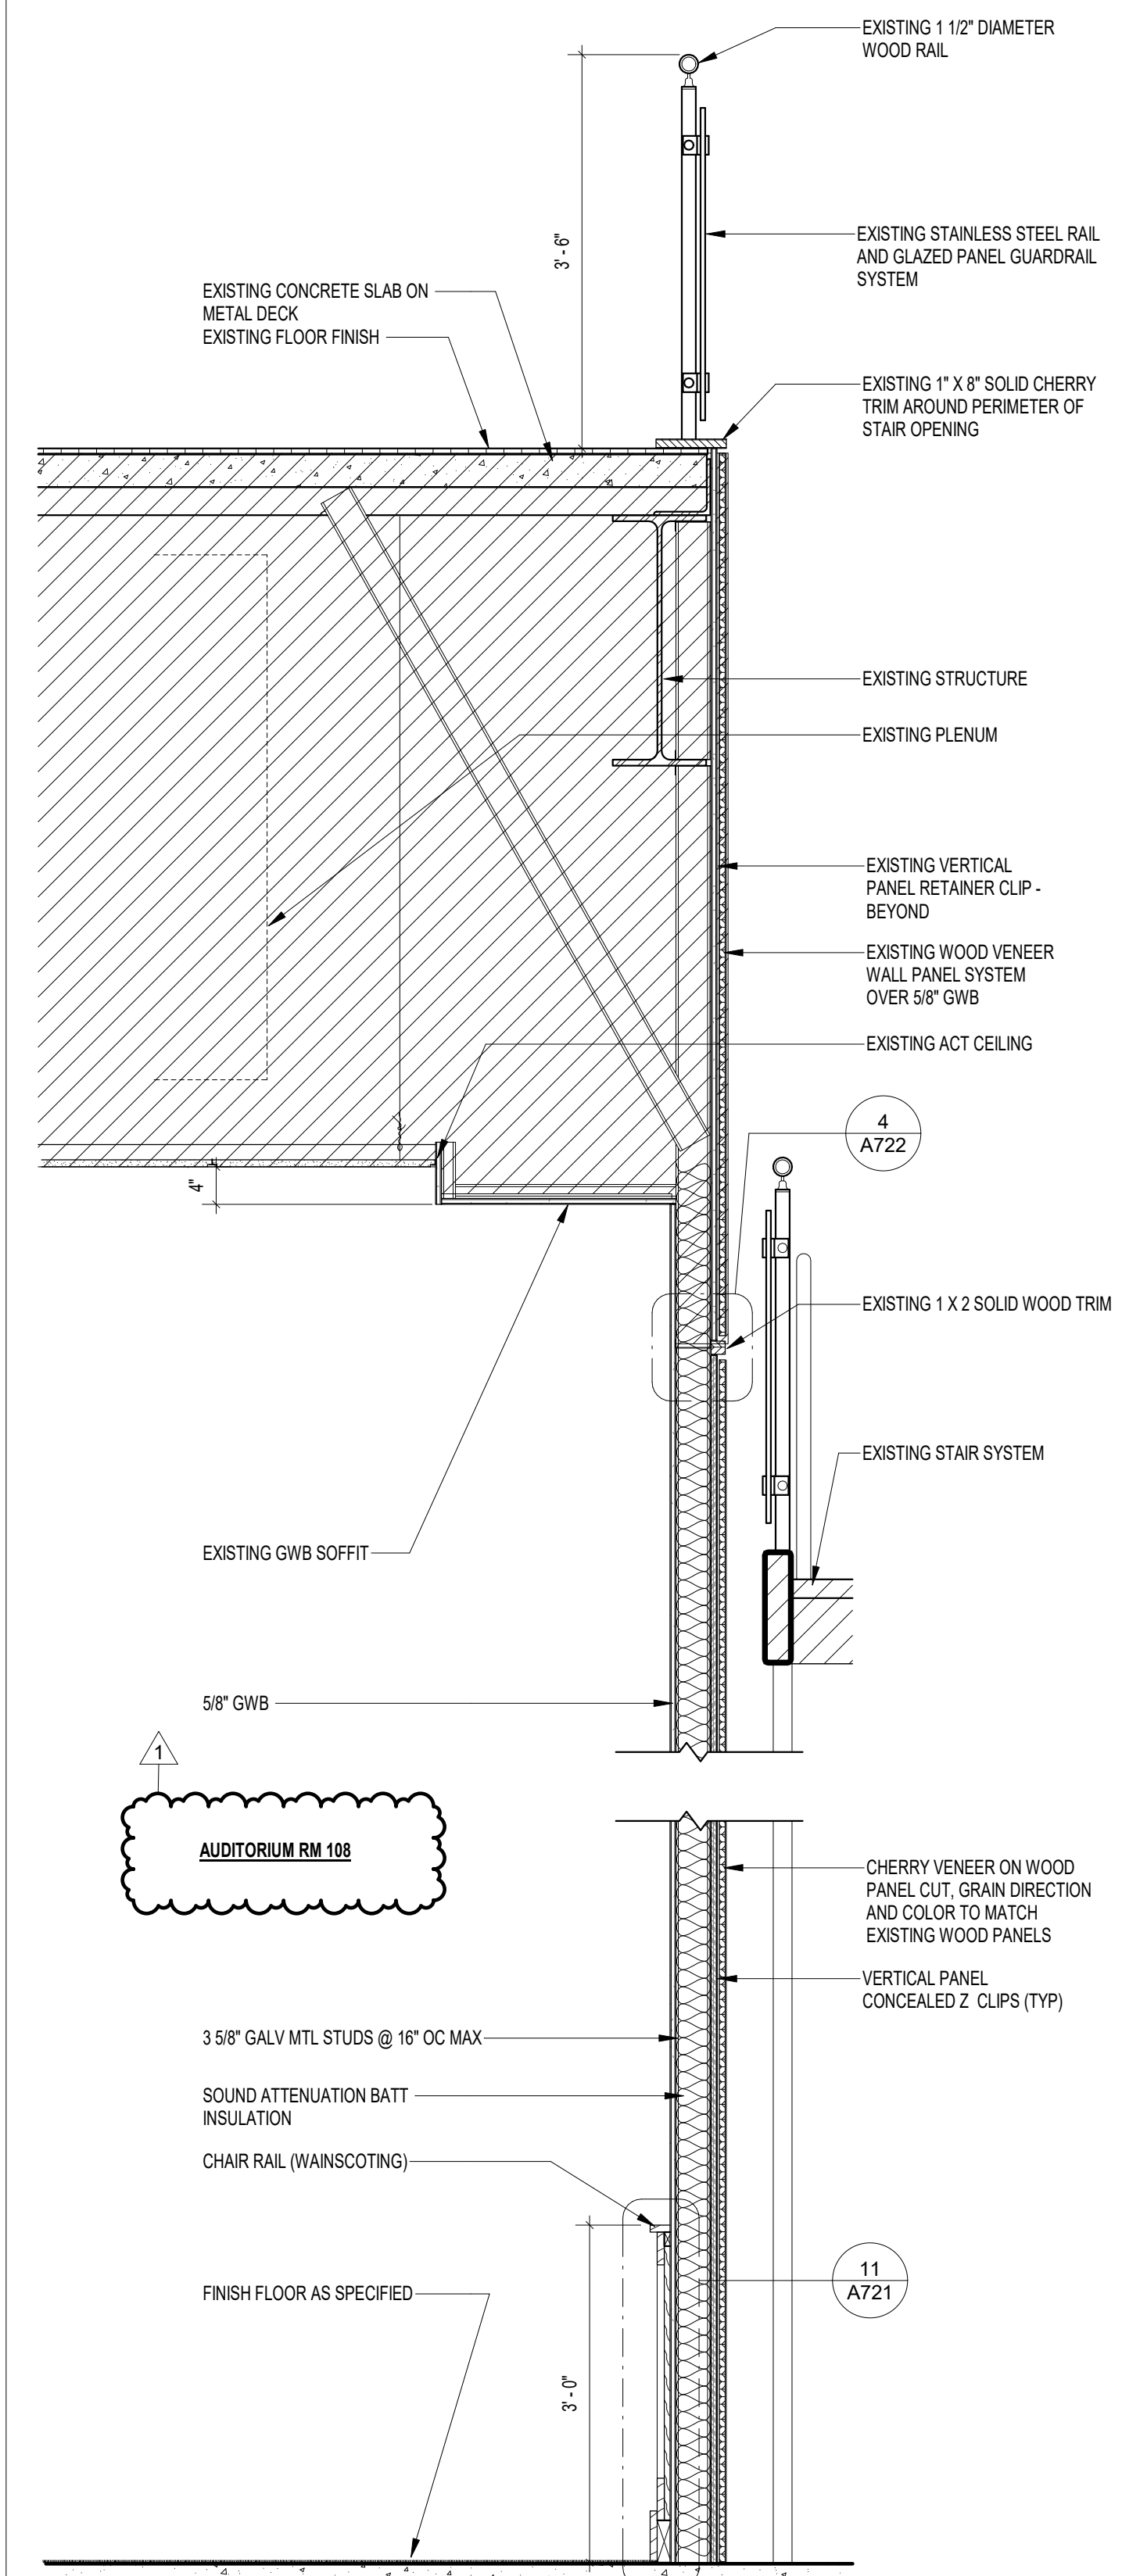


1 SECTION THRU STAIR WALL
3/4" = 1'-0"

NOTE:
ALL WOOD COMPONENTS COMPRISING
WAINSCOTING AND WOOD PANELING
SYSTEM SHALL BE FIRE RATED AND MEET A
MINIMUM FLAME SPREAD RATING OF CLASS B

NOTE:
ALL WOOD COMPONENTS COMPRISING
WAINSCOTING AND WOOD PANELING
SYSTEM SHALL BE FIRE RATED AND MEET A
MINIMUM FLAME SPREAD RATING OF CLASS B

NOTE:
11' x 17" SHEETS ARE PLOTTED AT 1/2
THE SCALE NOTED ON THESE DRAWINGS

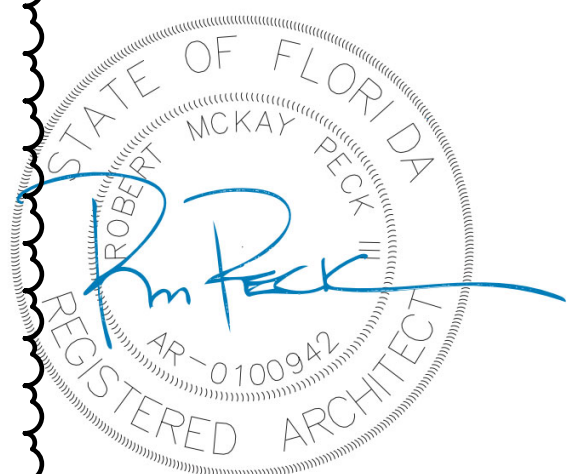

**FSU TURNBULL
CONFERENCE CENTER
RENOVATIONS**


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PROJECT PHASE
CONSTRUCTION DOCUMENTS

DATE	18 OCTOBER 2023	DRAWN BY	RMP
PROJECT NO	74000	CHECKED BY	RMP/BI

SHEET TITLE
**ENLARGED PLANS -
NEW WORK**

SHEET NO	A401	REV NO	1
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2 ENLARGED PLAN- SERVICE AREA
A401 1/4" = 1'-0"

WALL SYMBOL LEGEND

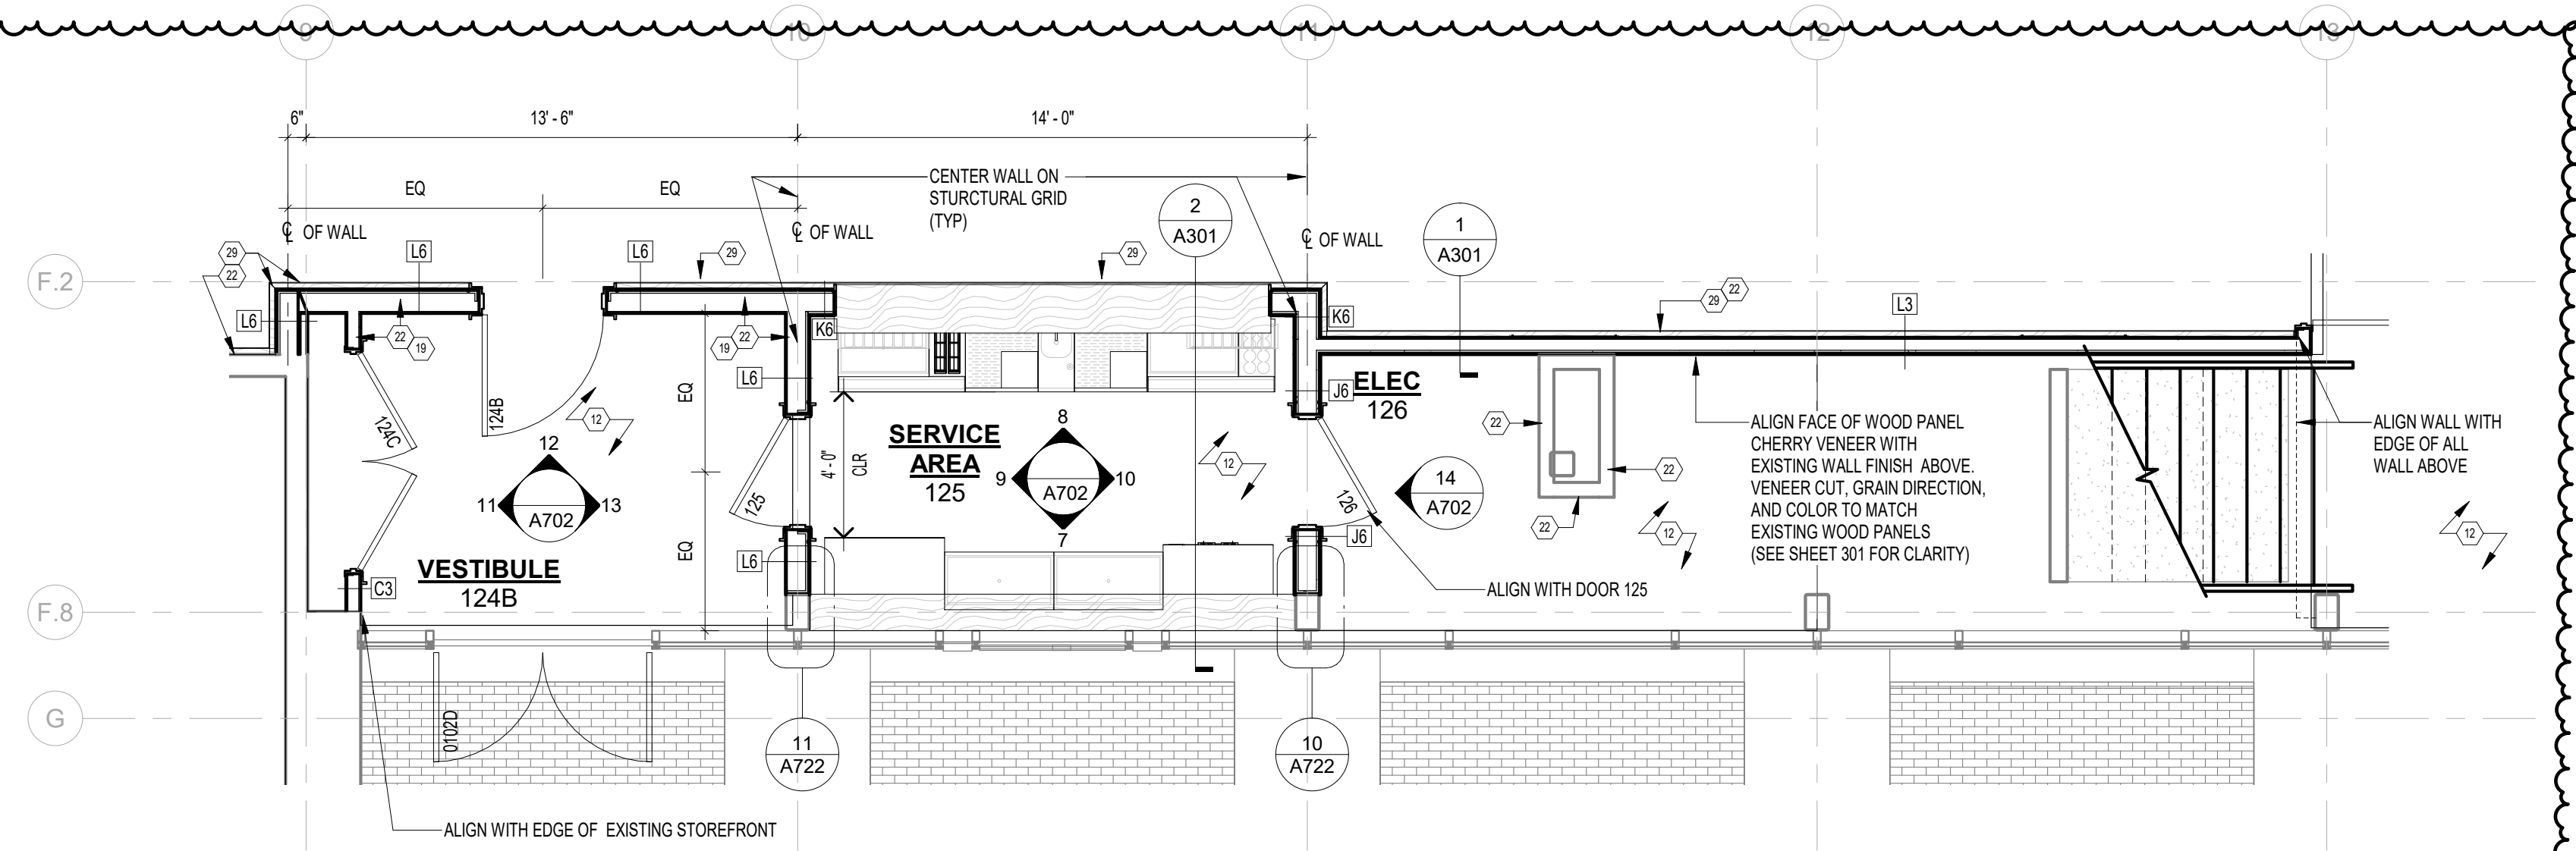	1 HOUR RATED
	2 HOUR RATED
	PARTIAL HEIGHT WALL
	FIRE EXTINGUISHER CABINET (FEC-1)
	FIRE EXTINGUISHER (FE-1)
	REFER TO PARTITION TYPE NOTES ON G102 REFER TO WALL TYPES ON SHEET G105


CONSTRUCTION NOTES: FLOOR PLAN

1. CONSTRUCT NEW STAGE STAIR PER SECTION	10. INSTALL NEW STAGE EDGE AND SKIRT PER ELEVATION SEE SHEET A701
2. CONSTRUCT NEW STAGE PER SECTION	11. EXISTING CARPET TO REMAIN.
3. INSTALL TRENCH DRAIN AT ELEVATOR ENTRANCE	12. INSTALL NEW FLOORING PER FINISH SCHEDULE.
4. CONSTRUCT NEW 0' GMS PARTIAL HEIGHT WALL. (SEE ELEVATIONS FOR HEIGHT OF WALL)	13. INSTALL EXISTING NEW A.V. RACKING AND EQUIPMENT (INSTALLED BY VIDEO WALL VENDOR). CONSTRUCTION MANAGER SHALL COORDINATE AS NECESSARY FOR SCHEDULED INSTALLATION.
5. INSTALL NEW HANDBICAP LIFT PER MANUFACTURER'S RECOMMENDATIONS AND PROCEDURES.	14. 4" X 4" STEEL POST ANCHOR TO EXISTING FLOOR SLAB.
6. INSTALL NEW 3/4" PLYWOOD SCREEN MOUNTING BOARD (CONFIRM REQUIRED DIMENSIONS WITH SCREEN MANUFACTURER).	15. INSTALL NEW HANDBICAP PER DETAIL
7. INSTALL NEW DOOR	16. INSTALL NEW STAGE BASEBOARD, WD-1
8. INSTALL NEW HIDDEN DOOR PER DETAIL	17. INSTALL NEW CEILING TRACK CURTAIN SYSTEM
9. NO WORK IN THIS ROOM	18. CONSTRUCT AND INSTALL NEW WOOD VIDEO SCREEN SHELF (PER DETAIL)

19. INSTALL NEW WD BASEBOARD TO MATCH EXISTING ADJACENT WD BASEBOARD	26. CONSTRUCT NEW GMS & GWB FULL HEIGHT COLUMN FURRING (EXTEND 6" ABOVE CEILING)
20. TERMINATE NEW BASEBOARD AT INSIDE CORNER	27. CONSTRUCT NEW WAINSCOT SEE APPLICABLE DETAILS AND ELEVATIONS FOR WAINSCOT HEIGHT
21. INSTALL NEW EXTERIOR DOOR	28. NEW DOUBLE SWINGING TRAFFIC DOOR WITH WOOD LAMINATE FINISH
22. PAINT EXISTING AND NEW PARTITIONS AS SCHEDULED. (TYP)	29. TERMINATE NEW WAINSCOTING AT THIS LOCATION
23. INSTALL NEW STOREFRONT DOOR AS SCHEDULED.	30. INFILL PATCH WALL AS REQUIRED TO APPLY NEW FINISH, AS SCHEDULED
24. INSTALL NEW CONCRETE SIDEWALK AND PROVIDE ADDITIONAL LANDSCAPING AS REQUIRED TO RESTORE TO ORIGINAL CONDITION	31. PROVIDE FRP WALL PANELS IN KITCHEN AREA (TYP) (SEE FINISH SCHEDULE)
25. INSTALL FREIGHT ELEVATOR PER MANUFACTURER'S RECOMMENDATIONS AND PROCEDURES.	32. REMOVE EXISTING GWB AND REPLACE WITH PLYWOOD AND FRP PANELS (SEE FINISH SCHEDULE AND DETAILS)
26. CONSTRUCT COURTYARD WALL. SEE SHEET A105 FOR DETAILS	33. INSTALL NEW RESINOUS FLOORING WITH CONT 4" BASE TURNED UP WALL (SEE FINISH SCHEDULE)
27. CONSTRUCT NEW ADDITION TO COURTYARD. MATCH EXISTING PAVEMENT AND CONCRETE LAYOUT. SEE SHEET A105 FOR DETAILS	34. CONTRACTOR SHALL CONFIRM EXISTING PARTITIONS ARE (1) HR RATED. IF NOT, PROVIDE 5/8" TYPE X" GWB ON GMS FRAMING AS REQUIRED TO ENSURE (1) HR RATING INTEGRITY AROUND STORAGE ROOMS 113 & 112, ELECTRICAL ROOM 120, AND MECHANICAL 211M

FLOOR PLAN GENERAL NOTES:

- REFER TO SHEET G105 FOR WALL TYPES AND ADDITIONAL INFORMATION. REFER TO SHEETS A111 AND A401, ENLARGED PLANS FOR INTERIOR WALL TYPES (TYP, UNO)
- PRIOR TO FRAMING BUILDING, EACH TRADE SHALL VERIFY PROPOSED BUILDING FRAMING IS ADEQUATE TO ALLOW INSTALLATION OF PROPOSED SYSTEMS.

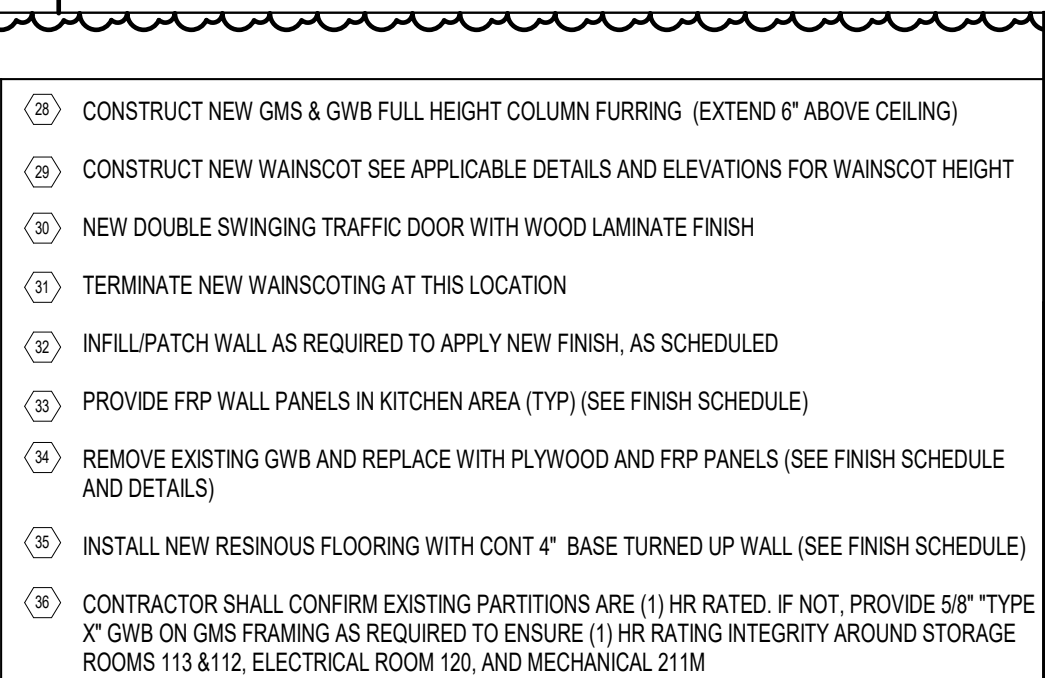


PROJECT PHASE
CONSTRUCTION DOCUMENTS

DATE	18 OCTOBER 2023	DRAWN BY	RMP
PROJECT NO	74000	CHECKED BY	RMP/BI

SHEET TITLE
**ENLARGED PLANS -
NEW WORK**

SHEET NO	A401	REV NO	1
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Enlarged Restroom Plan - RM
3/4" = 1'-0"
NORTH

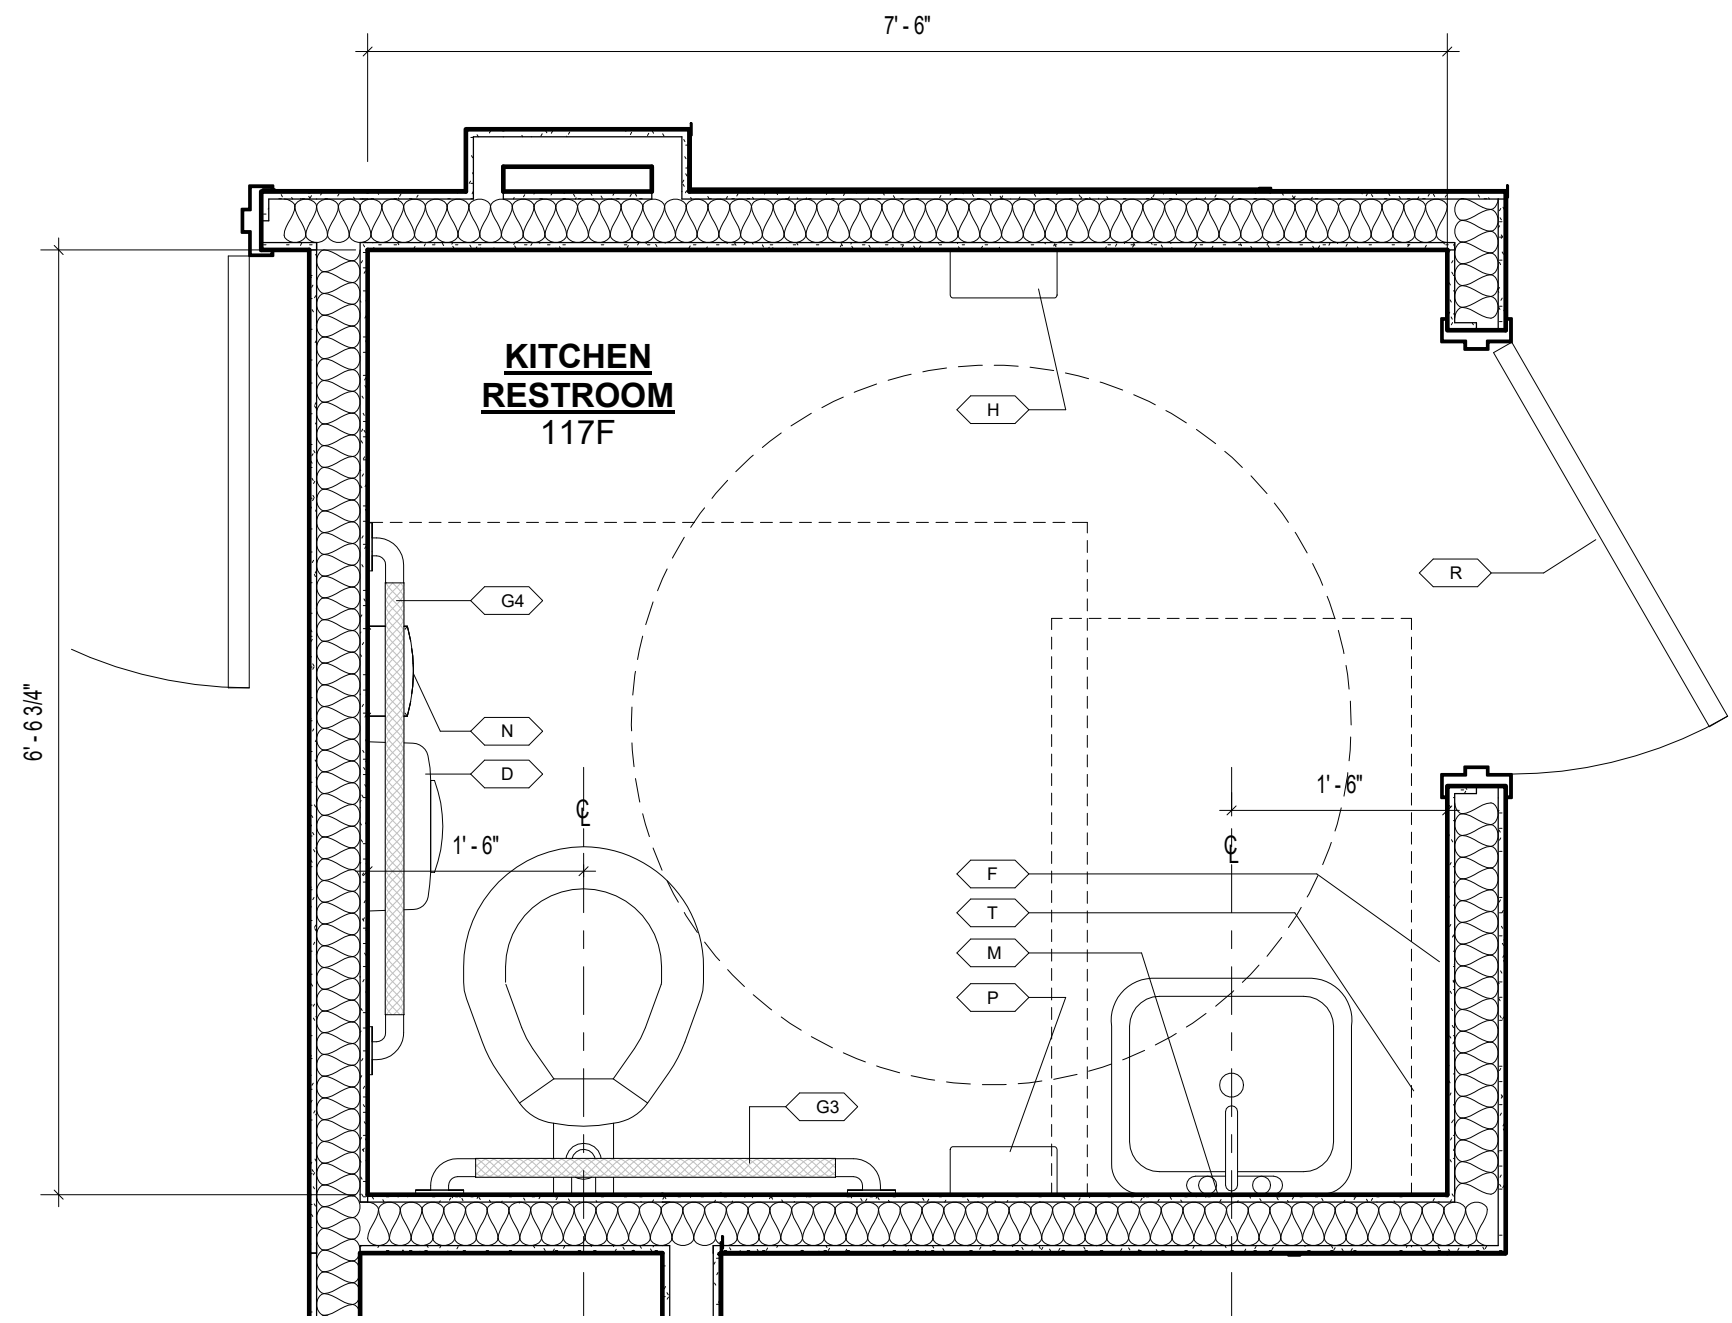GENERAL NOTES:

- RE: TOILET ELEVATIONS
1. TYPICAL ELEVATIONS SHOW LOCATION AND MOUNTING HEIGHTS OF TOILET FIXTURES, AND ACCESSORIES.
 2. DIMENSIONS LOCATING TOILET ACCESSORIES, ARE TYPICAL, UNO.

GENERAL NOTES:

- RE: TOILET PLANS
1. ENLARGED TOILET PLANS SHOW LOCATION OF TOILET FIXTURES, ACCESSORIES, AND NOTES. SEE 1/4" FLOOR PLANS FOR INFORMATION REGARDING WALL TYPES, CONSTRUCTION NOTES, AND ROOM FINISHES. DIMENSIONS LOCATING TOILET ACCESSORIES, SCREENS, ARE TYPICAL, UNO.
 2. SET FLOOR DRAINS IN NEW SLABS AT -0'-1" AND SLOPE FLOOR TO DRAIN, COORDINATE WITH STRUCTURAL AND PLUMBING.
 3. DIMENSIONS SHOWN ON THIS SHEET ARE TO FINISH FACE, UNO.



ARCHITECTURE
PLANNING INTERIORS
GRAPHICS


ELLIOTT MARSHALL BINES P.A. (EMI architects)
251 E. 7TH AVENUE TALLAHASSEE FL 32303
(850) 222-7442
www.emiarch.com
LICENSE #A-AC-006409 IB-0001153

TOILET ACCESSORIES SCHEDULE


MARK	ITEM	MOUNTING HEIGHT
A		
B		
C		
D	SURFACE MOUNTED DOUBLE ROLL TOILET TISSUE DISPENSER	29" AFF TO TOP OF UNIT
E		
F	SURFACE MOUNTED FOAM SOAP DISPENSER	40" AFF TO BOTTOM OF UNIT
G3	1 1/2" Ø GRAB BAR x 36" LONG	33" AFF TO CENTERLINE
G4	1 1/2" Ø GRAB BAR x 42" LONG	33" AFF TO CENTERLINE
H	HAND DRYER	40" AFF TO TOWEL ACCESS
J		
K		
L		
M	MIRROR - 18" W x 36" H	40" AFF TO BOTTOM OF REFLECTIVE SURFACE
N	SURFACE MOUNTED SANITARY NAPKIN DISPOSAL	31" AFF TO TOP OF UNIT
O		
P	PAPER TOWEL DISPENSER	40" AFF TO TOWEL ACCESS
Q		
R	ROBE HOOK	
S		
T	TRASH BIN	
U		
V		
W		
X		
Y		
Z		

NOTE:
11" x 17" SHEETS ARE PLOTTED AT 1/2
THE SCALE NOTED ON THESE DRAWINGS


- NOTES:
1. INSULATE EXPOSED HOT WATER PIPING AT HANDICAP LOCATIONS.
 2. LAVATORIES SHALL BE MOUNTED WITH THE BOTTOM OF LAVATORY APRON AT 2'-5" AFF.
 3. MIRRORS SHALL BE CENTERED OVER SINKS, UNO.
 4. ACCESSIBLE TOILETS SHALL MEET REQUIREMENTS OF THE FLORIDA BUILDING CODE 2017 EDITION.
 5. SHOULD ANY DISCREPANCY BE FOUND BETWEEN ITEMS NOTED IN THE CONTRACT DOCUMENTS AND APPLICABLE CODES, THE CONTRACTOR SHALL BRING ITEMS TO THE ATTENTION OF THE ARCHITECT PRIOR TO ORDERING, FABRICATING, OR INSTALLING TOILET FIXTURES OR ACCESSORIES.
 6. PROVIDE COAT HOOKS / ROBE HOOK ON THE INSIDE OF DOORS, TYP. OF TOILET COMPARTMENTS OR ON WALL WHERE INDICATED.
 7. IF A CONFLICT EXISTS BETWEEN ANY TOILET FIXTURE AND A TOILET ACCESSORY, NOTIFY THE ARCHITECT PRIOR TO INSTALLATION FOR DIRECTION.
 8. PROVIDE WOOD BLOCKING FOR SUPPORT OF FUTURE ANCHORAGE OF GRAB BAR LOADS.

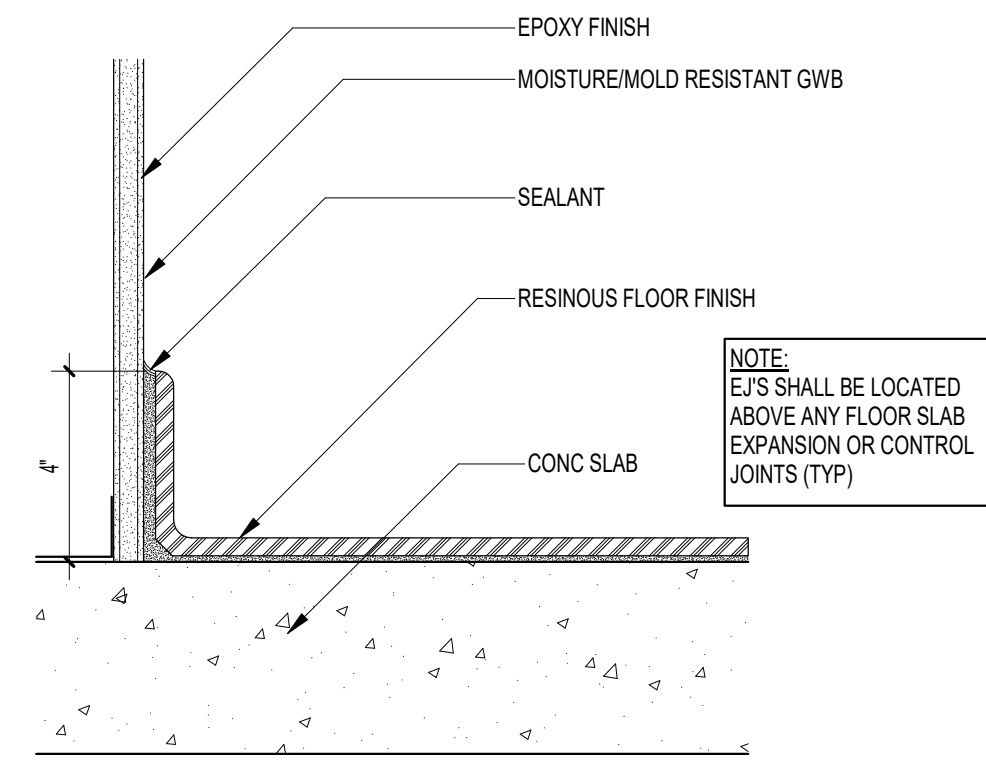


6 TILE
A422 3" = 1'-0"

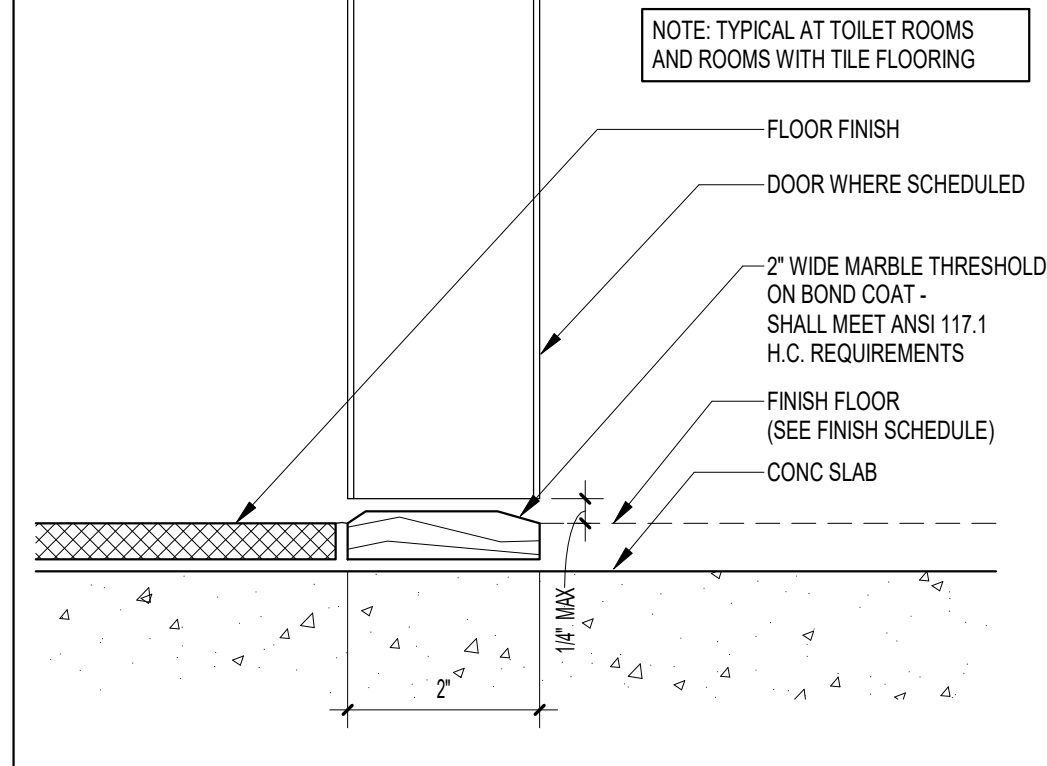


7 TYP THRESHOLD
A422 6" = 1'-0"

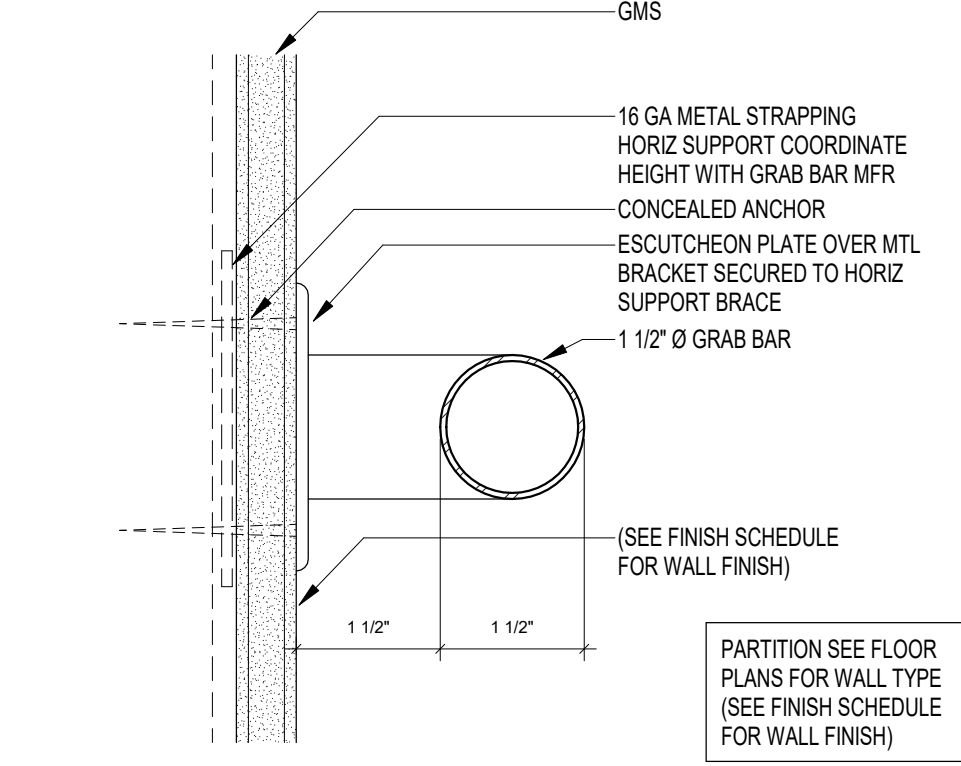

1 GRAB BAR
A422 6" = 1'-0"

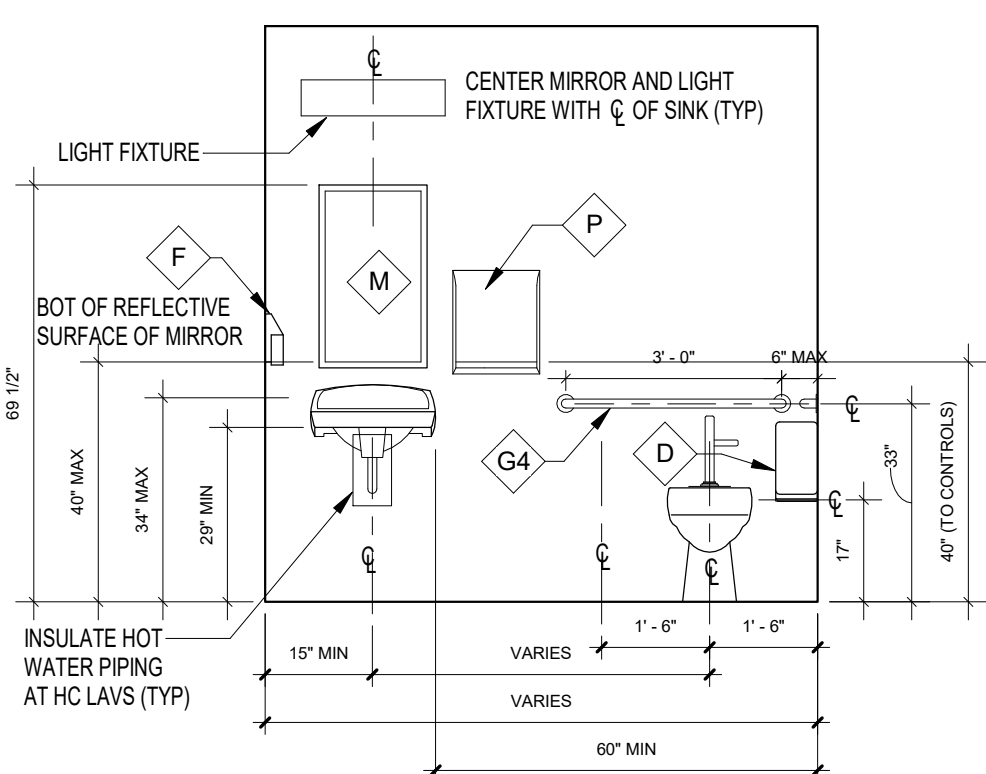

TYPICAL TOILET ELEVATIONS
3/8" = 1'-0"

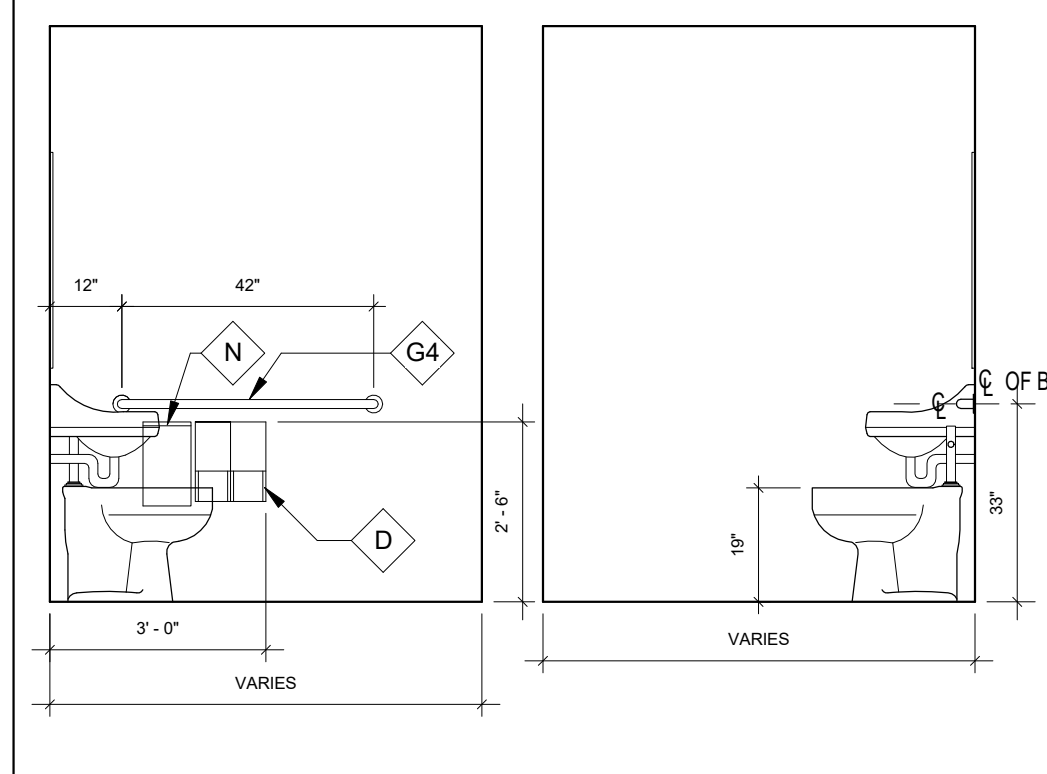

NOTE:
TYPICAL ELEVATIONS SHOWN FOR CLARITY
OF FIXTURE AND ACCESSORY LOCATIONS AND
HEIGHTS. REFER TO PLANS FOR LOCATIONS

**FSU TURNBULL
CONFERENCE CENTER
RENOVATIONS**

REV DATE DESCRIPTION

PROJECT PHASE
CONSTRUCTION DOCUMENTS

DATE
18 OCTOBER 2023

DRAWN BY
RMP/BI

PROJECT NO
74000


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SHEET TITLE

**ENLARGED TOILET
PLANS, SCHEDULE,
ELEVATIONS & DETAILS**


SHEET NO
A422

REV NO

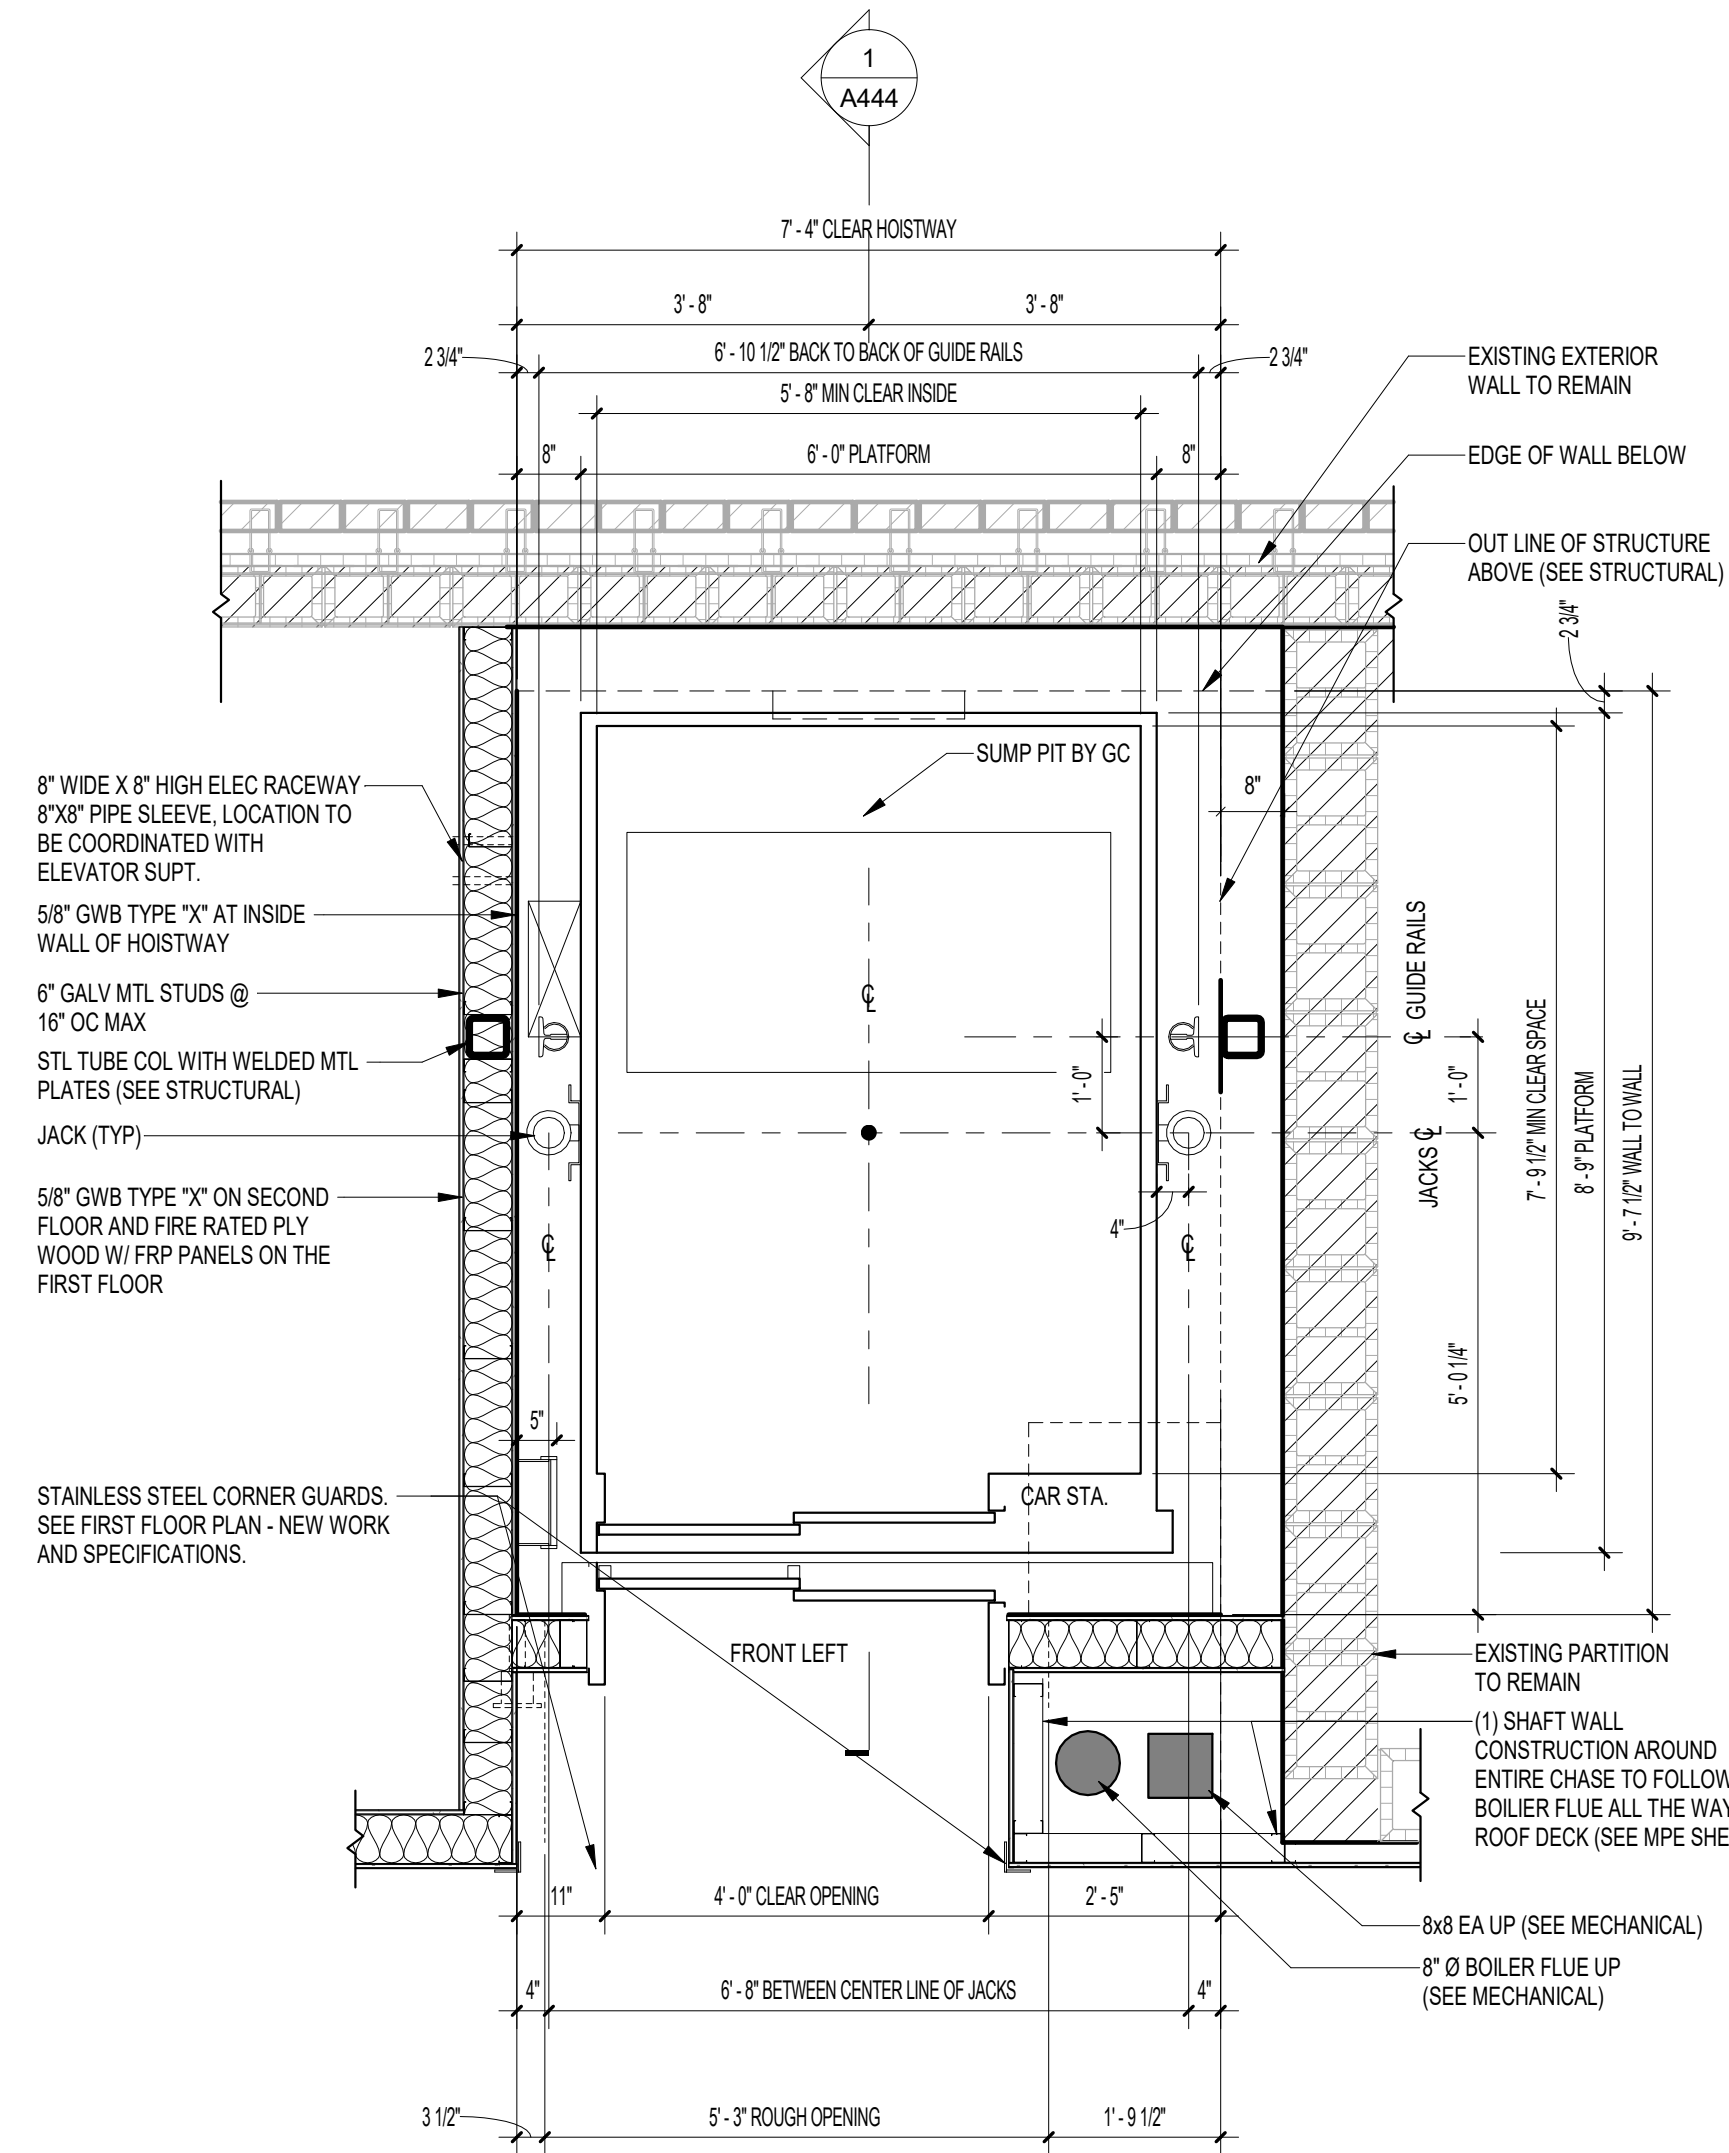

1
A443 1/2" = 1'-0"


FREIGHT ELEVATOR HOISTWAY PLAN

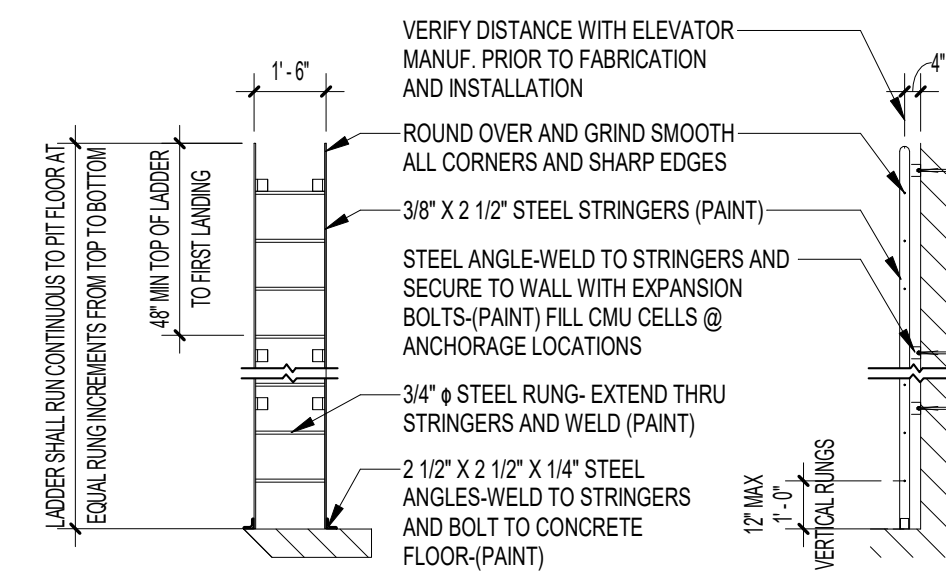

- NOTE:
1. TYP AT ELEVATOR PIT- VERIFY EXACT LOCATION WITH ELEVATOR MFR
 2. LADDER SHALL BE CONSTRUCTED TO WITHSTAND 200# AT ANY POINT
 3. WATERPROOFING ON FOUR (4) SIDES OF PIT- EXCLUDING BOTTOM (TYP.)
 4. SEAL BETWEEN FASTENERS, BRACKETS AND WALLS WITH TREMCO DYMOMIC 100 OR EQUAL
 5. PIT LADDER AND SILL ANGLES BY ELEVATOR MANUFACTURER

2
A443 1/4" = 1'-0"


PIT LADDER

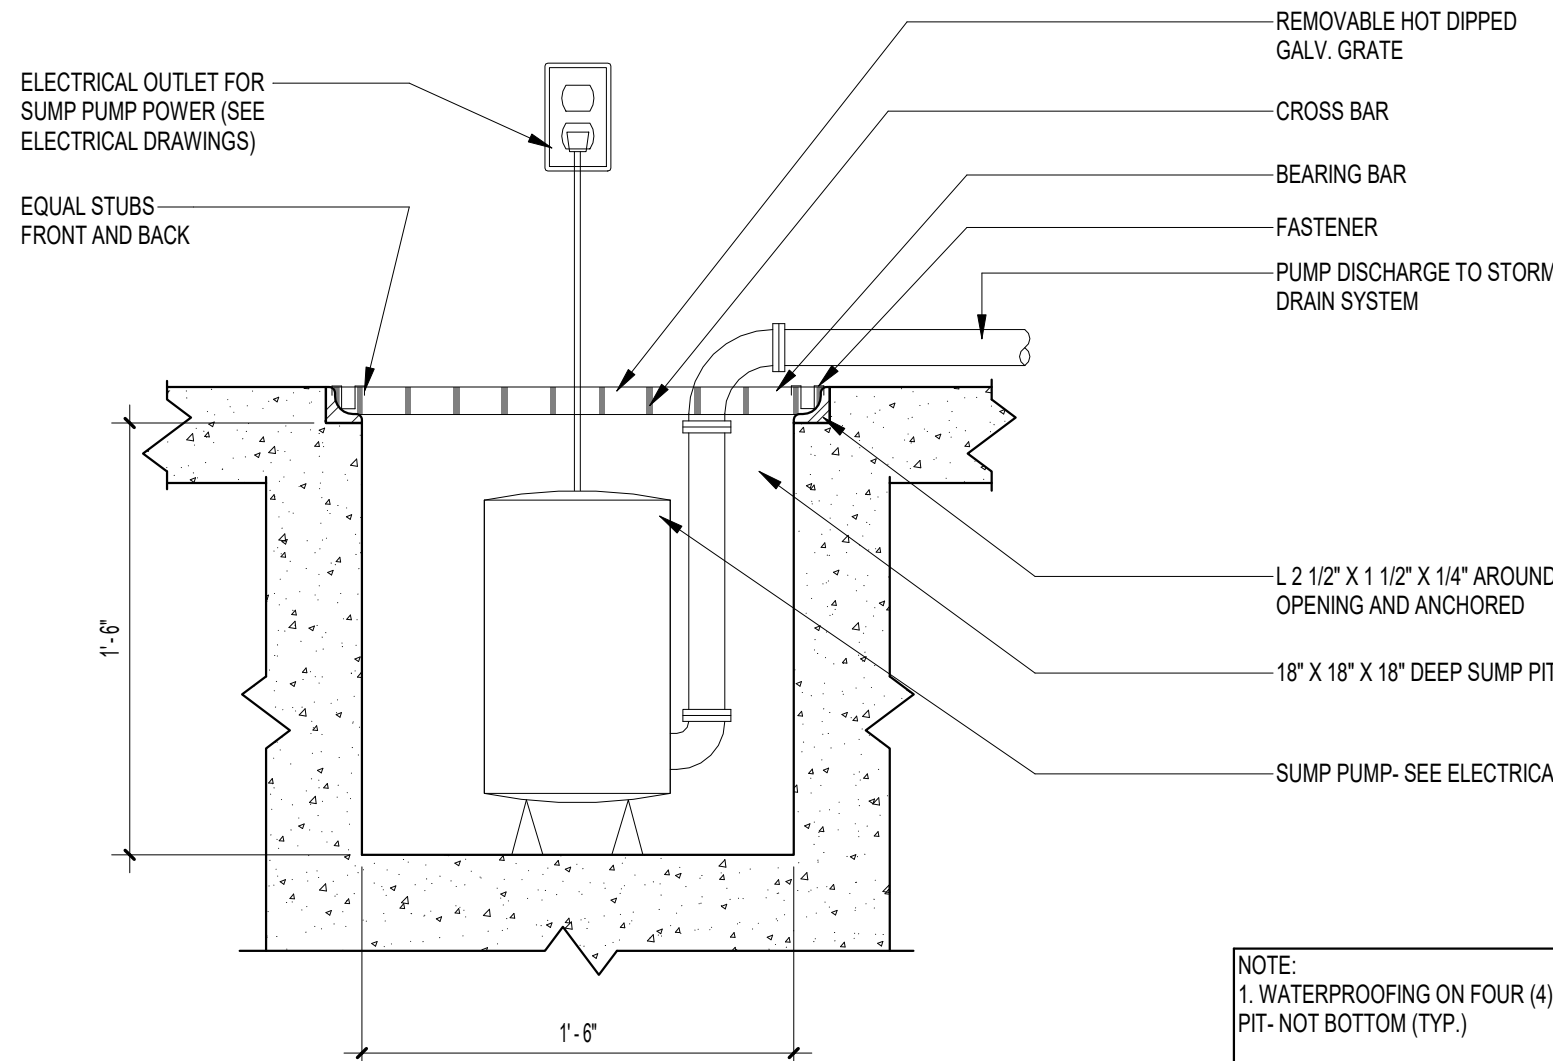


- NOTE:
1. WATERPROOFING ON FOUR (4) SIDES OF PIT- NOT BOTTOM (TYP.)
 2. CONFIRM EXACT LOCATION OF SUMP PIT WITH ELEVATOR MANUFACTURER PRIOR TO FORMING AND POURING OPERATIONS.

3
A443 1 1/2" = 1'-0"


SUMP PIT

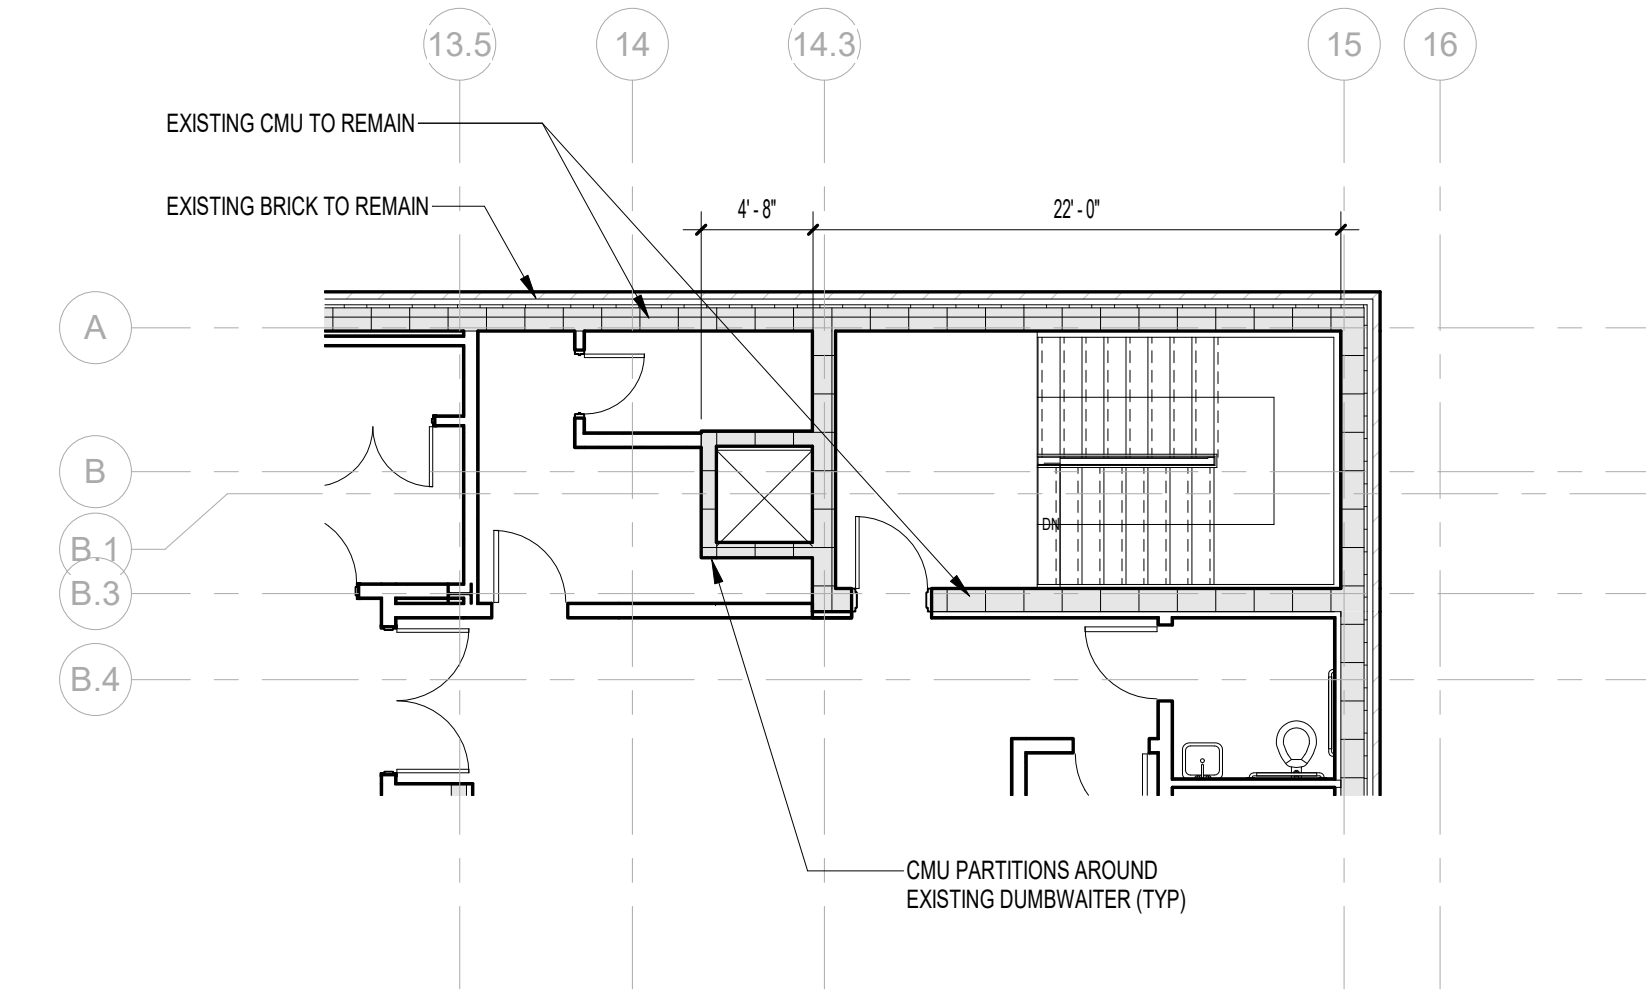

SECOND FLOOR PLAN- EXISTING
1/8" = 1'-0"
NORTH

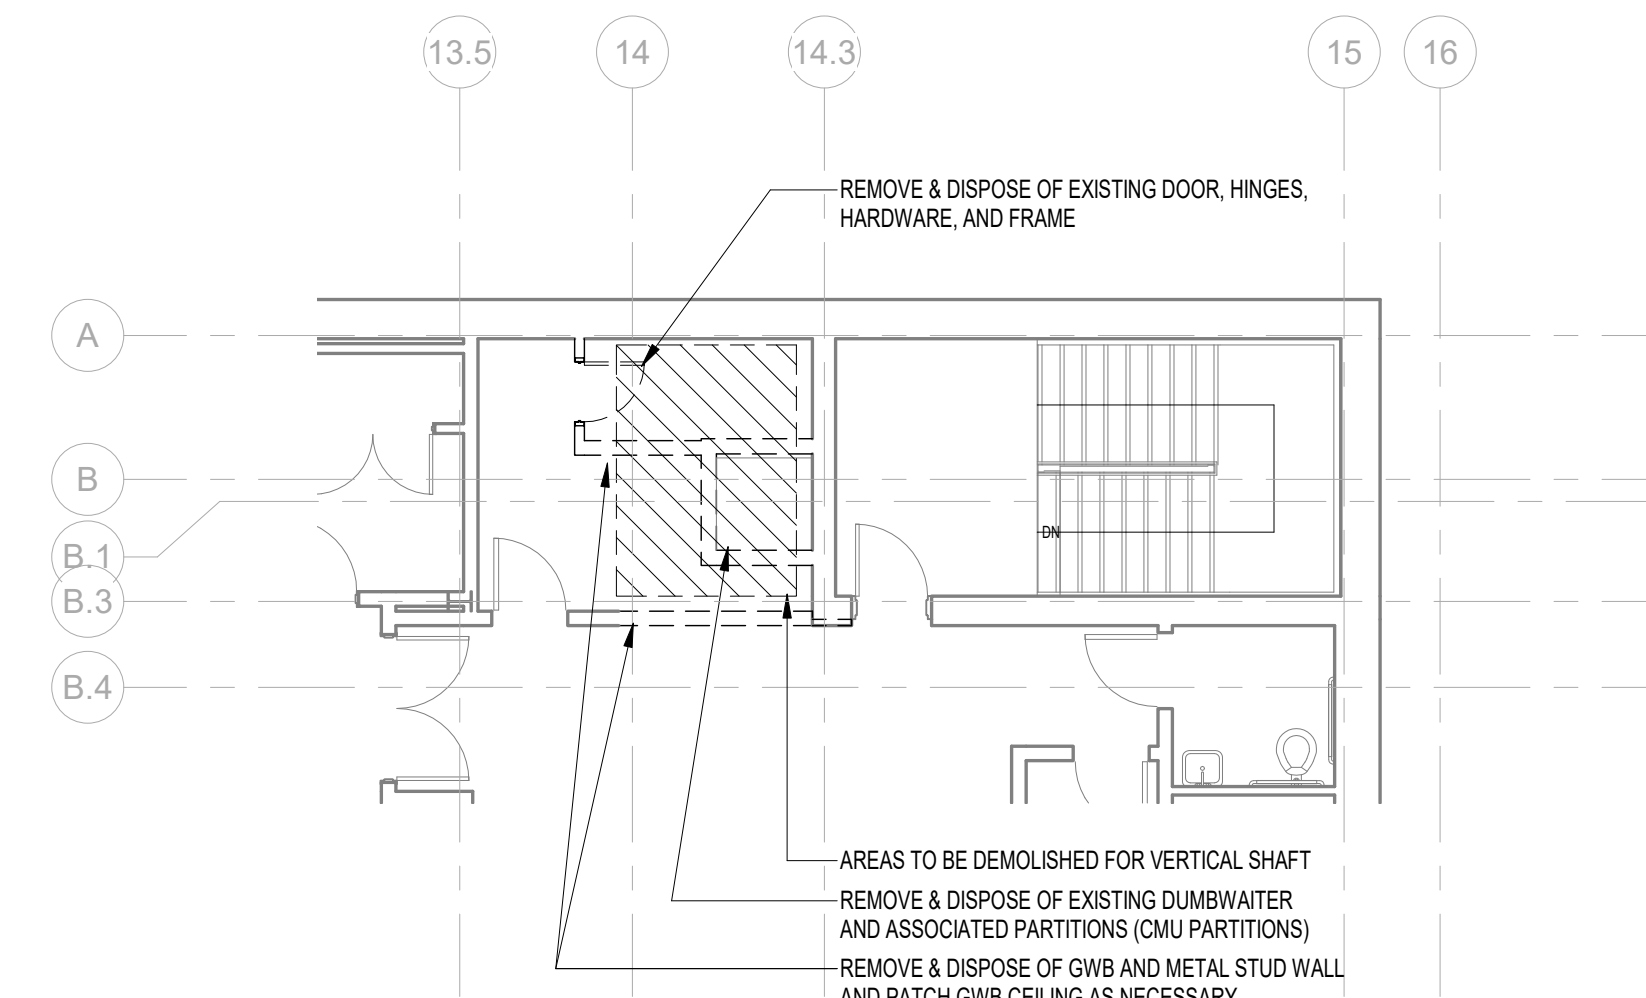

SECOND FLOOR PLAN- DEMOLITION
1/8" = 1'-0"
NORTH

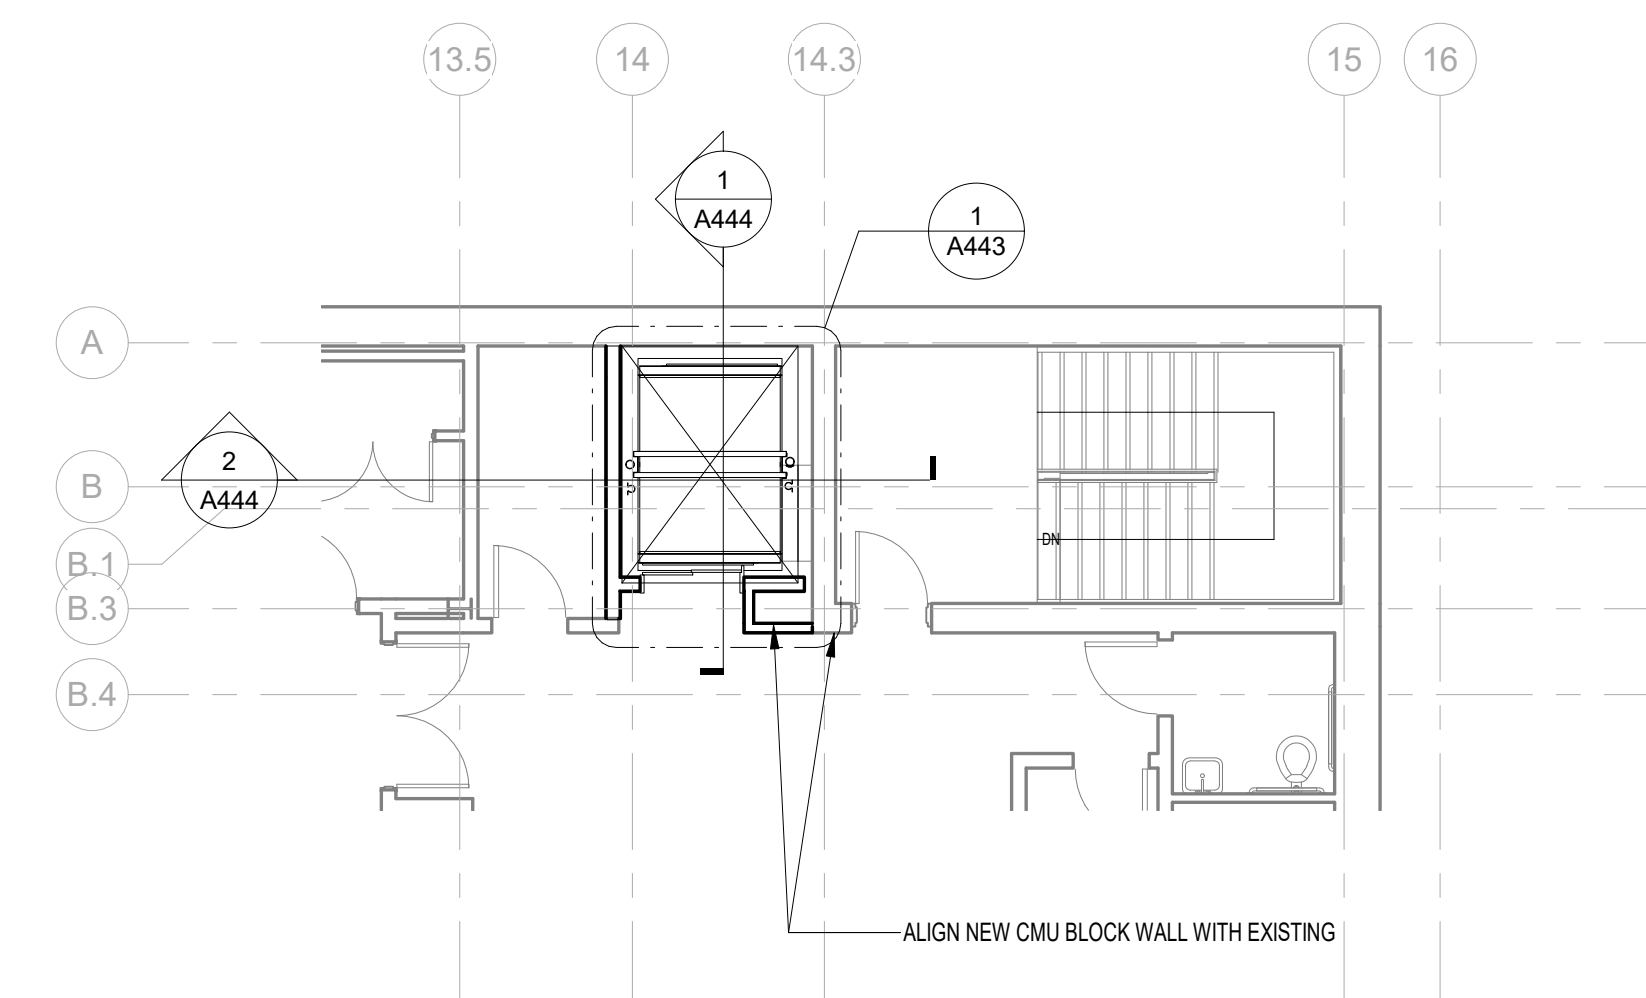

SECOND FLOOR PLAN- NEW CONSTRUCTION
1/8" = 1'-0"
NORTH

NOTE:
11' x 17" SHEETS ARE PLOTTED AT 1/2 THE SCALE NOTED ON THESE DRAWINGS

FSU TURNBULL
CONFERENCE CENTER
RENOVATIONS

REV	DATE	DESCRIPTION

PROJECT PHASE
CONSTRUCTION DOCUMENTS

DATE 18 OCTOBER 2023	DRAWN BY RMP/BI
PROJECT NO 74000	CHECKED BY

SHEET TITLE
**FREIGHT ELEVATOR
SECTION & DETAILS W/
2ND FLOOR PLAN DEMO**

SHEET NO A443	REV NO
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NOTE:
11" x 17" SHEETS ARE PLOTTED AT 1/2
THE SCALE NOTED ON THESE DRAWINGS

**FSU TURNBULL
CONFERENCE CENTER
RENOVATIONS**


REV	DATE	DESCRIPTION

PROJECT PHASE
CONSTRUCTION DOCUMENTS


DATE 18 OCTOBER 2023	DRAWN BY RMP
PROJECT NO 74000	CHECKED BY RMP/BI

SHEET TITLE
**FREIGHT ELEVATOR
SECTIONS**


SHEET NO A444	REV NO
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1 ELEVATOR HOISTWAY SECTION
A444 1/4" = 1'-0"

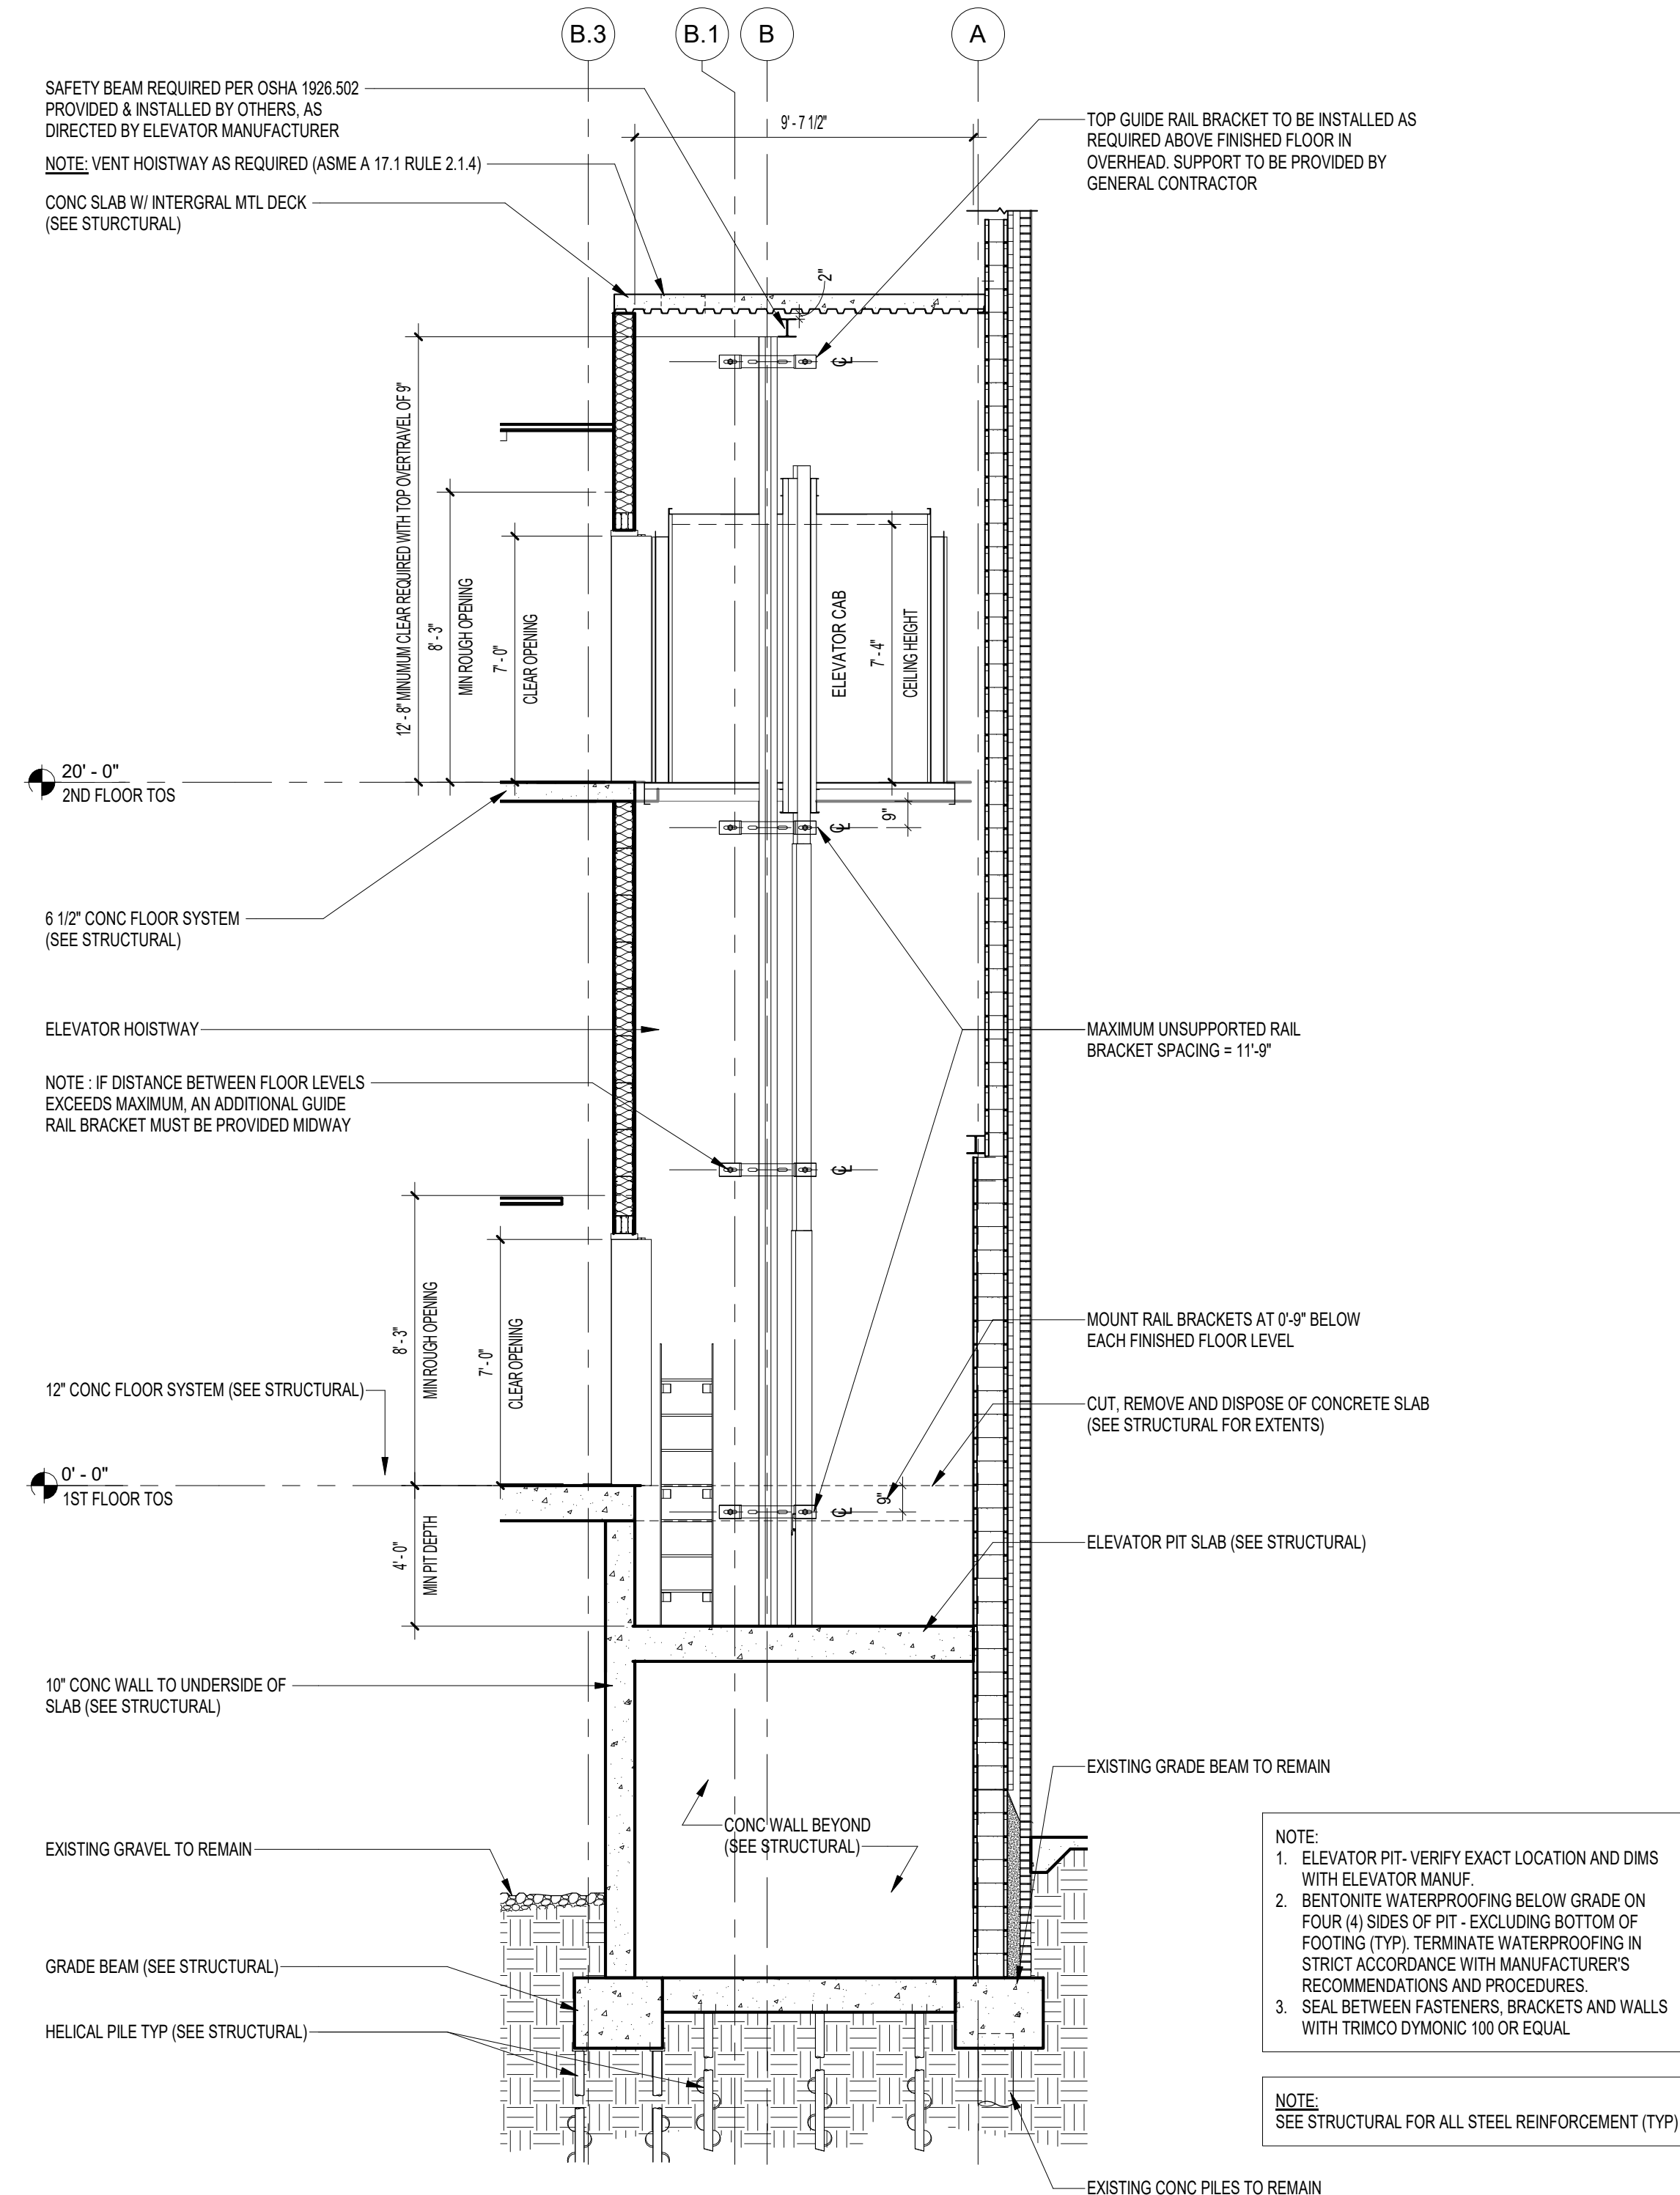


2 ELEVATOR HOISTWAY CROSS SECTION
A444 1/4" = 1'-0"

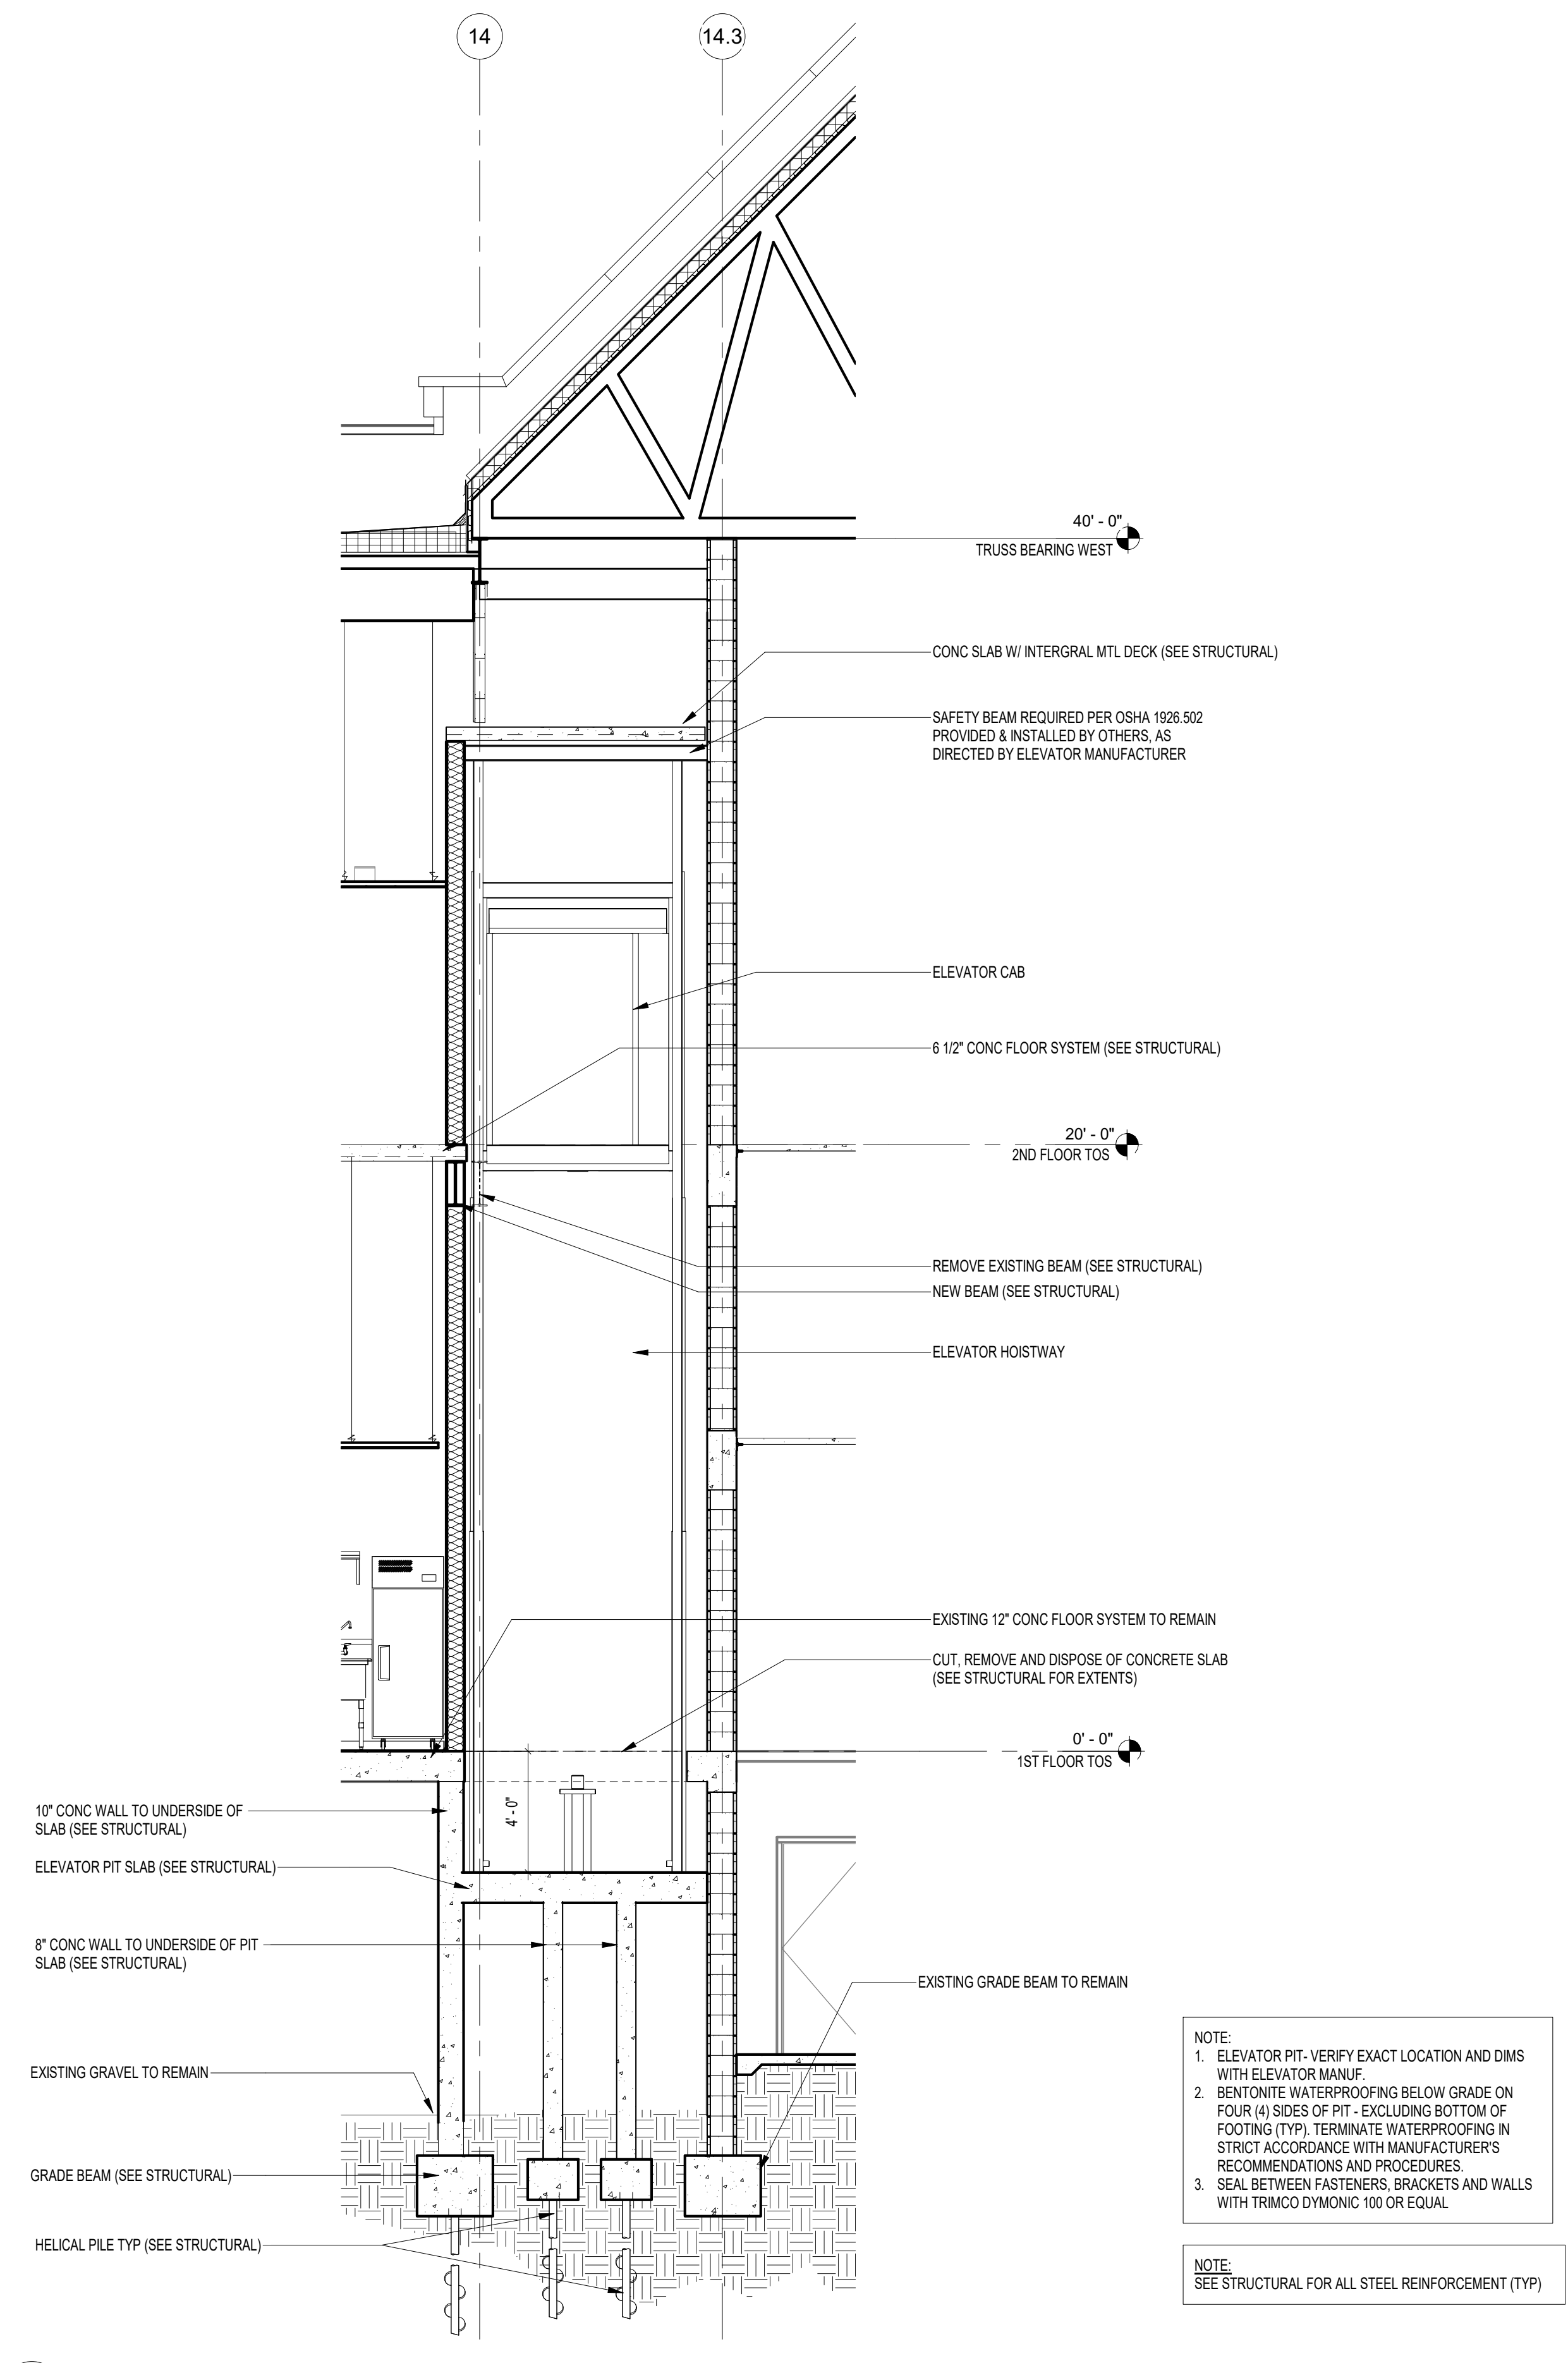

6 WASTE STACK
A511 3" = 1'-0"

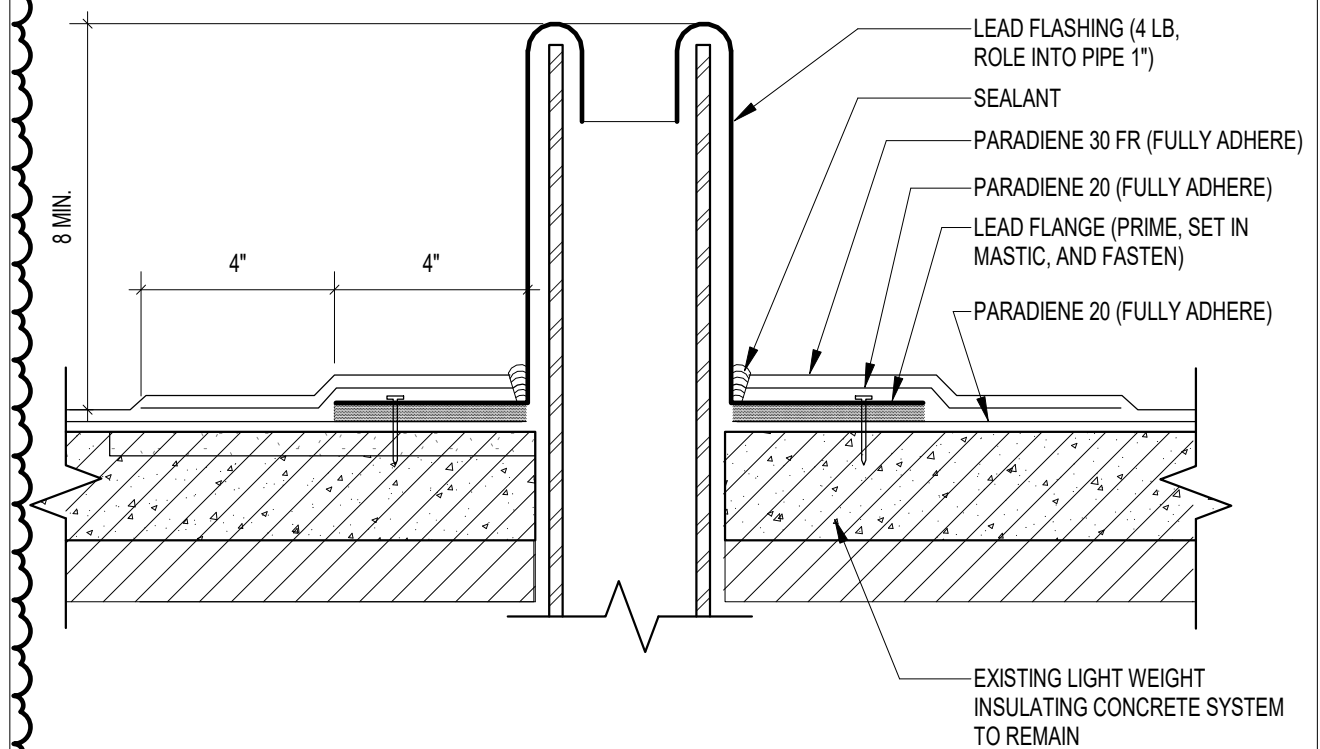
NOTE:
1. ROOF INSULATION SYSTEM IS SCHEMATICALLY SHOWN. INSULATION THICKNESS WILL VARY BASED ON LOCATION OF PENETRATION.
2. CONTRACTOR SHALL CONFIRM EXISTING ROOF MEMBRANE AND PROVIDE COMPATIBLE FLASHINGS AS RECOMMENDED BY ROOFING MANUFACTURER FOR INTENDED APPLICATION (TYP)

NOTE:
11" x 17" SHEETS ARE PLOTTED AT 1/2 THE SCALE NOTED ON THESE DRAWINGS

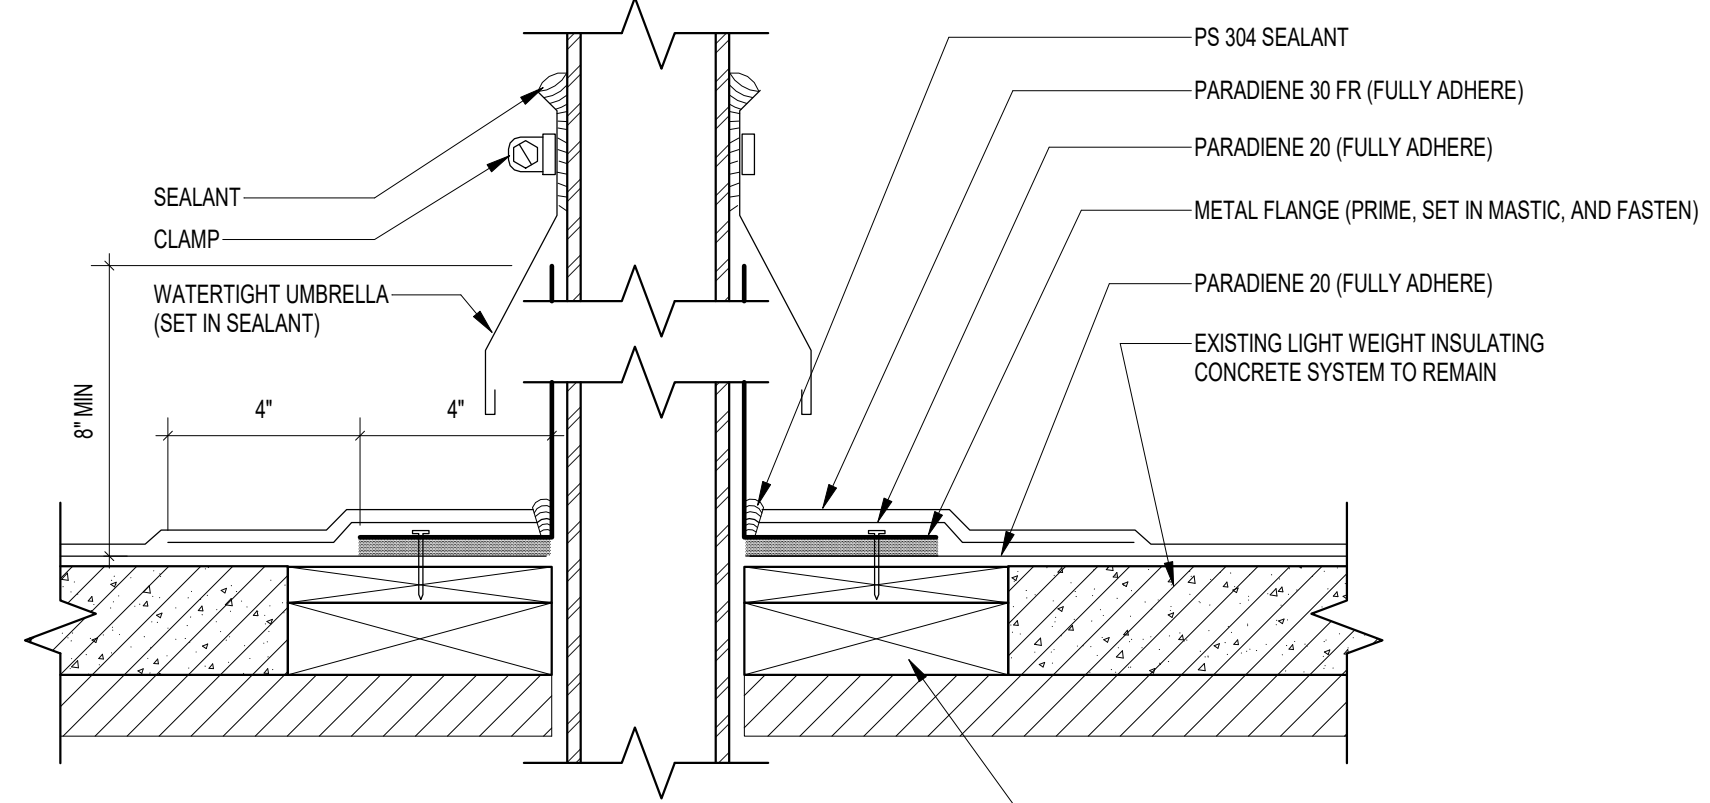


3 EQUIPMENT FRAMING
A511 3" = 1'-0"

NOTE:
1. ROOF INSULATION SYSTEM IS SCHEMATICALLY SHOWN. INSULATION THICKNESS WILL VARY BASED ON LOCATION OF PENETRATION.
2. CONTRACTOR SHALL CONFIRM EXISTING ROOF MEMBRANE AND PROVIDE COMPATIBLE FLASHINGS AS RECOMMENDED BY ROOFING MANUFACTURER FOR INTENDED APPLICATION (TYP)

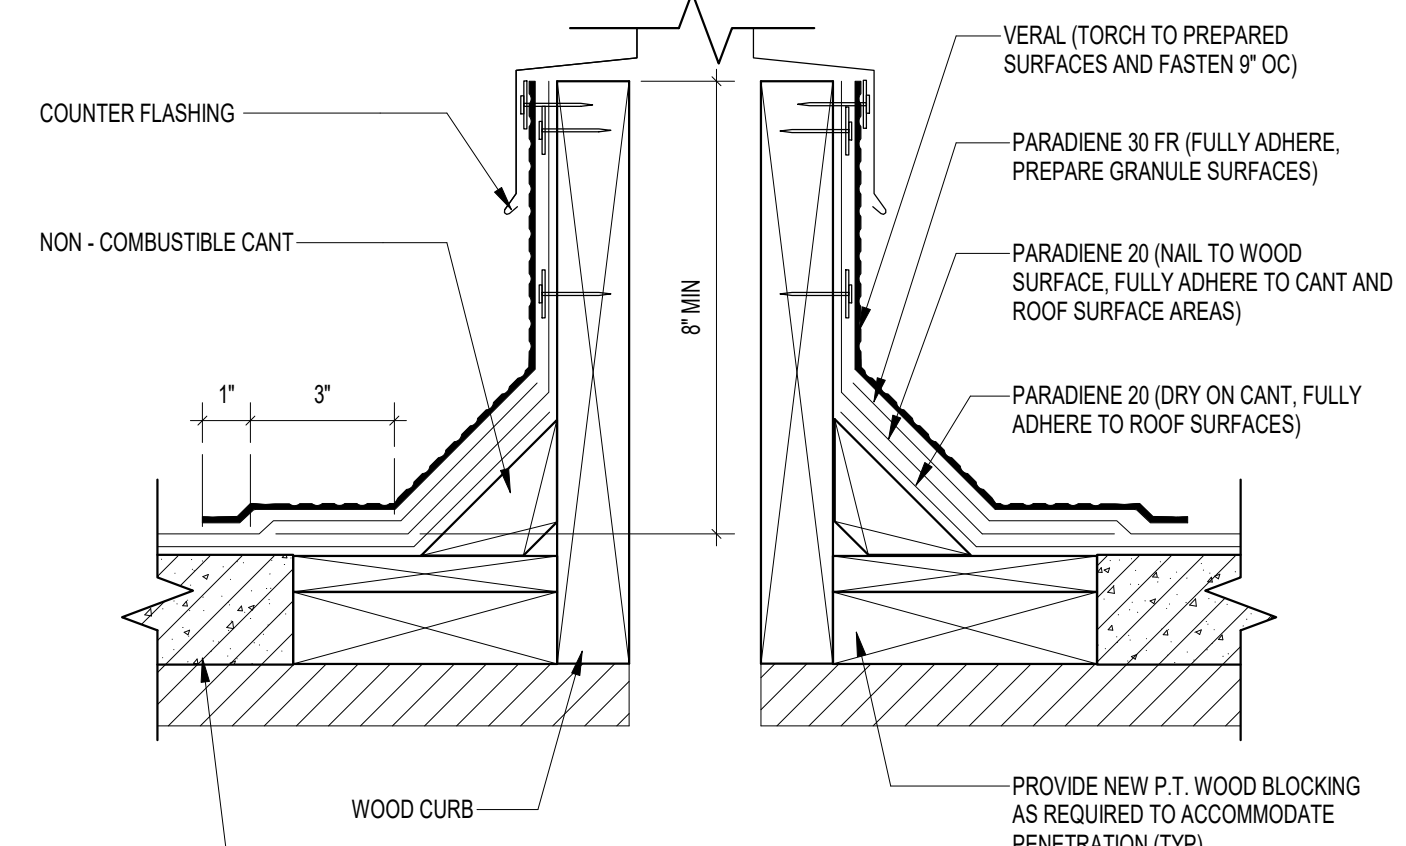


4 CURB, TYP
A511 3" = 1'-0"

NOTE:
1. ROOF INSULATION SYSTEM IS SCHEMATICALLY SHOWN. INSULATION THICKNESS WILL VARY BASED ON LOCATION OF PENETRATION.
2. CONTRACTOR SHALL CONFIRM EXISTING ROOF MEMBRANE AND PROVIDE COMPATIBLE FLASHINGS AS RECOMMENDED BY ROOFING MANUFACTURER FOR INTENDED APPLICATION (TYP)

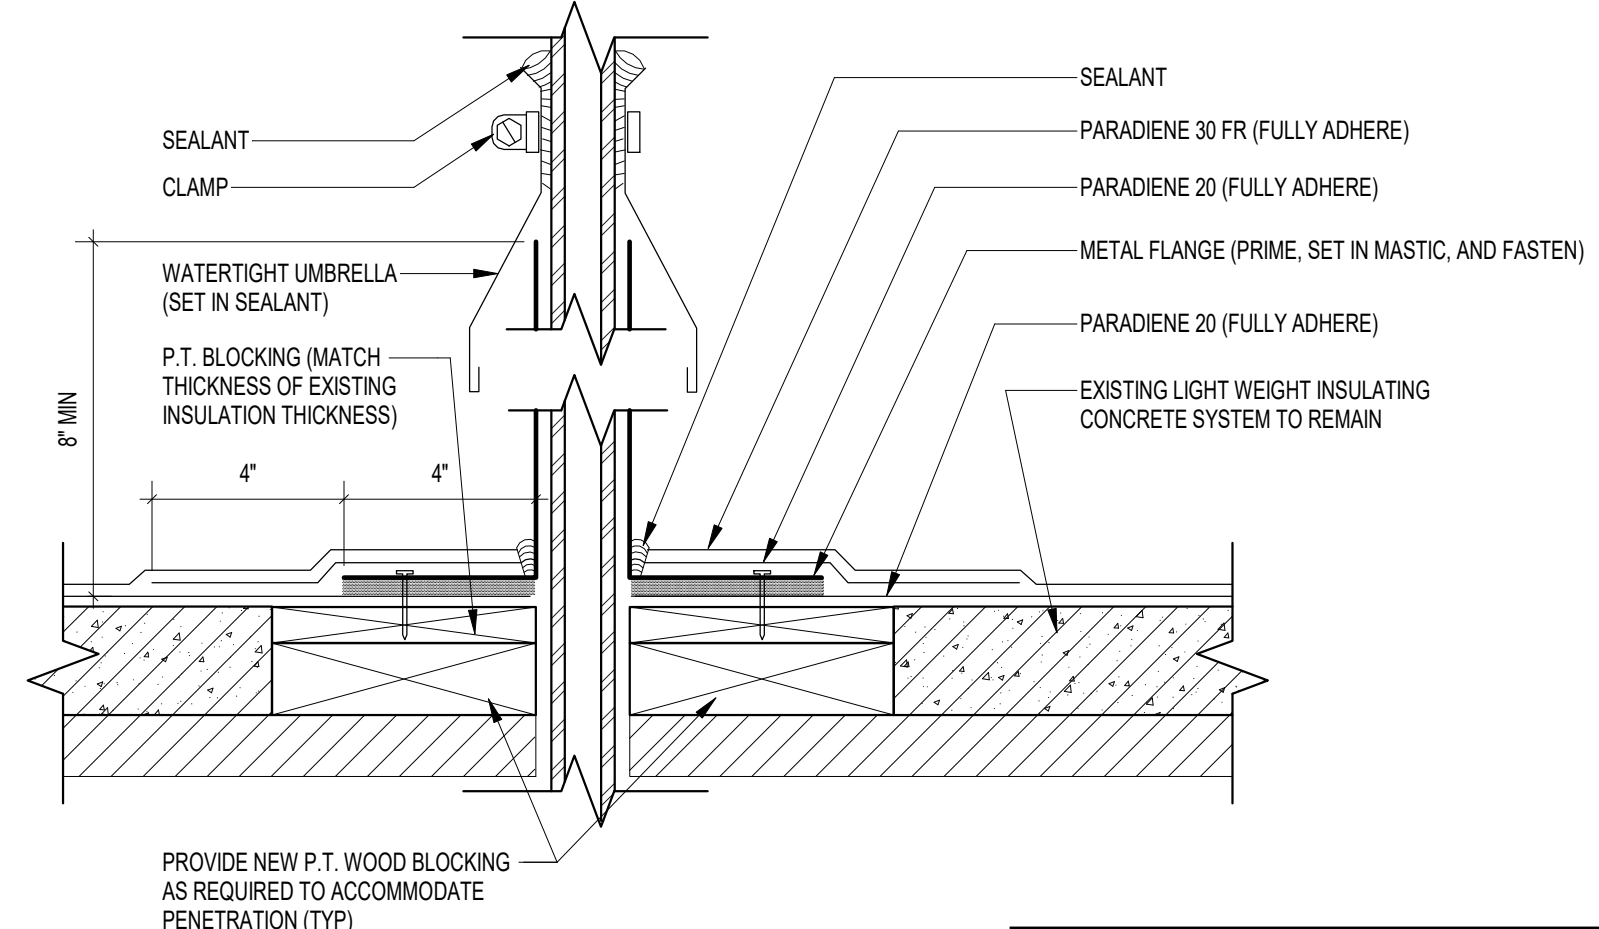

5 CONDUIT / SMALL PIPE PENETRATION
A511 3" = 1'-0"

NOTE:
1. ROOF INSULATION SYSTEM IS SCHEMATICALLY SHOWN. INSULATION THICKNESS WILL VARY BASED ON LOCATION OF PENETRATION.
2. CONTRACTOR SHALL CONFIRM EXISTING ROOF MEMBRANE AND PROVIDE COMPATIBLE FLASHINGS AS RECOMMENDED BY ROOFING MANUFACTURER FOR INTENDED APPLICATION (TYP)

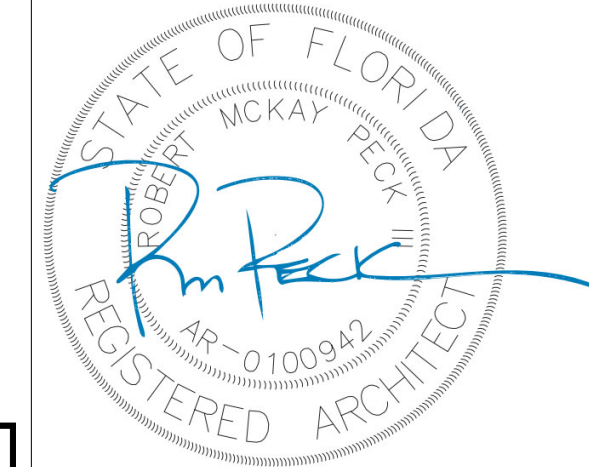

**FSU TURNBULL
CONFERENCE CENTER
RENOVATIONS**


REV	DATE	DESCRIPTION
1	04.17.24	FSU PERMIT

PROJECT PHASE
CONSTRUCTION DOCUMENTS

DATE	18 OCTOBER 2023	DRAWN BY	BI/RMP
PROJECT NO	74000	CHECKED BY	RMP/BI


**SECTIONS & ROOF
DETAILS**

SHEET NO	A511	REV NO	
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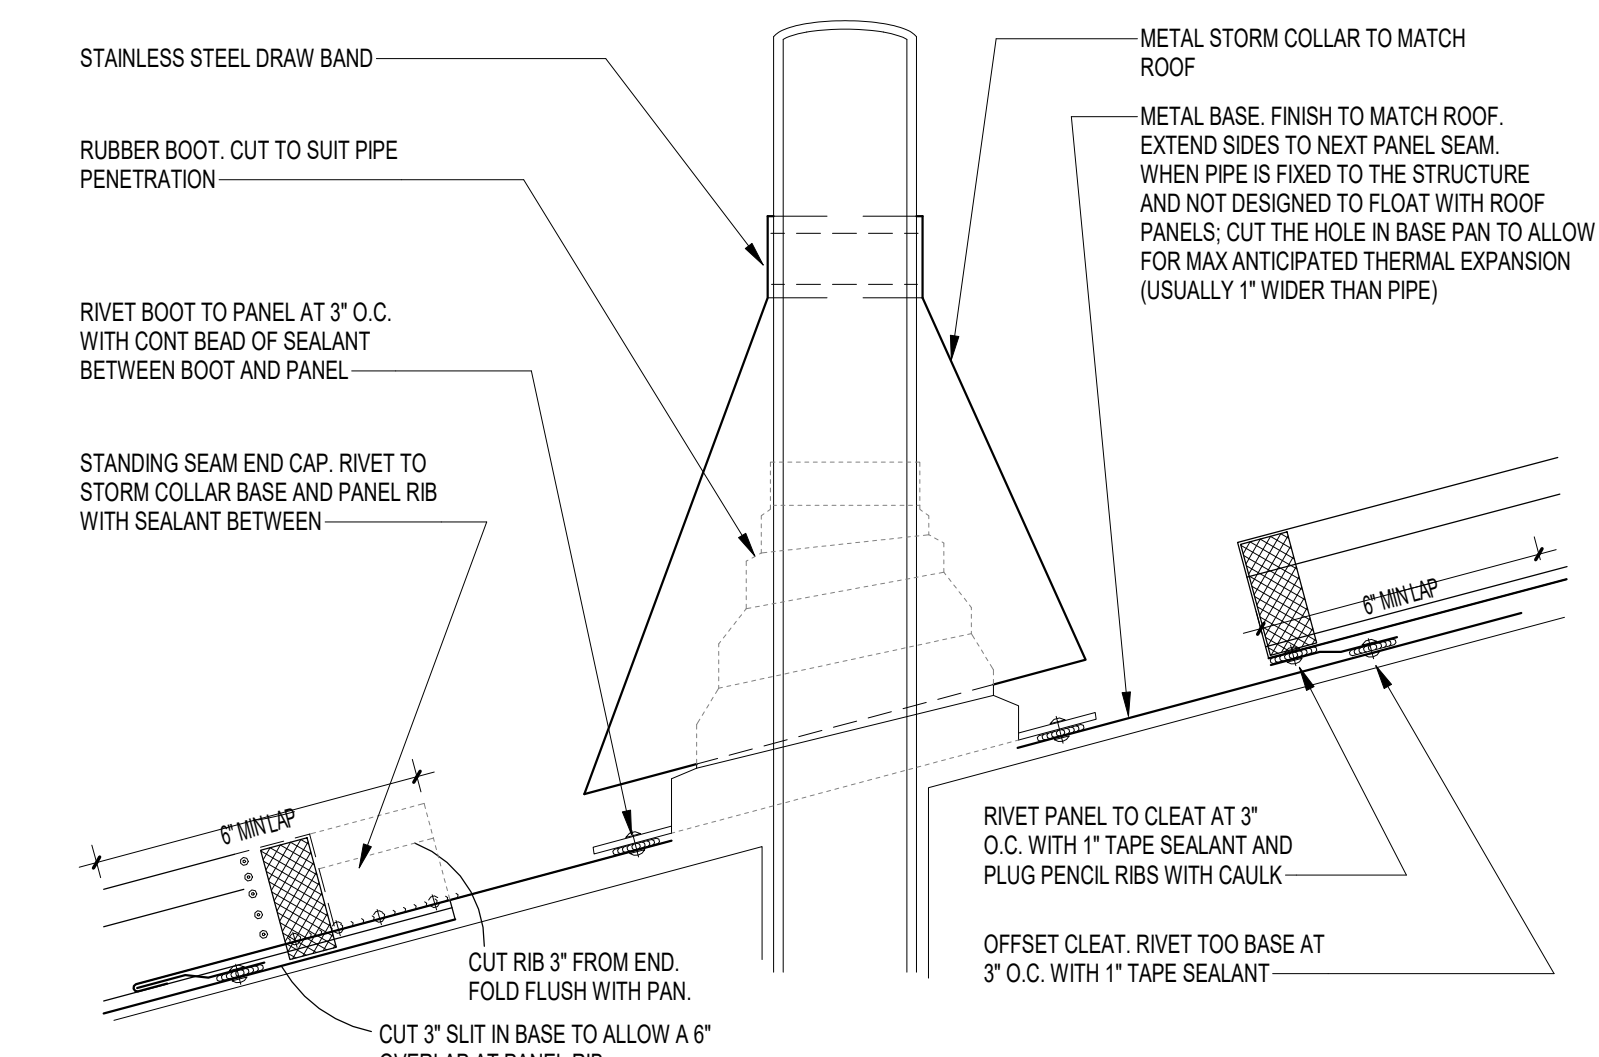
7 TYP ROOF CURB DETAIL
A511

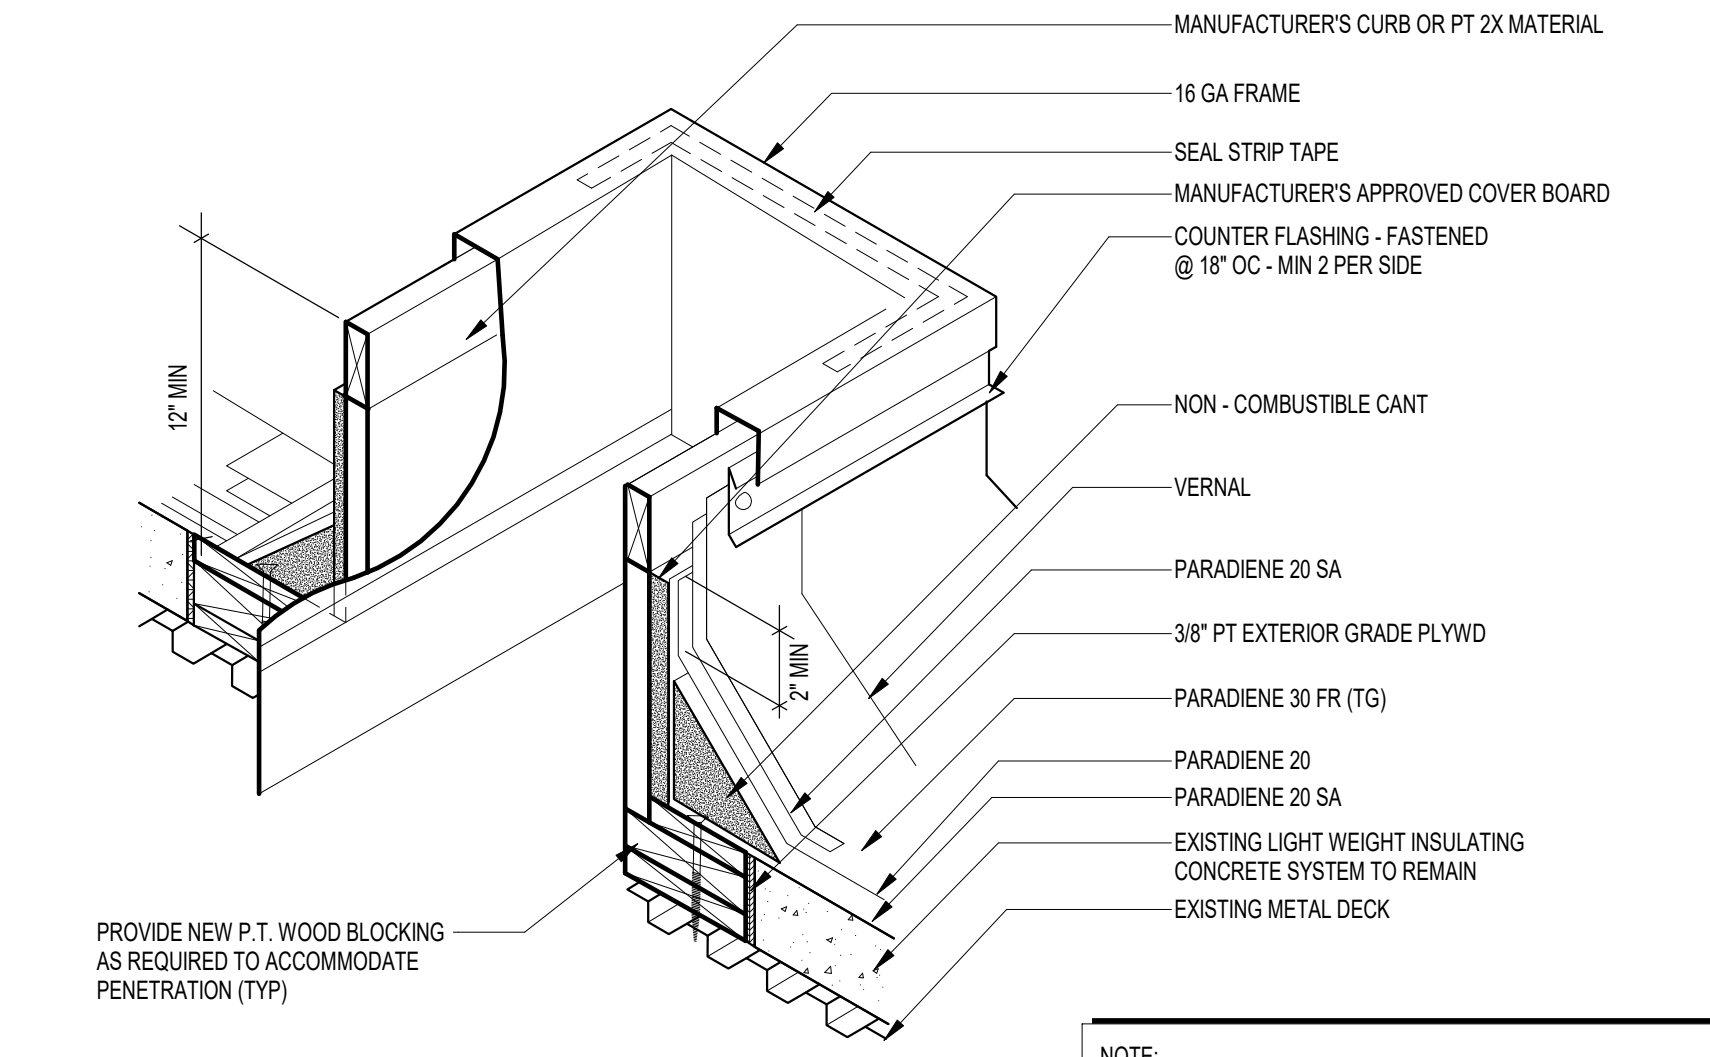NOTE:
1. ROOF INSULATION SYSTEM IS SCHEMATICALLY SHOWN. INSULATION THICKNESS WILL VARY BASED ON LOCATION OF PENETRATION.
2. CONTRACTOR SHALL CONFIRM EXISTING ROOF MEMBRANE AND PROVIDE COMPATIBLE FLASHINGS AS RECOMMENDED BY ROOFING MANUFACTURER FOR INTENDED APPLICATION (TYP)



8 VENT THRU ROOF
A511 3" = 1'-0"

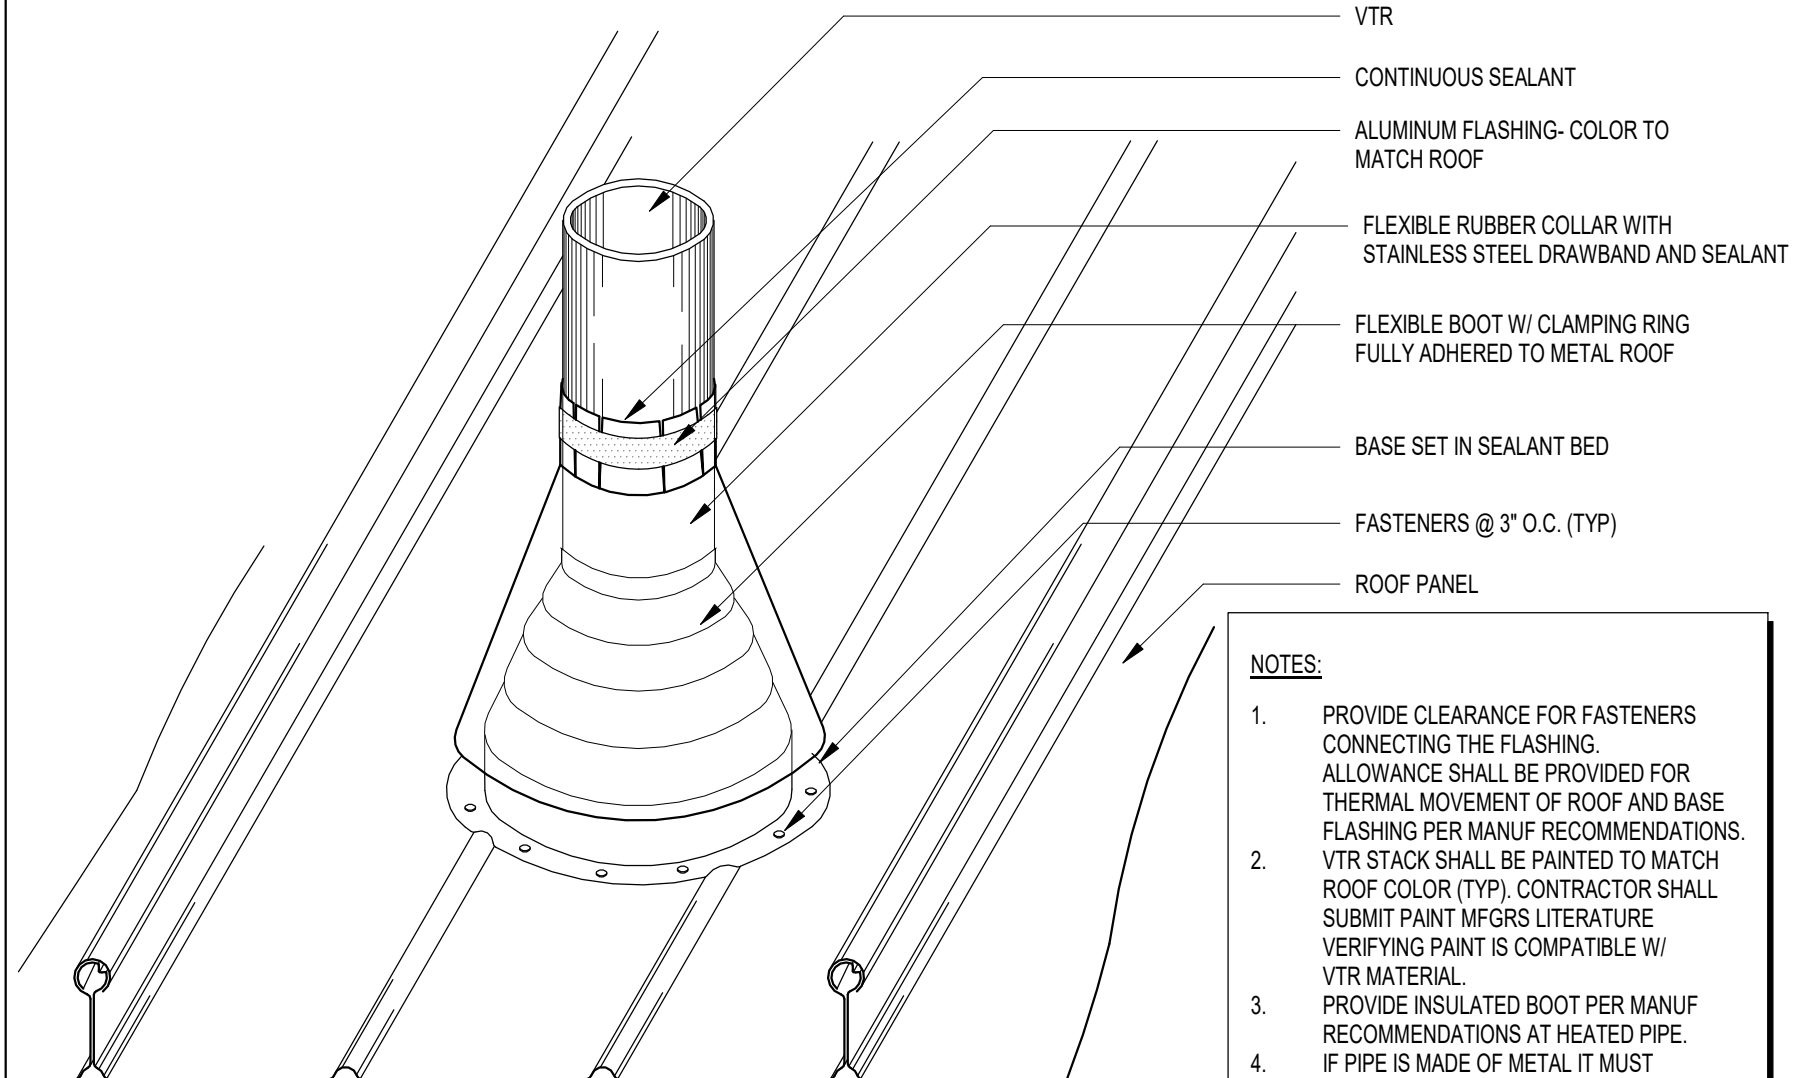NOTES:
1. PROVIDE CLEARANCE FOR FASTENERS CONNECTING THE FLASHING. ALLOWANCE SHALL BE PROVIDED FOR THERMAL MOVEMENT OF ROOF AND BASE FLASHING PER MANUF RECOMMENDATIONS.
2. VTR STACK SHALL BE PAINTED TO MATCH ROOF COLOR (TYP). CONTRACTOR SHALL SUBMIT PAINT MFGRS LITERATURE VERIFYING PAINT IS COMPATIBLE W/ VTR MATERIAL.
3. PROVIDE INSULATED BOOT PER MANUF RECOMMENDATIONS AT HEATED PIPE. IF PIPE IS MADE OF METAL IT MUST BE PAINTED TO PREVENT RUST RUN-OFF FROM STAINING PANELS. PROVIDE PAINT PRODUCT FOR ARCHITECT'S APPROVAL PRIOR TO PAINT APPLICATION



9 PIPE PENETRATION
A511 3" = 1'-0"

DOOR SCHEDULE

DOOR-MRK	WIDTH	HEIGHT	THICK	MATL	TYPE	LABEL	HWD SET NO	HEAD	JAMB	FRM-MAT	FRM-TYPE	REMARKS
0101C	CUSTOM SIZE	8'-0"	1 3/4"	AL	D		01	10/A622	12/A622	AL	5	1,12
0102D	CUSTOM SIZE	CUSTOM SIZE	1 3/4"	AL	D		02	9/A622	11/A622	AL	4	1,
108A	EXISTING	EXISTING	EXISTING	EXISTING	EXISTING	EXISTING	07	5/A621	5/A621	HM	3	5,7,11
108B	EXISTING	EXISTING	EXISTING	EXISTING	EXISTING	EXISTING	07	5/A621	5/A621	HM	3	5,7,11
115	EXISTING	EXISTING	EXISTING	EXISTING	EXISTING	EXISTING	03	6/A621	6/A621	HM	1	5,7,11
117A	PR 3'-0"	8'-0"	1 1/2"	WD VENEER	C		08	7/A621	7/A621		1	
117E	PR 3'-0"	8'-0"	1 1/2"	WD VENEER	C		08	7/A621	7/A621		1	
117F	3'-0"	7'-0"	1 3/4"	HM	A	1HR	09	15/A621	15/A621	HM	1	5,7
117S	3'-0"	7'-0"	1 3/4"	HM	A	1HR	10	15/A621	15/A621	HM	1	5,7
119	PR 3'-0"	7'-0"	1 3/4"	HM	C		11	15/A621	15/A621	HM	3	5,7
124	EXISTING	EXISTING	EXISTING	EXISTING	EXISTING	EXISTING	12	6/A621	6/A621	HM	3	5,7,11
124A	3'-0"	7'-0"	1 3/4"	WD-2	A	1HR	13	15/A621	15/A621	HM	1	5,7
124B	3'-4"	8'-0"	1 3/4"	WD-2	A		14	16/A621	16/A621	HM	1	5,7
124C	PR 3'-0"	7'-0"	1 3/4"	WD-2	A		15	6/A621	6/A621	HM	3	5,7
125	3'-0"	7'-0"	1 3/4"	WD-2	A	1HR	16	16/A621	16/A621	HM	1	5,7
125R	12'-0"	4'-7 3/4"			E		17	1/A622	2/A622		1	
126	3'-0"	7'-0"	1 3/4"	WD	A	1HR	18	9/A621	9/A621	HM	1	5,7
0200F	EXISTING	EXISTING	EXISTING	EXISTING	EXISTING	EXISTING	19	5/A621	5/A621	HM	1	9,11
211M	PR 3'-0"	7'-0"	1 3/4"	WD	A	1HR	15	5/A621	5/A621	HM	1	5,7
212	EXISTING	EXISTING	EXISTING	EXISTING	EXISTING	EXISTING	19	5/A621	5/A621	HM	1	9,11
213	PR 3'-0"	7'-0"	1 3/4"	WD	A		15	5/A621	5/A621	HM	1	5,7
214	3'-0"	7'-0"	1 3/4"	WD	A	1HR	20	5/A621	5/A621	HM	1	5,7
852	PR 2'-10"	7'-2"	1 3/4"	HM	A	1HR	21	6/A622	7/A622	HM	1	5,7
S301	EXISTING	EXISTING	EXISTING	EXISTING	EXISTING	EXISTING	19	3/A622	4/A622	HM	1	9,11


DOOR AND WINDOW GENERAL NOTES:

- ROUGH OPENING DIMENSIONS ARE INDICATED. ACTUAL WINDOW SIZES SHOULD BE CONSTRUCTED TO MEET TOLERANCES NECESSARY FOR PROPER VERTICAL AND HORIZONTAL ALIGNMENT OF SYSTEMS AND CONFORMANCE W/ DETAILS INCLUDED HEREIN. SEE SPECIFICATIONS AND FIELD VERIFY DIMENSIONS PRIOR TO FABRICATION.
- WEATHERSTRIPPING SHALL BE PROVIDED AT HEAD AND JAMBS OF EXTERIOR DOORS.
- THRESHOLDS SHALL CONFORM TO ADA ACCESSIBILITY REQUIREMENTS.
- PRE-DRILL DOORS FOR THE APPROPRIATE HARDWARE SET AS SPECIFIED.
- DOORS TO HAVE LEVER-TYPE HANDLES TO MEET ADA ACCESSIBILITY REQUIREMENTS. REFER TO HARDWARE SCHEDULE IN THE SPECIFICATIONS.
- SECTIONS THROUGH ALUM STOREFRONT MEMBERS ARE JOB SPECIFIC - "ACCEPTABLE MANUFACTURERS TO MATCH DETAILS PRECISELY" PER THE SPECIFICATIONS.
- SECTIONS THROUGH ALUM STOREFRONT MEMBERS ARE JOB SPECIFIC - "ACCEPTABLE MANUFACTURERS TO MATCH DETAILS PRECISELY" PER THE SPECIFICATIONS.
- WINDOW, STOREFRONT, AND CURTAINWALL MFG'S SHALL BE RESPONSIBLE TO PROVIDE ANY ADDITIONAL MULLION REINFORCEMENT NECESSARY TO MEET SPECIFIED WIND LOADING CRITERIA.
- THRESHOLDS, JAMBS, AND HEADS OF EXTERIOR DOORS SHALL BE FULLY GASKETED.
- IN WINDOWS AND STOREFRONTS, SUBSILLS SHALL BE SET IN A BED OF SEALANT TO INSURE A WATERTIGHT SEAL (INTERIOR AND EXTERIOR).
- END DAM SUBSILL WITH FLASHING MATERIAL. SEAL END DAM TO SUBSILL, THEN SEAL END DAM TO CONDITION PER MFR. INSTRUCTIONS.
- FASTENER HEADS AT SILL MUST BE COVERED WITH SEALANT TO INSURE A WATERTIGHT SEAL (TYP) EXTERIOR CONDITIONS.
- ALL EXTERIOR AND ADJACENT DOORS (AS DEFINED BY FBC-B CHAPTER 13) TO COMPLY WITH FBC-B 13-403.AB.
- VALUE ENGINEERING TO A LESS EFFICIENT UNIT OR ASSEMBLY IS NOT ALLOWED WITHOUT RESUBMITTAL OF THE ENERGY FORMS AND APPROVAL OF THE BUILDING DEPARTMENT.


GLAZING LEGEND

- SINGLE GLAZING - 1/4" CLEAR TEMPERED GLASS
- 1" INSULATED GLASS UNIT: OUTER LITE 1/4" CLEAR LOW-E #2 X AIRSPACE X 1/4" CLEAR GLASS INNER LITE
- INSULATED GLASS UNIT, OUTER LITE 1/4" CLEAR TEMPERED LOW-E #2 SURFACE X AIRSPACE X 1/4" CLEAR TEMPERED GLASS INNER LITE
- 1'+(-) INSULATED LAMINATED IMPACT RESISTANT GLASS - INNER LITE (2) LAYERS 3/16" CLEAR GLASS WITH .090" INTERLAYER X AIR SPACE X 1/4" OR 3/16" (AS REQUIRED FOR STRENGTH) WITH LOW-E #2 SURFACE. TEMPERED WHERE CODE REQUIRED.
- INSULATED GLASS UNIT, OUTER LITE 1/4" CLEAR TEMPERED X AIRSPACE X 1/4" CLEAR TEMPERED GLASS INNER LITE

NOTE:
GLASS THICKNESS INDICATED ABOVE IS THE MINIMUM, INCREASE THICKNESS AS REQUIRED TO MEET DESIGN WIND LOADS.

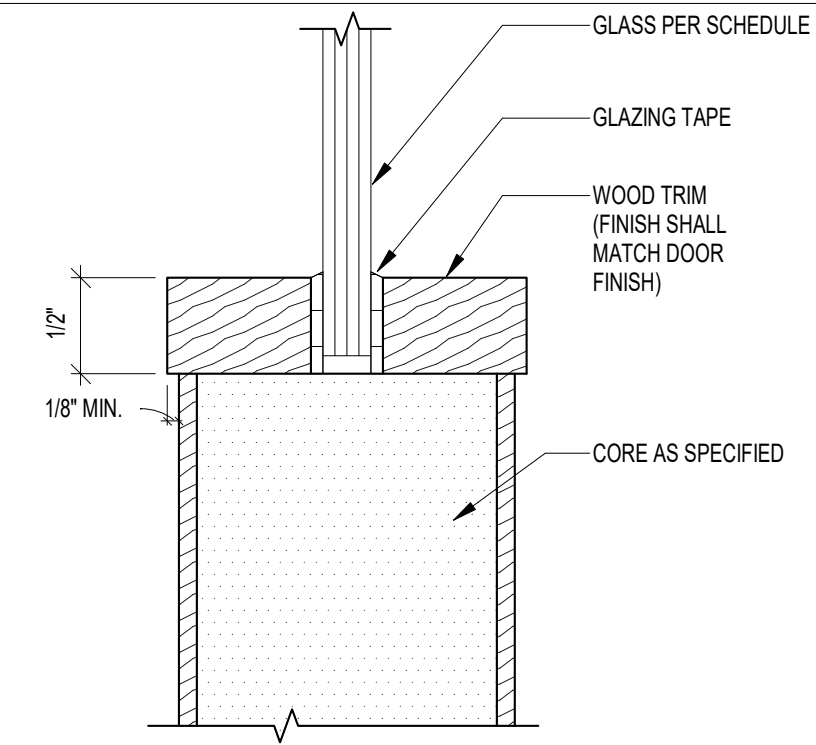

DOOR GLAZING

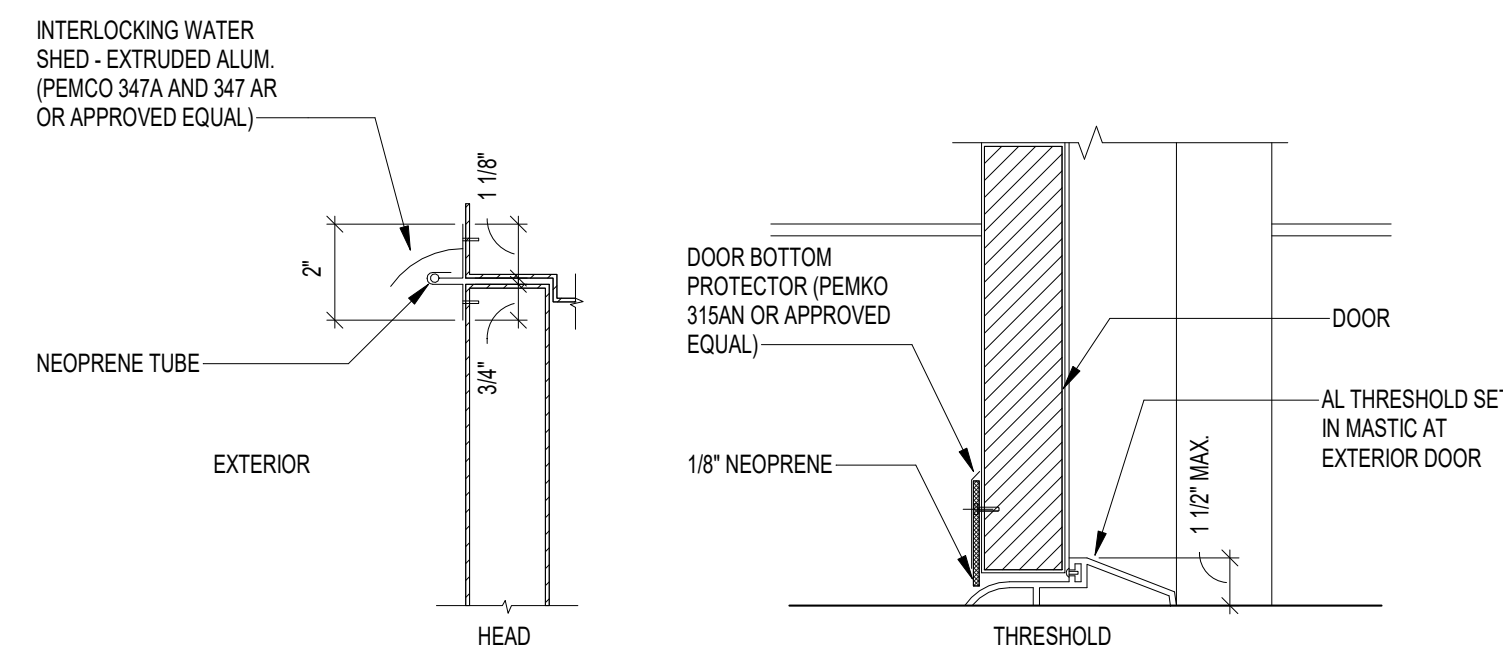

TYP EXTERIOR DOOR WEATHERPROOFING

(AT DOORS FLUSH WITH EXTERIOR WALLS NOT PROVIDED WITH A PROTECTIVE OVERHANG ONLY)

DOOR SCHEDULE GENERAL NOTES


- CONTINUOUS WEATHERSTRIPPING SHALL BE PROVIDED AT HEAD, JAMBS, AND THRESHOLDS OF ALL EXTERIOR DOORS.
- THRESHOLDS SHALL CONFORM TO ADA ACCESSIBILITY REQUIREMENTS.
- PRE-DRILL DOORS FOR THE APPROPRIATE HARDWARE SET AS SPECIFIED.
- DOORS TO HAVE LEVER-TYPE HANDLES TO MEET ADA ACCESSIBILITY REQUIREMENTS. REFER TO HARDWARE SCHEDULE IN THE SPECIFICATIONS; EXCEPTION - EXIT HWD.
- THRESHOLDS, JAMBS, AND HEADS OF EXTERIOR DOORS SHALL BE FULLY GASKETED.
- FIRE RATED DOORS SHALL HAVE FIRE RATED HARDWARE.
- FIRE RATED DOORS SHALL HAVE A SELF-CLOSING DEVICE.
- REFER TO MECHANICAL SPECIFICATIONS FOR LOUVER REQUIREMENTS.
- WOOD OR METAL VISION LIGHT FRAMES SHALL HAVE A SQUARE PROFILE.
- PROVIDE A STRUCTURAL COMPOSITE LUMBER (LAMINATED STRAND) CORE IN DOORS WITH VISION LIGHTS.
- EXTERIOR DOORS SHALL BE PROVIDED WITH CLOSERS.
- FIRE RATED DOORS WITH A LITE SHOULD HAVE LABELED 1/4" FIRE SAFETY GLASS.
- PROVIDE BASE MOUNTED DOORSTOPS AT DOORS THAT ARE CLOSE TO AN ADJACENT WALL.
- OPENINGS WITHIN A 1-HOUR FIRE RATED WALL ASSEMBLY SHALL MAINTAIN A MINIMUM 45 MINUTE FIRE RATING. FIRE RATED DOORS SHALL BE A SELF-CLOSING DOOR ASSEMBLY. NFPA 1, 1.14.1, FLORIDA 2010 EDITION.

DOOR SCHEDULE REMARKS


- DOOR IS A STOREFRONT DOOR PART OF AN ALUMINUM STOREFRONT SYSTEM. IT IS THE CONTRACTOR'S RESPONSIBILITY TO VISIT THE SITE AND DETERMINE EXACT EXTENTS OF DEMOLITION WORK PRIOR TO SUBMITTING A PROPOSAL FOR THE COST OF THE WORK (TYP). CONTRACTOR TO VERIFY AND FIELD MEASURE OPENINGS TO ACCOMMODATE NEW DOOR AS SPECIFIED.
- UNDERCUT DOOR 1" (COORDINATE WITH MECHANICAL DRAWINGS).
- SWING DOOR 180°.
- PROVIDE A REMOVABLE CENTER MULLION AS SHOWN IN THE DOOR FRAME ELEVATIONS.
- DOOR SHALL BE EQUIPPED WITH A SELF-CLOSING DEVICE.
- PROVIDE DOOR HOLDER.
- PROVIDE KICK PLATE.
- PROVIDE SOUND GASKETING ENTIRE DOOR PERIMETER.
- EXISTING, NO WORK.
- PROVIDE LOUVER IN DOOR.
- EXISTING DOOR TO BE RELOCATED. FIELD VERIFY EXISTING DOOR AND HARDWARE PREP AND NOTIFY AEC TEAM OF ANY CONFLICTS. ALL LOCATIONS TO RECEIVE NEW DOOR FRAMES AS SCHEDULED.
- DOOR TO BE IMPACT RESISTANT AND RECEIVE IMPACT GLAZING AS SPECIFIED.

GLAZING NOTES:


- EXTERIOR GLAZING SHALL BE CLEAR, AND INTERIOR GLAZING SHALL BE CLEAR, UNLESS NOTED OTHERWISE.
- LABELED, TEMPERED, AND LAMINATED GLAZING SHALL DISPLAY A PERMANENT STAMP OR MANUFACTURER'S LABEL IDENTIFYING THE PRODUCT. ANY LABELS ON INTERIOR HOLLOW METAL WINDOW FRAMES SHALL BE INSTALLED ON UNDERSIDE OF HORIZONTAL MULLIONS OR ANOTHER DISCRETE LOCATION IF APPROPRIATE.
- TEMPERED GLASS SHALL BE IN LOCATIONS WHERE WINDOWS OR GLAZING IS LOCATED WITHIN 4'-0" OF INTERIOR OR EXTERIOR DOORS AND BELOW DOOR HEAD HIGH.
- SEE WINDOW ELEVATIONS FOR GLAZING TYPES.
- FIRE RATED GLAZING 45 MINUTES OR HIGHER SHALL COMPLY WITH THE HOSE STREAM TEST.

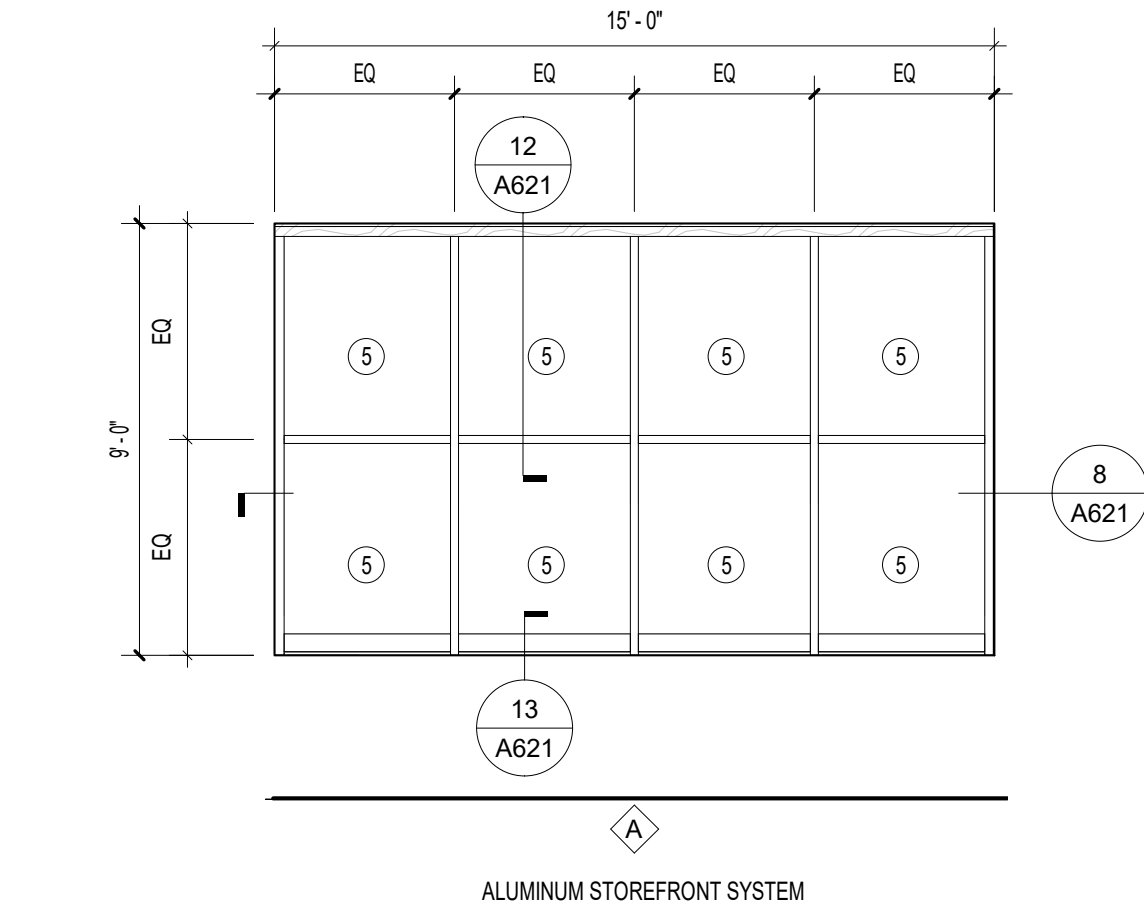

WINDOW ELEVATIONS
1/4" = 1'-0"

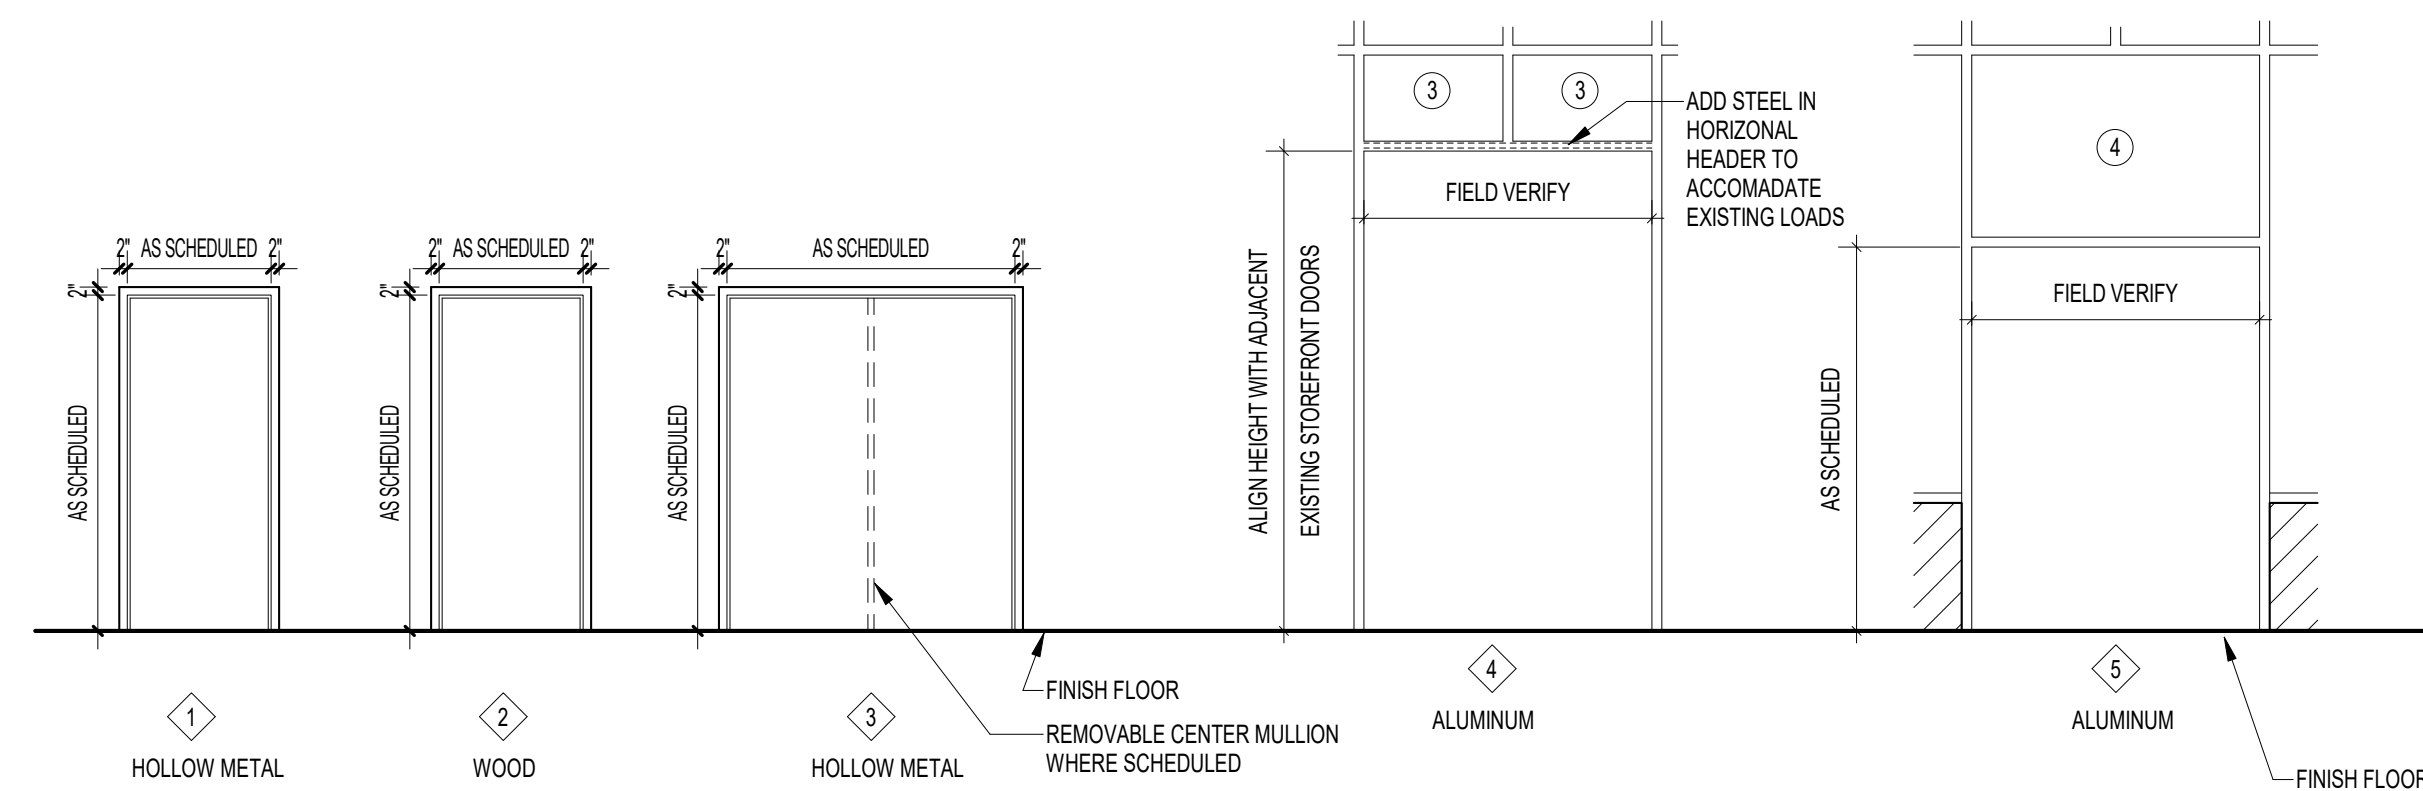

DOOR FRAME ELEVATIONS
1/4" = 1'-0"

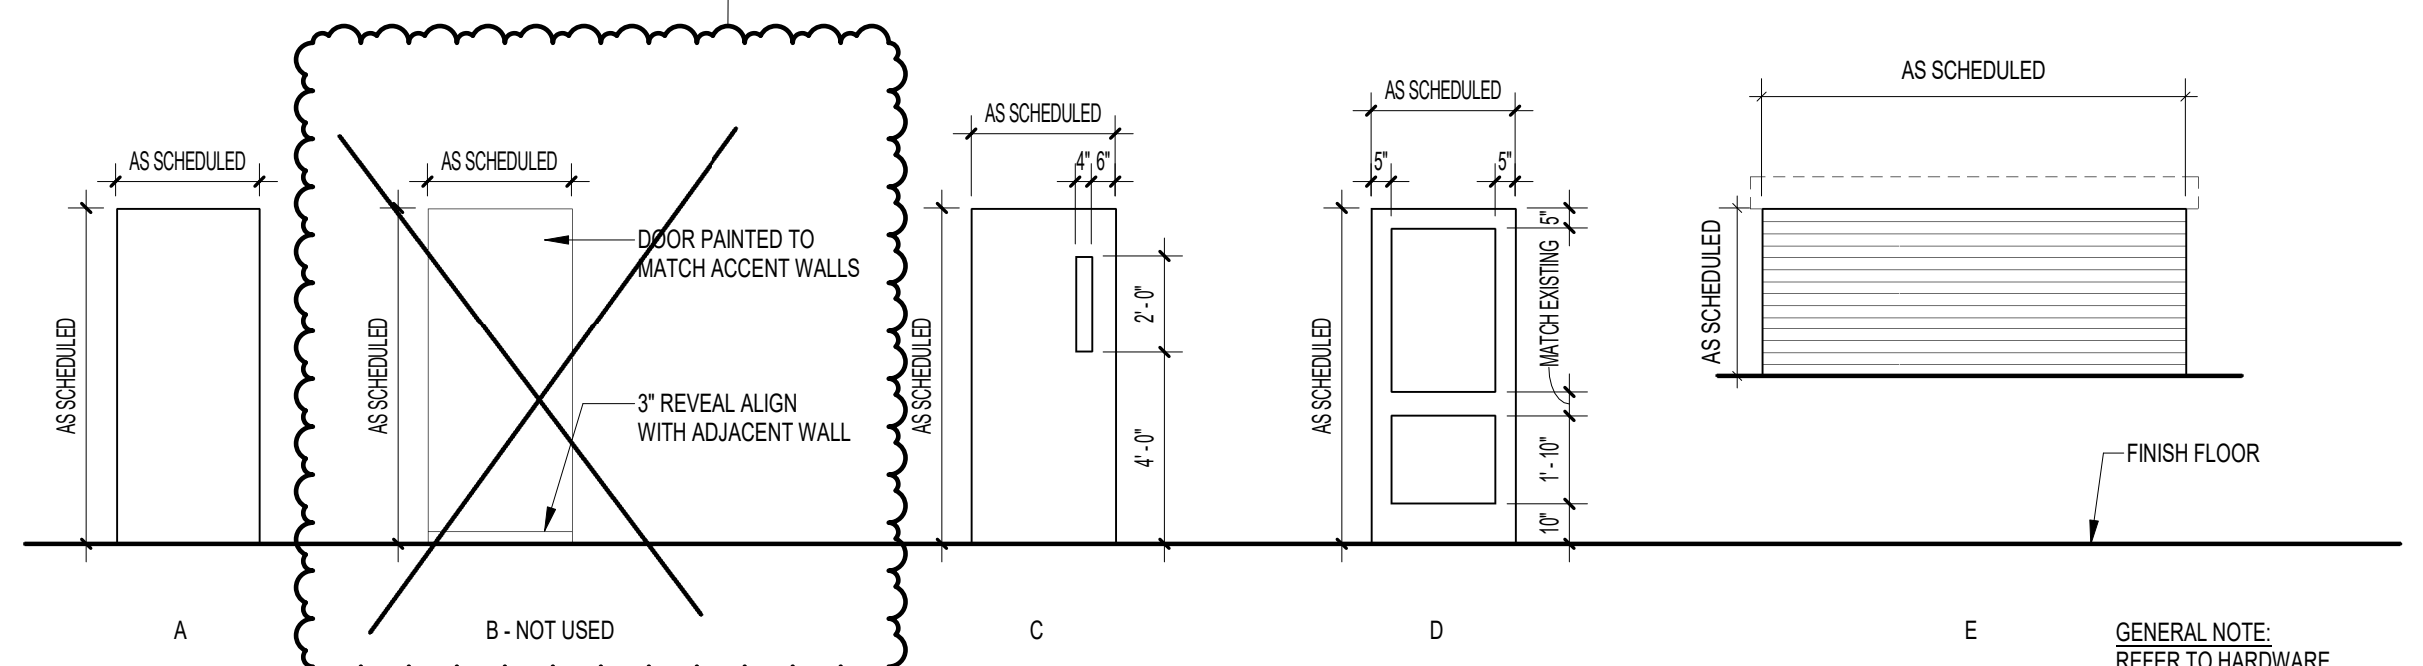

DOOR ELEVATIONS
1/4" = 1'-0"


GENERAL NOTE:
REFER TO HARDWARE SCHEDULE IN PROJECT MANUAL FOR ALL DOOR HARDWARE



ARCHITECTURE
PLANNING INTERIORS
GRAPHICS

ELLIOTT MARSHALL BINES PA. (EMI architects)
251 E. 7TH AVENUE TALLAHASSEE FL 32303
(850) 222-7442
www.emiarch.com
LICENSE #A-000049-18 0200153

NOTE:
11' x 17' SHEETS ARE PLOTTED AT 1/2 THE SCALE NOTED ON THESE DRAWINGS

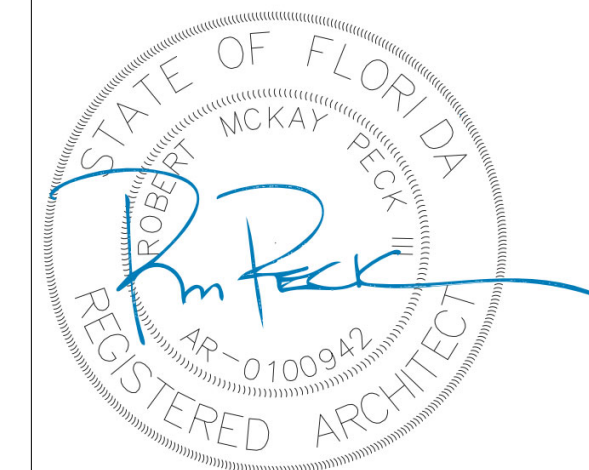

FSU TURNBULL
CONFERENCE CENTER
RENOVATIONS

REV	DATE	DESCRIPTION
1	04.17.24	FSU PERMIT

PROJECT PHASE
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DATE
18 OCTOBER 2023

DRAWN BY
RMP

PROJECT NO
74000

CHECKED BY
RMP/BI


SHEET TITLE

DOOR SCHEDULE AND
WD/DR ELEVATIONS
(GLAZING LEGEND)

SHEET NO
A605

REV NO
1

NOTE:
11' x 17' SHEETS ARE PLOTTED AT 1/2
THE SCALE NOTED ON THESE DRAWINGS

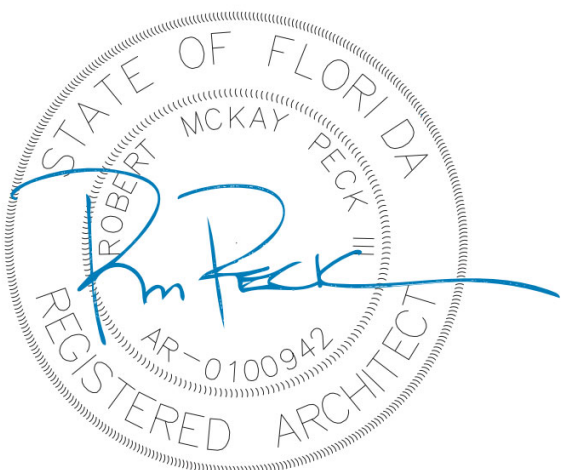

**FSU TURNBULL
CONFERENCE CENTER
RENOVATIONS**


REV	DATE	DESCRIPTION
1	04.17.24	FSU PERMIT

PROJECT PHASE	
CONSTRUCTION DOCUMENTS	
DATE	DRAWN BY
18 OCTOBER 2023	
PROJECT NO	CHECKED BY
74000	RMP/BI


**DOOR AND WINDOW
DETAILS**

SHEET NO	REV NO
A621	1


NOTE:
ALL EXTERIOR STOREFRONT SYSTEMS AND DOORS
ARE TO MATCH EXISTING STOREFRONT SYSTEM

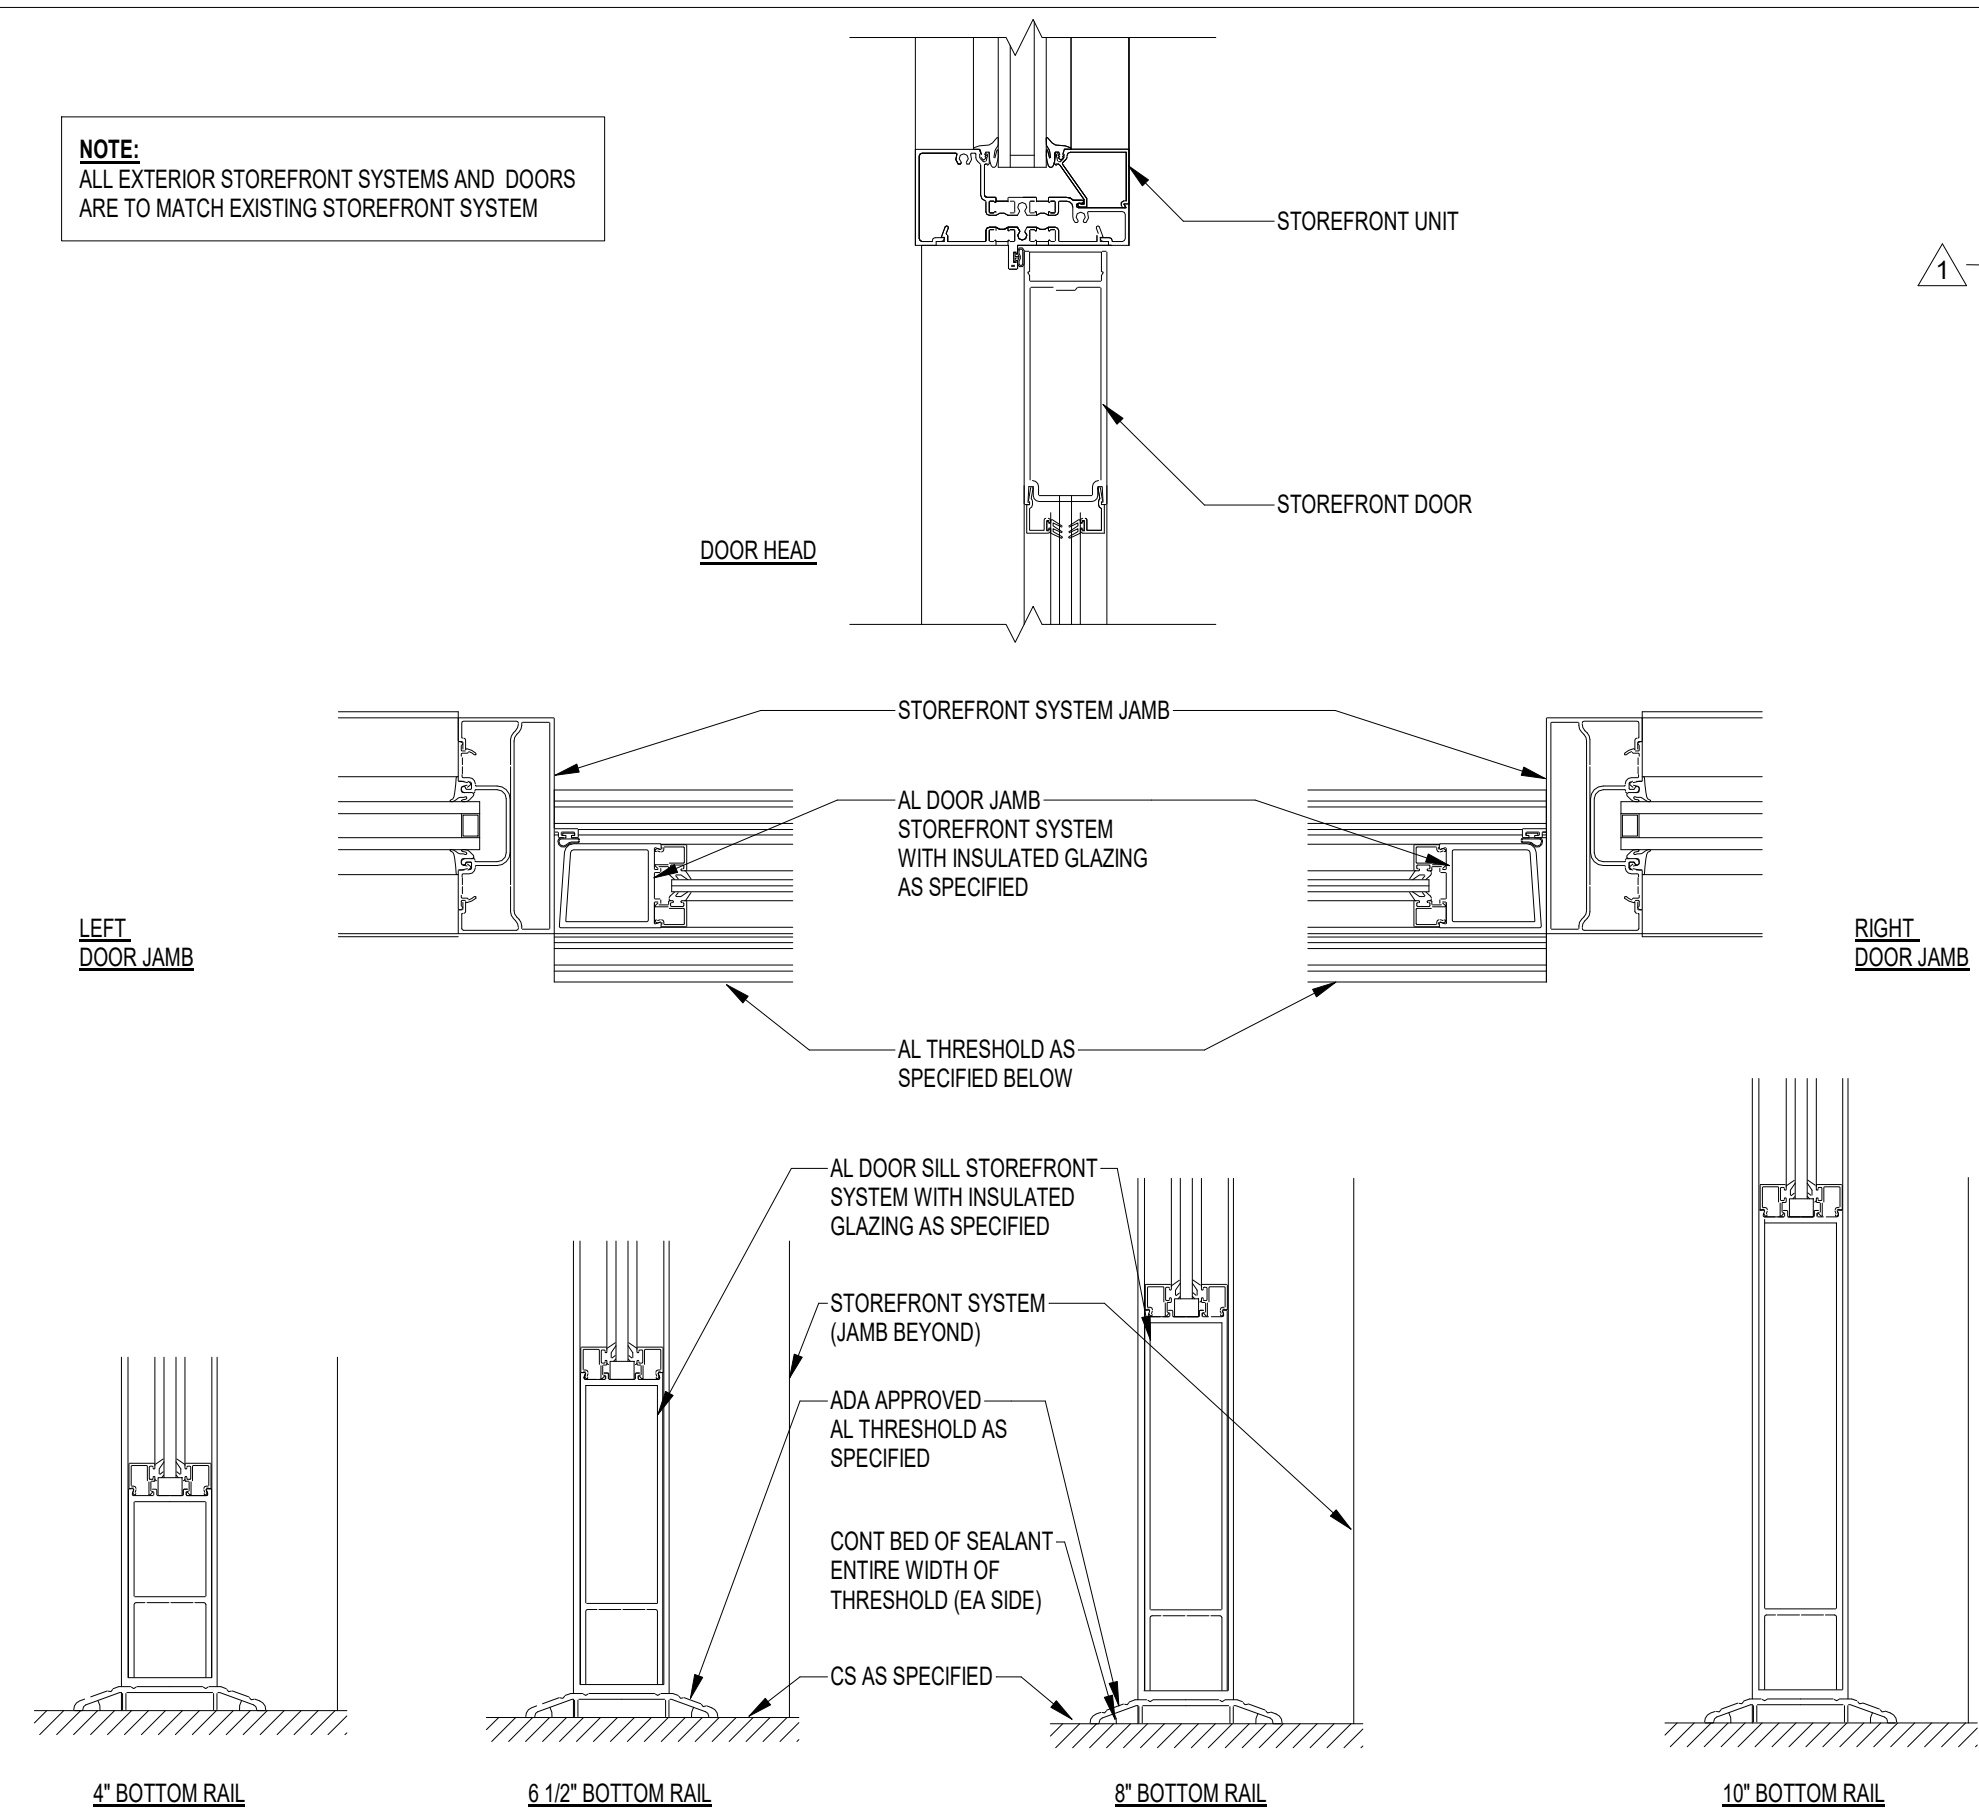


1 STOREFRONT DOOR RAIL/JAMB/HEAD
A621 3" = 1'-0"

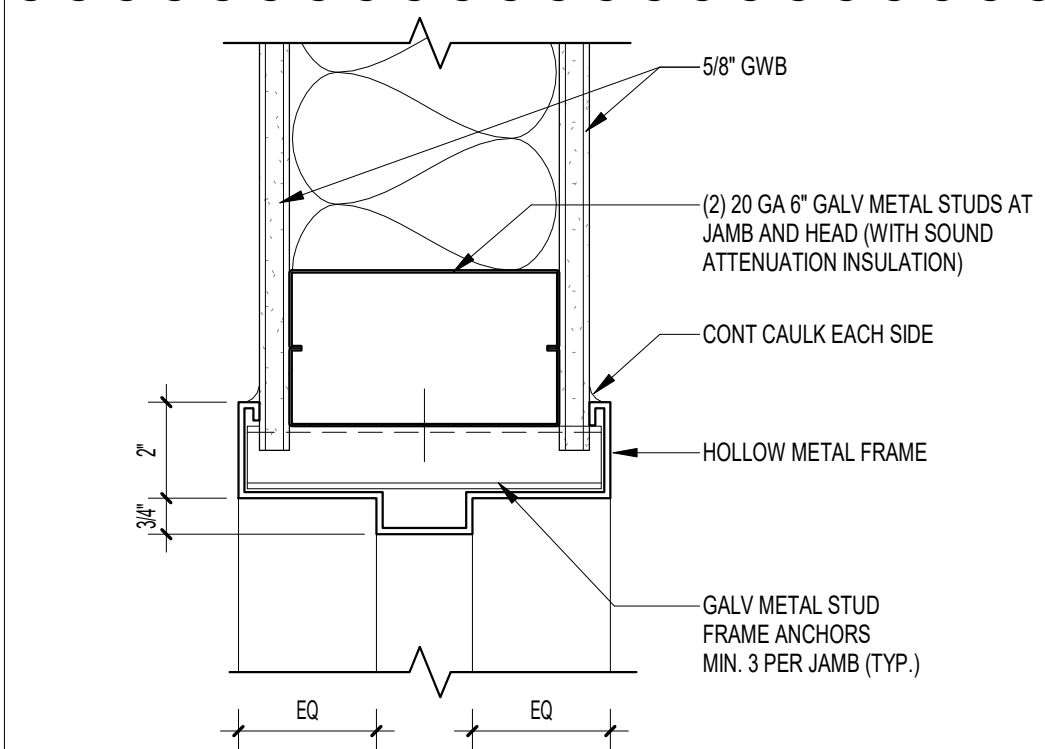


5 DOOR HEAD/JAMB TYP
A621 3" = 1'-0"

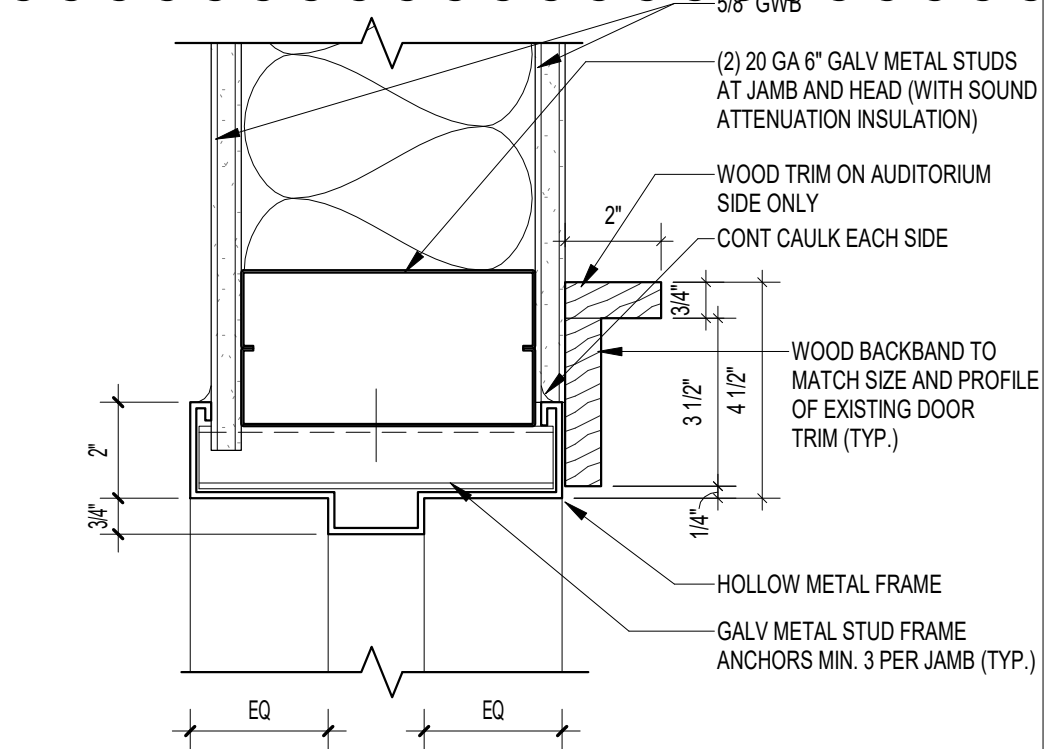


6 DOOR HEAD/JAMB W/TRIM TYP
A621 3" = 1'-0"

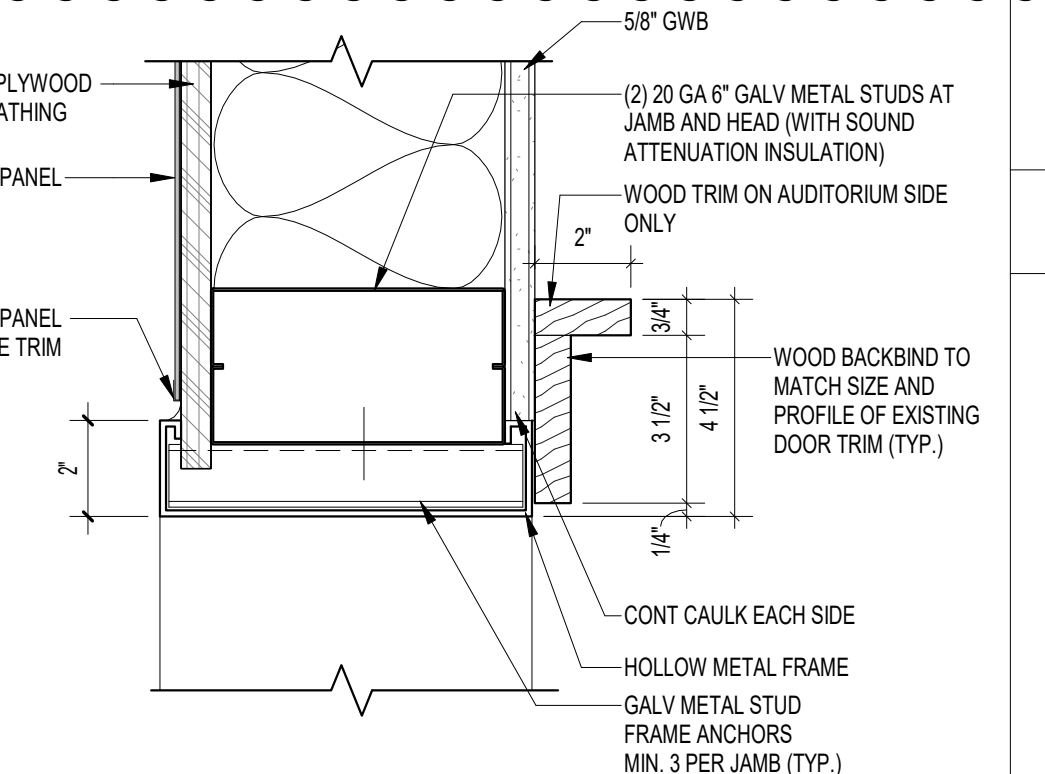


7 TRAFFIC IMPACT DOOR HEAD/JAMB
A621 3" = 1'-0"

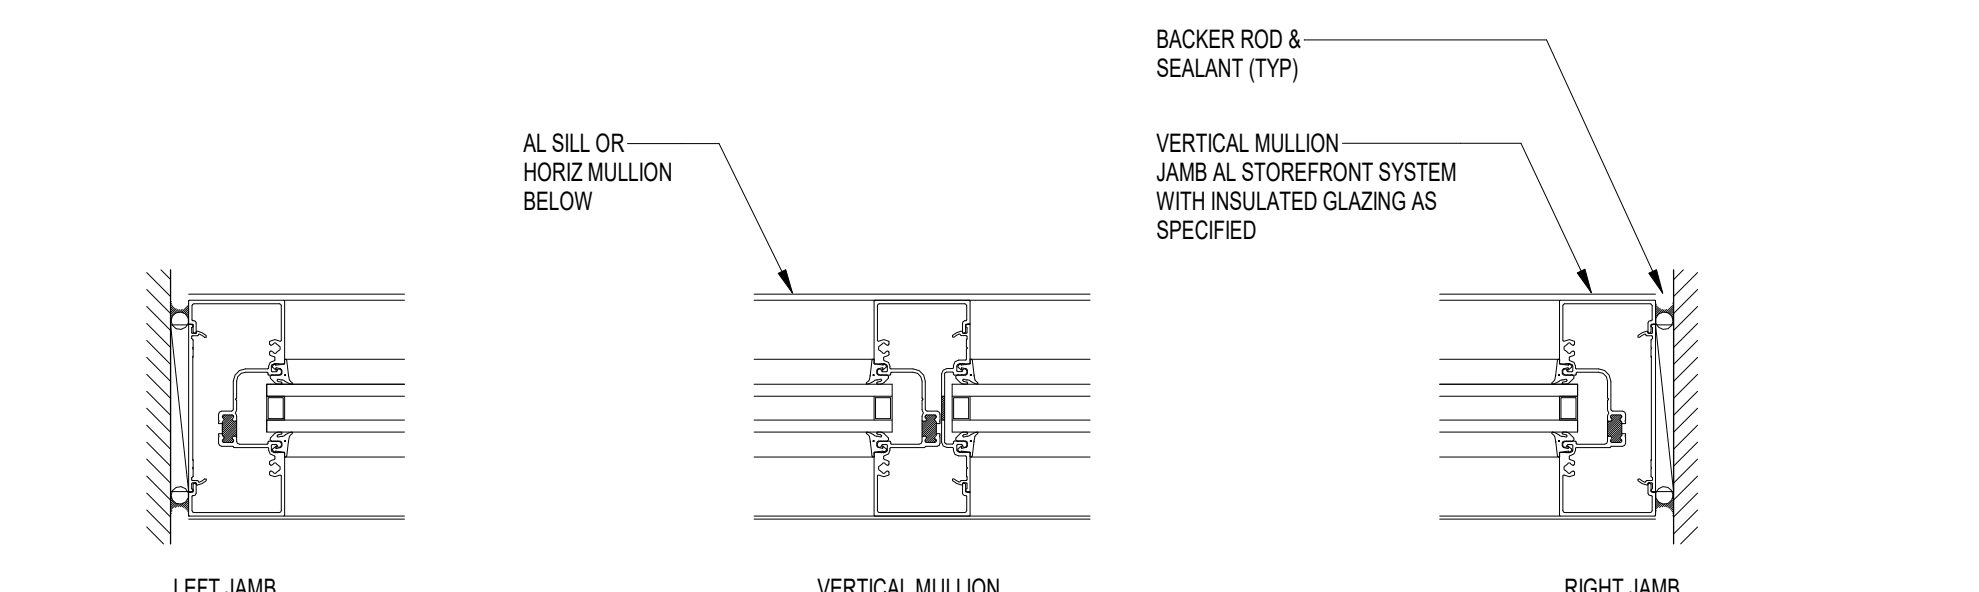


8 STOREFRONT JAMB/MULLION
A621 3" = 1'-0"

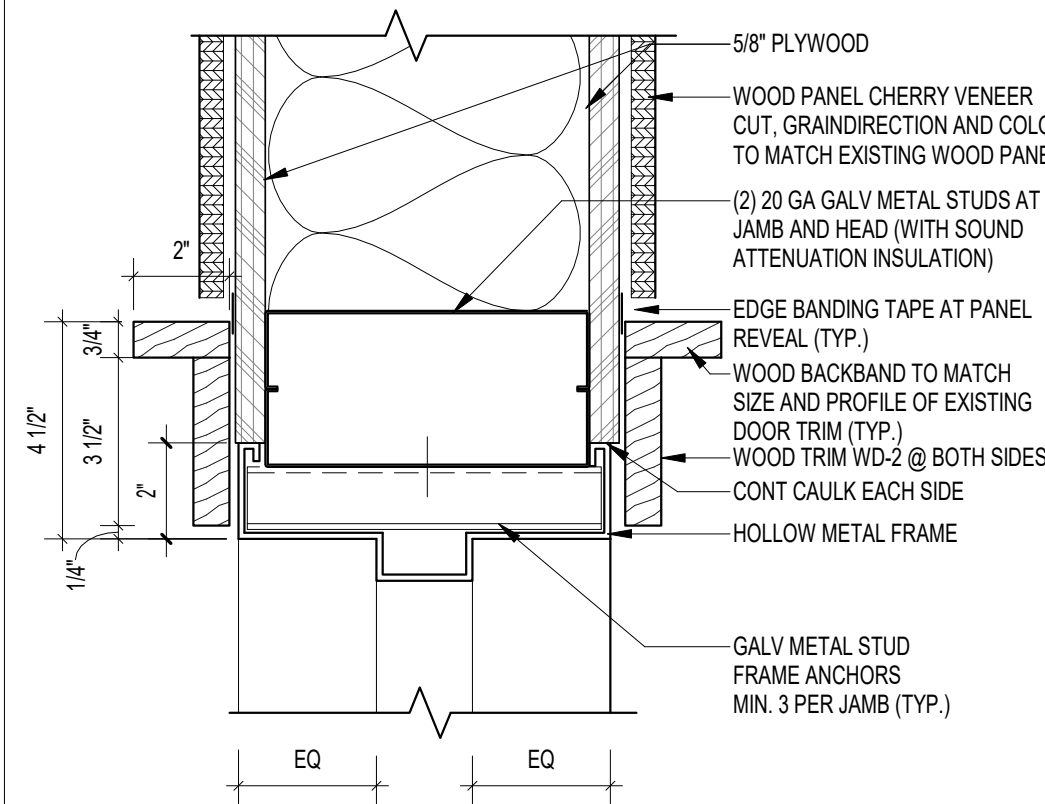


9 DOOR HEAD /JAMB W/ TRIM & WD PANEL
A621 3" = 1'-0"

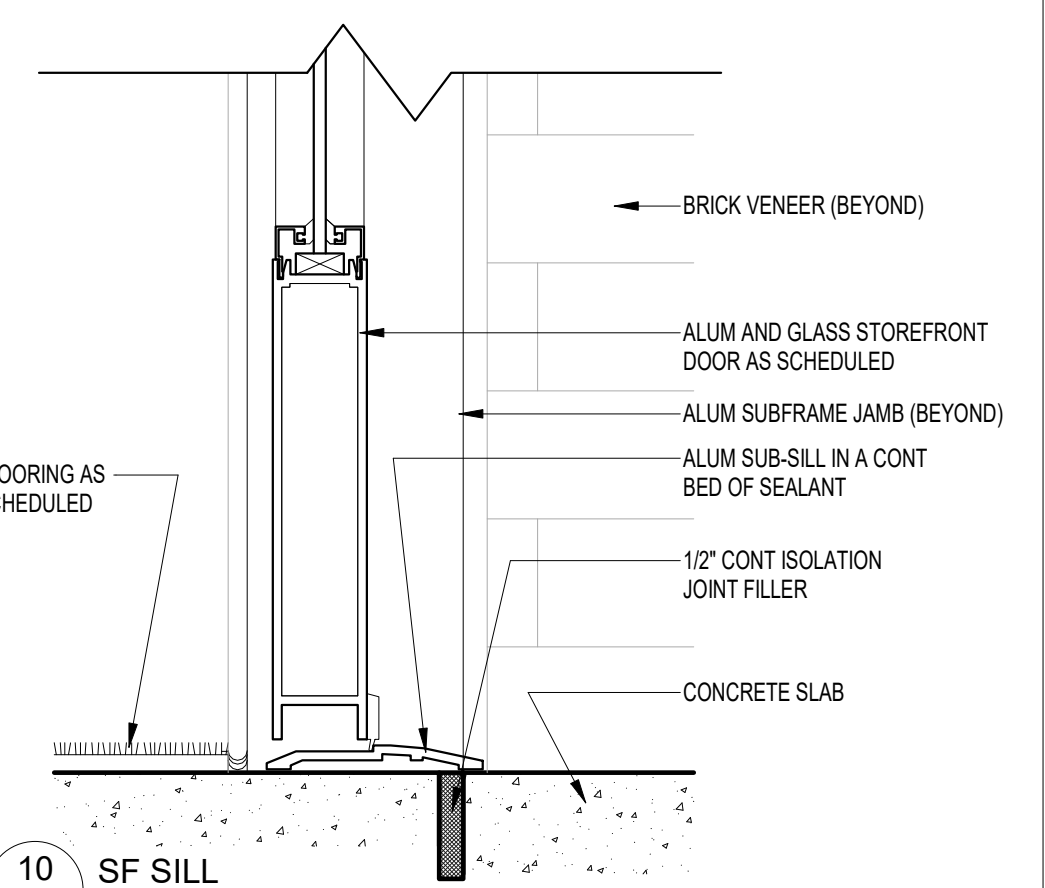


10 SF SILL
A621 3" = 1'-0"

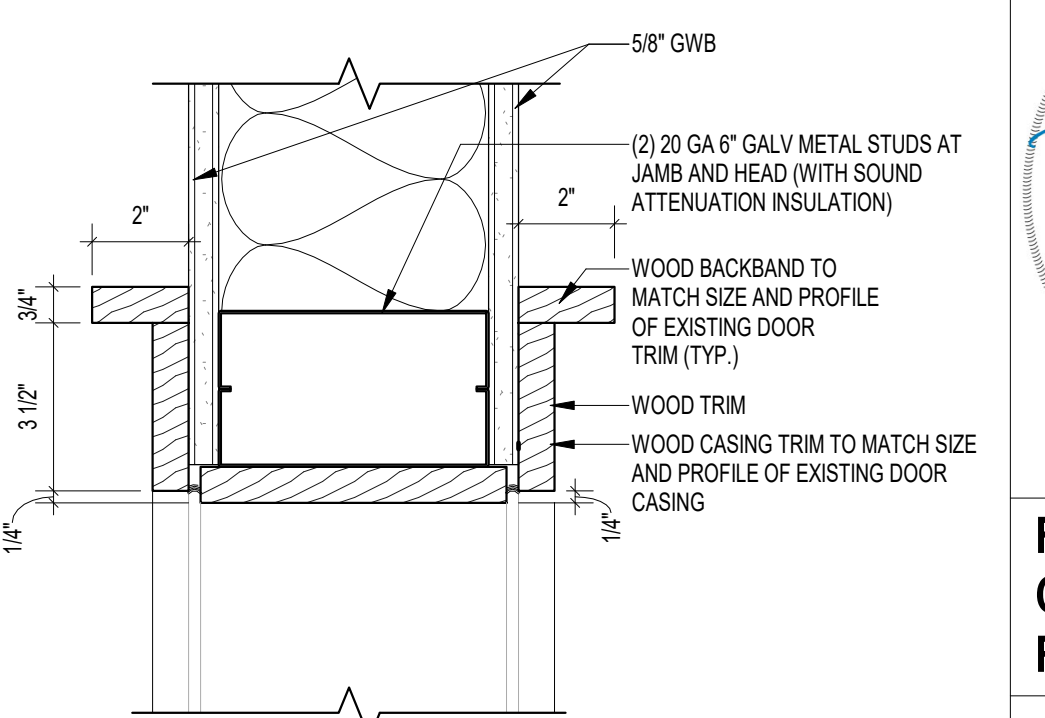


11 CASSED OPENING HEAD/JAMB
A621 3" = 1'-0"

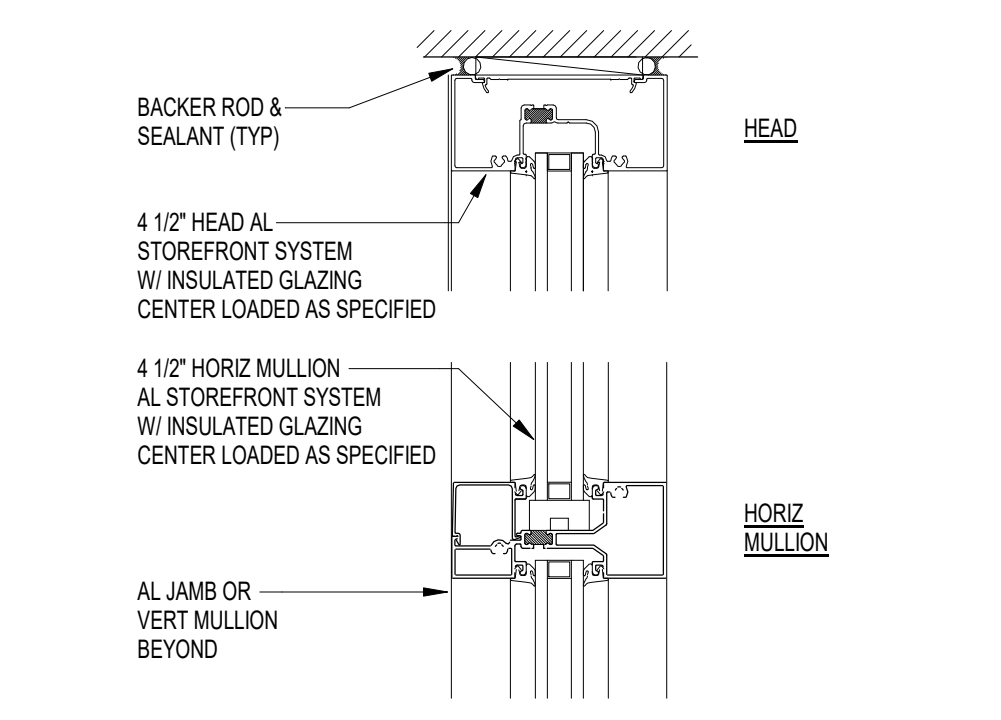


12 SF HEAD & HORZ MULLION
A621 3" = 1'-0"

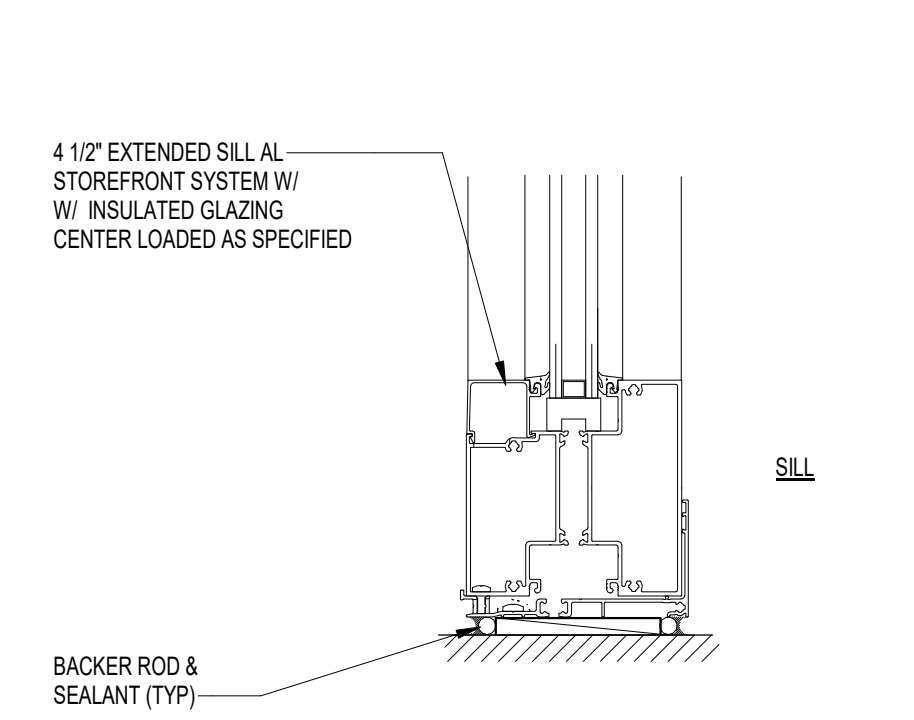


13 SF SILL
A621 3" = 1'-0"

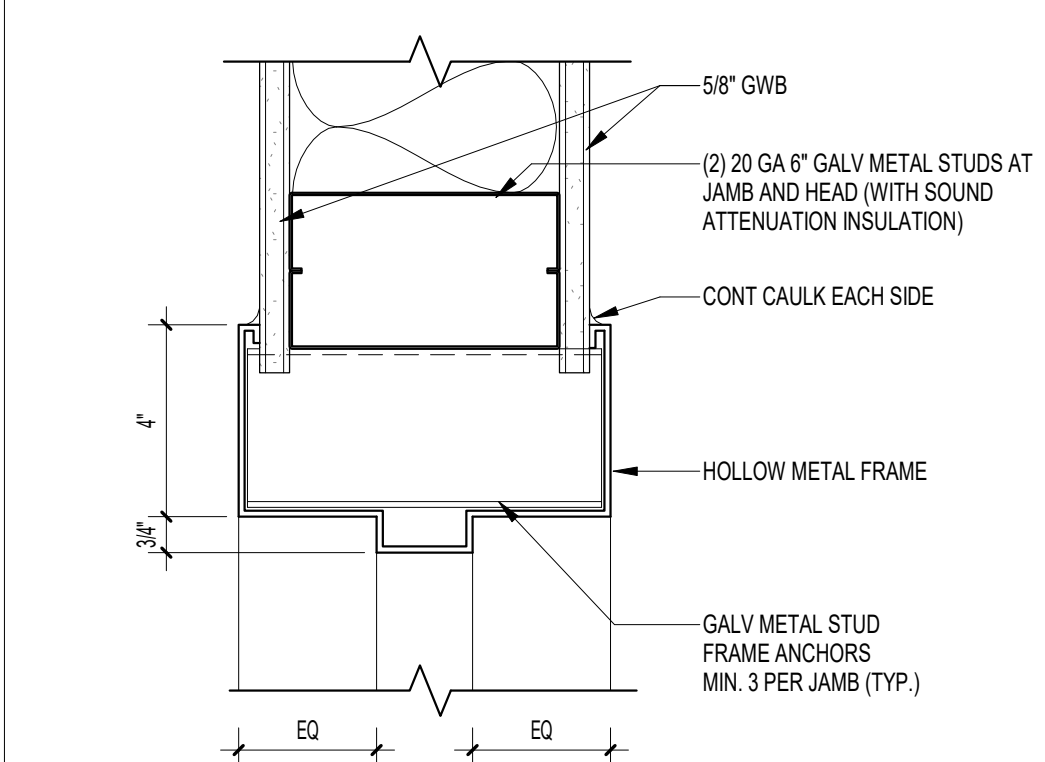


14 DOOR HEAD
A621 3" = 1'-0"

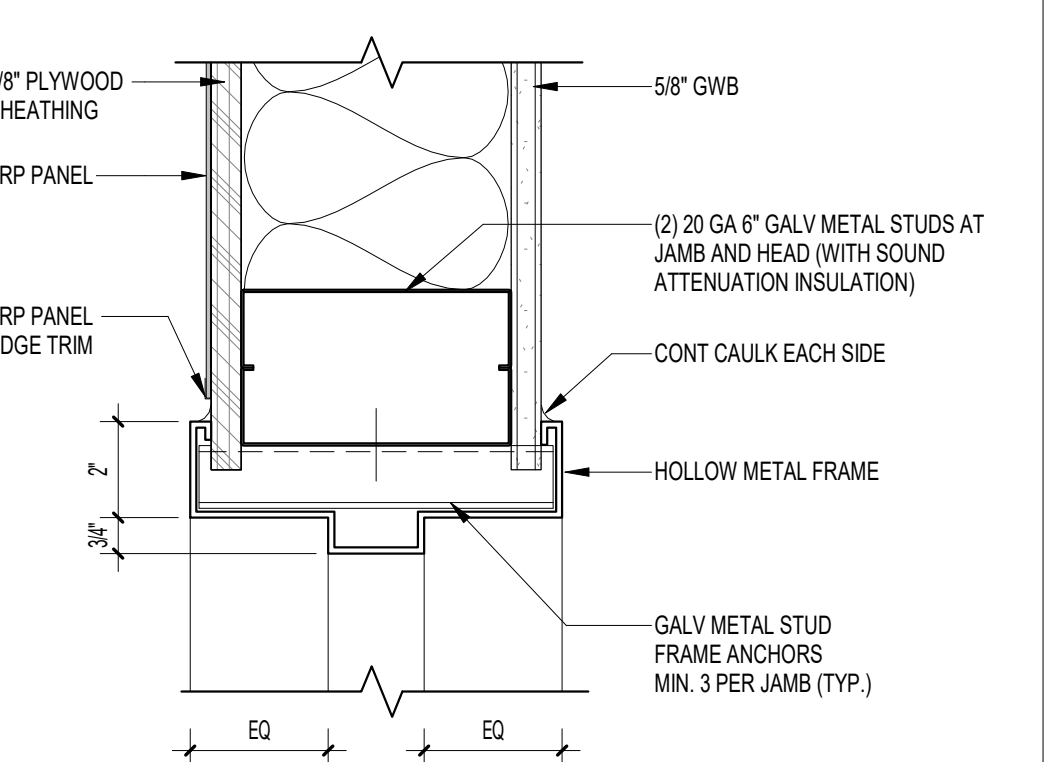


15 DOOR HEAD/JAMB
A621 3" = 1'-0"

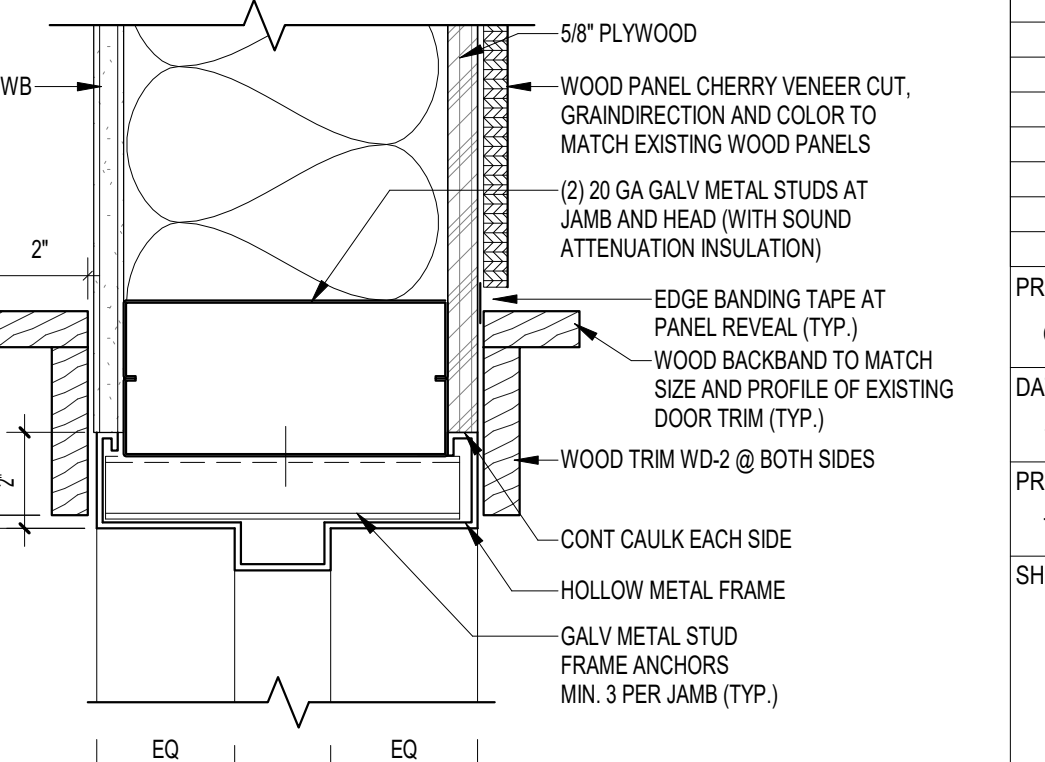


16 DOOR HEAD /JAMB W/ TRIM & WD PANEL
A621 3" = 1'-0"

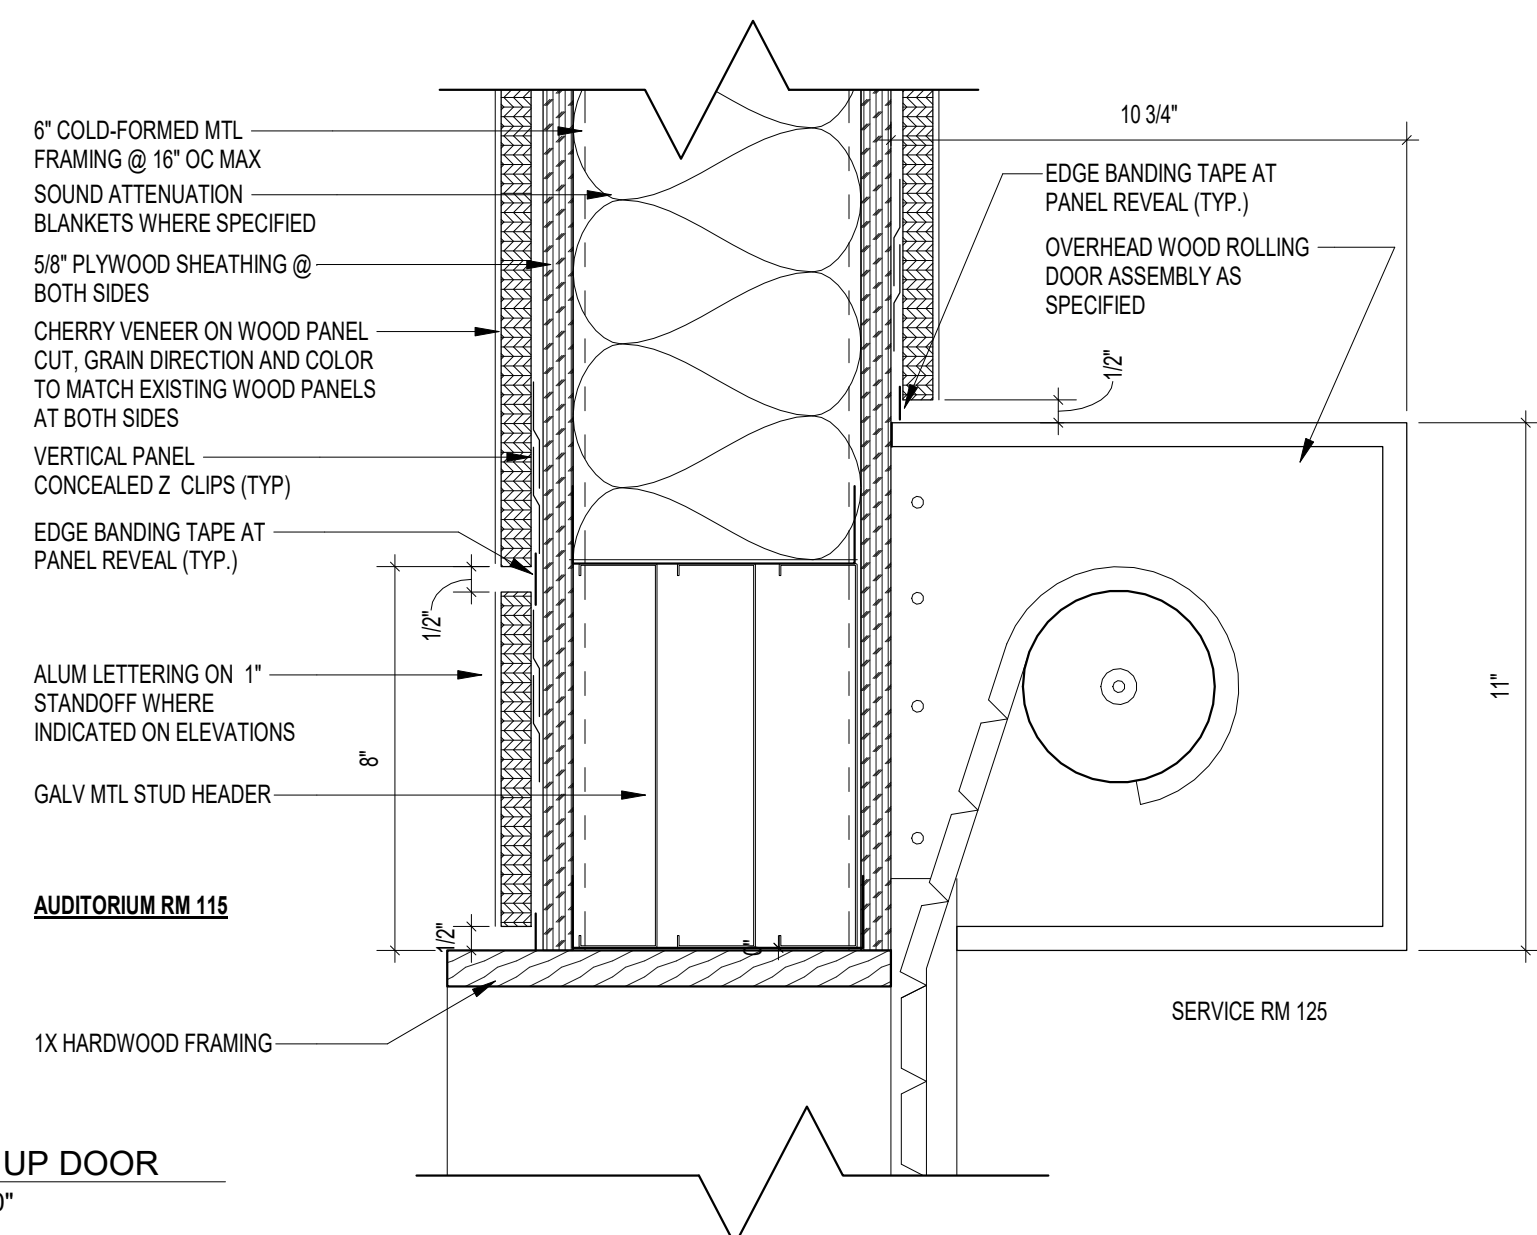


1 ROLL UP DOOR
A622 3" = 1'-0"

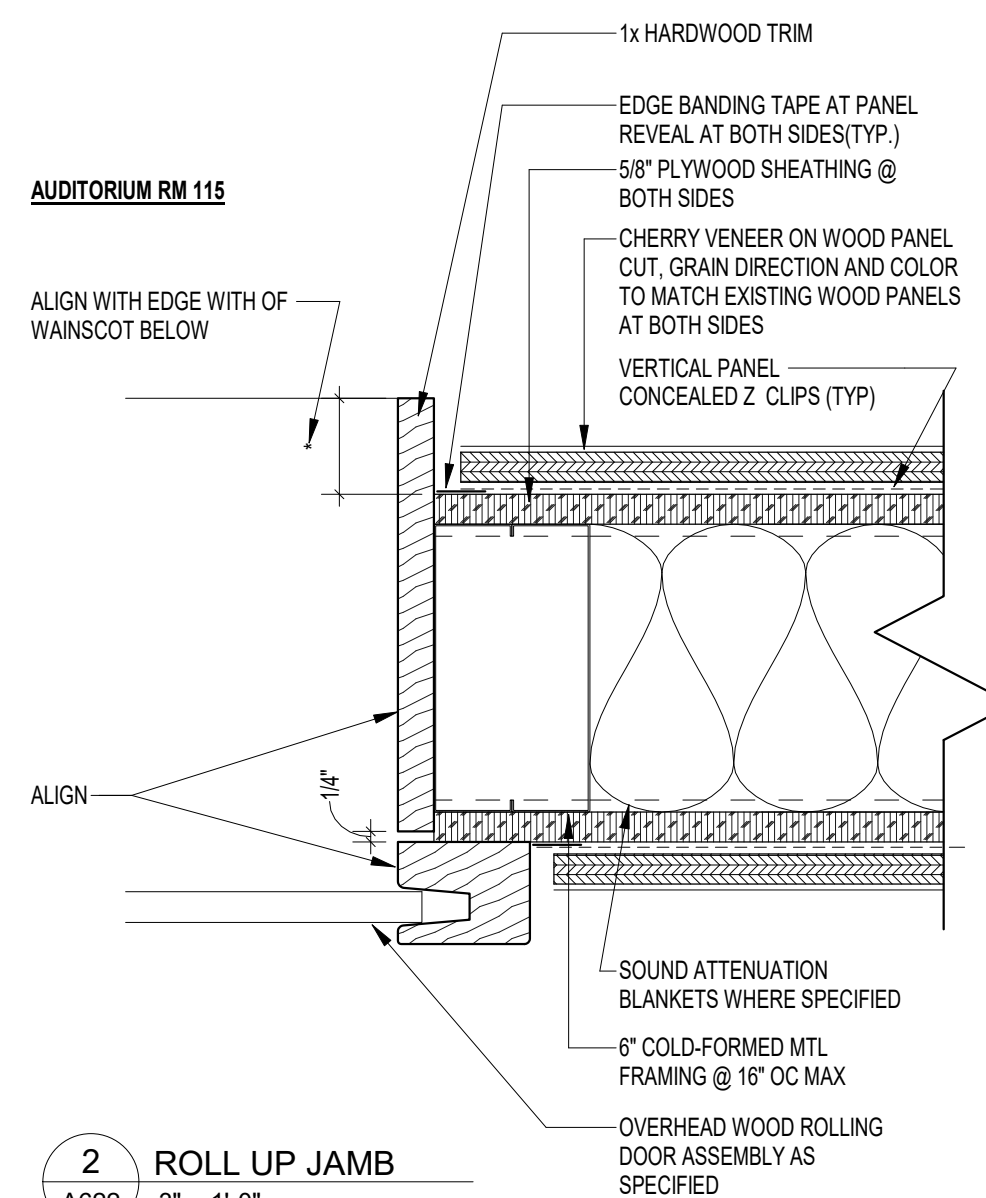


2 ROLL UP JAMB
A622 3" = 1'-0"

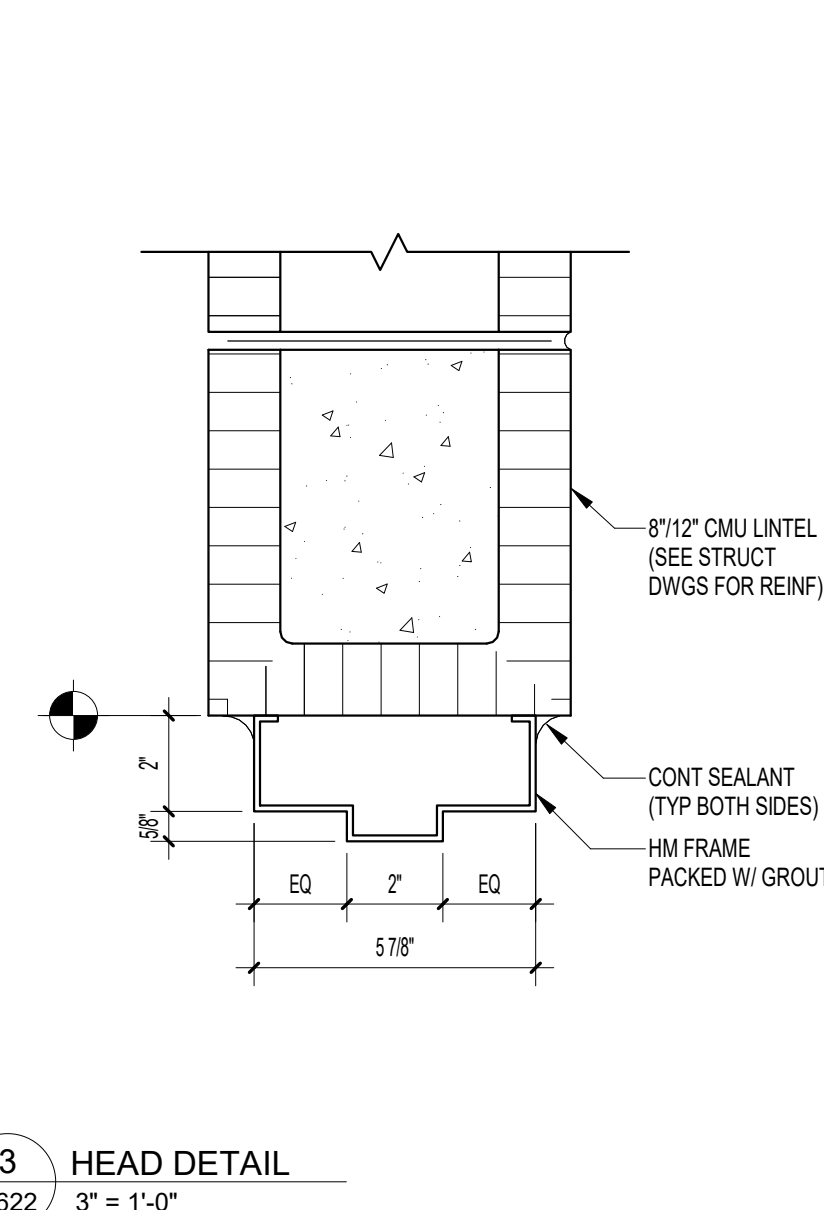


3 HEAD DETAIL
A622 3" = 1'-0"

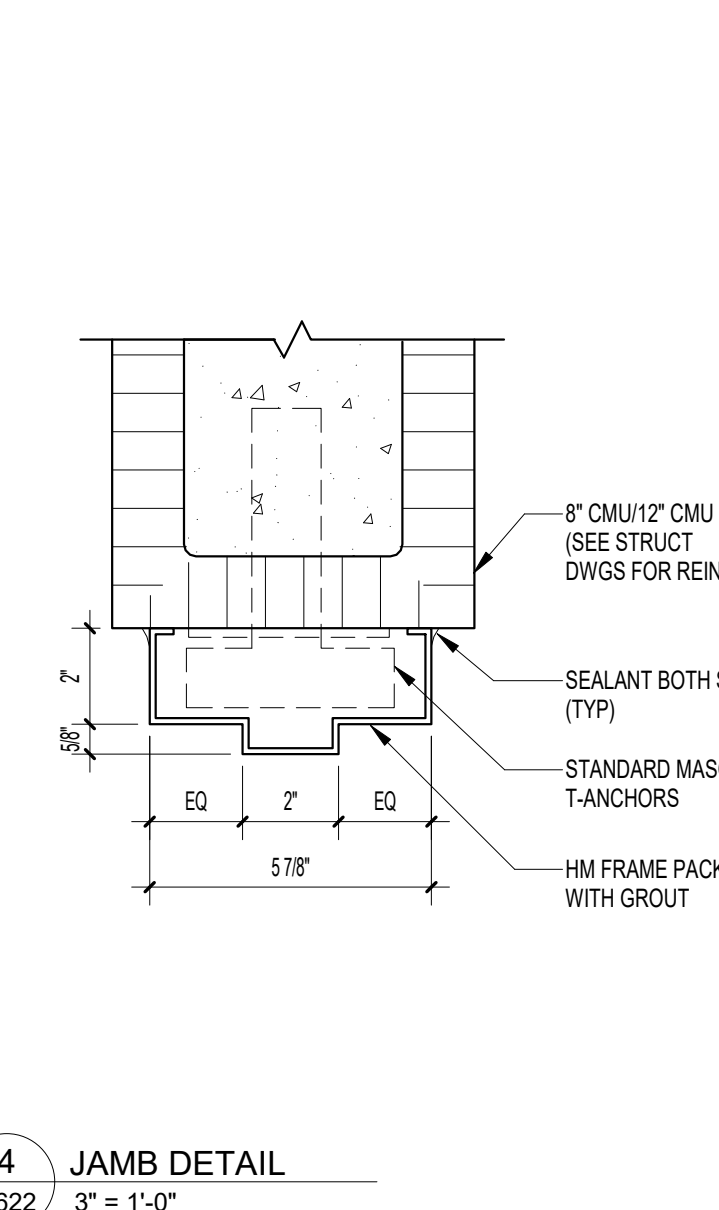


4 JAMB DETAIL
A622 3" = 1'-0"

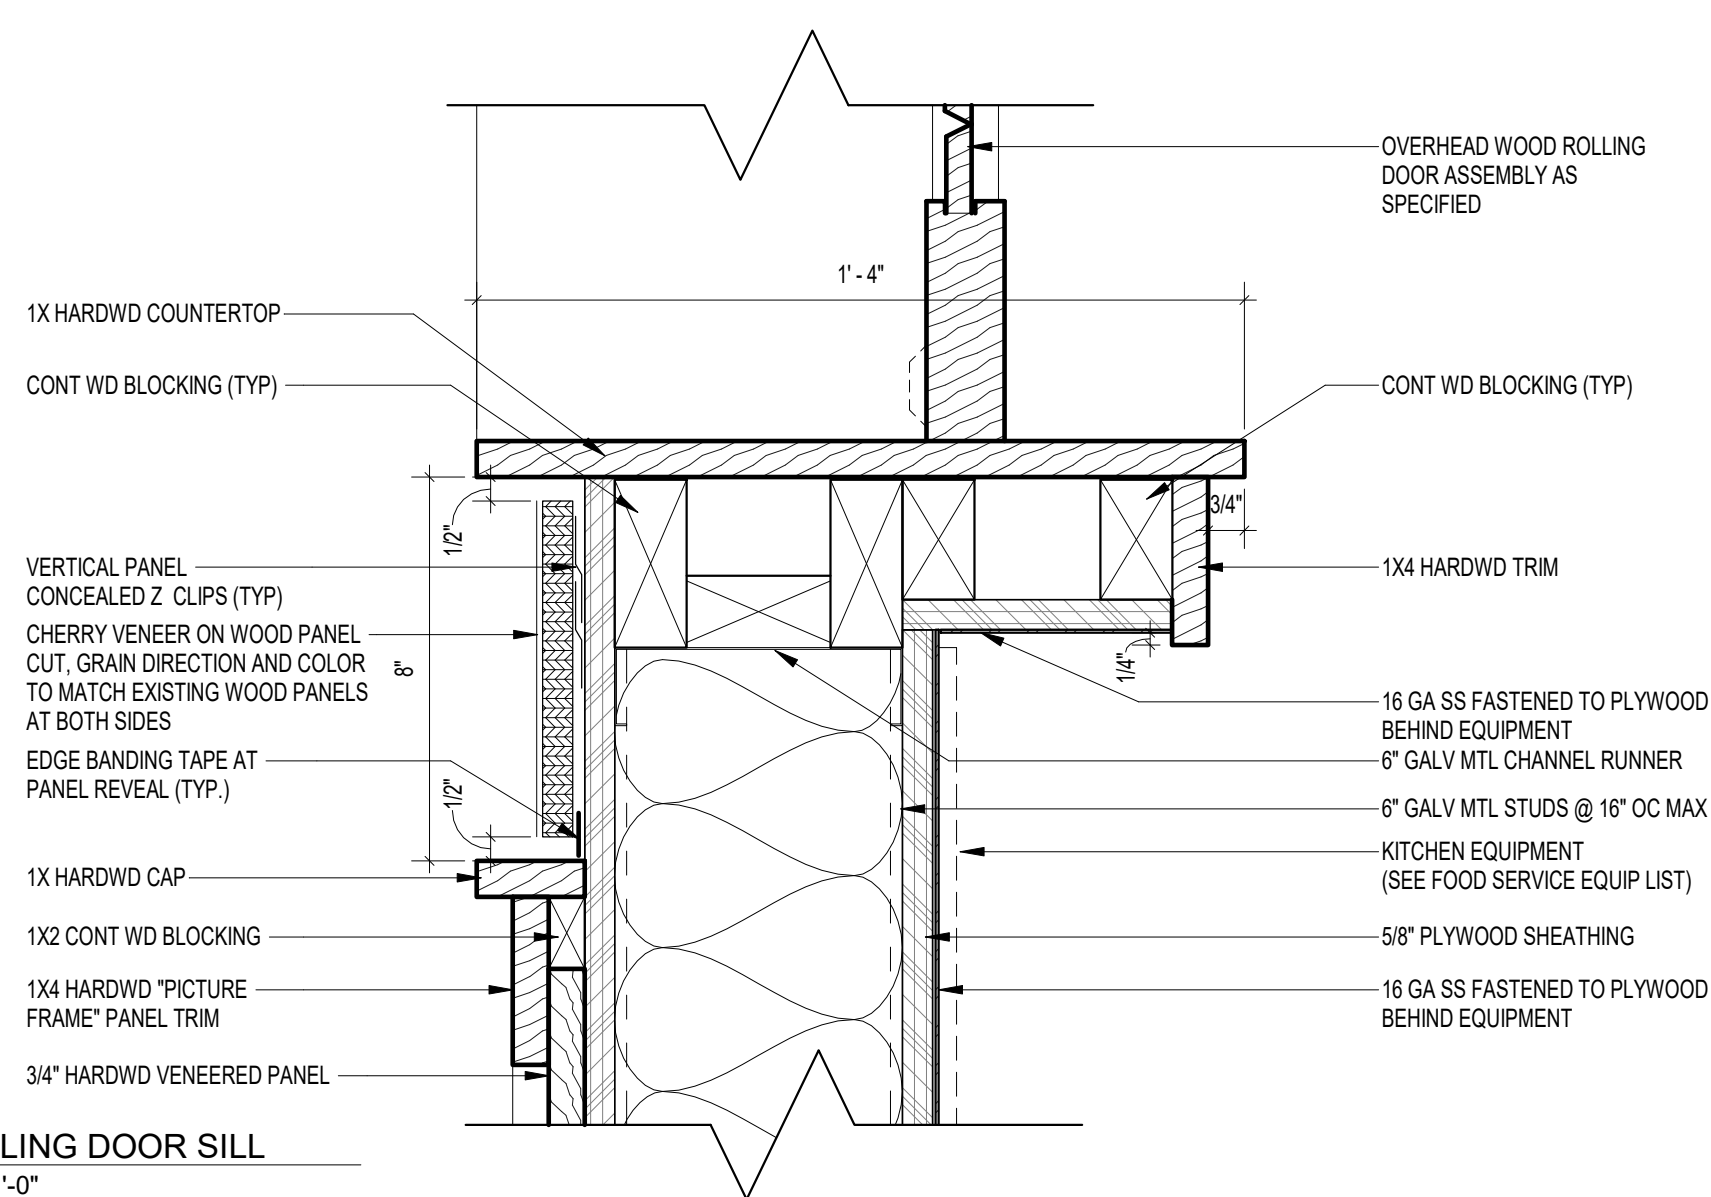


5 ROLLING DOOR SILL
A622 3" = 1'-0"

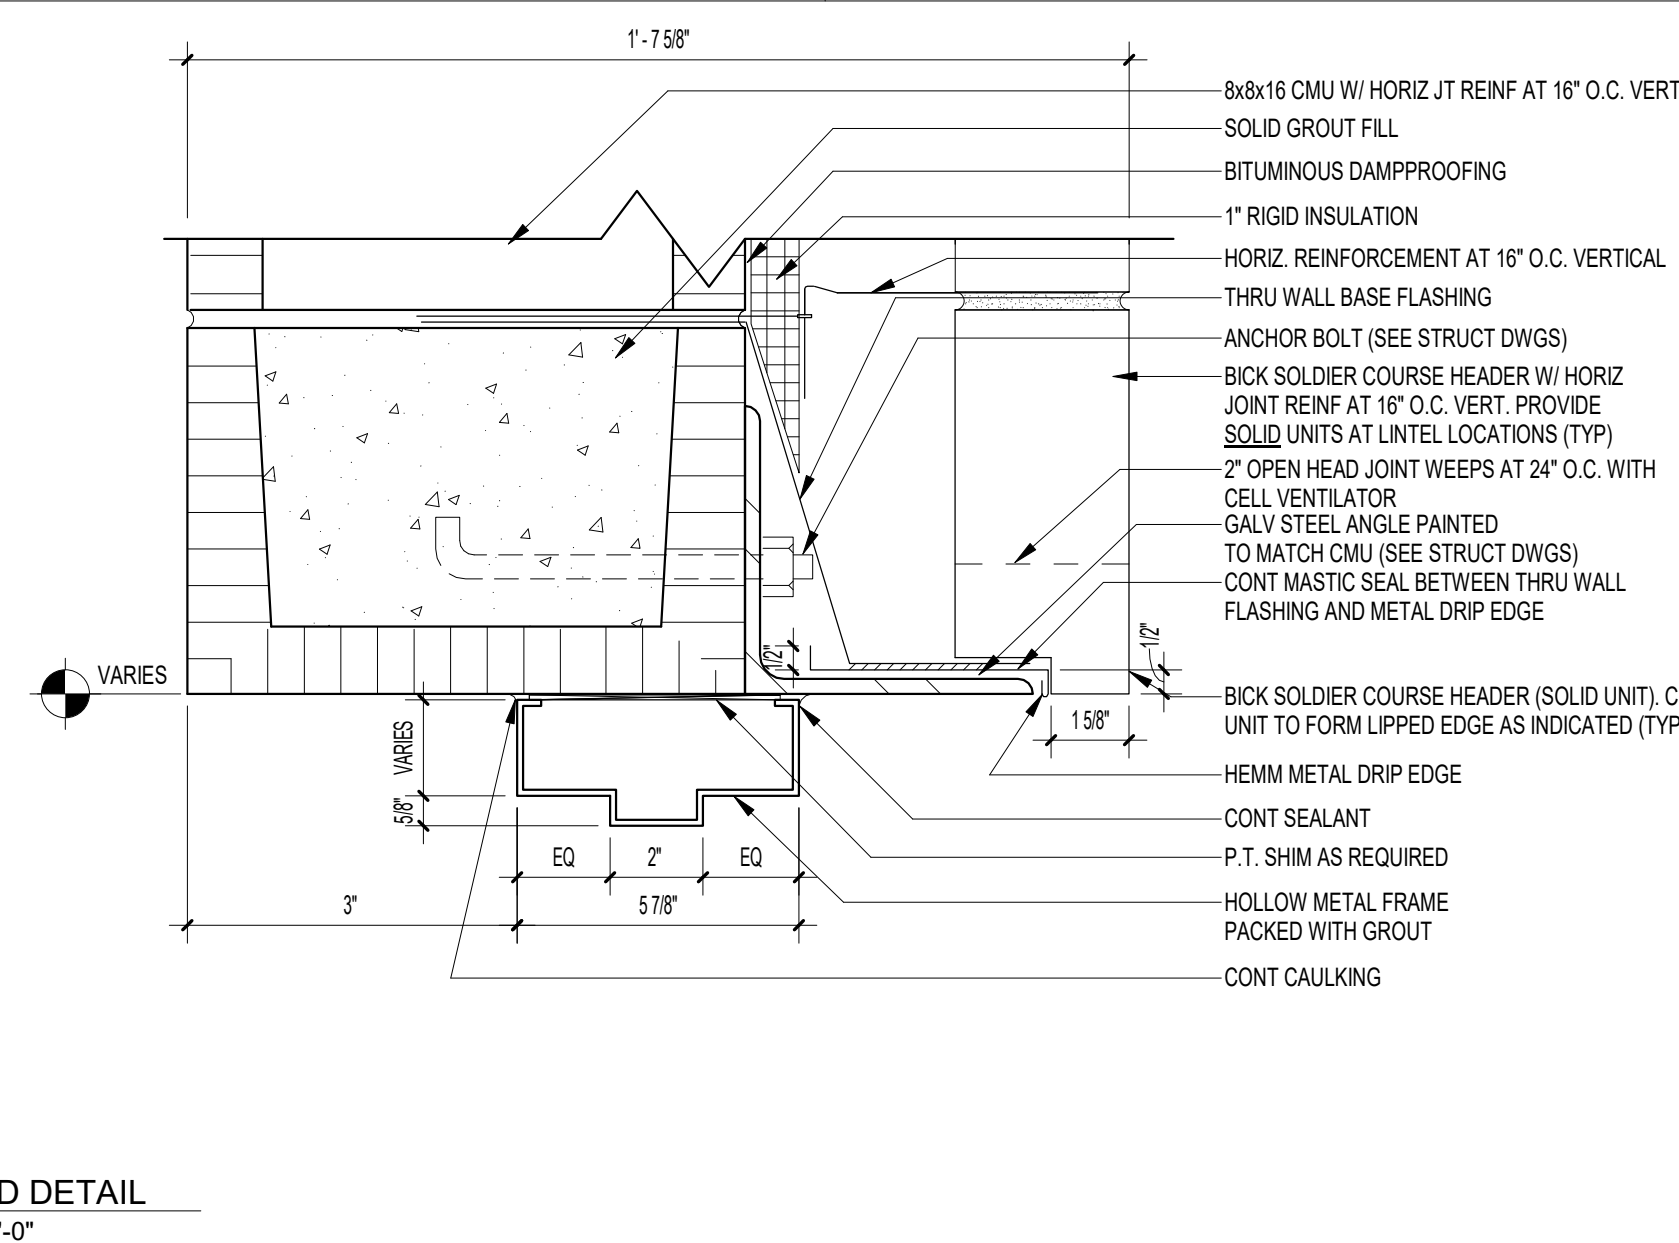


6 HEAD DETAIL
A622 3" = 1'-0"

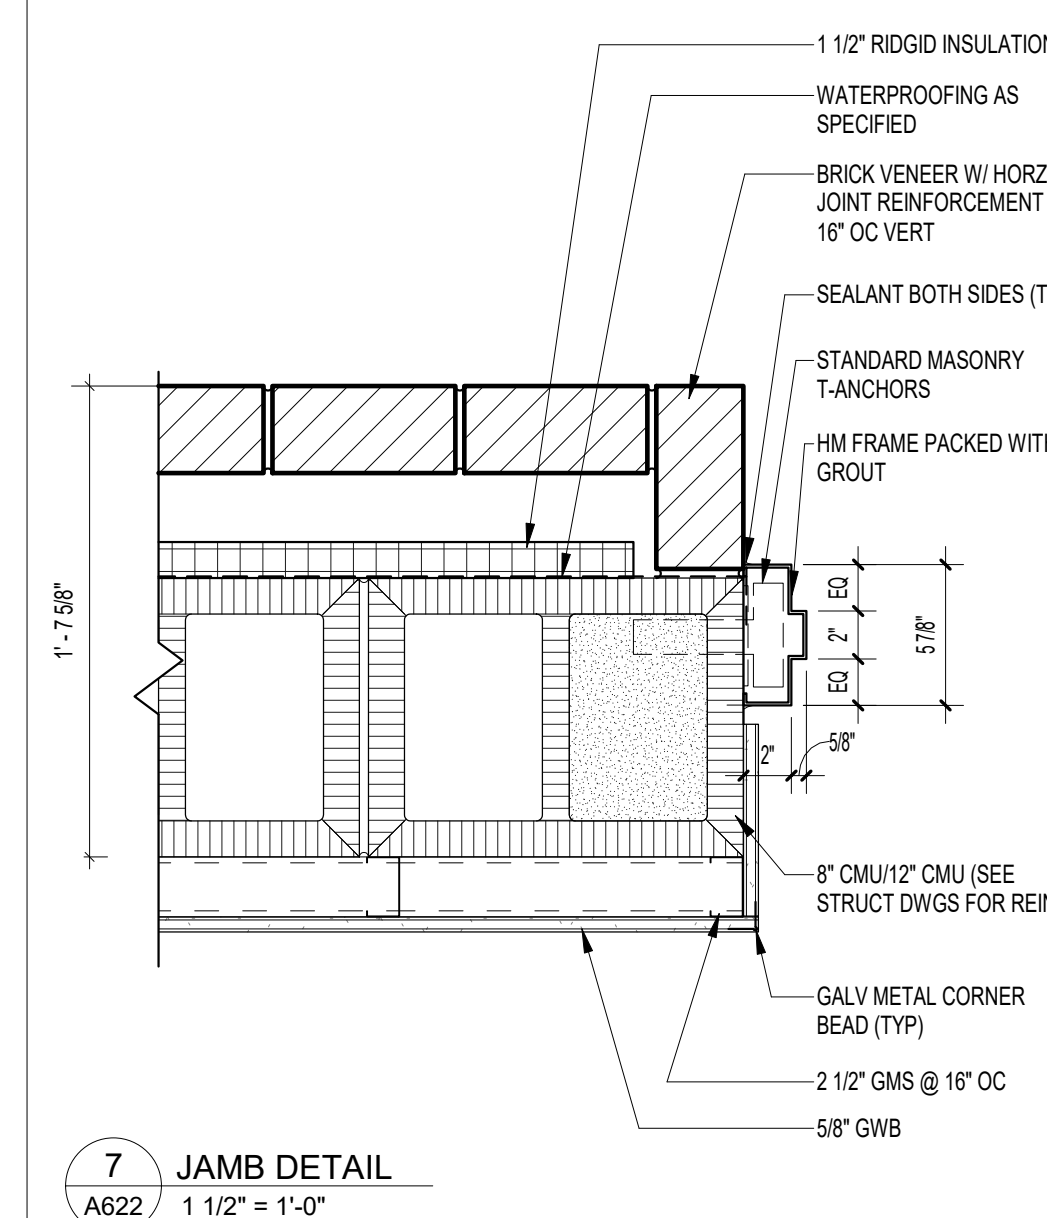


7 JAMB DETAIL
A622 1 1/2" = 1'-0"

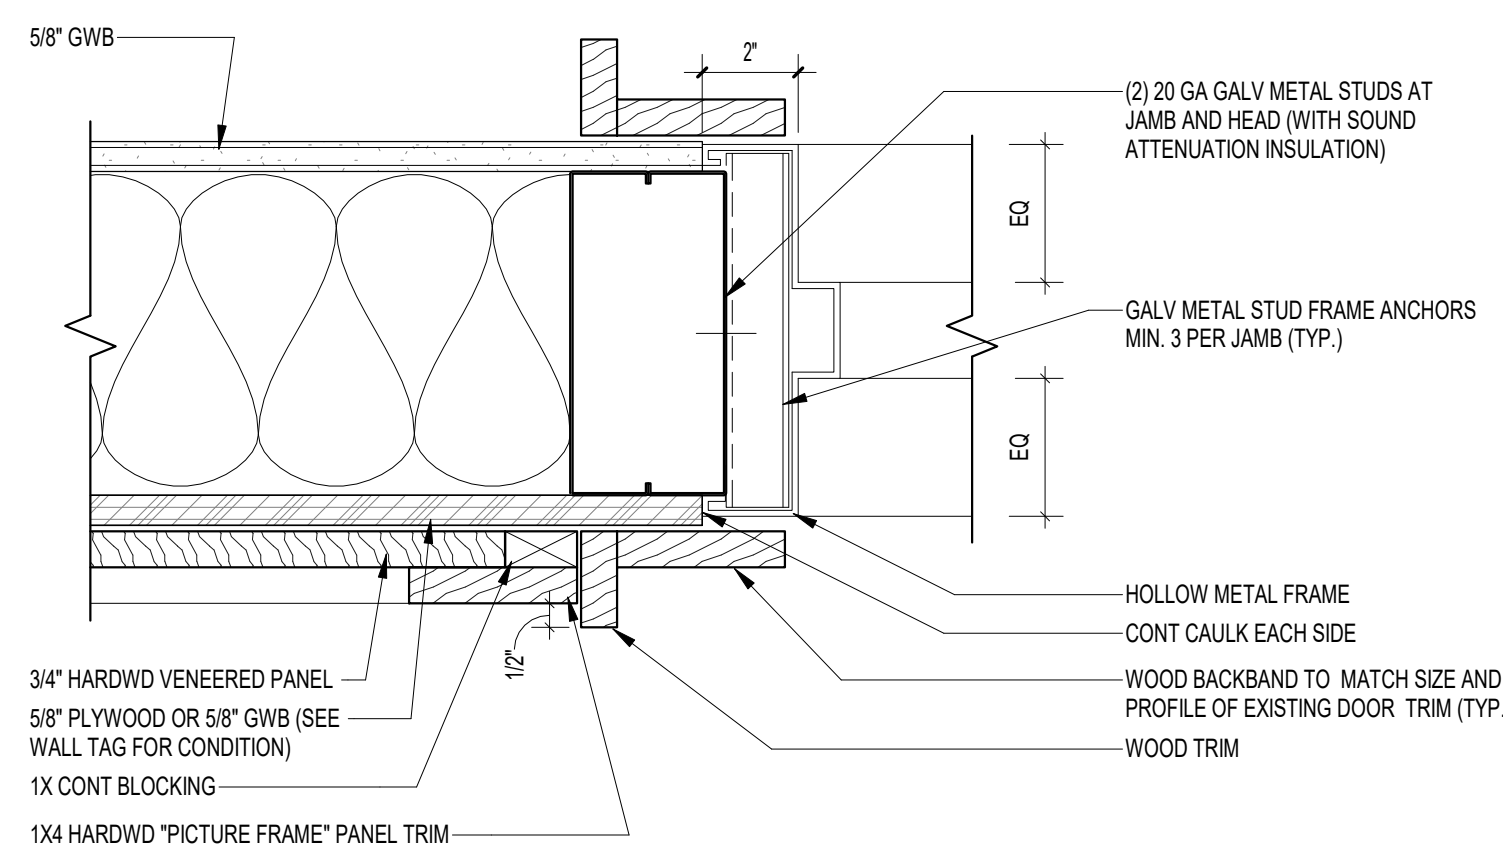


8 WAINSCOT AT DOOR JAMB
A622 3" = 1'-0"

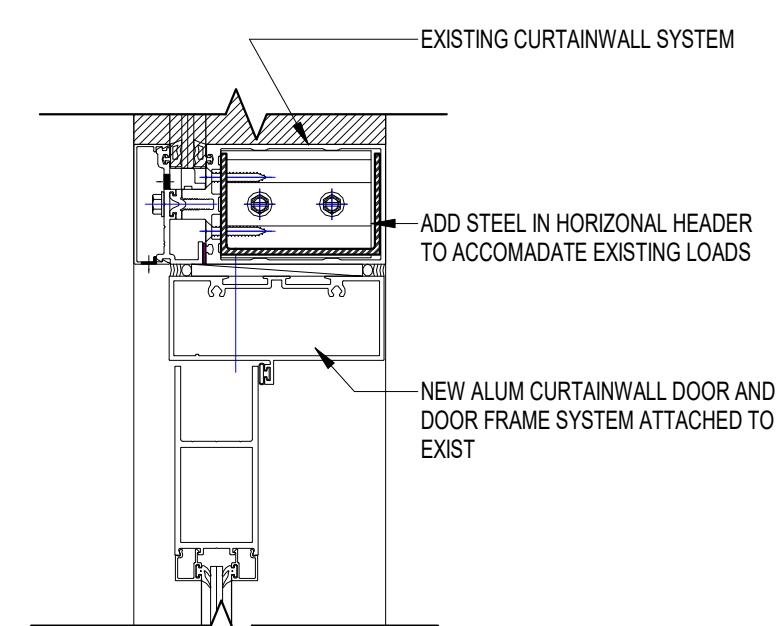


9 CURTAINWALL HEAD DETAIL
A622 3" = 1'-0"

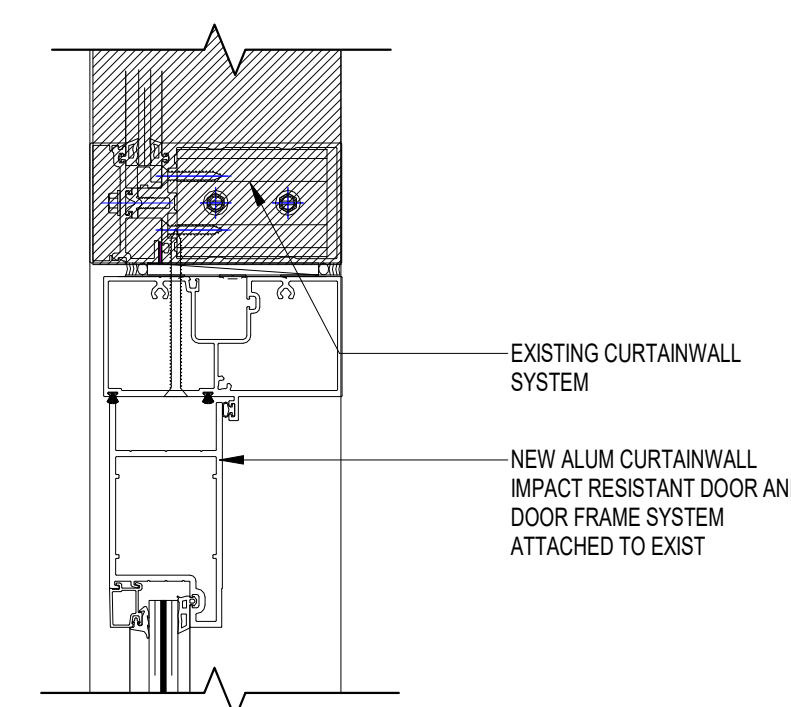

10 CURTAINWALL DETAIL 2
A622 3" = 1'-0"

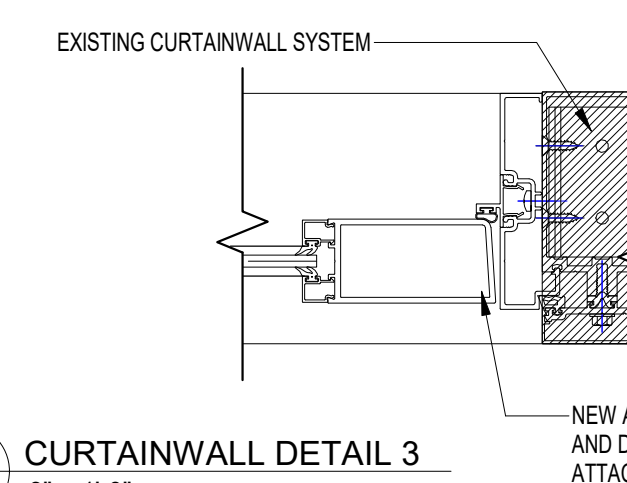

11 CURTAINWALL DETAIL 3
A622 3" = 1'-0"

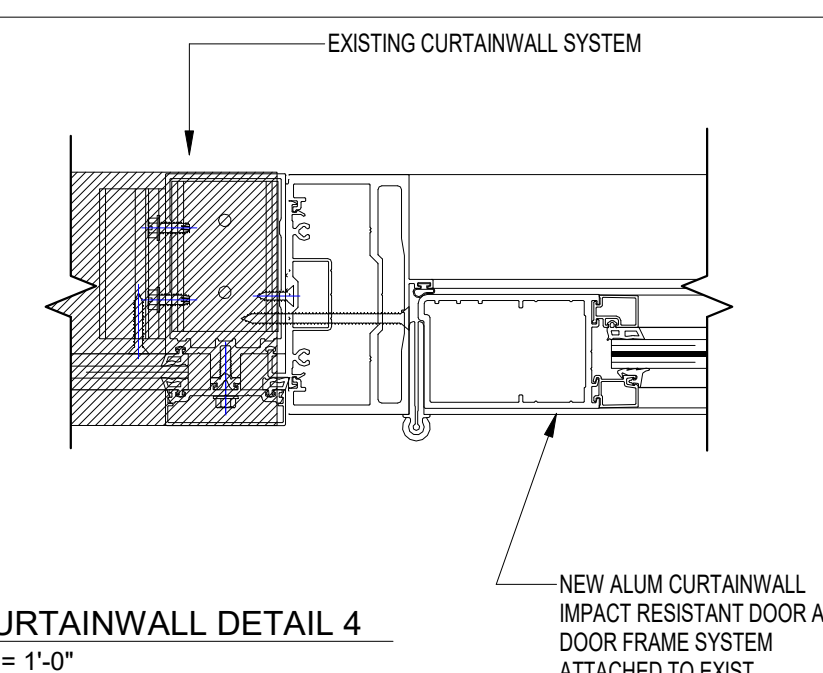

12 CURTAINWALL DETAIL 4
A622 3" = 1'-0"

FSU TURNBULL CONFERENCE CENTER RENOVATIONS

REV	DATE	DESCRIPTION

PROJECT PHASE
CONSTRUCTION DOCUMENTS

DATE
18 OCTOBER 2023

DRAWN BY
Checker

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74000

CHECKED BY
RMP/BI

SHEET TITLE

DOOR AND WINDOW DETAILS

SHEET NO
A622

REV NO

FINISH SCHEDULE DEFINITIONS		
SYM	SURFACE	DEFINITION
CPT	FLOOR	CARPET, CLASS B CERTIFICATE REQUIRED
VCT	FLOOR	VINYL COMPOSITION TILE
CONC	FLOOR	CONCRETE
CONCP	FLOOR	CONCRETE PAINTED WITH EPOXY (REFER TO 09800 - TYPE HPW)
ICC	FLOOR	CONCRETE, WITH INTEGRAL COLOR AND SEALED (REFER TO SPEC FOR DIAMOND POLISH FINISH)
LVT	FLOOR	LUXURY VINYL TILE
SC	FLOOR	SEALED CONCRETE
PT	FLOOR	PORCELAIN TILE
RF	FLOOR	RESINOUS FLOOR
RC	BASE	RUBBER COVERED BASE
WD	BASE	WOOD BASE
RF	BASE	RESINOUS BASE
EXIST	WALL	EXISTING FINISHES TO REMAIN IN PLACE, NO NEW PAINT FINISH.
EXIST - P_	WALL	EXISTING FINISHES TO REMAIN IN PLACE, PAINT AS SCHEDULED.
WDP	WALL	WOOD PANEL SYSTEM
CT	WALL	GLAZED CERAMIC TILE
BPE	WALL	EXPOSED CONCRETE MASONRY UNITS, PAINTED
CONCP	WALL	EXPOSED CONCRETE MASONRY UNITS, PAINTED WITH EPOXY (REFER TO 09960 - TYPE HPW)
CONCPE	WALL	CONCRETE PAINTED
ES	WALL	CONCRETE PAINTED WITH EPOXY (REFER TO 09960 - TYPE HPW)
GP	WALL	EXPOSED STRUCTURE
GPE	WALL	GYPSUM WALLBOARD, PAINTED
AWP	WALL	GYPSUM WALLBOARD, PAINTED WITH EPOXY (REFER TO 09960 - TYPE HPW)
ES	WALL	ACOUSTICAL WALL PANEL WALL
ESP	CEILING	EXPOSED STRUCTURE
GP	CEILING	NO CEILING, PAINT EXPOSED STRUCTURE
GPE	CEILING	GYPSUM WALLBOARD, PAINTED
ACT	CEILING	GYPSUM WALLBOARD PAINTED W/ EPOXY (REFER TO 09960 - TYPE HPW)
ACT	CEILING	ACOUSTICAL CEILING TILE

FINISH SCHEDULE REMARKS	
1.	ALL COMBUSTIBLE MATERIAL INSIDE WATER HEATER CLOSET TO BE PAINTED WITH INTUMESCENT PAINT. SEE FINISH SCHEDULE GENERAL NOTE J.
2.	IF ANY CEILING HEIGHT DISCREPANCIES ARE DISCOVERED NOTIFY ARCHITECT PRIOR TO PROCEEDING WITH ANY RELATED WORK SCOPE.
3.	EPOXY PAINTED WALLS AND FLOORS AT ALL TRASH LOCATIONS.
4.	SHEETROCK TAPED AND FINISHED - NO PAINT. SEE FLOOR PLANS FOR LOCATIONS.
5.	PROVIDE BLOCKING FOR CONTINUOUS ACOUSTICAL WALL PANEL SYSTEM.
6.	PROVIDE PERFORATED GYPSUM WALLBOARD AT CEILING - SEE SPECIFICATION.
7.	PROVIDE ACCENT PAINT COLOR AT SOFFIT AND PILASTERS - TYPICAL AT ALL CORRIDORS.
8.	ANGLED WALLS AT STAGE TO BE PAINTED P-4, SEE ELEVATIONS
9.	CARPET TO MATCH EXISTING CARPET IN AUDITORIUM/DINING ROOM 115.
10.	SEE DEMOLITION AND NEW CONSTRUCTION PLANS FOR EXTENTS OF EXISTING FINISHES TO REMAIN. WALL AND/OR CEILING FINISHES NOTED TO BE PAINTED CAN BE EITHER EXISTING OR NEW. FLOOR FINISHES ARE EITHER NOTED AS EXISTING (TO REMAIN) OR NEW.
11.	SEE REFLECTED CEILING PLAN FOR CEILING HEIGHT CHANGES.
12.	EXISTING WALL FINISHES TO BE PAINTED. COLOR AS SCHEDULED.
13.	SEE ASSOCIATED DETAILS FOR EXACT HEIGHT OF CEILING FINISHES. NEW CEILING FINISH TO ALIGN WITH HORIZONTAL STRUCTURAL SYSTEM.

EXTERIOR COLOR LISTING	
BRICK VENEER	MATCH EXISTING
WINDOWS	MATCH EXISTING
HM DOORS	MATCH EXISTING
HM FRAMES	MATCH EXISTING
ALUM DOORS	MATCH EXISTING
ALUM DOOR FRAMES	MATCH EXISTING
STEEL COLUMNS AND BEAMS	MATCH EXISTING
EXTERIOR HAND RAILS	BLACK (TO BE SELECTED BY OWNER)
EXTERIOR GUARD RAILS	BLACK (TO BE SELECTED BY OWNER)
CAULK @ WINDOWS, CONSTRUCTION JOINTS	MATCH EXISTING
MORTAR	MATCH EXISTING
BRICK TO BRICK JOINTS	MATCH EXISTING
BRICK TO BRICK EXPANSION JOINTS, ETC.	MATCH EXISTING
BRICK PAVERS	MATCH EXISTING

FINISH SCHEDULE GENERAL NOTES	
A.	CARPET - CLASS B CERTIFICATE REQUIRED.
B.	CONCRETE - TROWEL FINISHED, SEALED.
C.	EPOXY PAINT IS SPECIFIED AS A SPECIAL COATING.
D.	REFER TO EXTERIOR ELEVATION SHEETS FOR COLORS OF EXTERIOR HOLLOW METAL DOORS AND FRAMES.
E.	ALL INTERIOR HM DOOR FRAMES SHALL BE PAINTED P-1.
F.	MAXIMIZE CEILING HEIGHTS, TYP.
G.	PAINT METAL FRAME FOR GLAZING IN WOOD DOORS TO MATCH COLOR OF DOOR HM FRAME.
H.	FOR ALL FINISHES, SAMPLES SHALL BE PROVIDED FOR ARCHITECT'S APPROVAL.
I.	JOINTS IN WOOD BASE SHALL BE SCARF CUT NOT BUT CUT (TYP)
J.	ALL DOOR FRAMES TO BE PAINTED TO MATCH EXISTING UNO
K.	PAINT HANDRAILS TO MATCH COLOR OF ADJACENT WALLS
L.	PAINT HIDDEN DOORS TO MATCH COLOR OF ADJACENT WALLS

FINISH SCHEDULE										
RM-NO	RM-NAME	FLR-FIN	BASE	N-FIN	E-FIN	S-FIN	W-FIN	CEILING FINISH	CLG-HT	REMARKS
0101	CORE LOBBY	EXISTING	EXISTING	EXISTING	EXISTING	EXISTING	GP-1, GP-2	EXISTING	11'-4" (+/-)	2, 10
108	AUDITORIUM DINING ROOM	EXISTING (CPT-2)	WD-2	EXIST. - P-2, GP-2	GP-2/GP-3	EXISTING GP-4	EXIST. P-2, GP-2	GP/ACT-1	15'-0" (+/-)	2, 10
113V	VENDING	CPT-2	WD-2	GP-1	GP-6	GP-6	GP-6	GP-6	10'-0"	2, 10
115	CLASSROOM	EXISTING	EXISTING	EXISTING - P-1	EXISTING - P-1	EXISTING - P-1	EXISTING - P-1	EXISTING	12'-6" (+/-)	2, 10, 12
117A	KITCHEN	RF-1, RF-2	RF-2	FRP-1	FRP-1	FRP-1, BPE (P-5)	FRP-1	ACT-2	VARIES	2, 11
117B	BEVERAGE AREA	RF-2	RF-2	FRP-1	FRP-1	FRP-1, BPE (P-5)	FRP-1	ACT-2	10'-0"	2, 11
117C	KITCHEN (COLD PREP)	RF-2	RF-2	FRP-1	FRP-1	FRP-1	FRP-1	ACT-2	12'-6"	2, 11
117D	DISH PIT	RF-2	RF-2	FRP-1	FRP-1	FRP-1	FRP-1	ACT-2	10'-0"	2, 11
117E	KITCHEN ACCESS	RF-2	RF-2	FRP-1	FRP-1	FRP-1	FRP-1	ACT-2	10'-0"	2, 11
117F	KITCHEN RESTROOM	RF-2	RF-2	FRP-1	GPE-1	GPE-1	GPE-1	ACT-2	8'-6"	2
117S	STORAGE	RF-2	RF-2	FRP-1	FRP-1	FRP-1	FRP-1	ACT-2	8'-0"	2
119	RECEIVING & HOLDING	SC	EXISTING	GP-1	GP-1	GP-1	EXISTING	EXISTING	8'-0" (+/-)	2
120	ELEC	EXISTING	EXISTING	EXISTING	EXISTING (GP-1)	EXISTING	EXISTING	EXISTING	8'-0"	2
124	VESTIBULE	CPT-2	WD-2	EXISTING	GP-1	GP-1	GP-1	GP-1	12'-0"	2, 13
124B	VESTIBULE	CPT-2	WD-2	EXISTING	GP-1	GP-1	GP-1	GP-1	12'-0"	2, 13
125	SERVICE AREA	LVT-1	WD-2	WDP-1	WDP-1	WDP-1	WDP-1	GP-1	12'-0"	2, 13
126	ELEC	LVT-1	WD-2	EXISTING	WDP-1	WDP-1	EXISTING	EXISTING	8'-0" (+/-)	2, 10
0200F	CORRIDOR	LVT-1	RC-1	GP-1	EXIST. P-1, GP-1	EXIST. P-1, GP-1	EXIST. P-1, GP-1	ACT-1	10'-0" (+/-)	2, 10
209	JANITOR	EXISTING	RC-1	P-1	EXISTING P-1	P-1	PT-1	EXISTING	8'-6" (+/-)	2, 10
211M	MECHANICAL	SC	RC-1	EXISTING P-1	GP-1	EXISTING P-1	EXISTING P-1	ACT-1	NO CEILING	2, 10
212	STORAGE	CPT-2	RC-1	GP-1	EXIST. P-1, GP-1	EXIST. P-1, GP-1	EXIST. P-1, GP-1	ACT-1	12'-6" (+/-)	2, 10
213	STORAGE	CPT-2	RC-1	GP-1	EXISTING P-1	GP-1	GP-1	ACT-1	10'-0" (+/-)	2, 10
213A	STAGING AREA	CPT-2	RC-1	EXIST. P-1, GP-1	EXIST. P-1, GP-1	EXIST. P-1, GP-1	EXIST. P-1, GP-1	ACT-1	10'-0" (+/-)	2, 10
214	CLASSROOM	CPT-2	MATCH EXISTING	EXISTING P-1	EXISTING P-1	GP-1	EXISTING P-1	EXISTING (ACT-1)	12'-6" (+/-)	2, 10
852	ELEVATOR MACHINE ROOM	SC	RC-1	GP-1	GP-1	EXISTING P-1	GP-1	GP-1	8'-0" (+/-)	2, 10
8301	STAIR	EXISTING	EXISTING	EXISTING BP-1	EXISTING BP-1	EXISTING	EXISTING	EXISTING	15'-0" (+/-)	3


INTERIOR COLOR LISTING					
MATERIAL	MANUFACTURER	STYLE	COLOR	COLOR # / SIZE	
PAINT					
P-1	SHERWIN WILLIAMS	TO MATCH EXISTING CORRIDOR + CLASSROOM WALLS	ARCHITECT & OWNER TO CONFIRM	-	-
P-2	SHERWIN WILLIAMS	TO MATCH EXISTING DINING ROOM WALLS	ARCHITECT & OWNER TO CONFIRM	-	-
P-3	SHERWIN WILLIAMS	TO MATCH EXISTING ENTRY WAYS	ARCHITECT & OWNER TO CONFIRM	-	-
P-4	SHERWIN WILLIAMS	TO MATCH EXISTING 2 ND FLOOR STAGE	IRON ONE (MATCH FLOOR)	GW 7069	-
P-5	SHERWIN WILLIAMS	TO MATCH FRP PANEL FINISH	ARCHITECT & OWNER TO CONFIRM	-	-
P-6	SHERWIN WILLIAMS	TO MATCH EXISTING TOUPE ACCENT COLOR	ARCHITECT & OWNER TO CONFIRM	-	-
ACOUSTICAL CEILING TILE					
ACT-1	ARMSTRONG	OPTIMA	WHITE	3152	
ACT-2	ARMSTRONG	KITCHEN ZONE	WHITE	898	
WOOD BASE AND CHAIR RAIL					
WD-1 (STAGE WD BASE BOARDS & TRIM)	SHERWIN WILLIAMS	WATER BASED MANGONNY WOOD STAIN	EBONY		
WD-2 (ALL OTHER ITEMS)	SHERWIN WILLIAMS	WATER BASED CHERRY WOOD STAIN	NATURAL		
SEALED CONCRETE FLOORING					
SC-1					
CARPET					
CPT-1	TANDUS CENTIVA	PLEXUS COLOUR III	DARK SHADOW	18552	
CPT-2	MANNINGTON COMMERCIAL (EXISTING)	VALLEY FOLD	ROOSTER	75390	
RESINOUS FLOORING					
RF-1	DUR-A-FLEX	POLY-CRETE SLB	TF-PLUS GREY	GREY	
RF-2	DUR-A-FLEX	POLY-CRETE SLB	ARMOR TOP GLOSS WITH GRIT	LIGHT GREY	
FRP PANEL					
FR-1	MARLITE	STANDARD FRP	P100 WHITE	SURFACED PEBBLED FINISH	
WOOD PANEL SYSTEM					
WDP-1		PANELING W/ WOOD VENEER	CHERRY	MATCH EXISTING	
LVT					
LVT-1	MANNINGTON COMMERCIAL	GROOVE	VELVET	C148 (12X24")	
RUBBER BASE					
RC-1	JOHNSONITE	MATCH EXISTING CORRIDOR	ARCHITECT & OWNER TO CONFIRM	-	-



ARCHITECTURE
PLANNING INTERIORS
GRAPHICS

ELLIOTT MARSHALL BINES PA. (EMI architects)
251 E. 7TH AVENUE TALLAHASSEE FL 32303
(850) 222-7442
www.emiarch.com
LICENSE #A-AC-000409 IB C000153

NOTE:
11" x 17" SHEETS ARE PLOTTED AT 1/2
THE SCALE NOTED ON THESE DRAWINGS

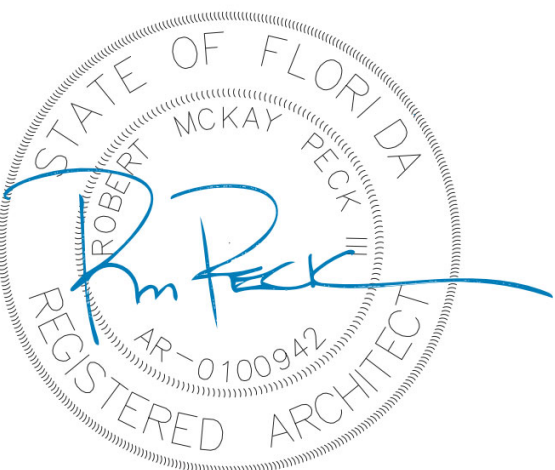

FSU TURNBULL
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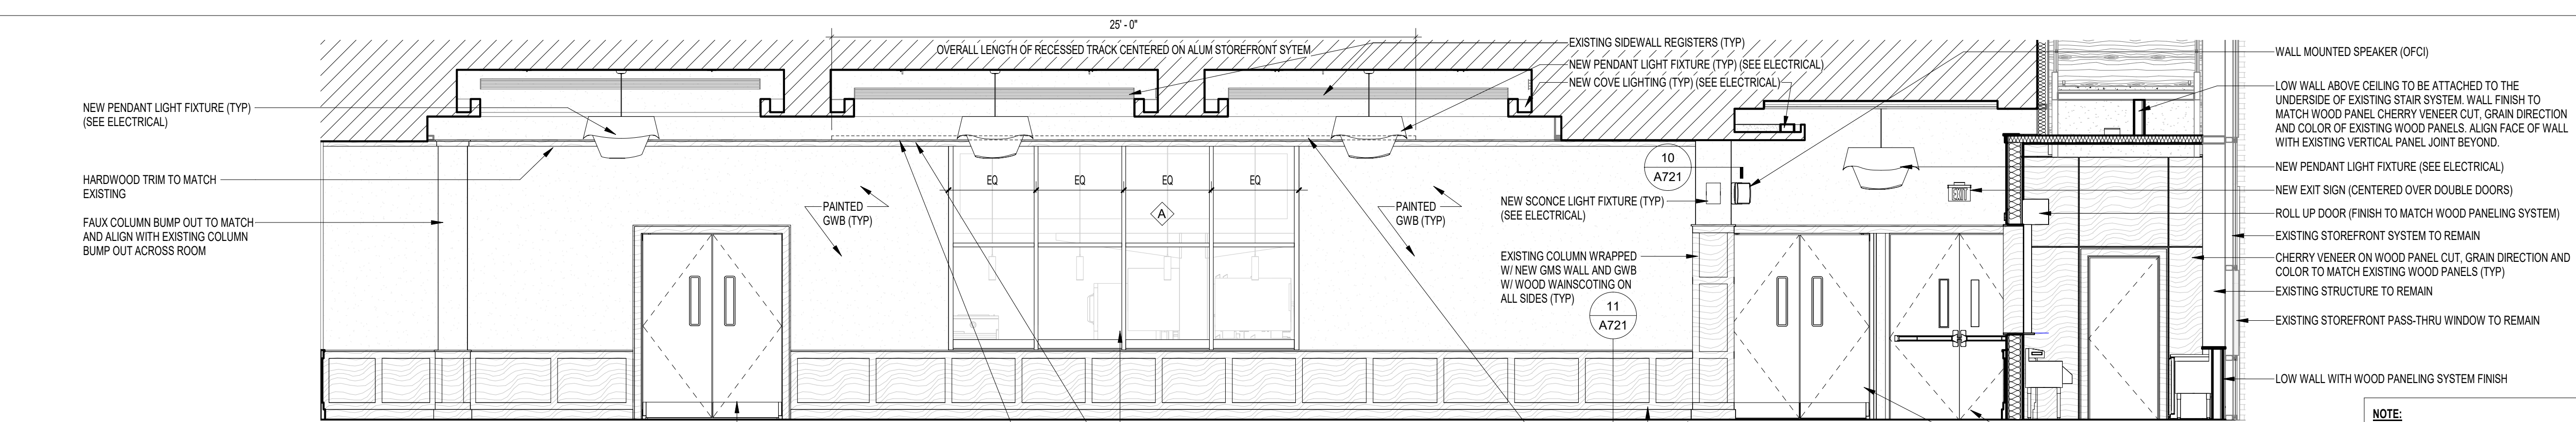
SHEET TITLE
FINISH SCHEDULE,
NOTES AND COLOR
LISTINGS

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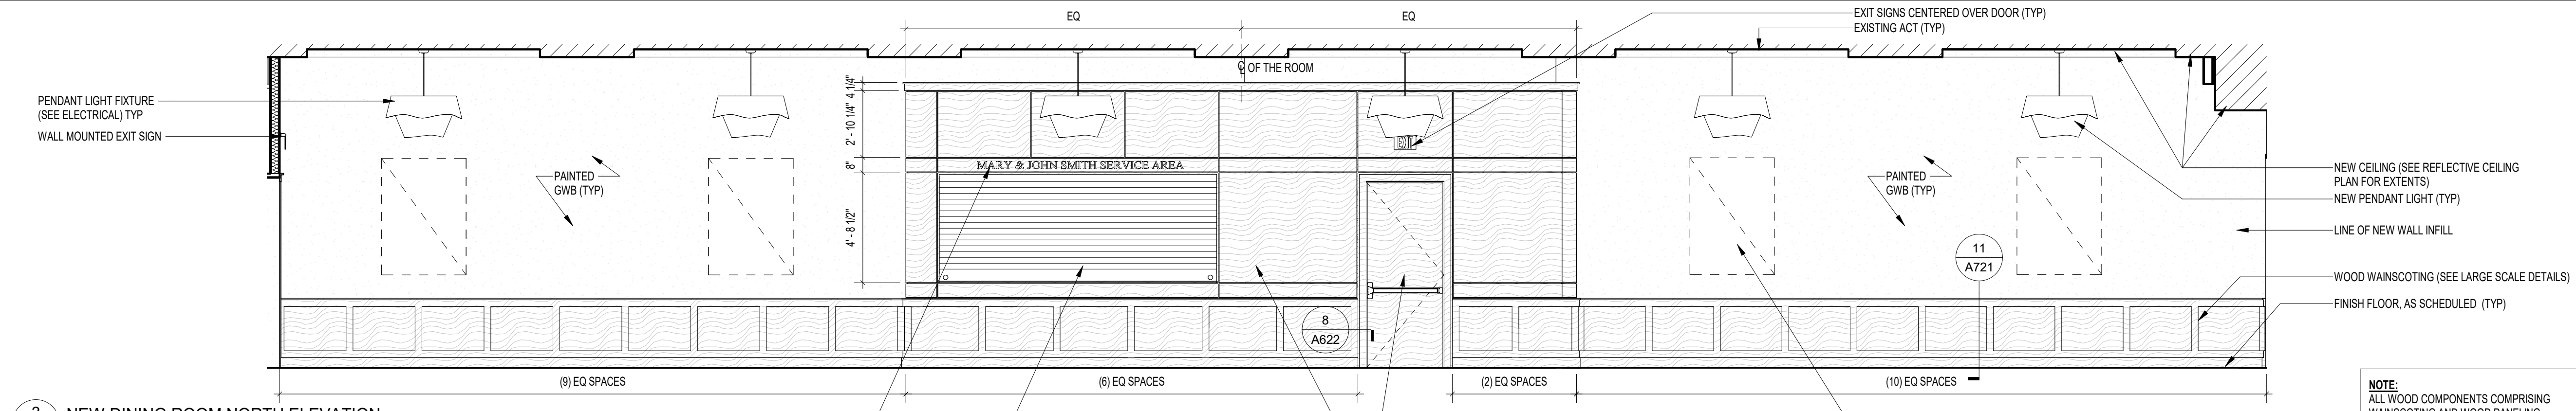
SHEET NO
A641

REVISION NO
1



2
A701 NEW DINING ROOM WEST ELEVATION
1/4" = 1'-0"

NOTE:
ALL WOOD COMPONENTS COMPRISING WAINSCOTING AND WOOD PANELING SYSTEM SHALL BE FIRE RATED AND MEET A MINIMUM FLAME SPREAD RATING OF CLASS B



3
A701 NEW DINING ROOM NORTH ELEVATION
1/4" = 1'-0"


NOTE:
LETTERING INDICATED IS A PLACE HOLDER OWNER TO CONFIRM HEIGHT, STYLE AND CONTENT. CENTER LETTERING ABOVE OPENING BELOW

CHERRY VENEER ON WOOD PANEL CUT, GRAIN DIRECTION AND COLOR TO MATCH EXISTING WOOD PANELS (TYP)
ROLL UP DOOR AS SPECIFIED

NEW DOOR AS SCHEDULED (FINISH TO MATCH WOOD PANEL SYSTEM GRAIN DIRECTION AND COLOR)
ART NIC (OFCI) TYP

NOTE:
ALL WOOD COMPONENTS COMPRISING WAINSCOTING AND WOOD PANELING SYSTEM SHALL BE FIRE RATED AND MEET A MINIMUM FLAME SPREAD RATING OF CLASS B

NOTE:
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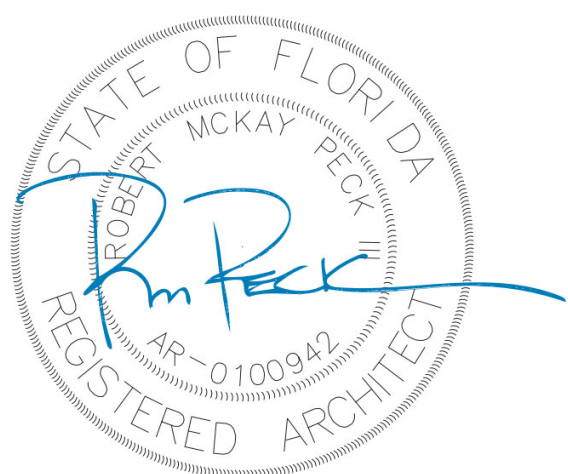
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PROJECT NO	74000	CHECKED BY	RMP/BI

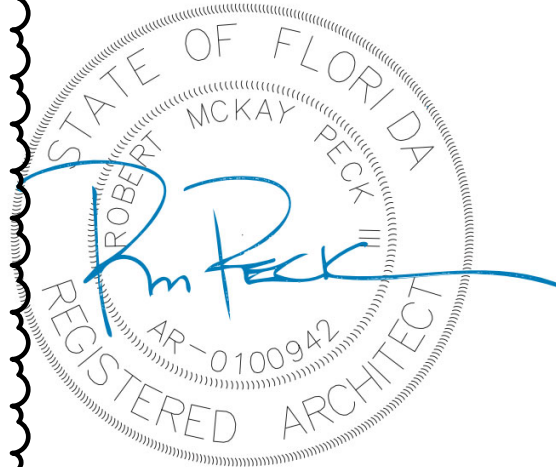SHEET TITLE
INTERIOR ELEVATIONS

SHEET NO	A701	REV NO	1
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REV	DATE	DESCRIPTION
1	04.17.24	FSU PERMIT

PROJECT PHASE
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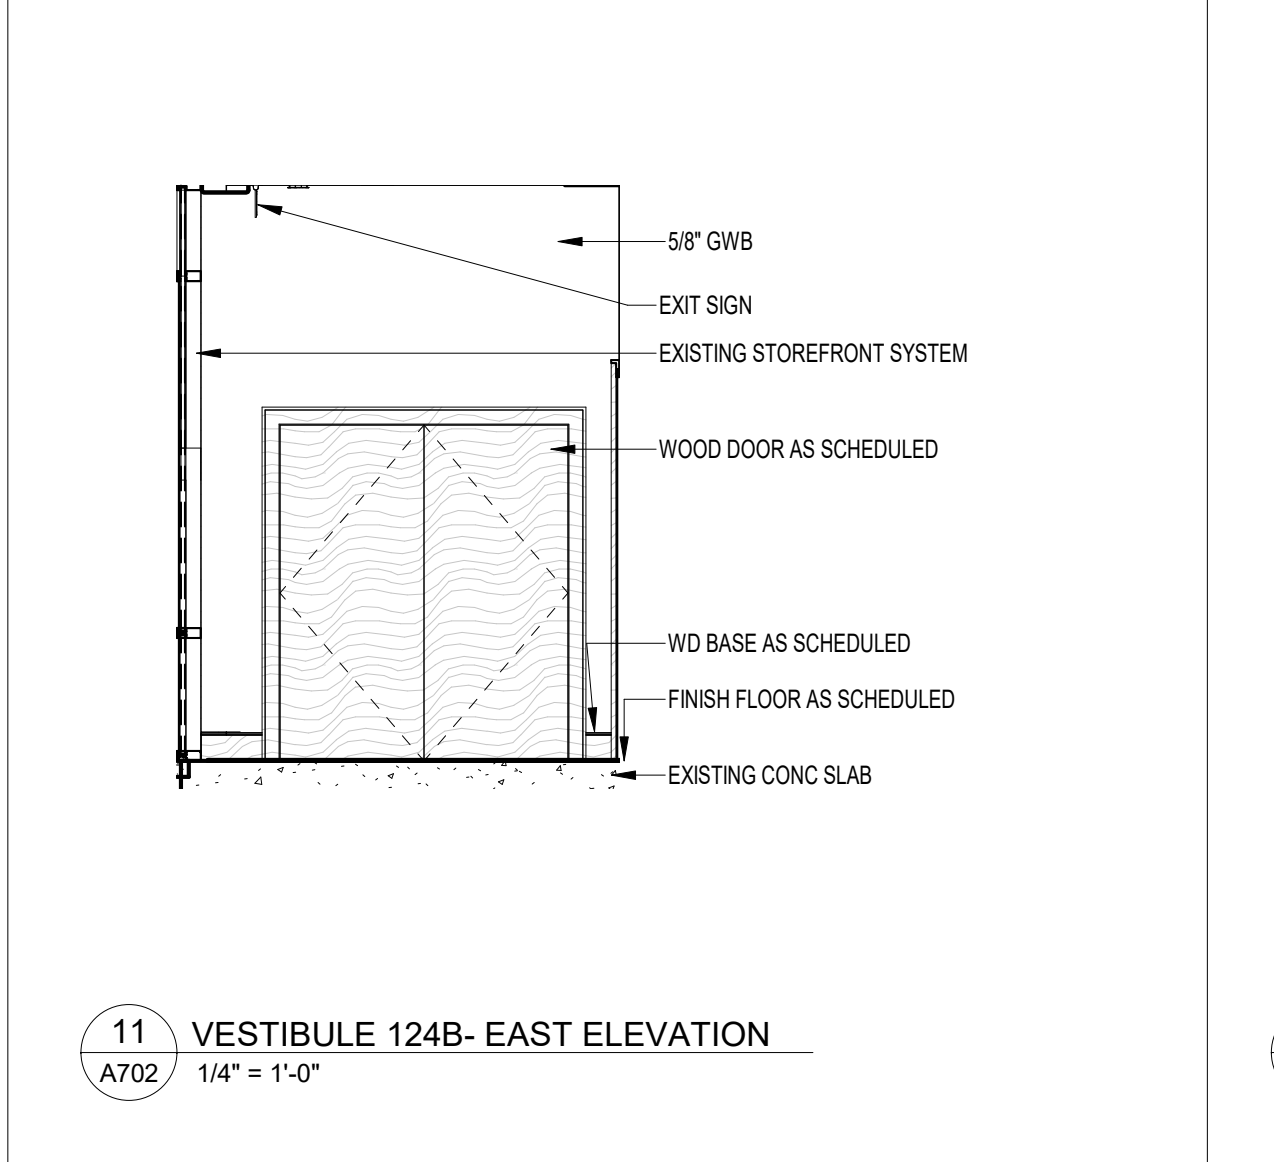
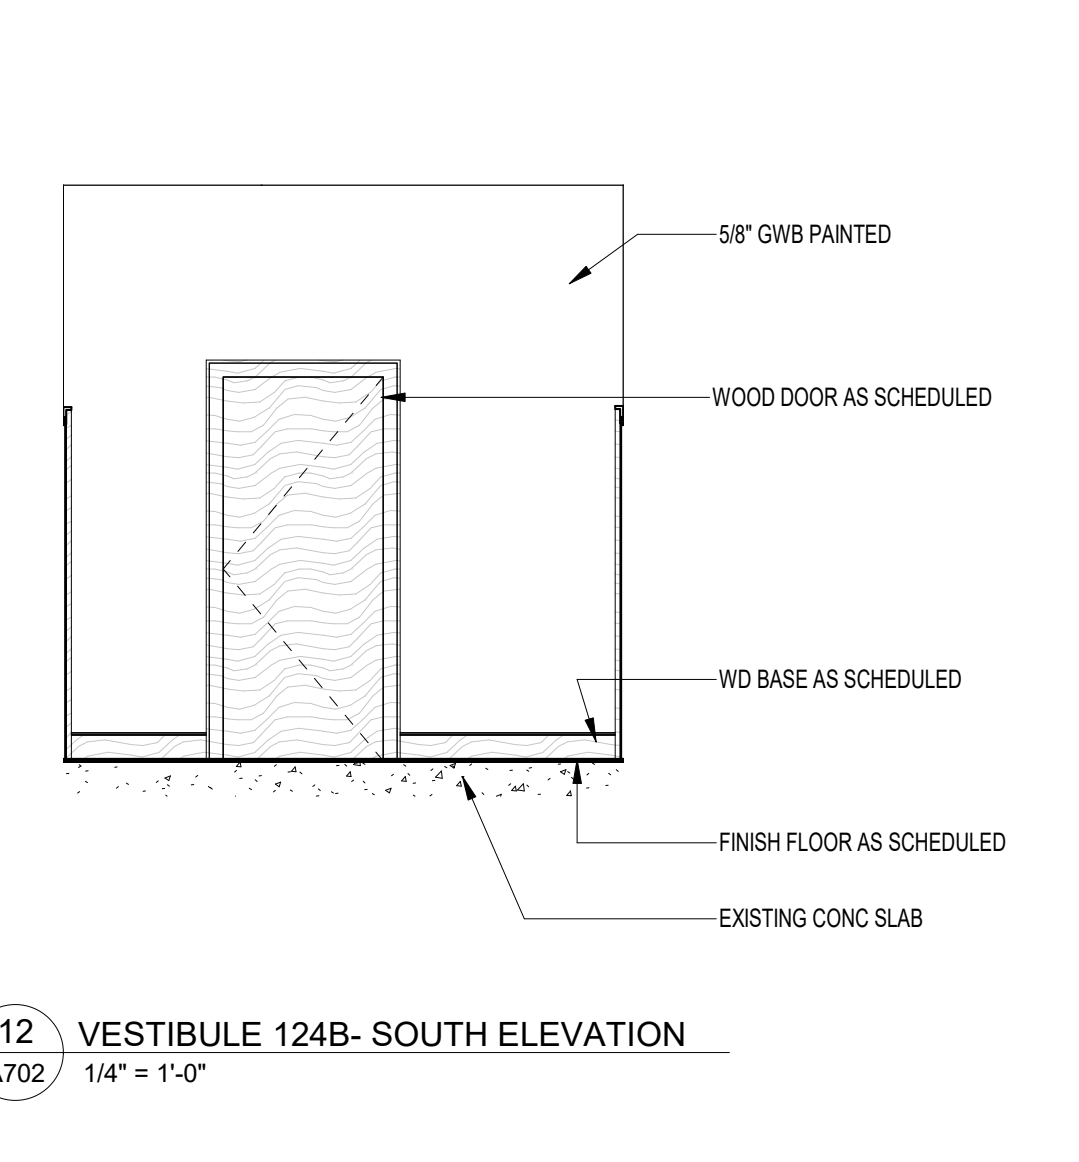
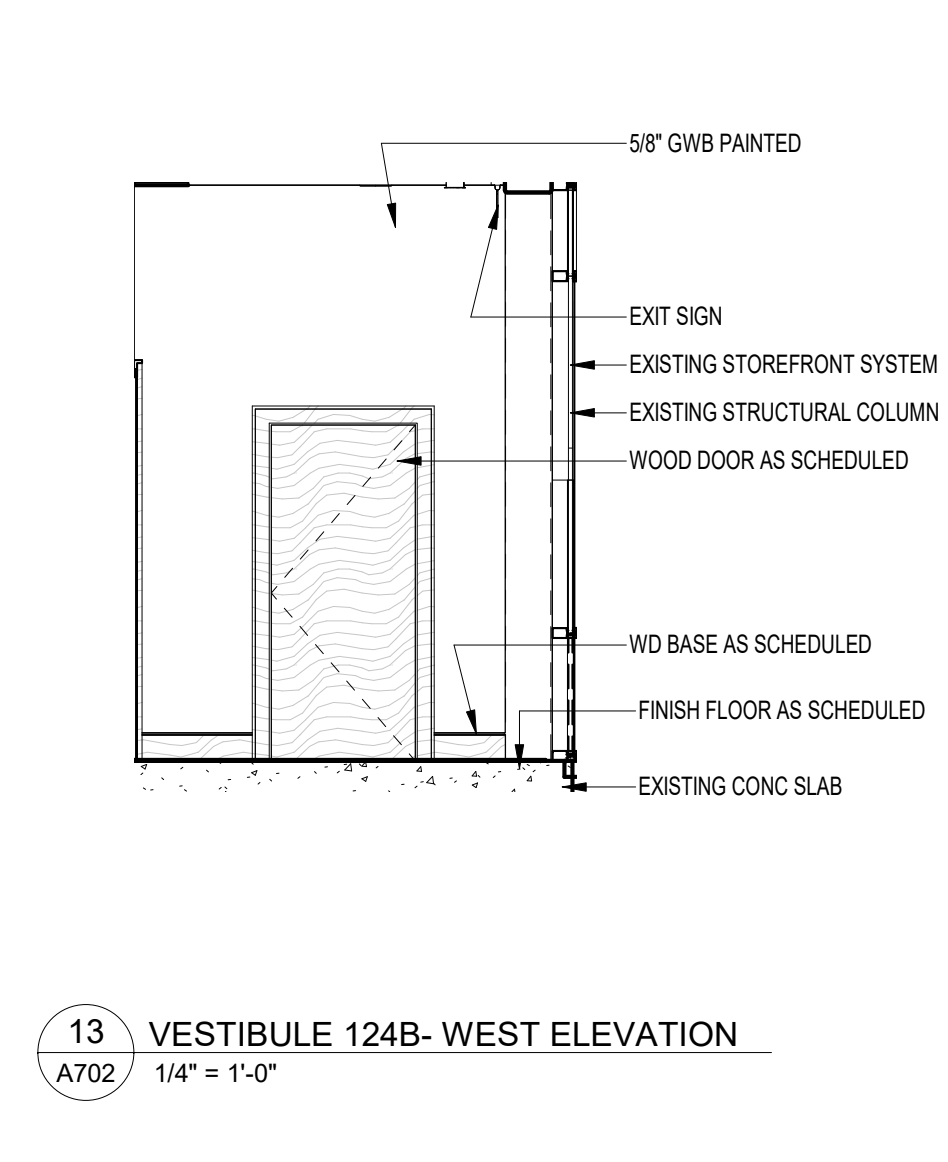
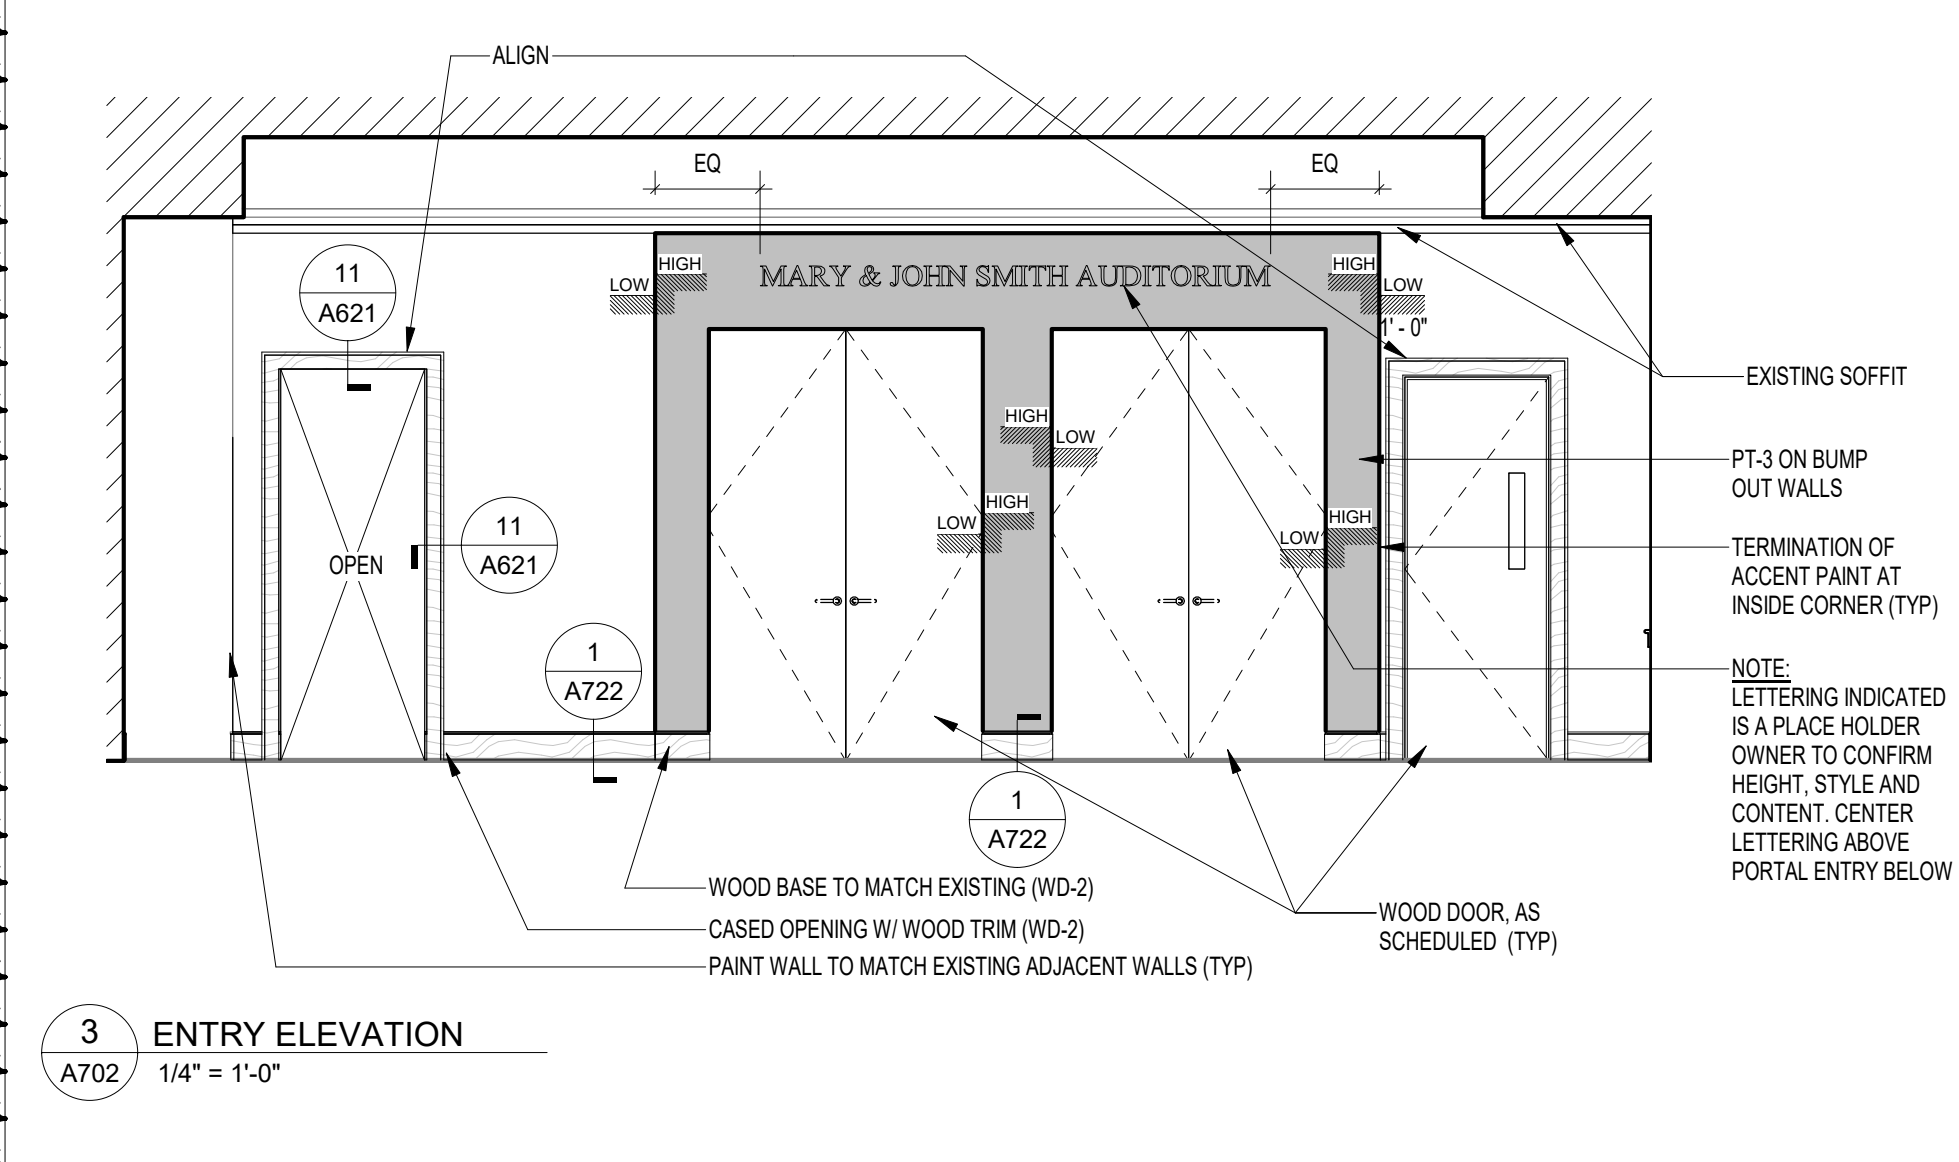
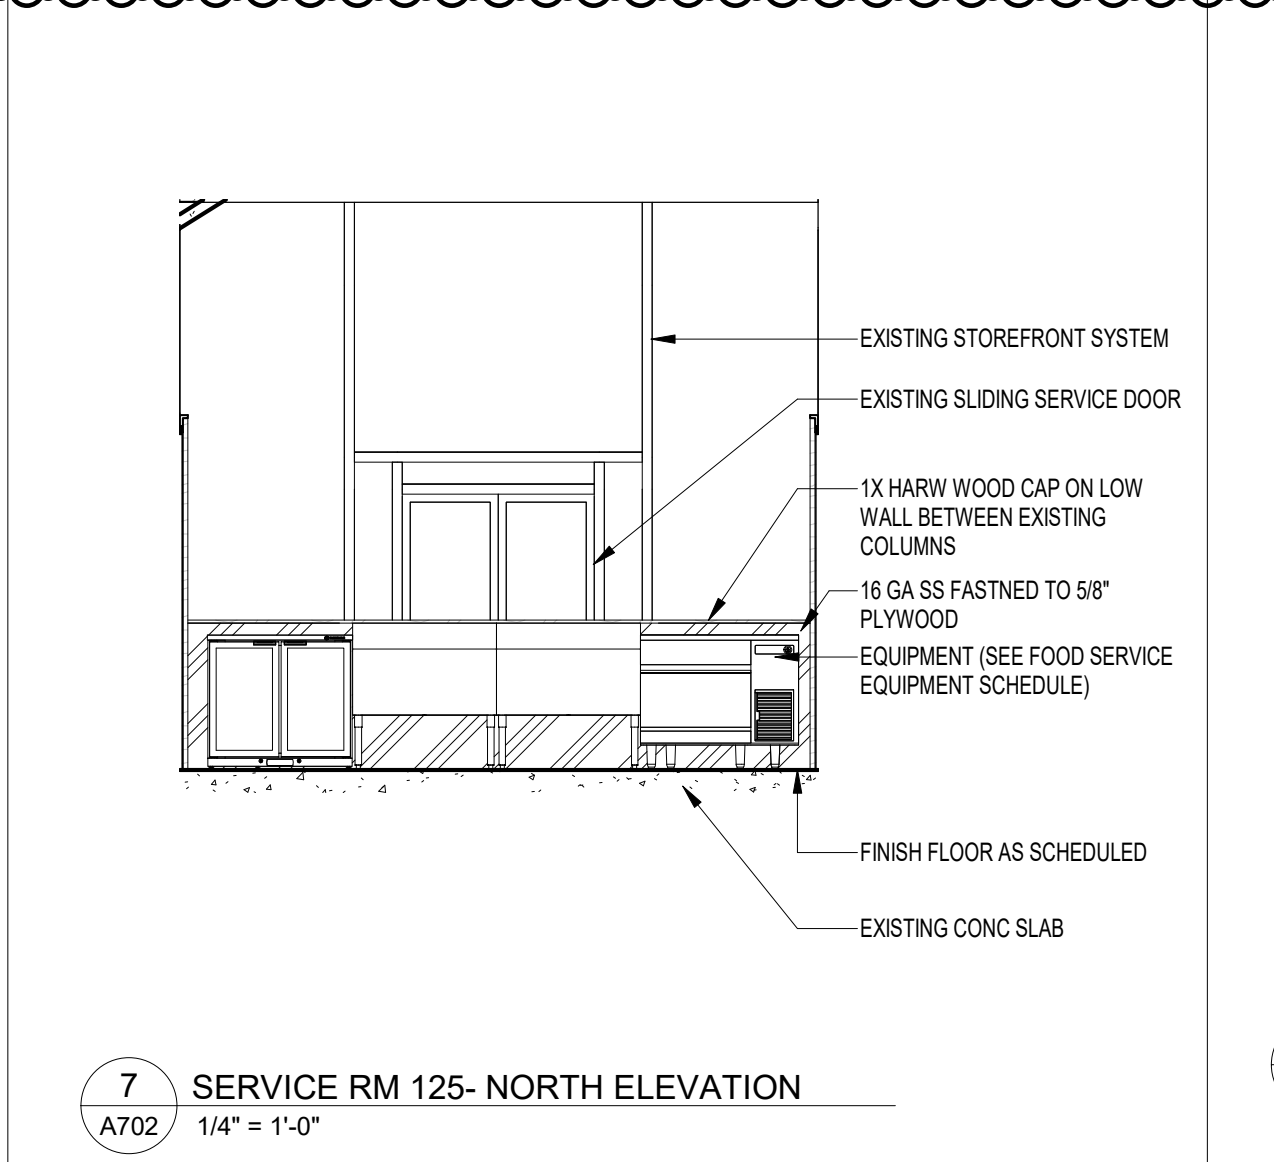
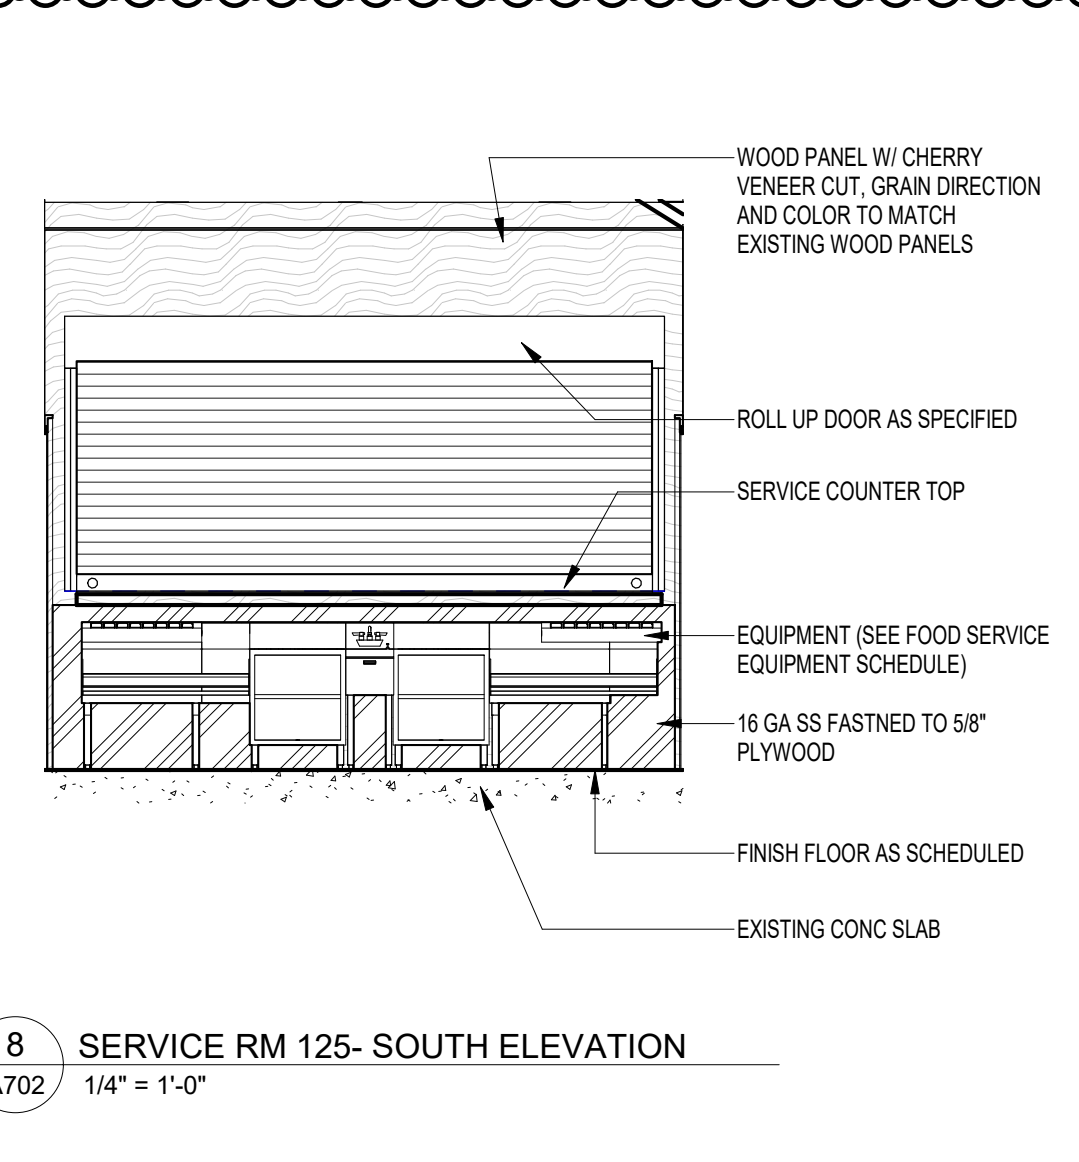
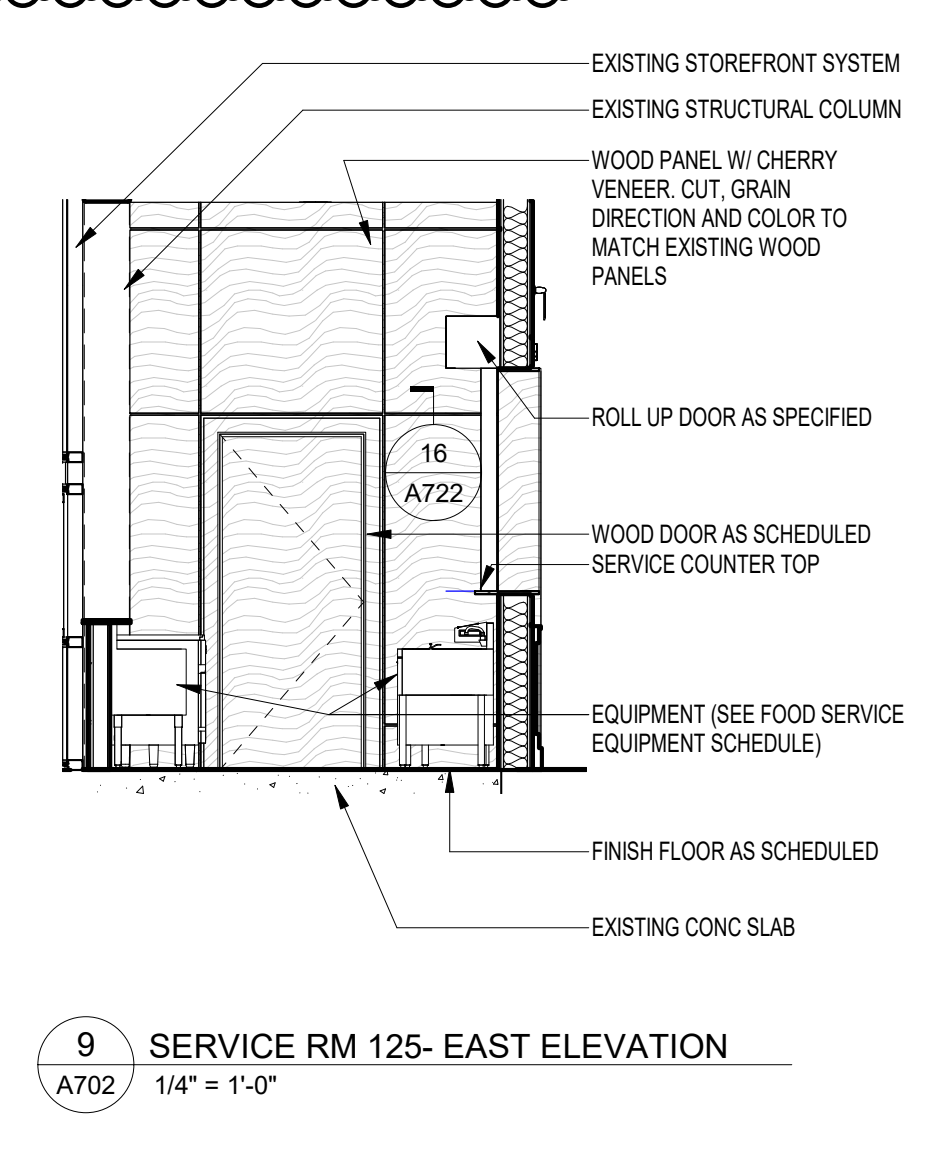
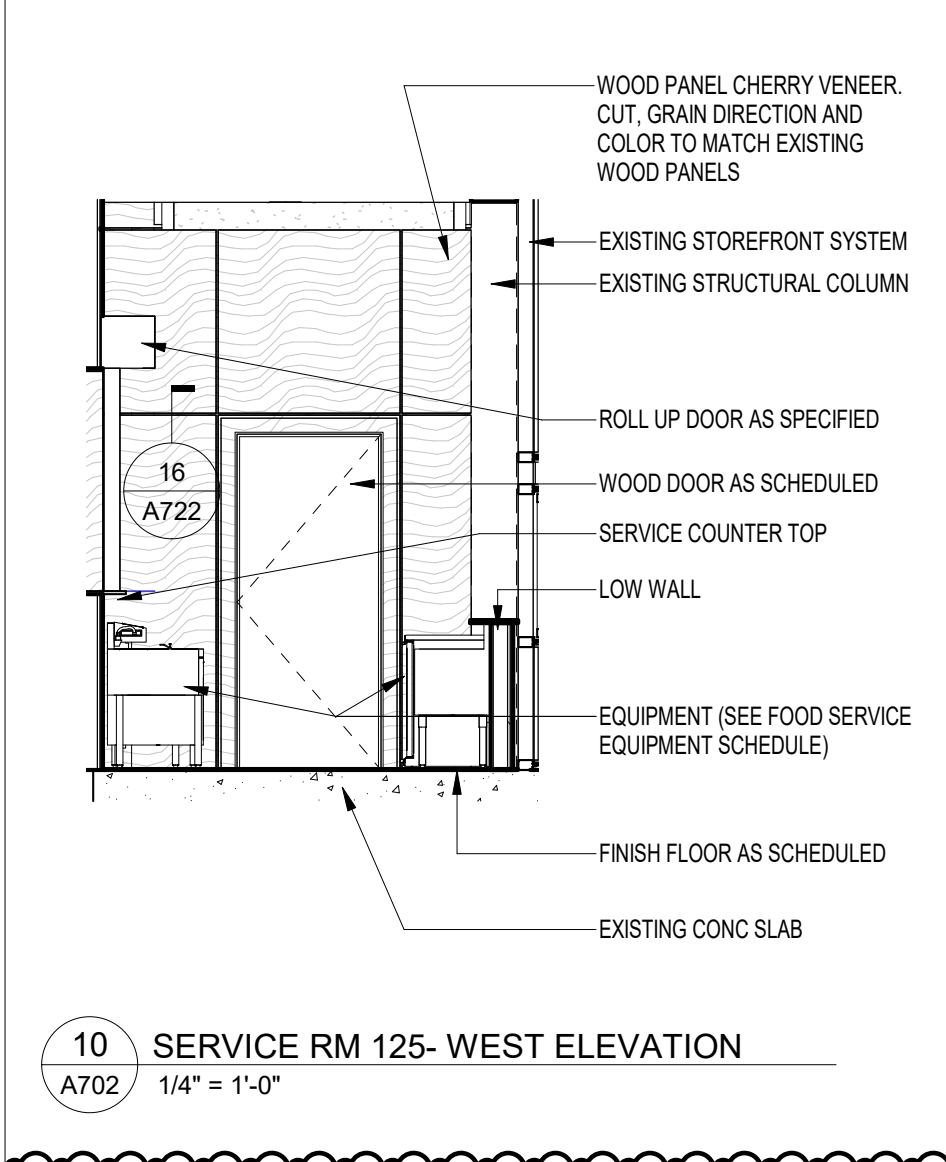
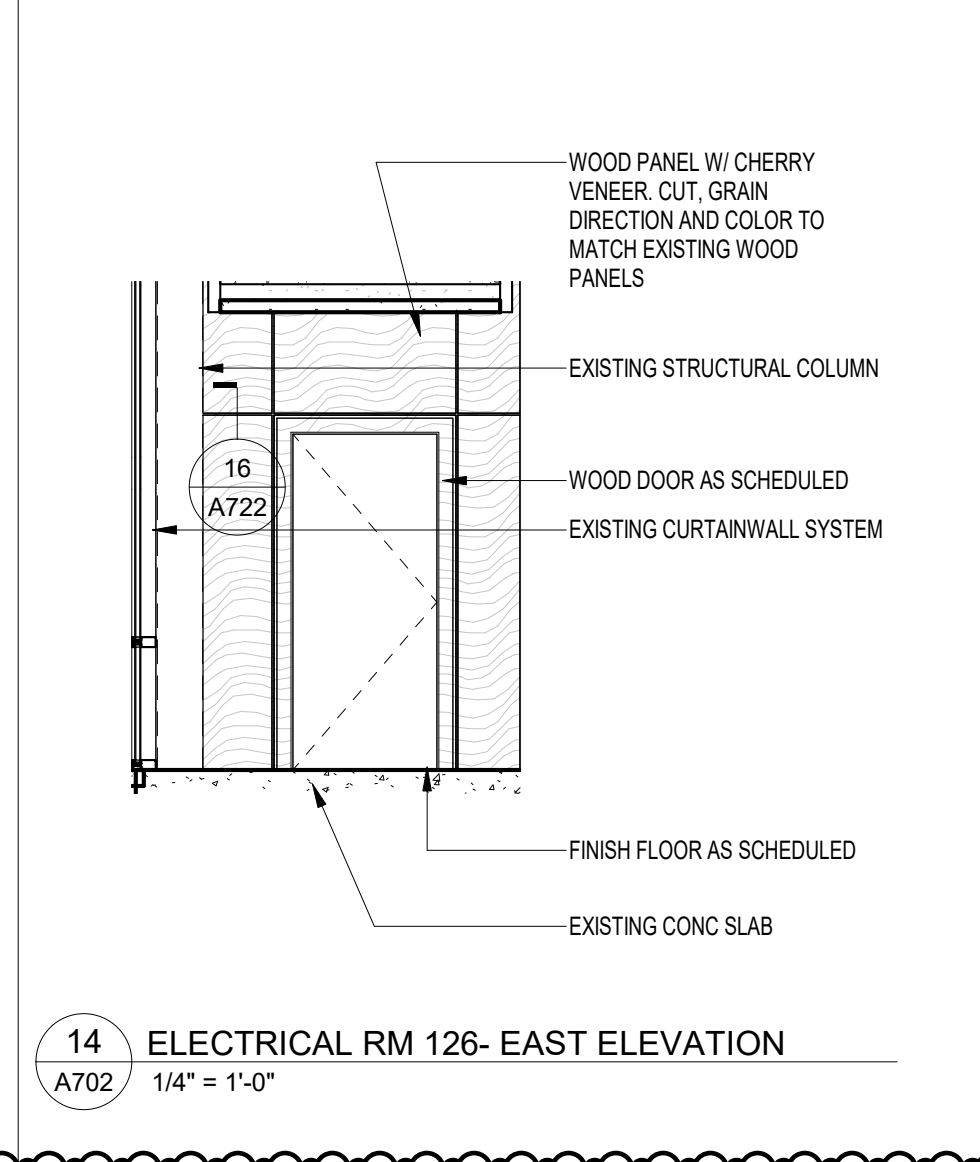
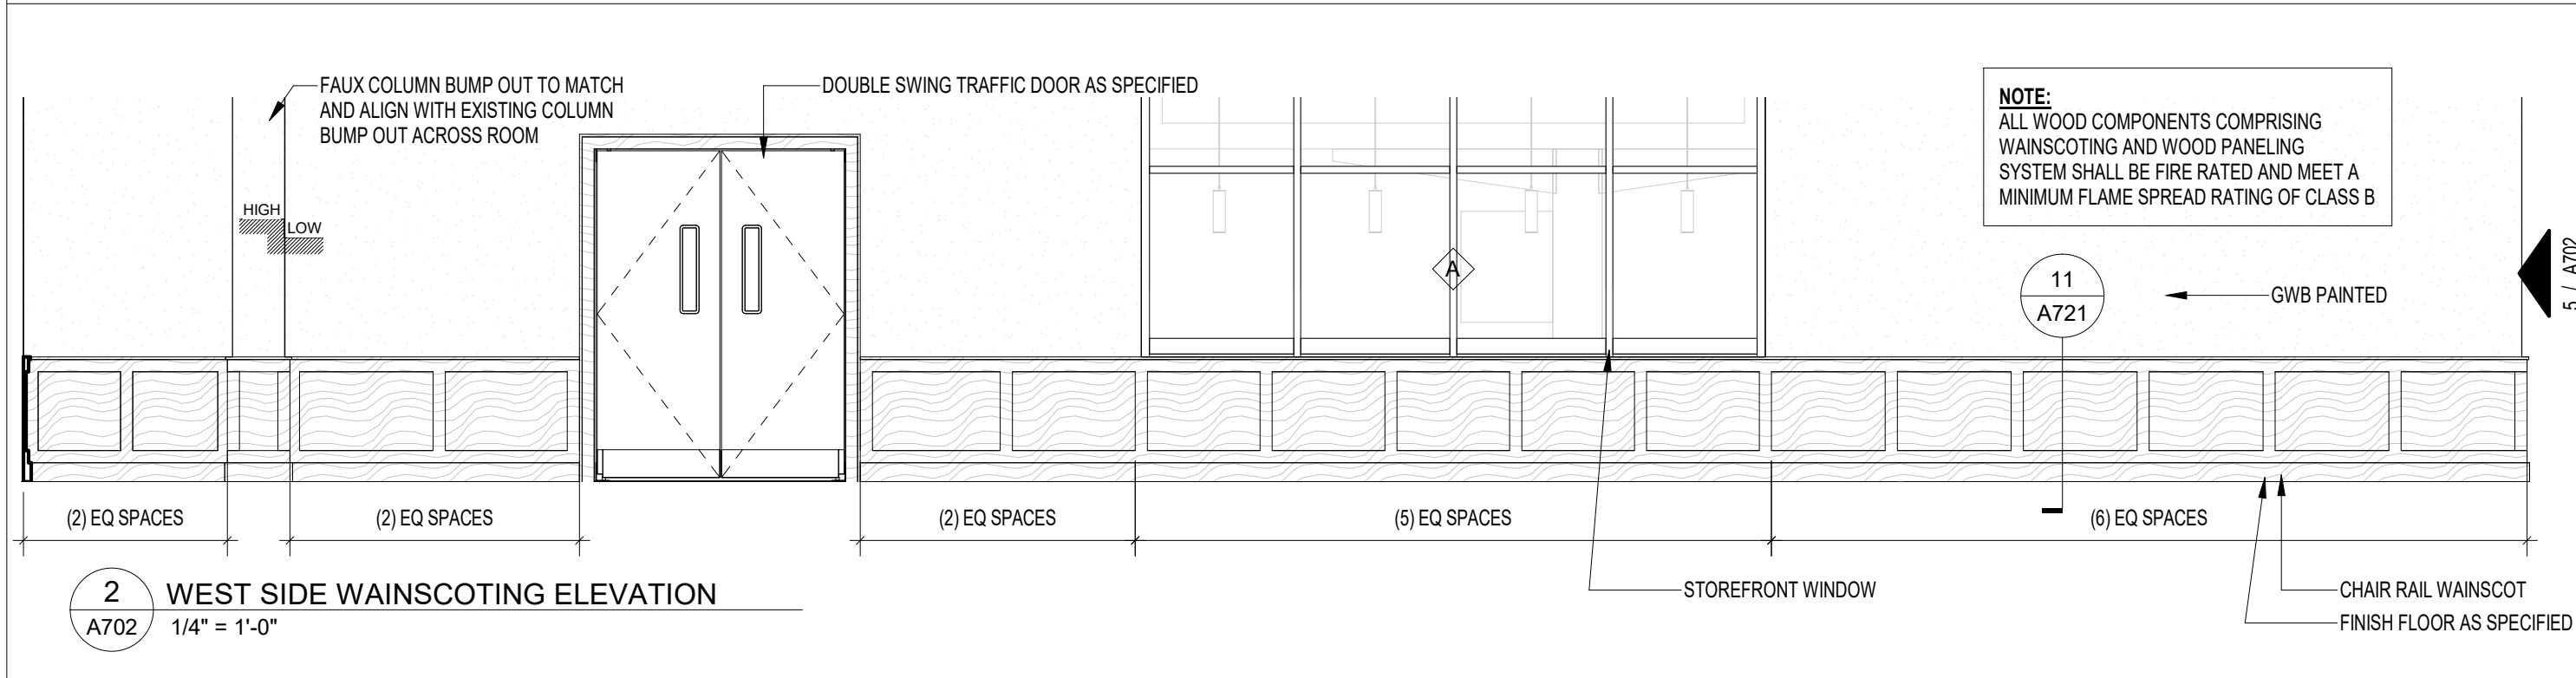
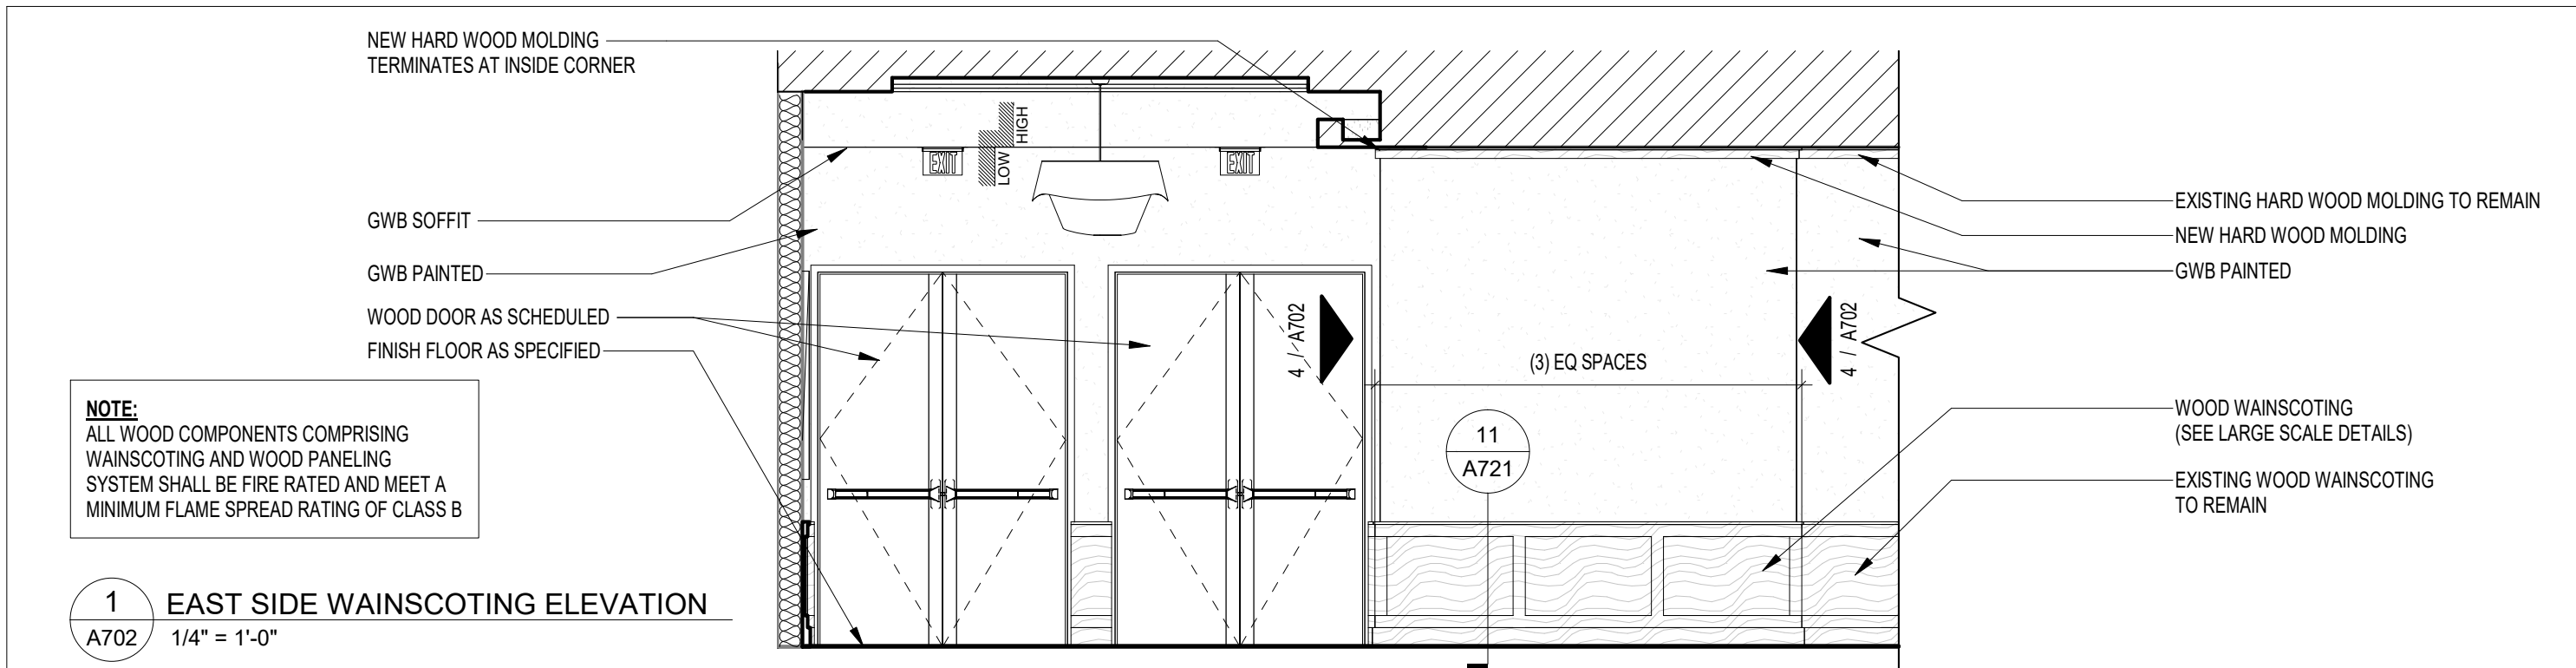
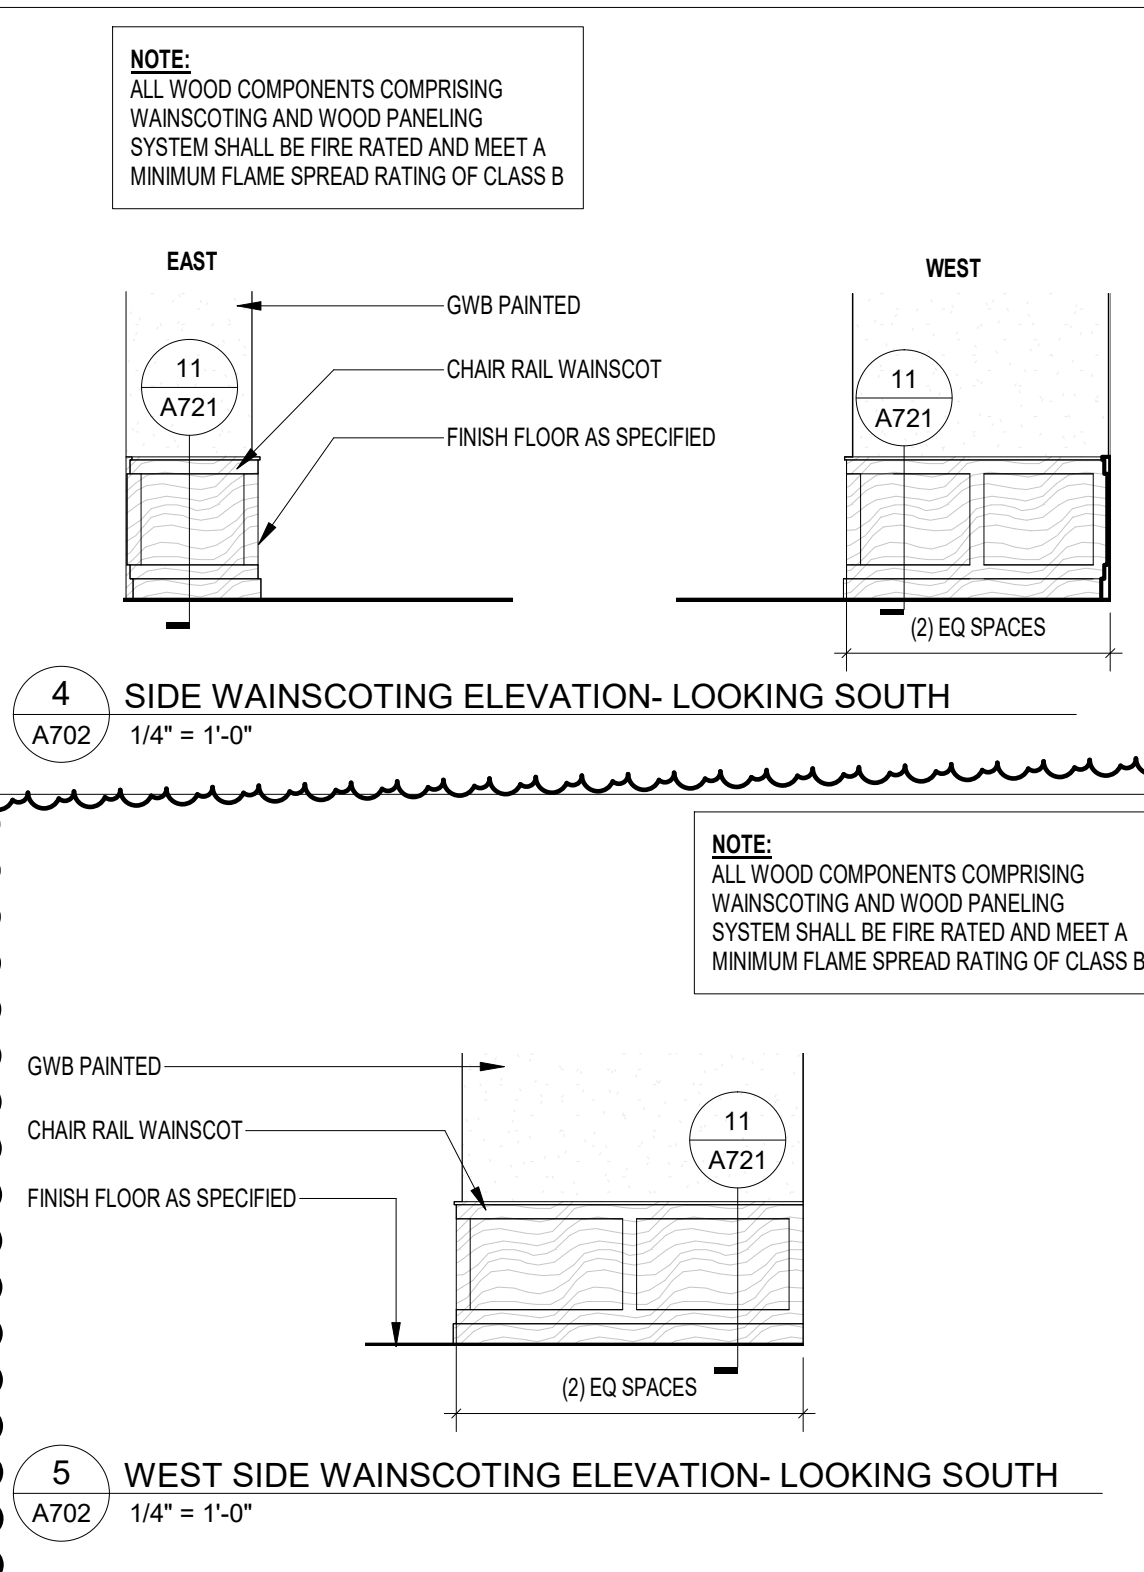
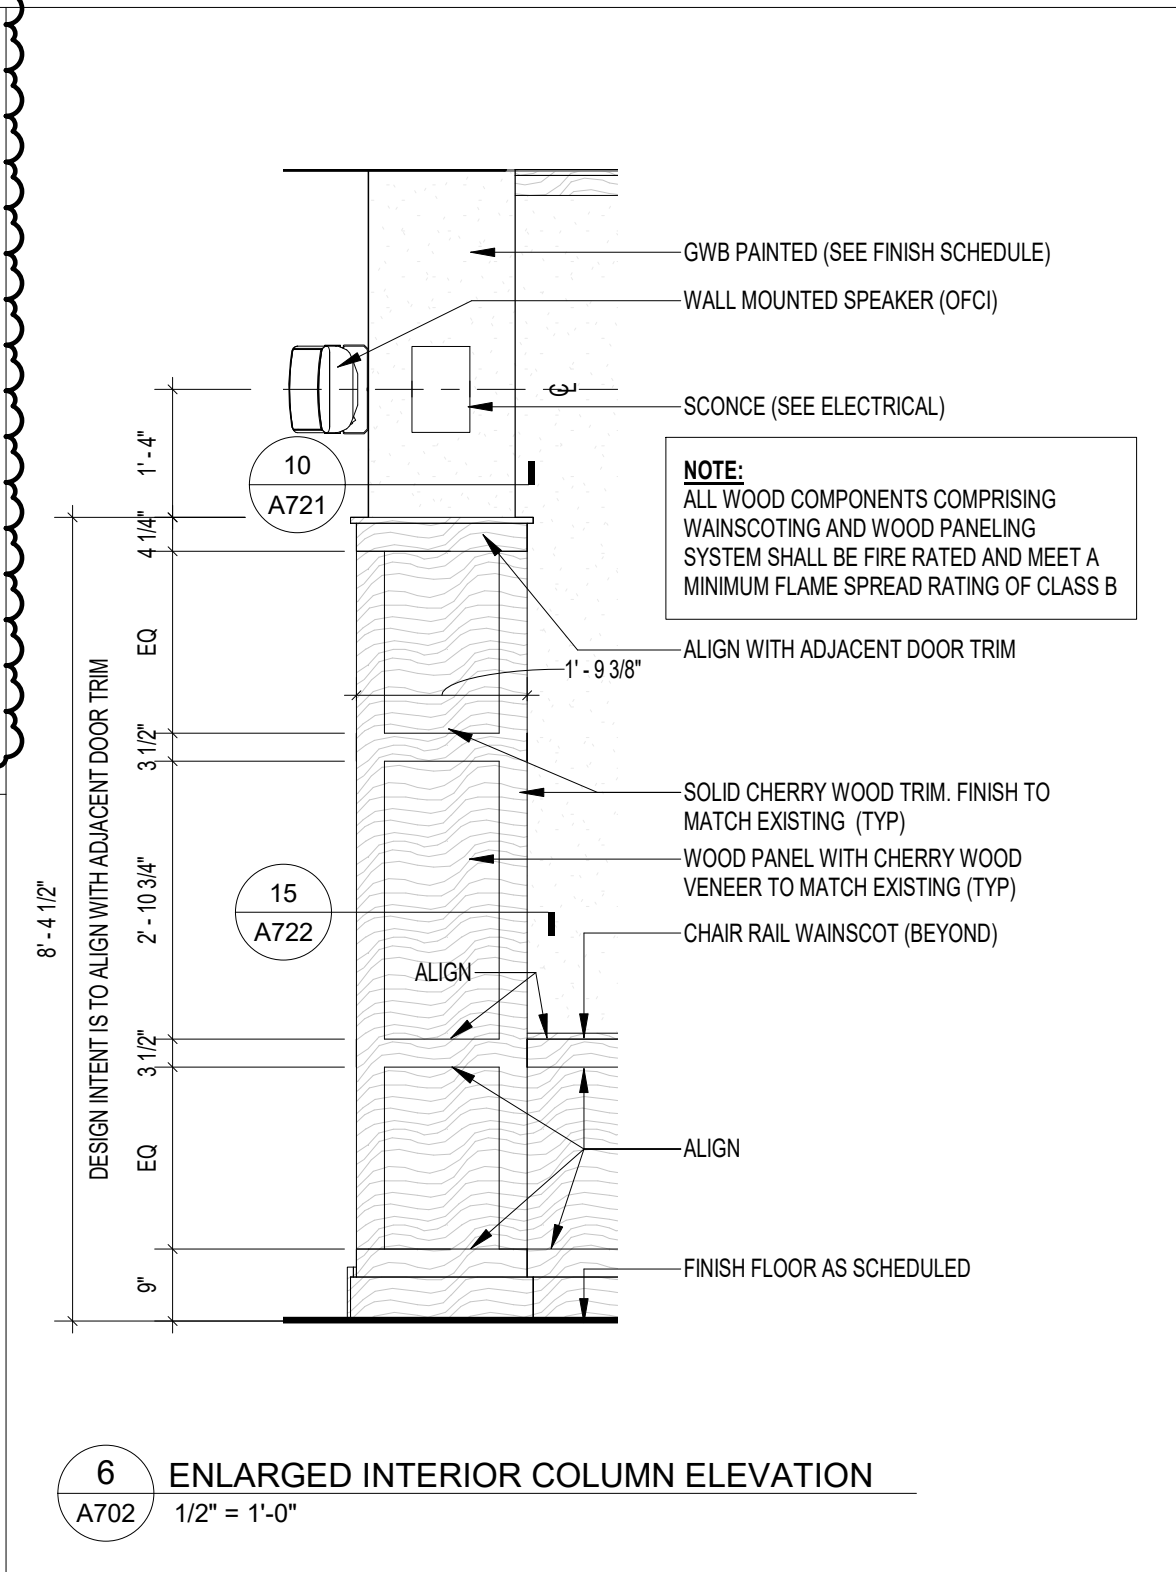
SHEET TITLE
INTERIOR ELEVATIONS

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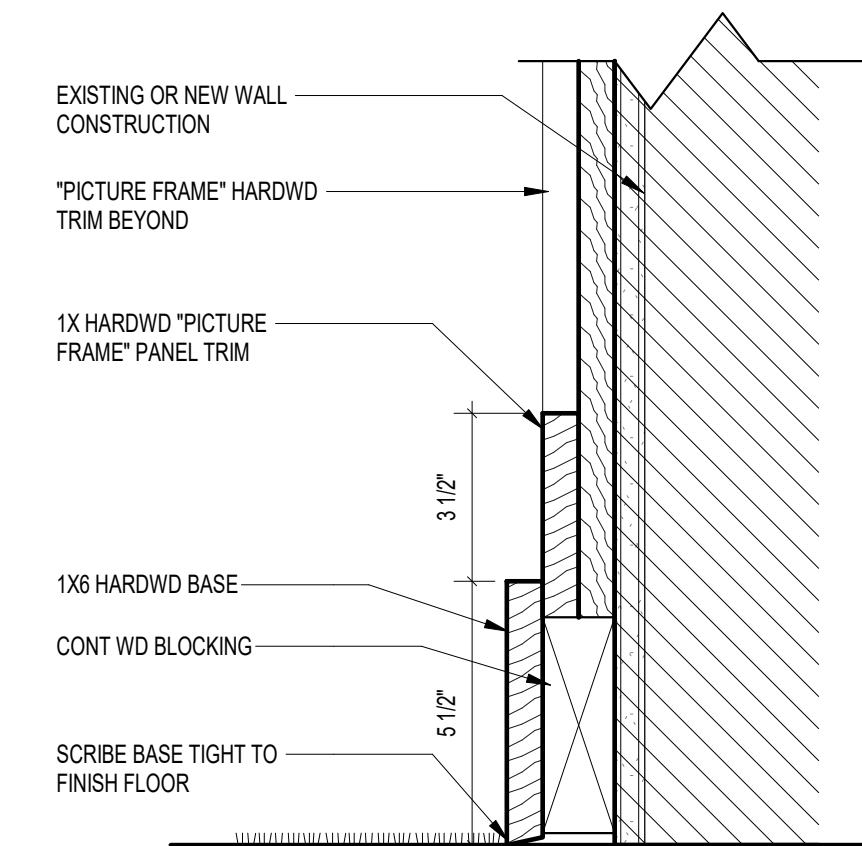
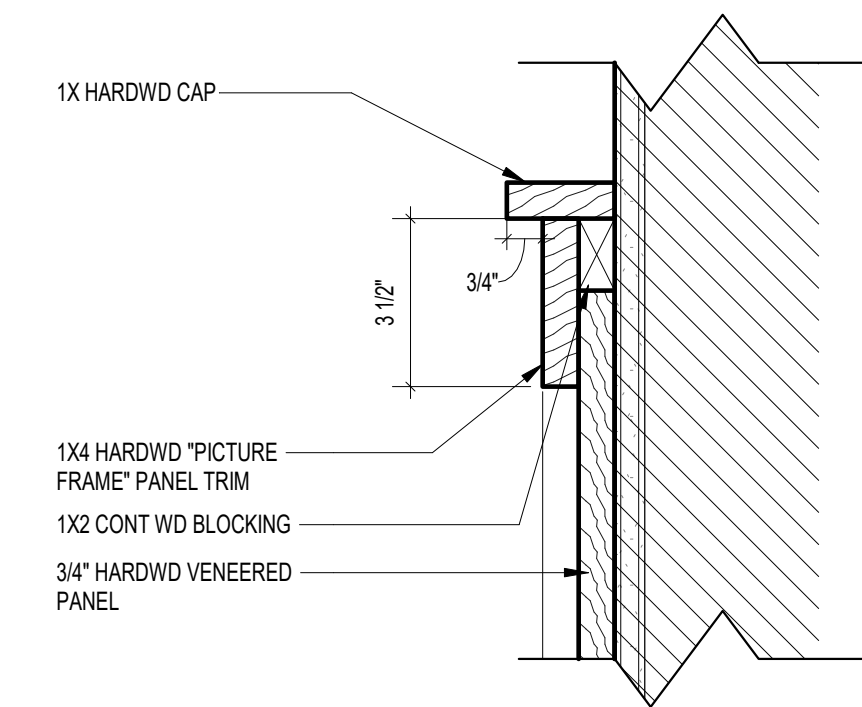
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SHEET NO
A702


REV NO
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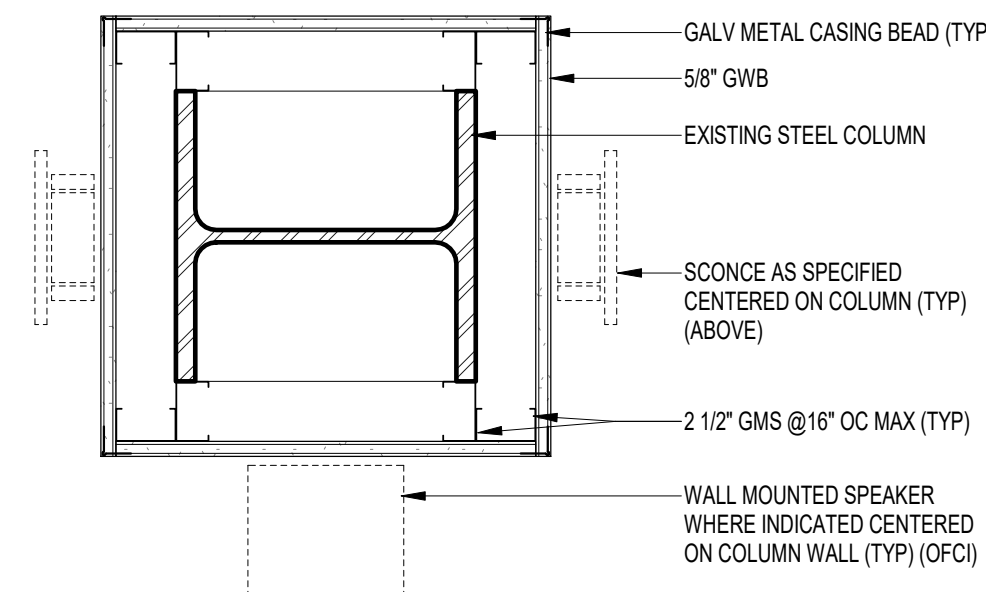
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NOTE:
11' x 17" SHEETS ARE PLOTTED AT 1/2
THE SCALE NOTED ON THESE DRAWINGS



**FSU TURNBULL
CONFERENCE CENTER
RENOVATIONS**



10 COLUMN FURRING
A721 1 1/2" = 1'-0"

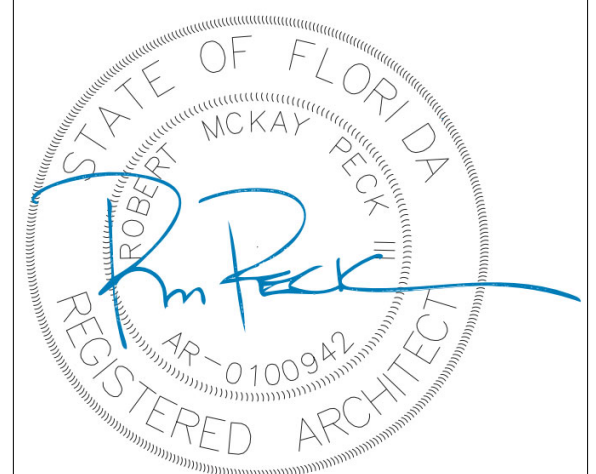NOTE:
ALL WOOD COMPONENTS COMPRISING
WAINSCOTING AND WOOD PANELING
SYSTEM SHALL BE FIRE RATED AND MEET A
MINIMUM FLAME SPREAD RATING OF CLASS B

11 WAINSCOTT DETAIL
A721 3" = 1'-0"

NOTE:
ALL WOOD COMPONENTS COMPRISING
WAINSCOTING AND WOOD PANELING
SYSTEM SHALL BE FIRE RATED AND MEET A
MINIMUM FLAME SPREAD RATING OF CLASS B















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1	04.17.24	FSU PERMIT

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CONSTRUCTION DOCUMENTS	
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18 OCTOBER 2023	
PROJECT NO	CHECKED BY
74000	RMP/BI




INTERIOR DETAILS

SHEET NO	REV NO
A721	1


NOTE:
11" x 17" SHEETS ARE PLOTTED AT 1/2
THE SCALE NOTED ON THESE DRAWINGS

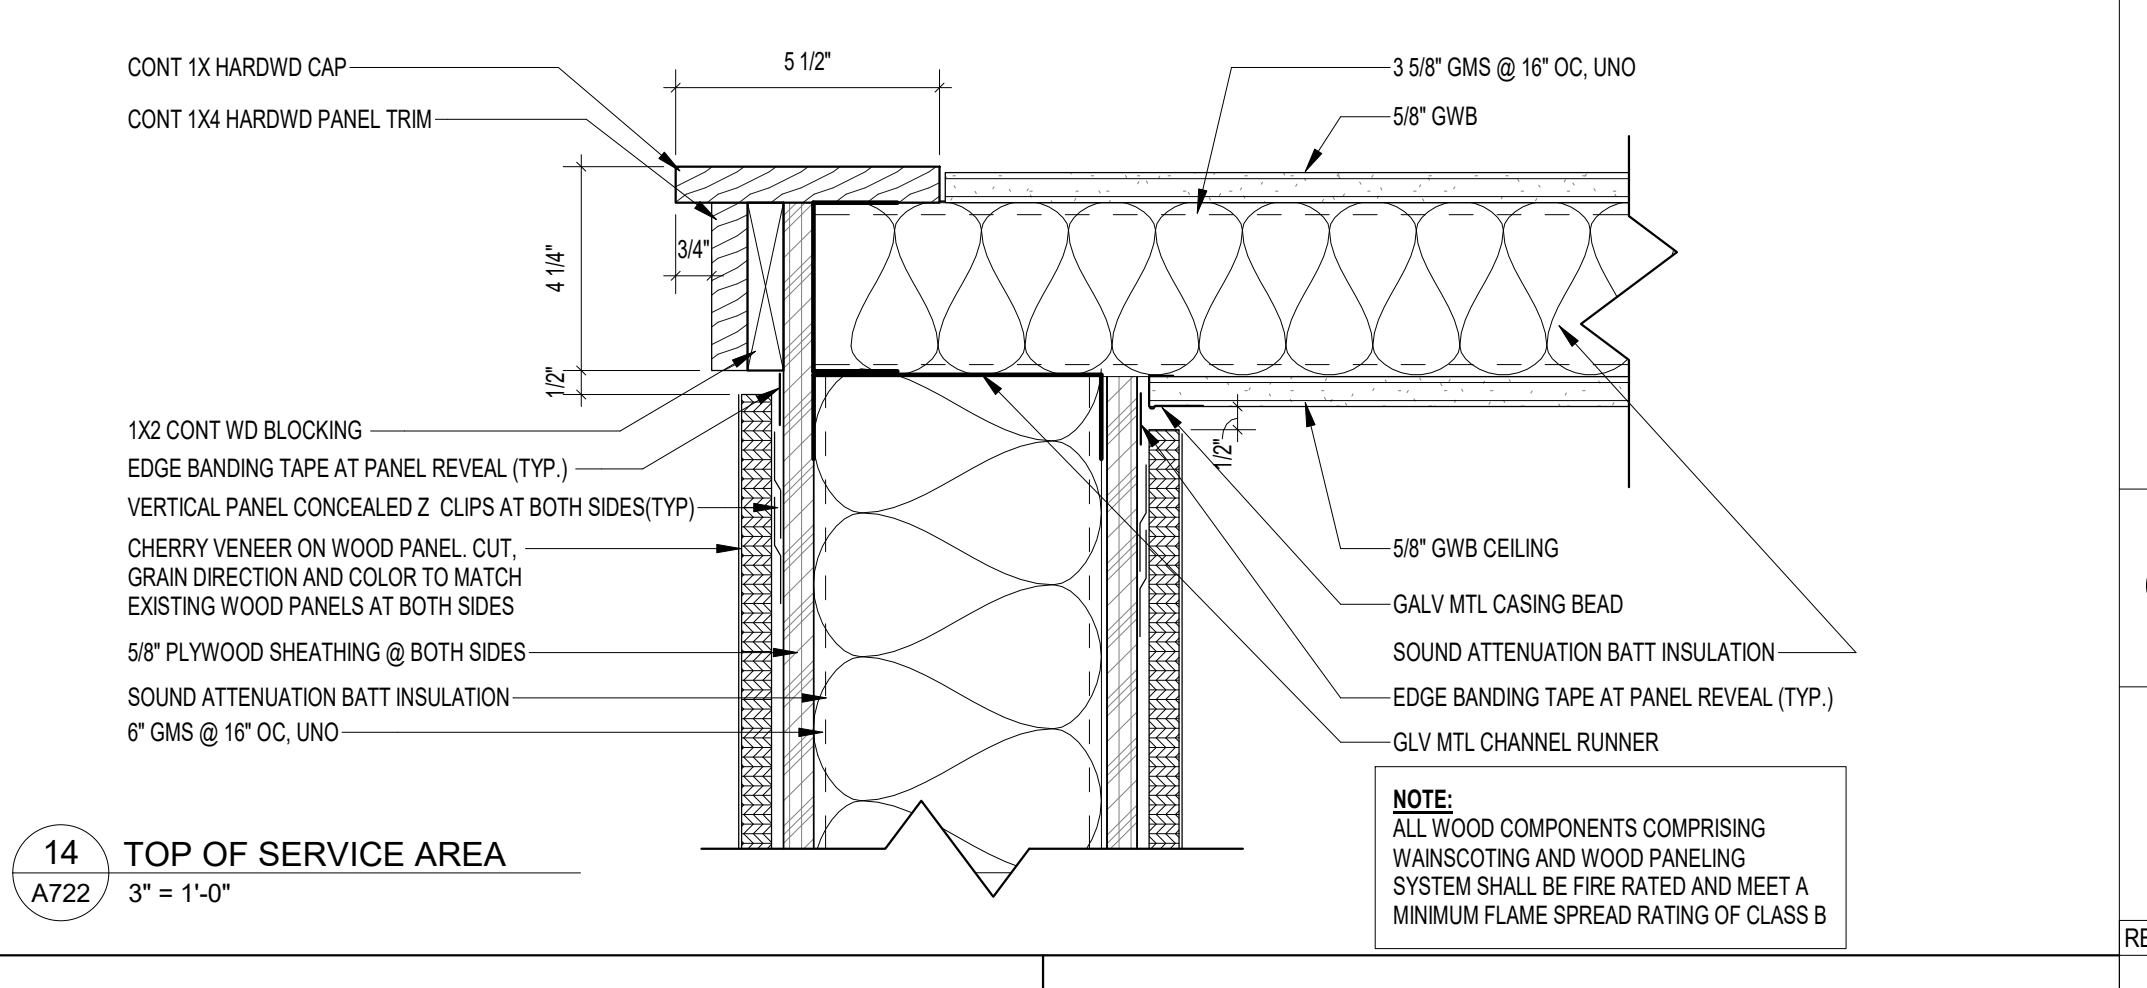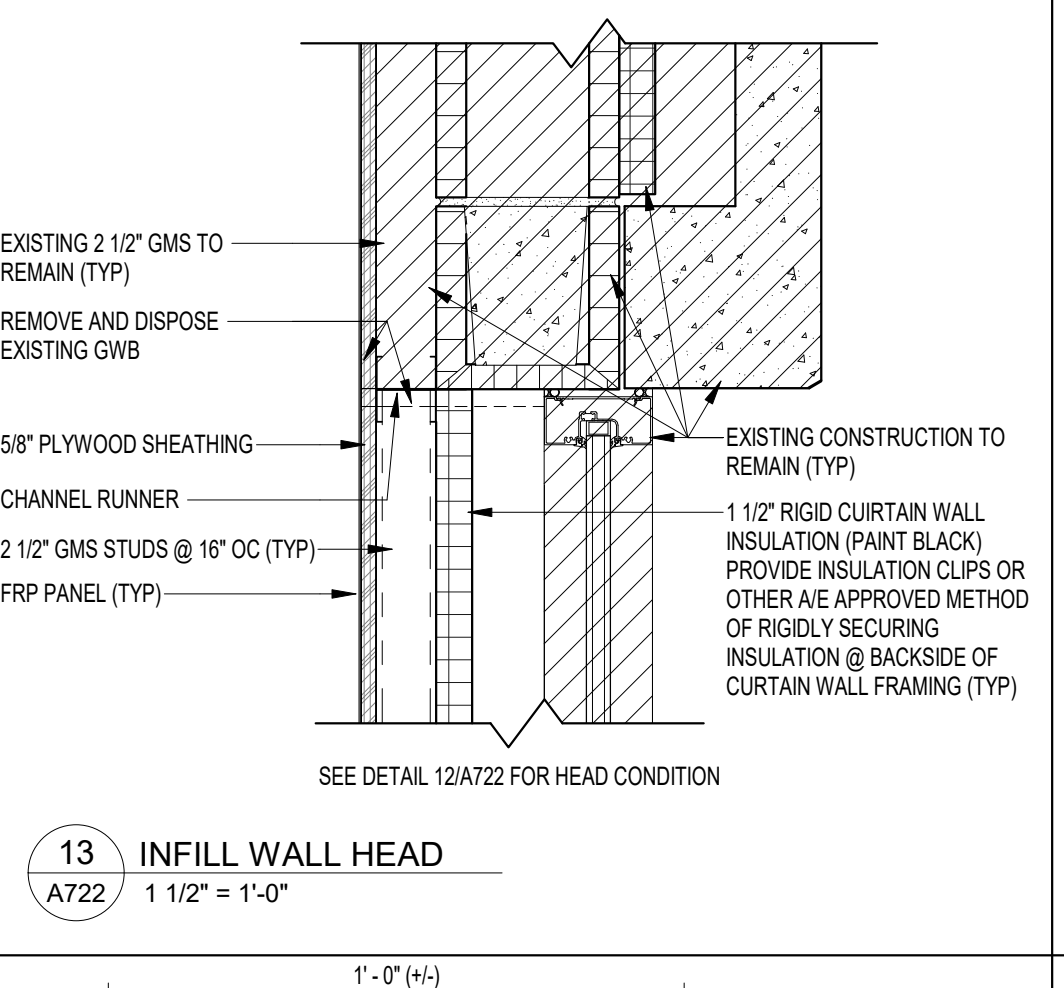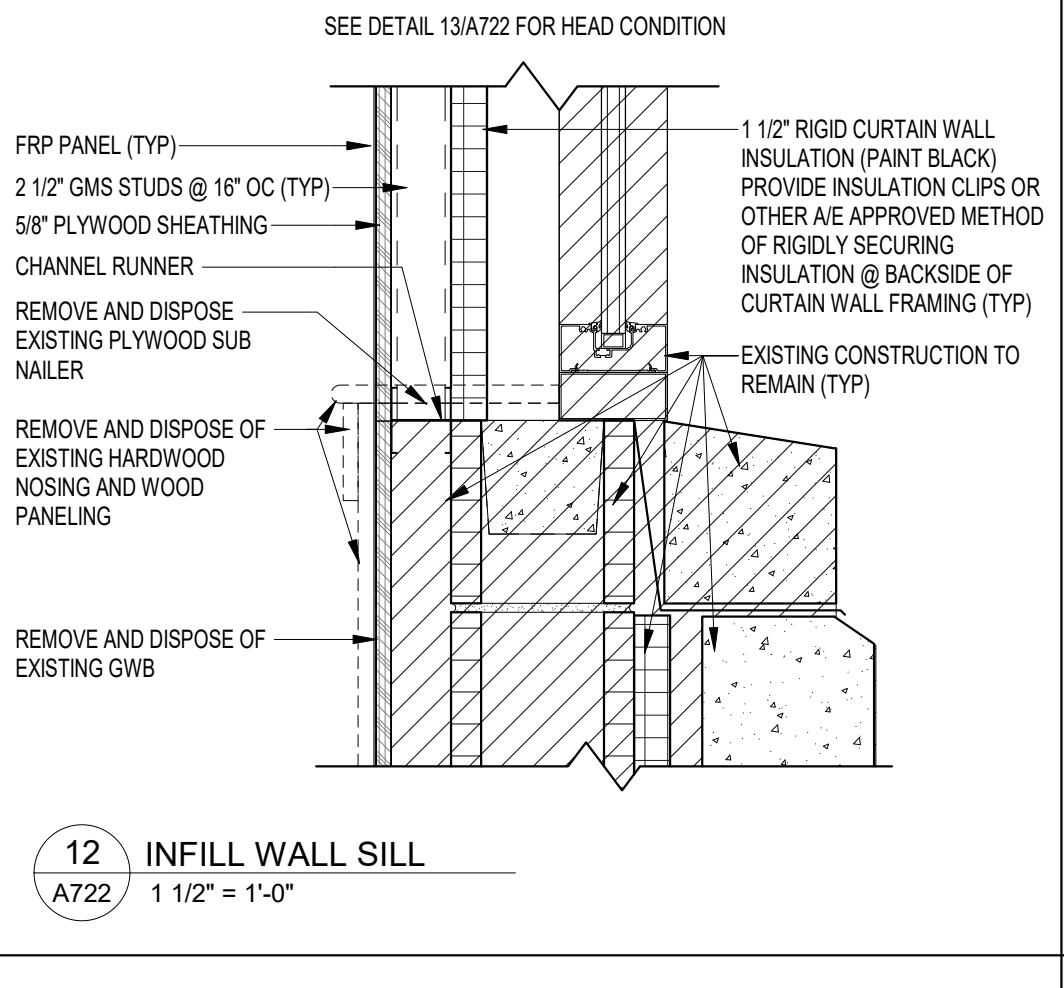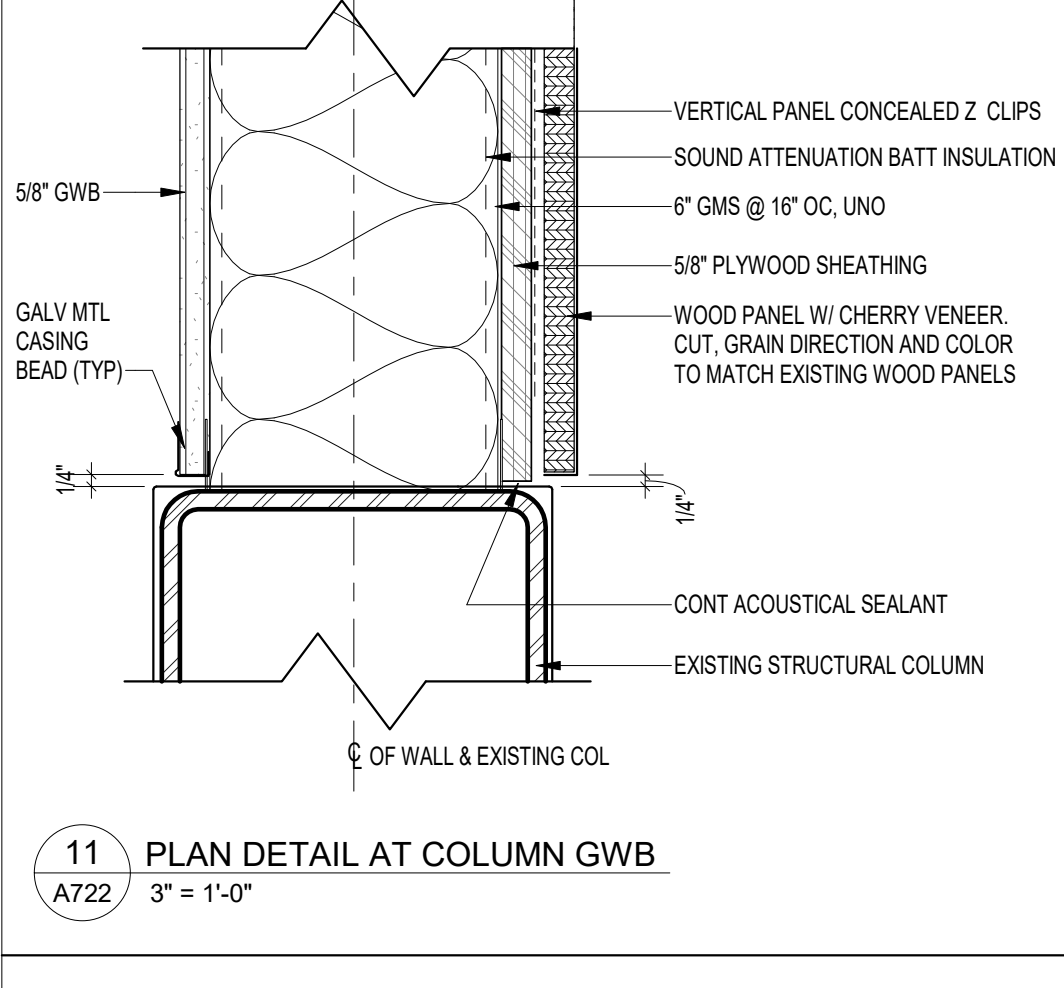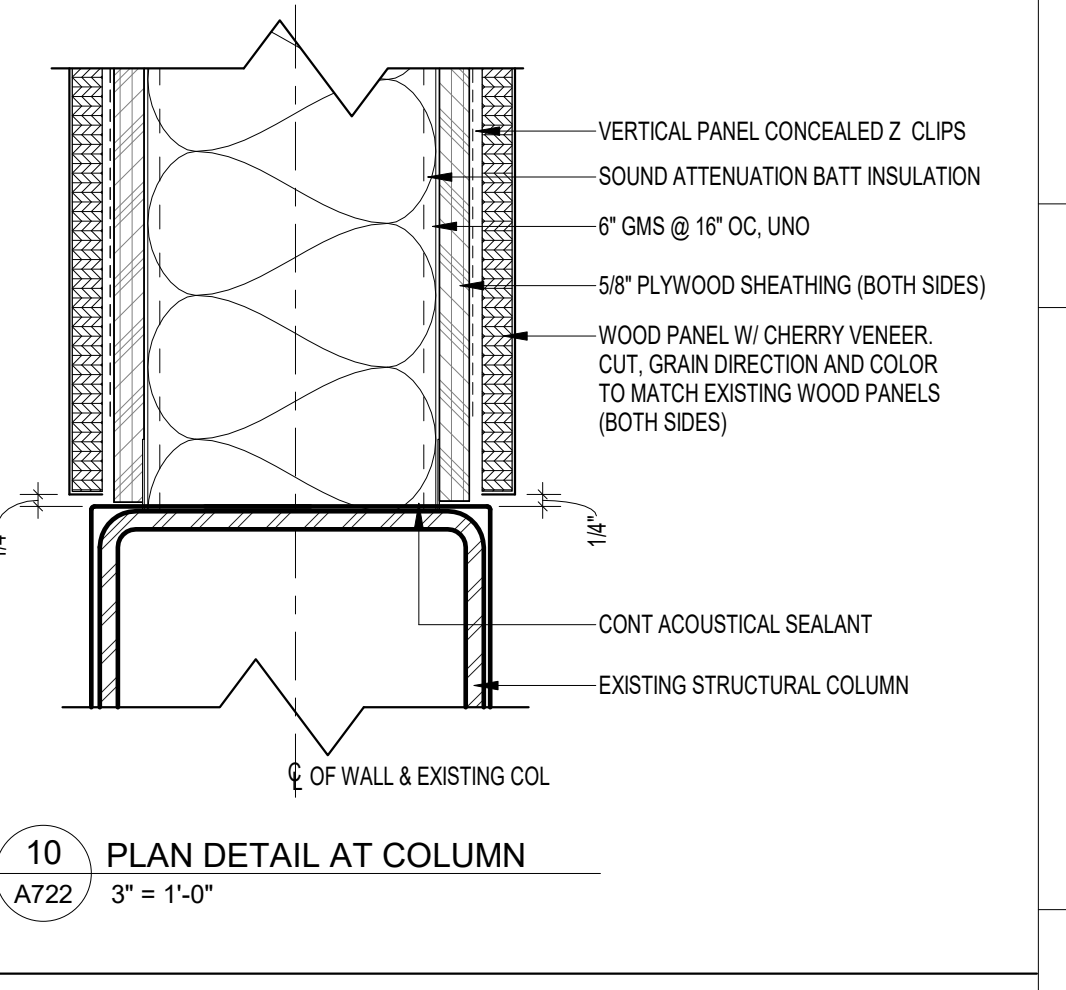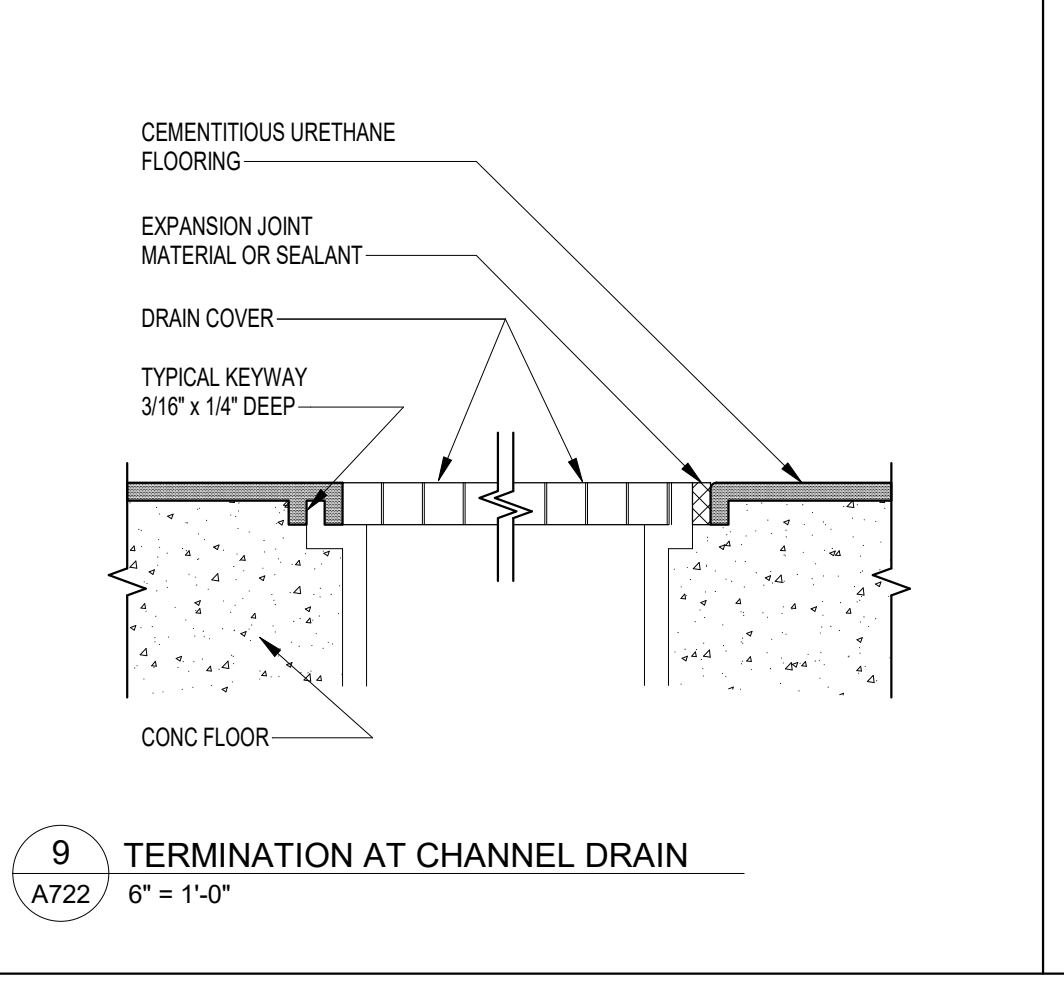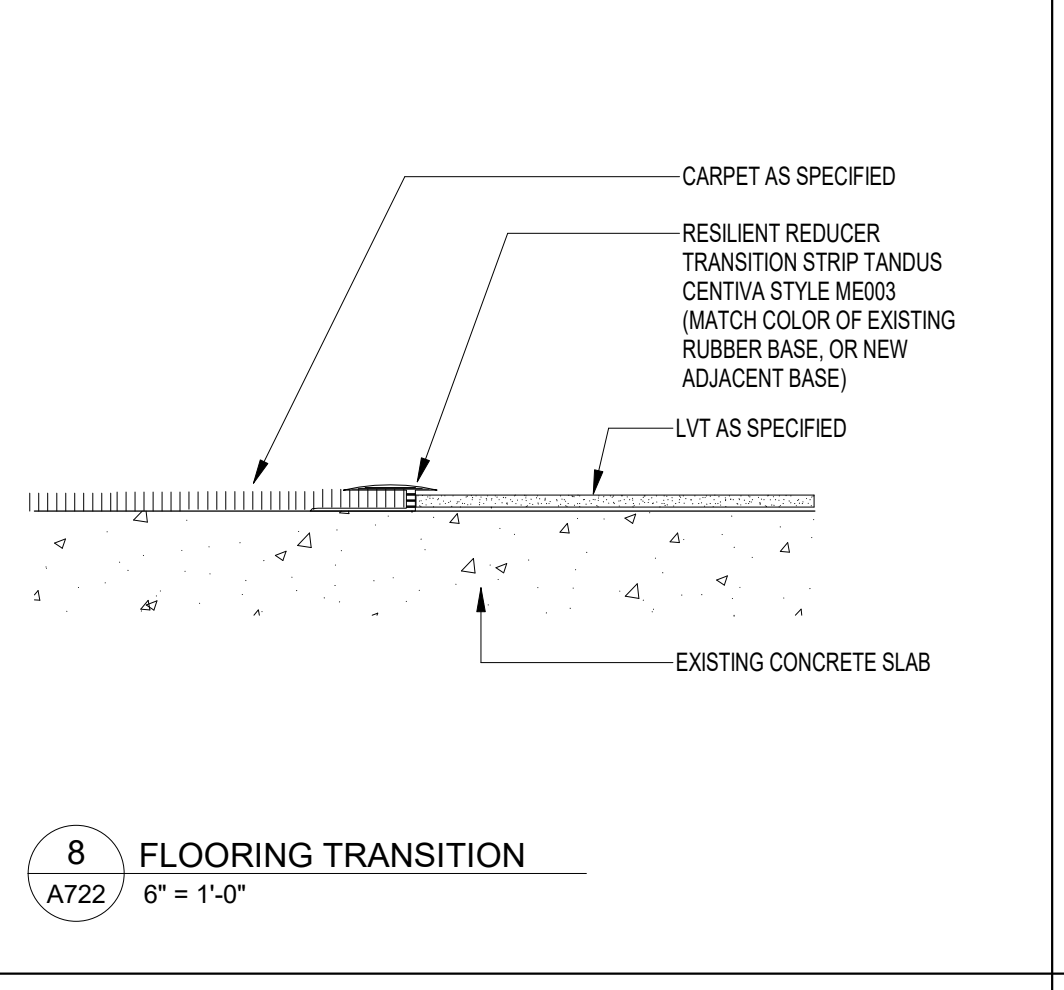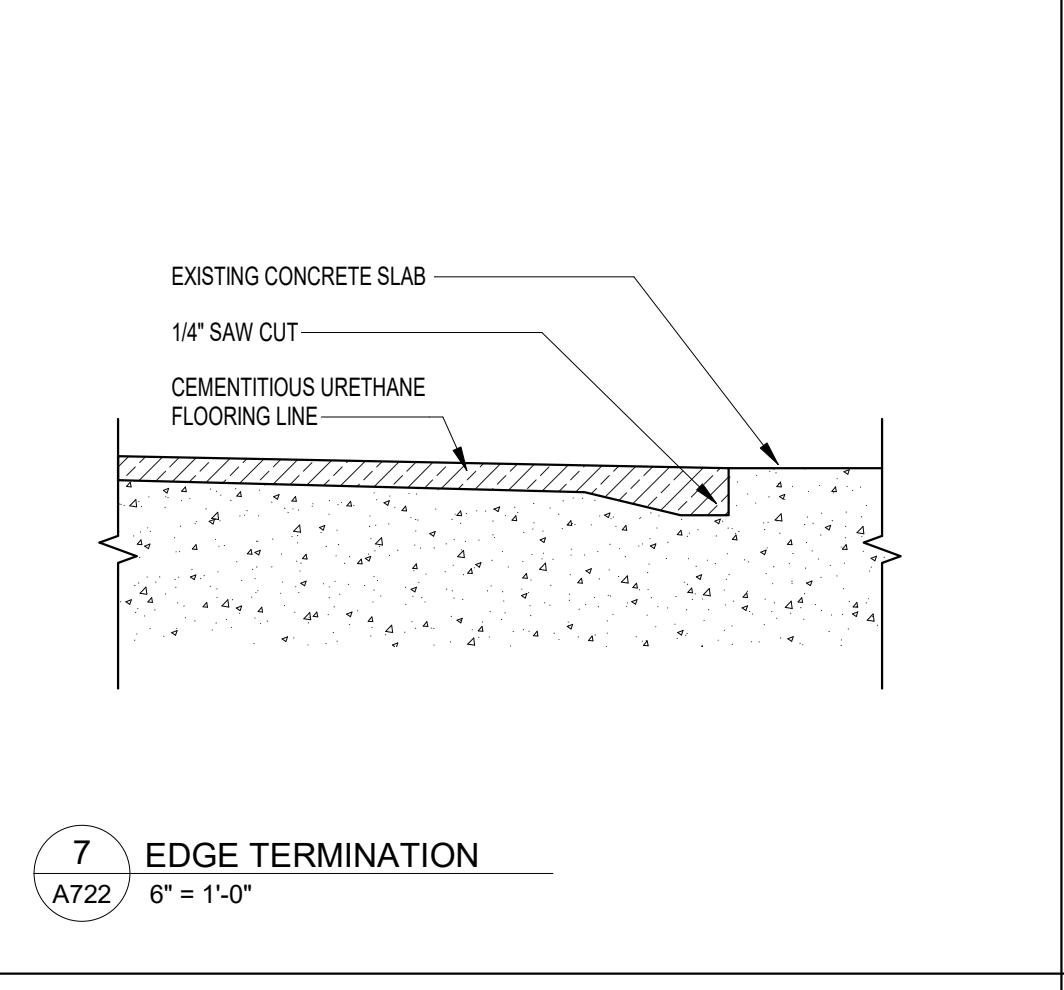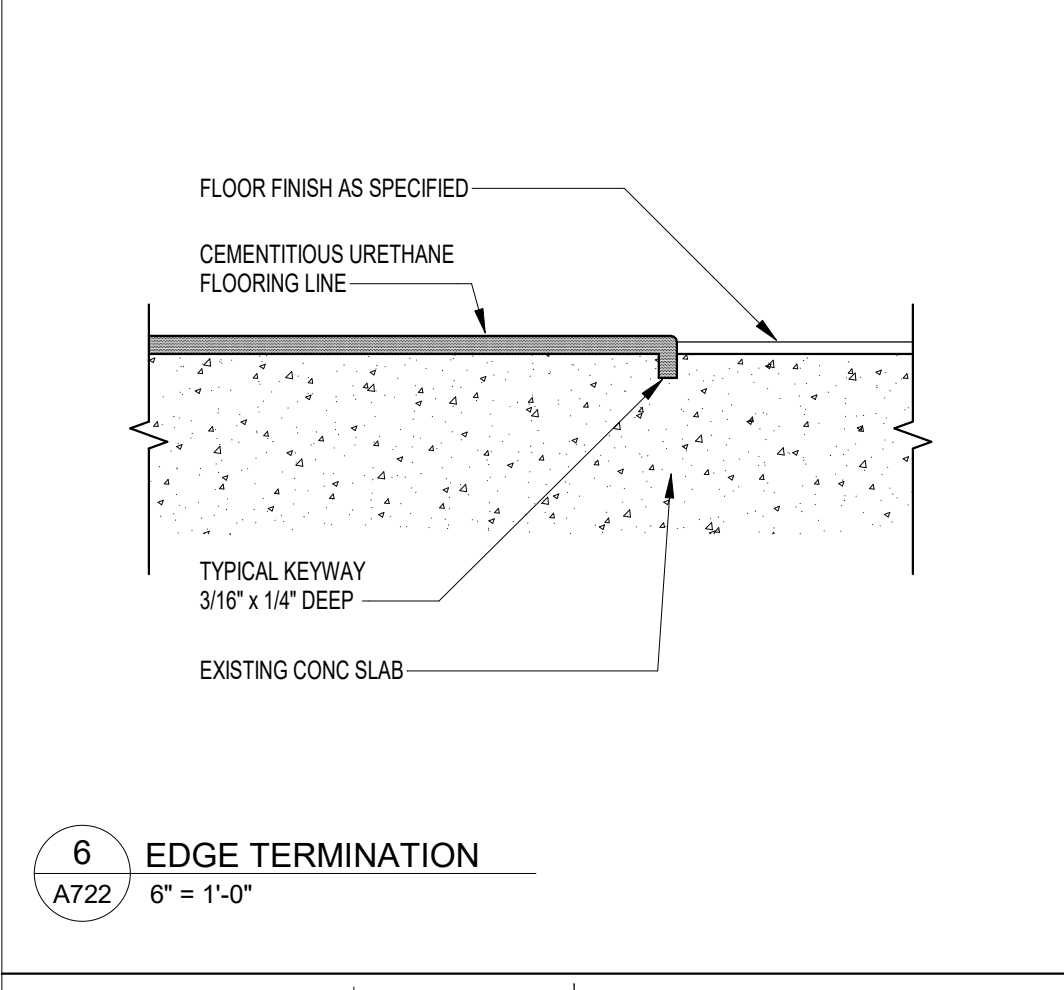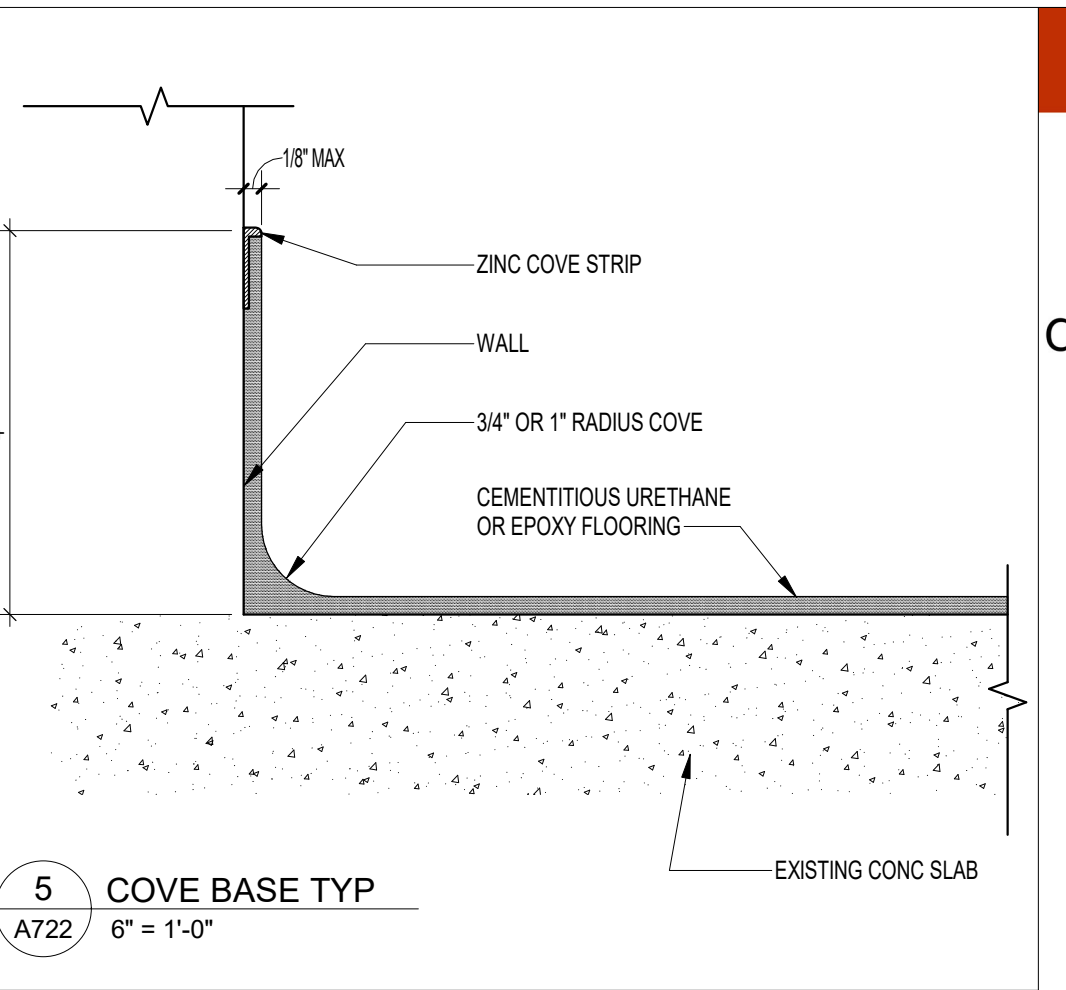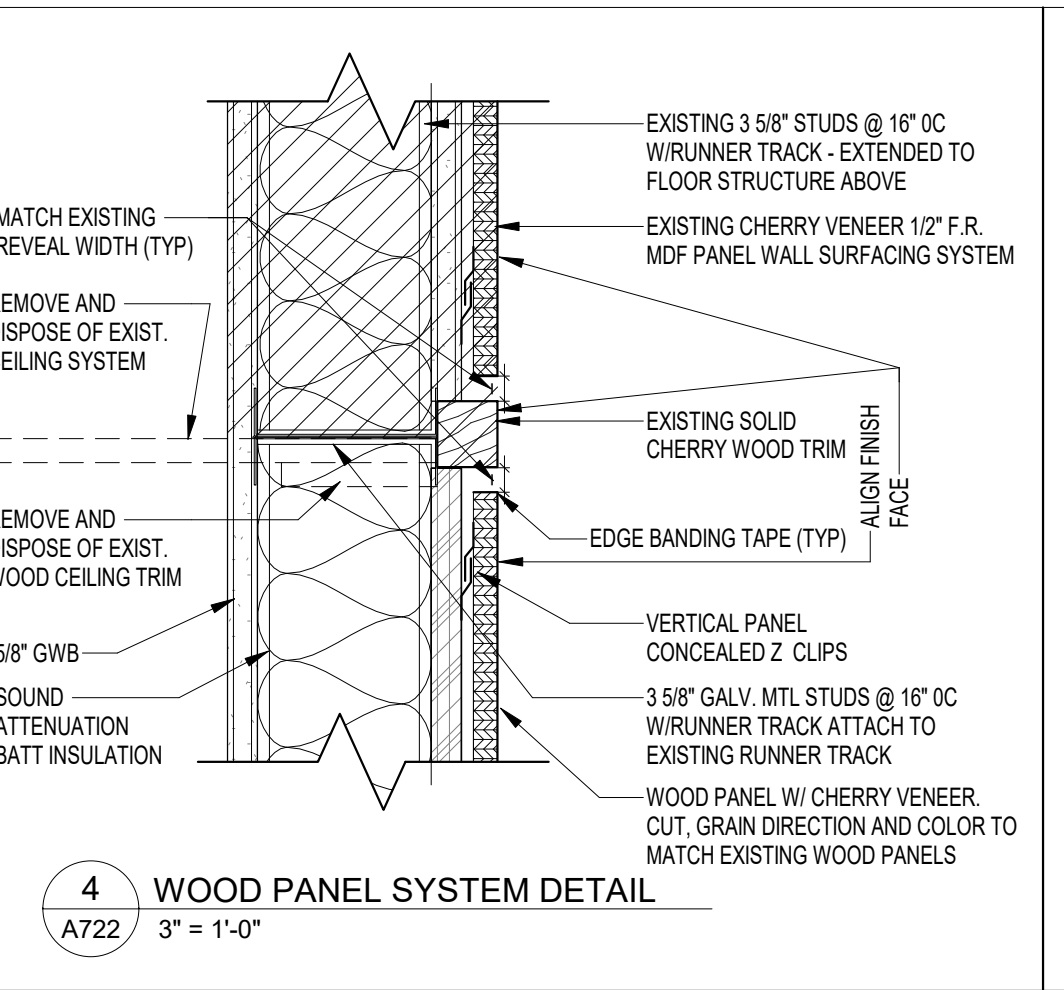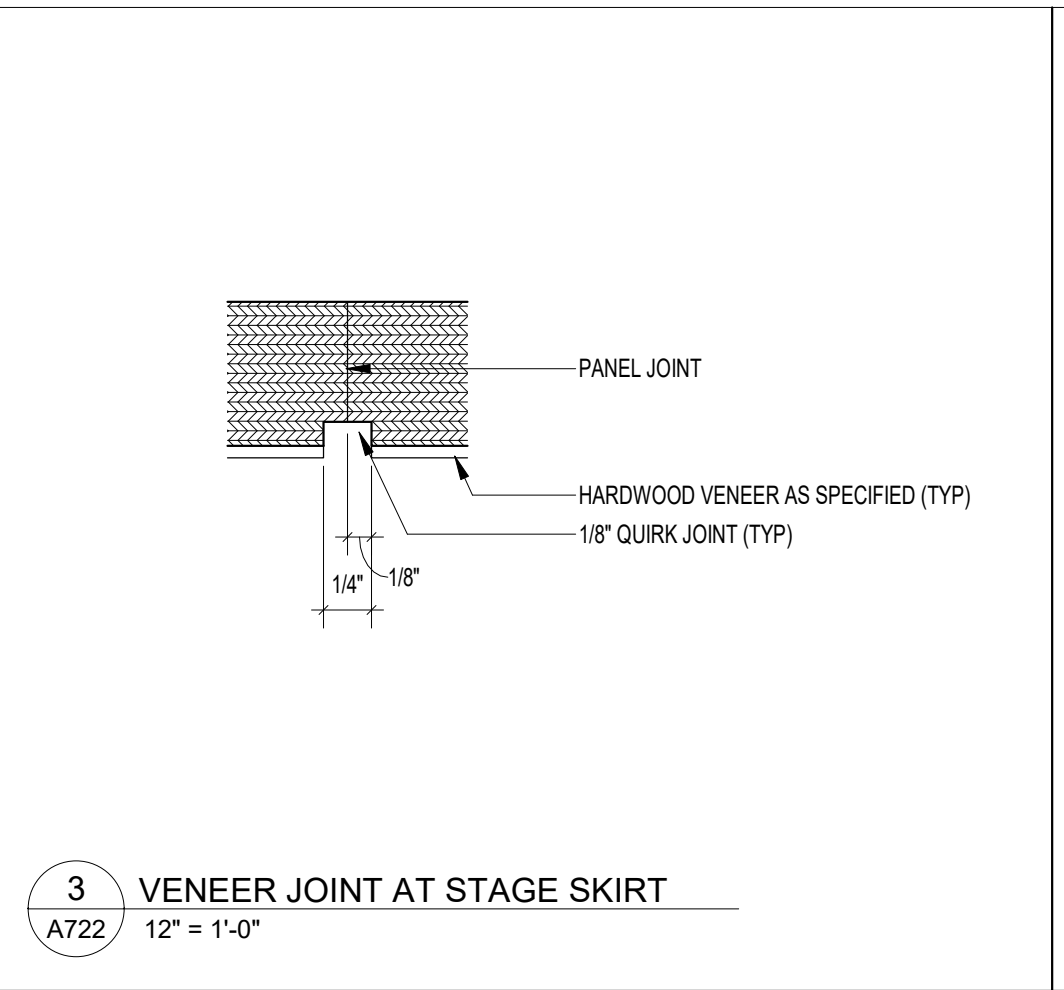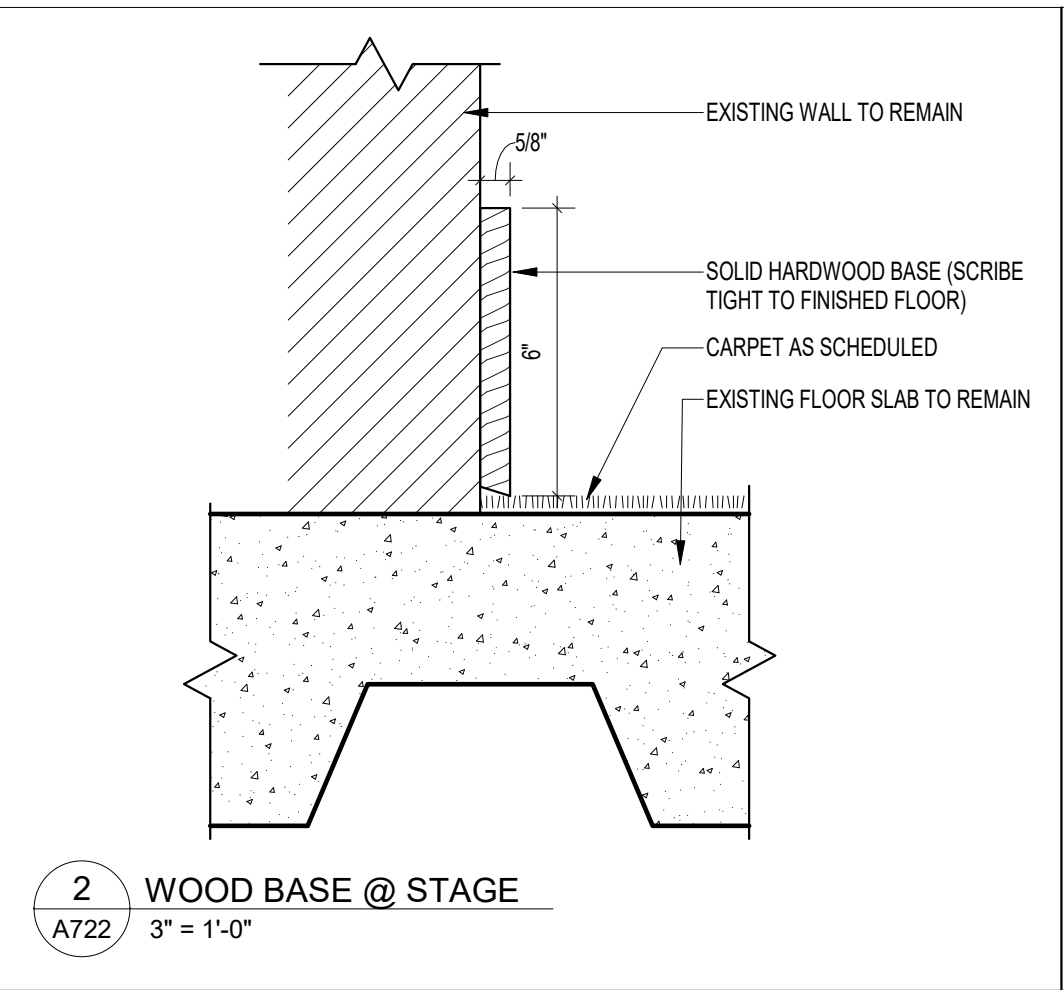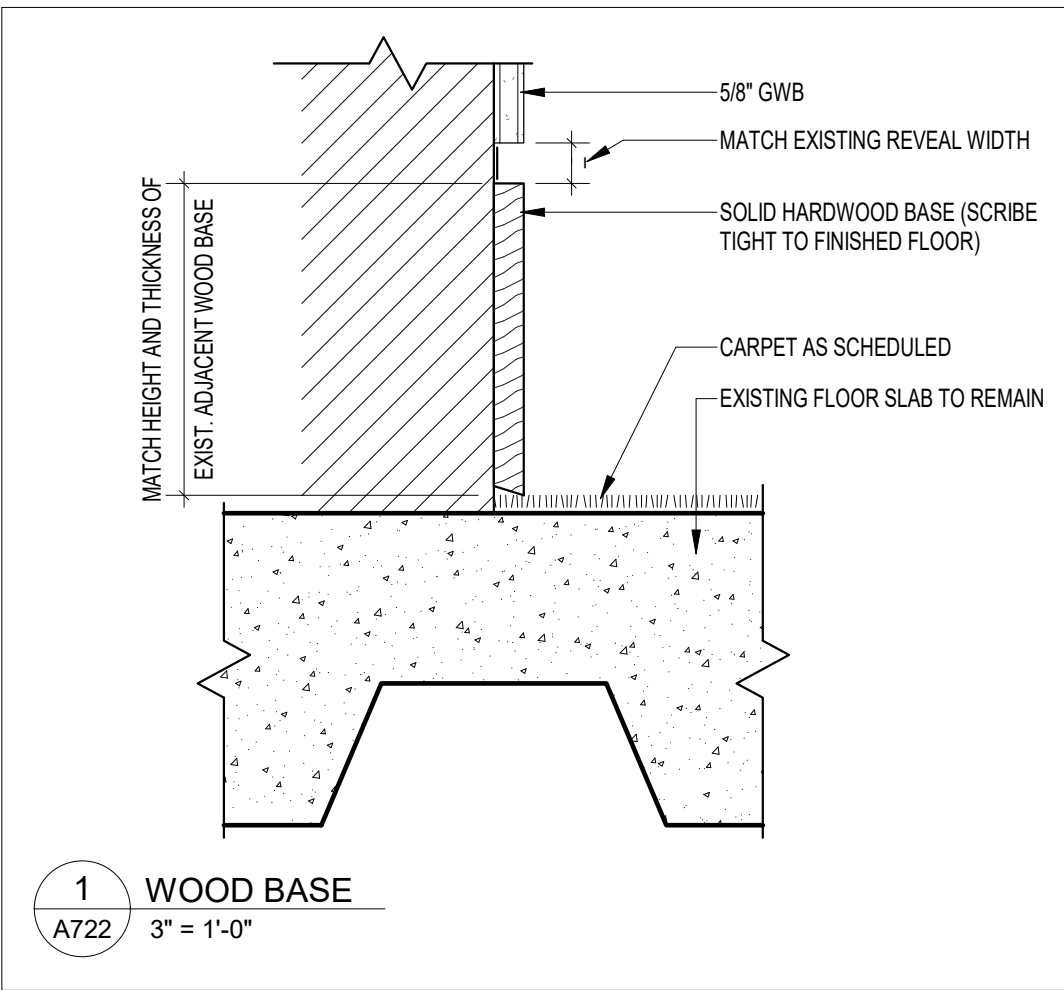


FSU TURNBULL
CONFERENCE CENTER
RENOVATIONS

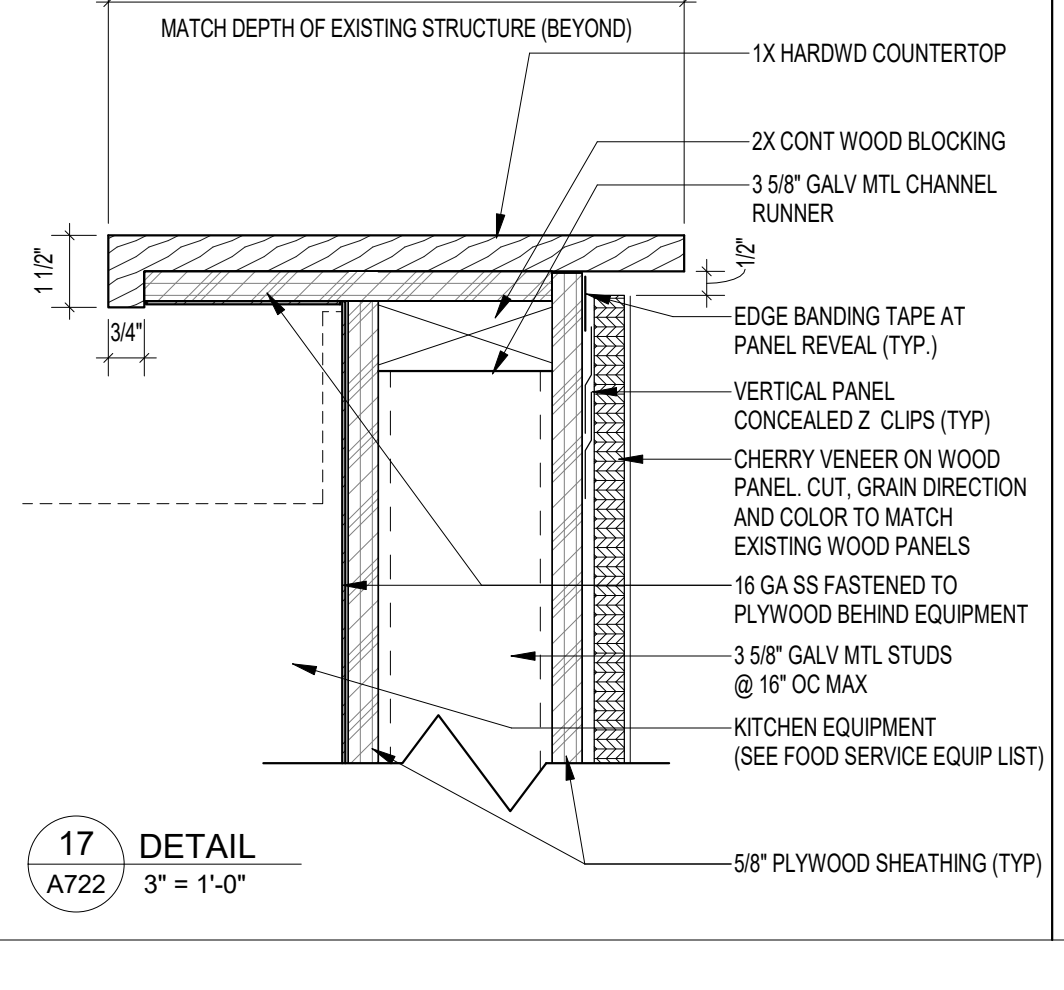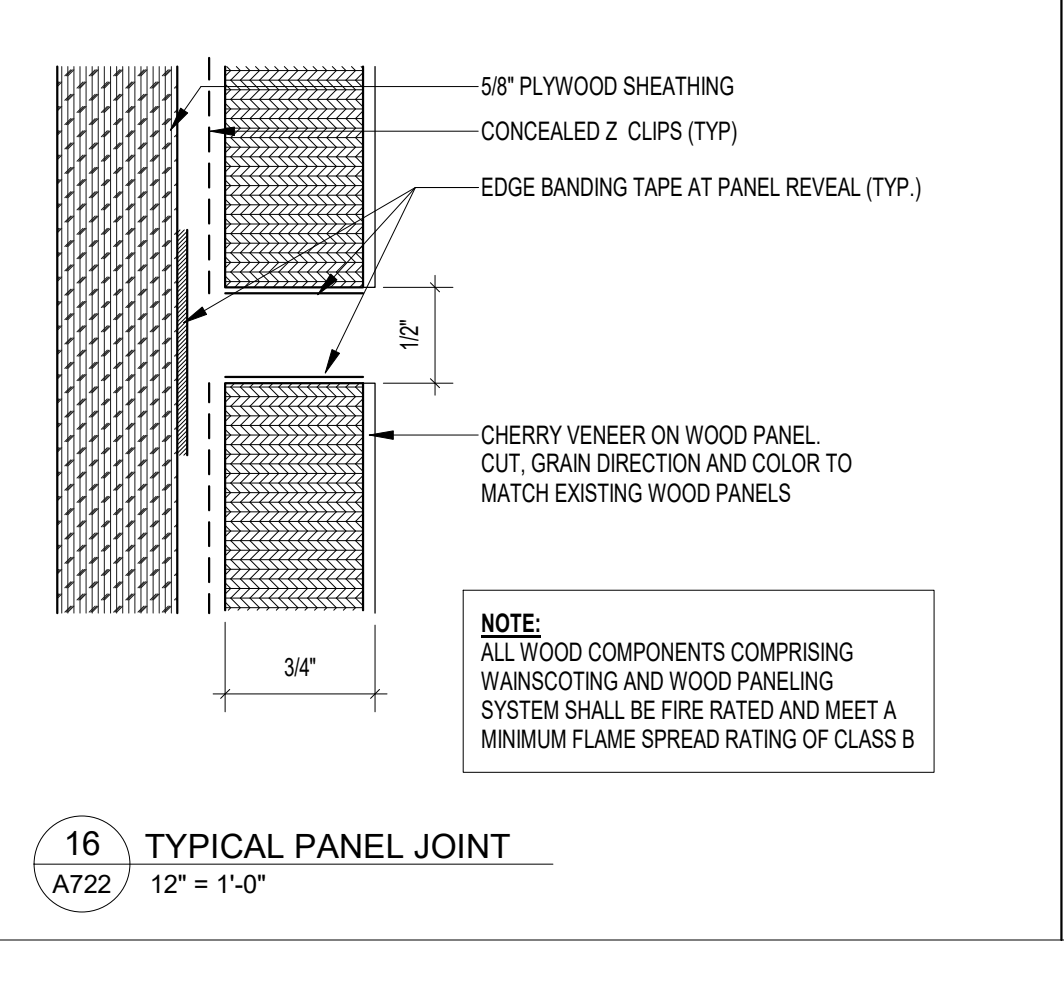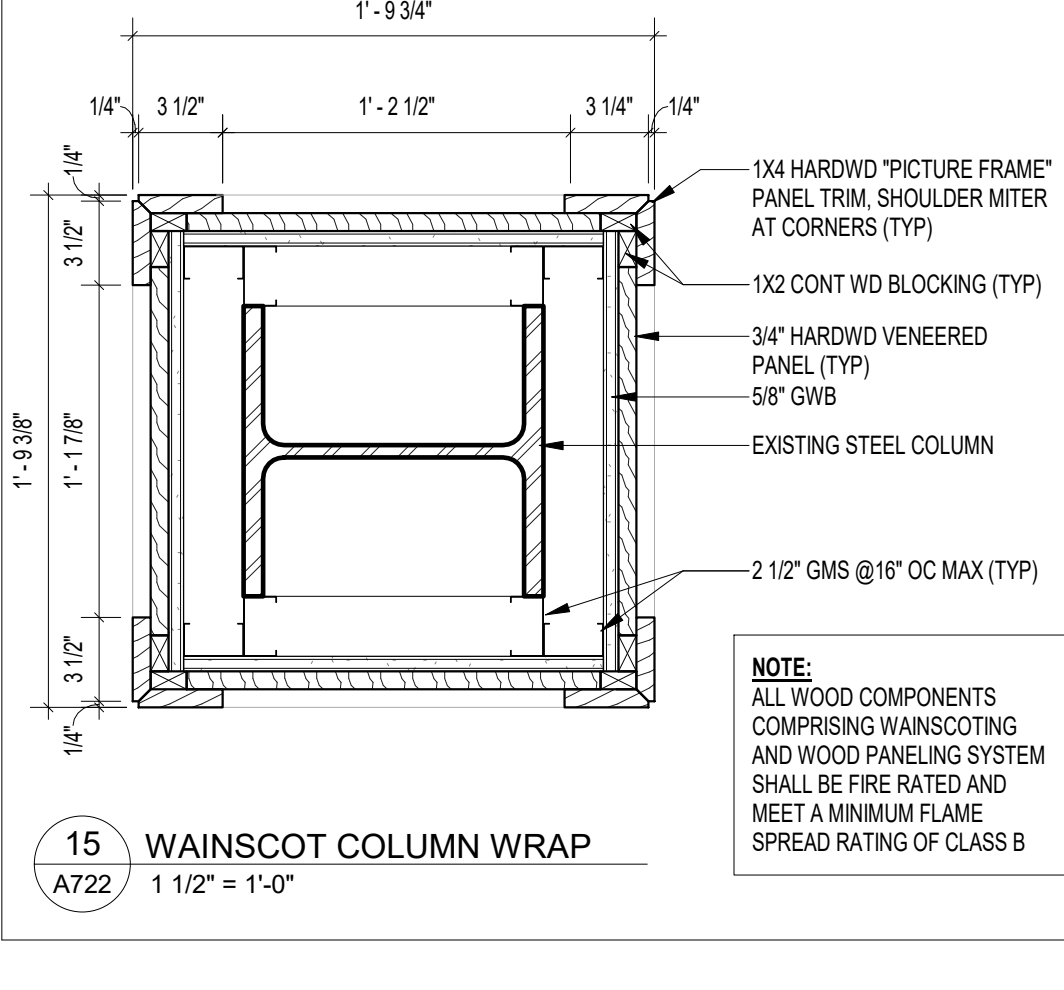


REV	DATE	DESCRIPTION
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DATE 18 OCTOBER 2023	DRAWN BY RMP	CHECKED BY RMP/BI
PROJECT NO 74000	CHECKED BY RMP/BI	
SHEET TITLE INTERIOR DETAILS		
SHEET NO A722	REV NO	

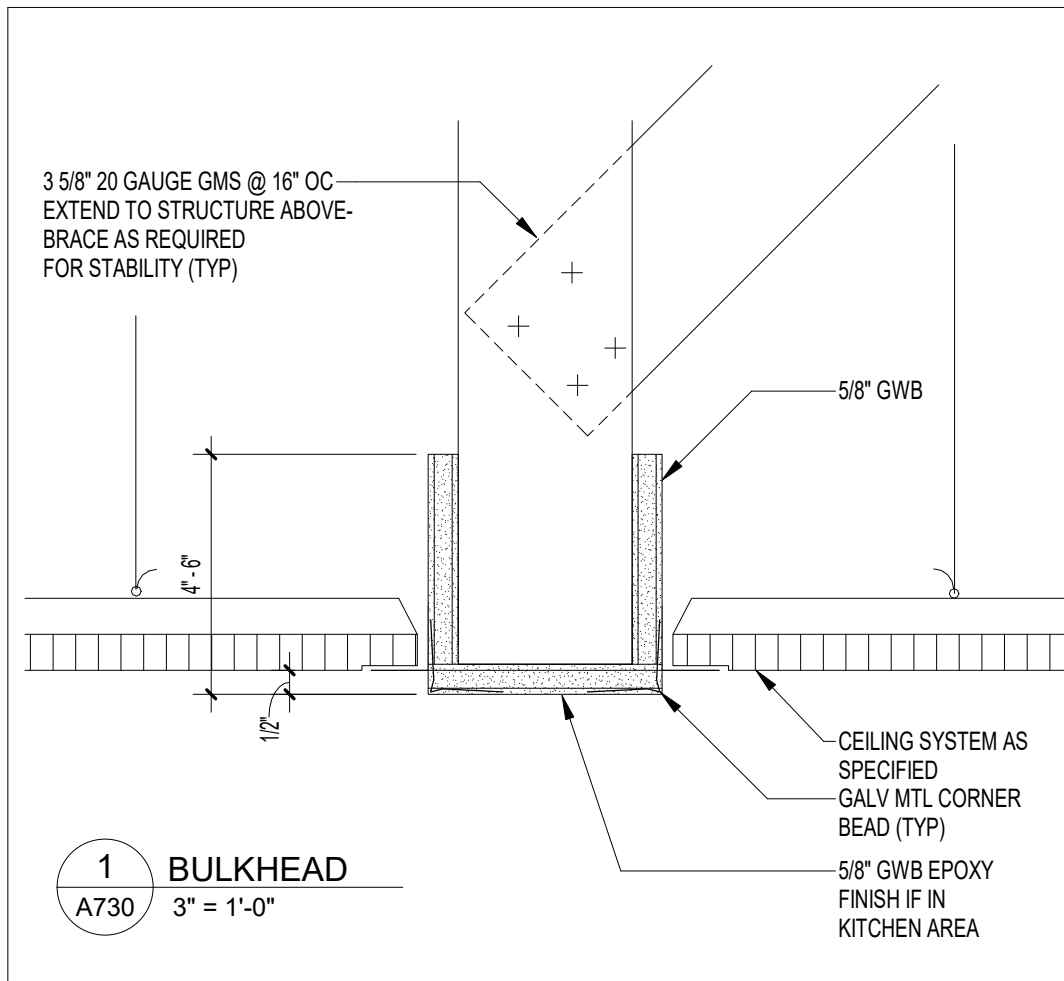


1 BULKHEAD
A730 3" = 1'-0"

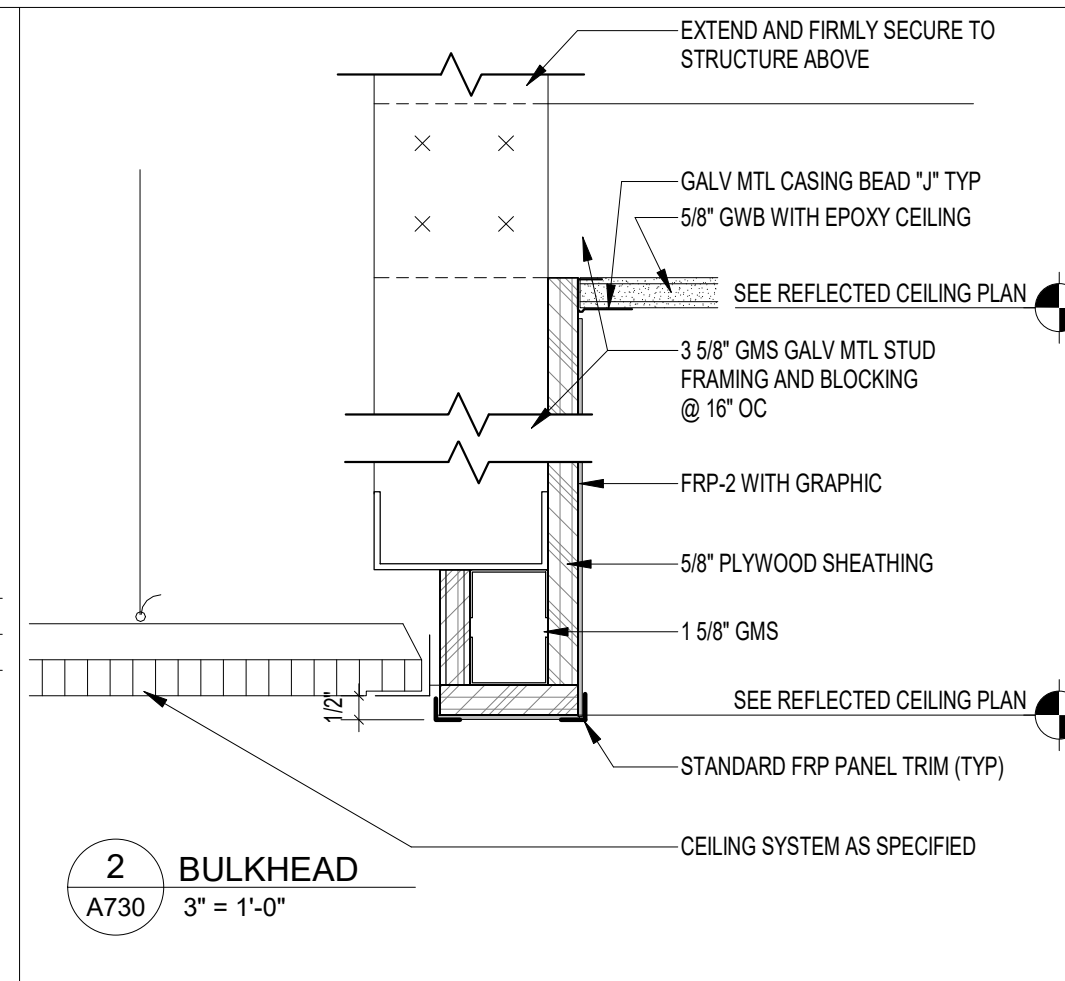


2 BULKHEAD
A730 3" = 1'-0"

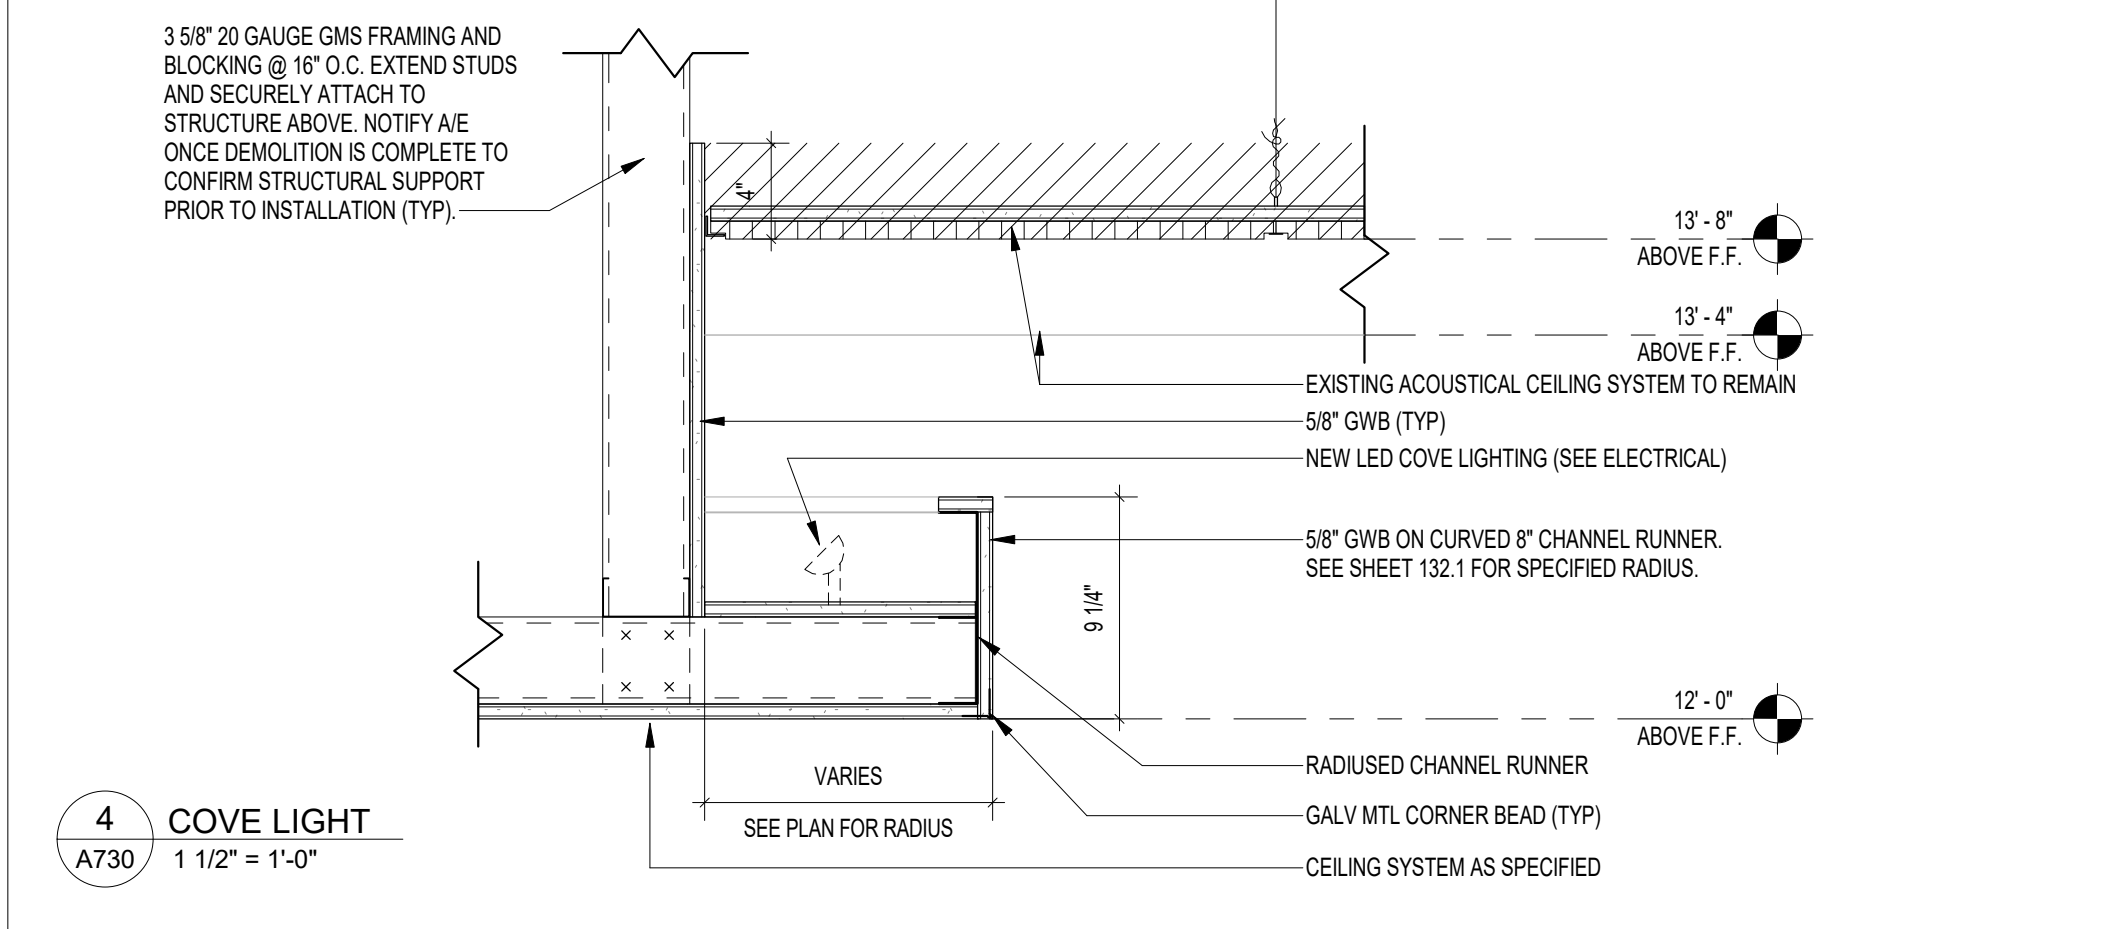


4 COVE LIGHT
A730 1 1/2" = 1'-0"

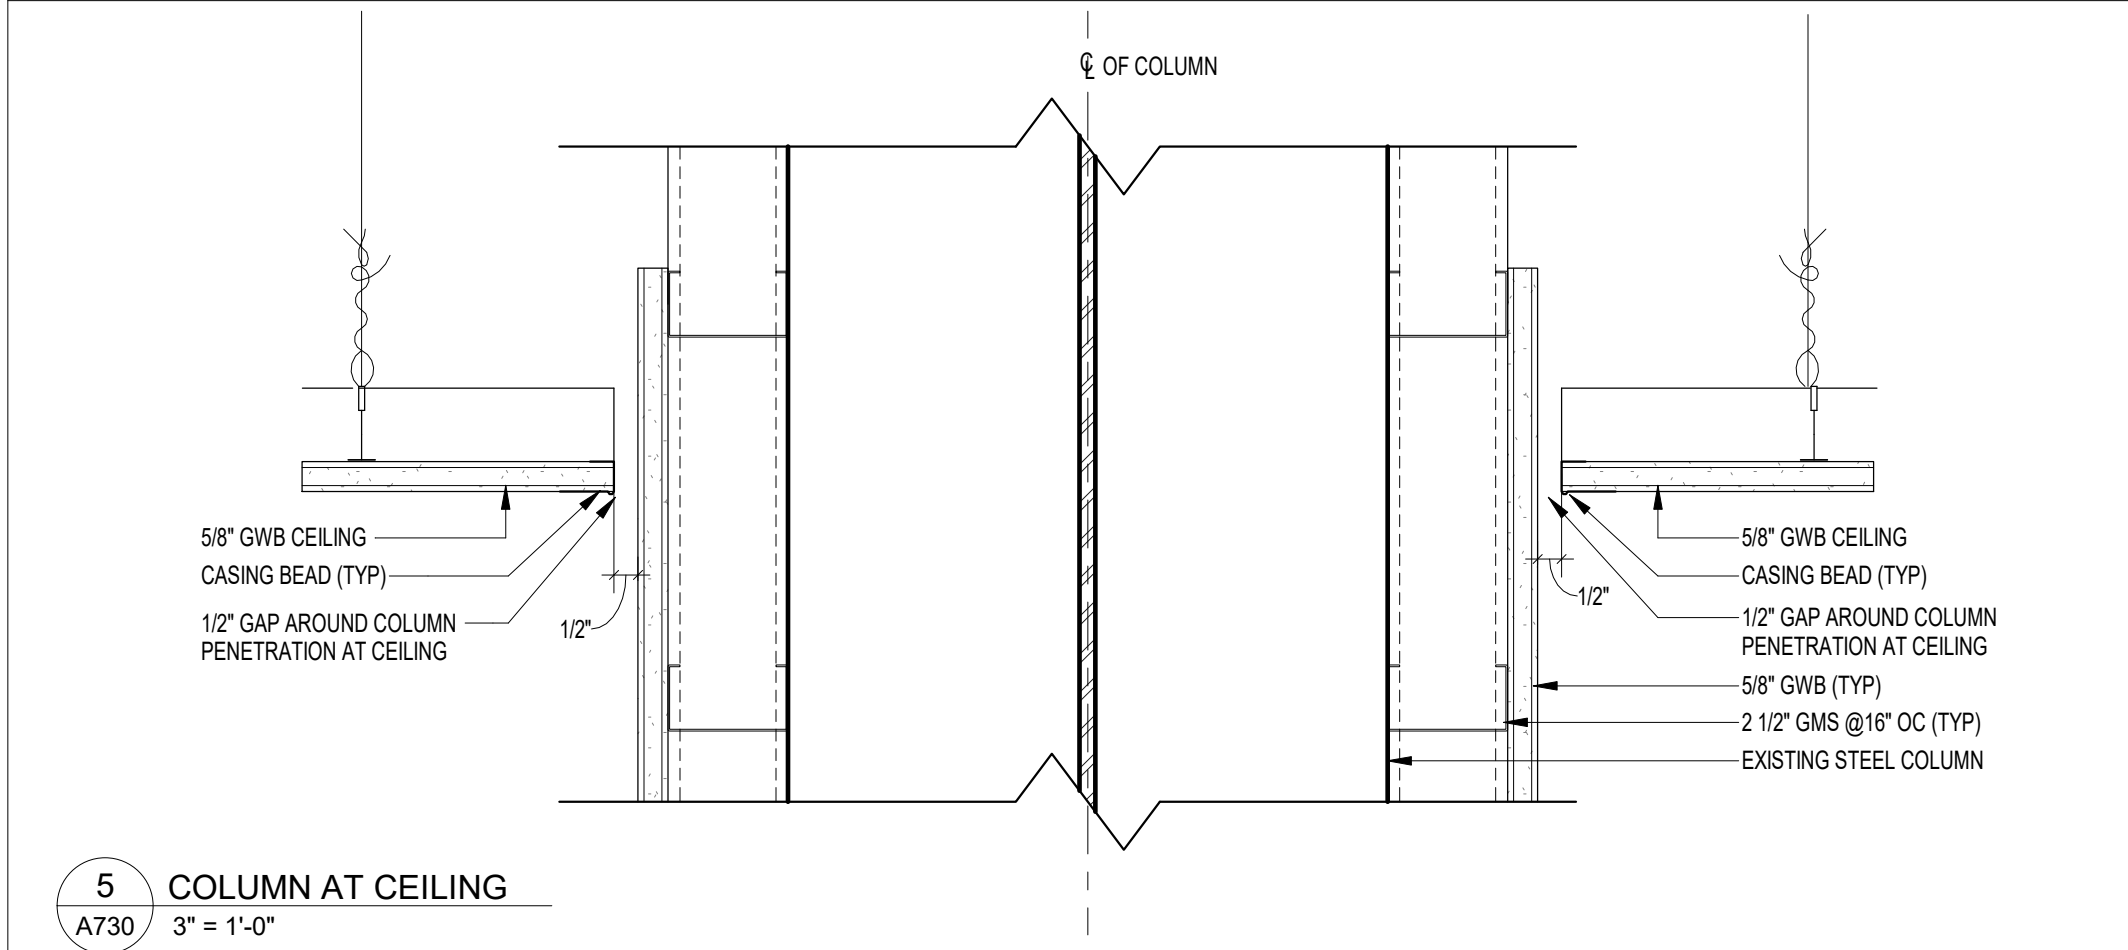


5 COLUMN AT CEILING
A730 3" = 1'-0"

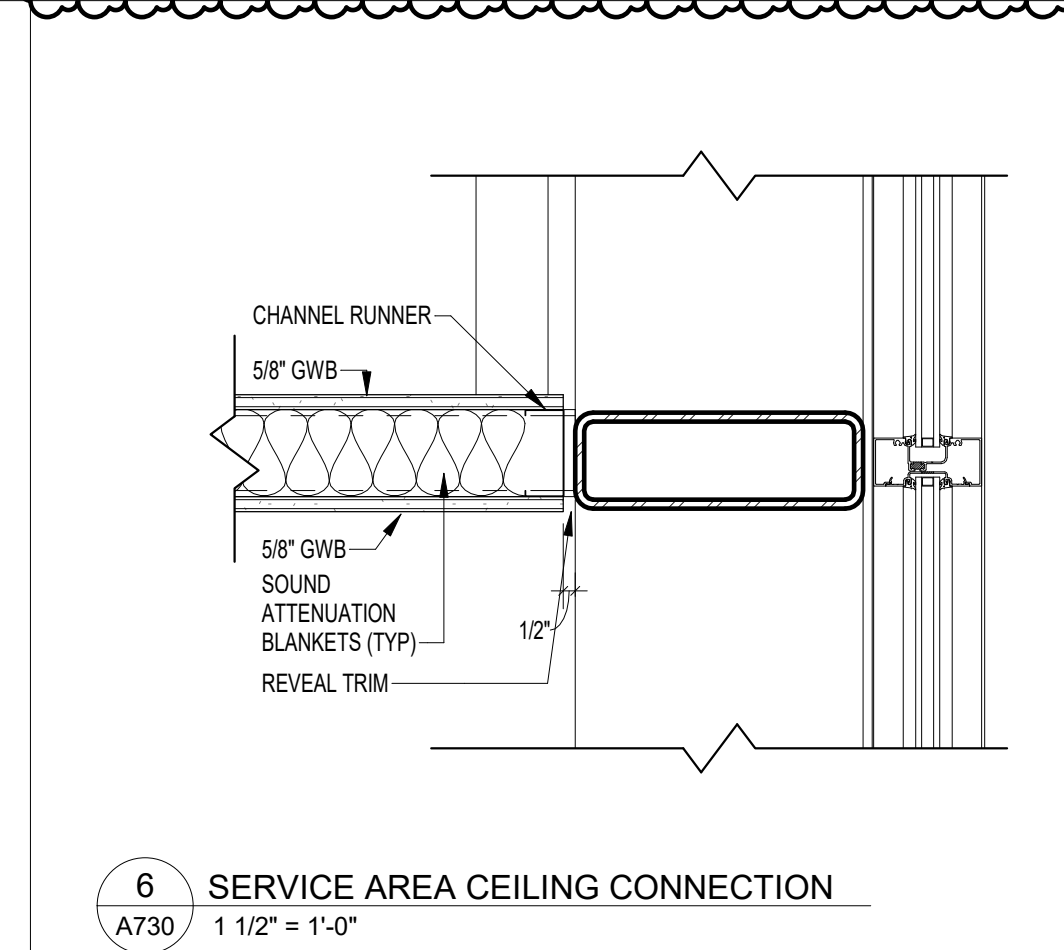


6 SERVICE AREA CEILING CONNECTION
A730 1 1/2" = 1'-0"

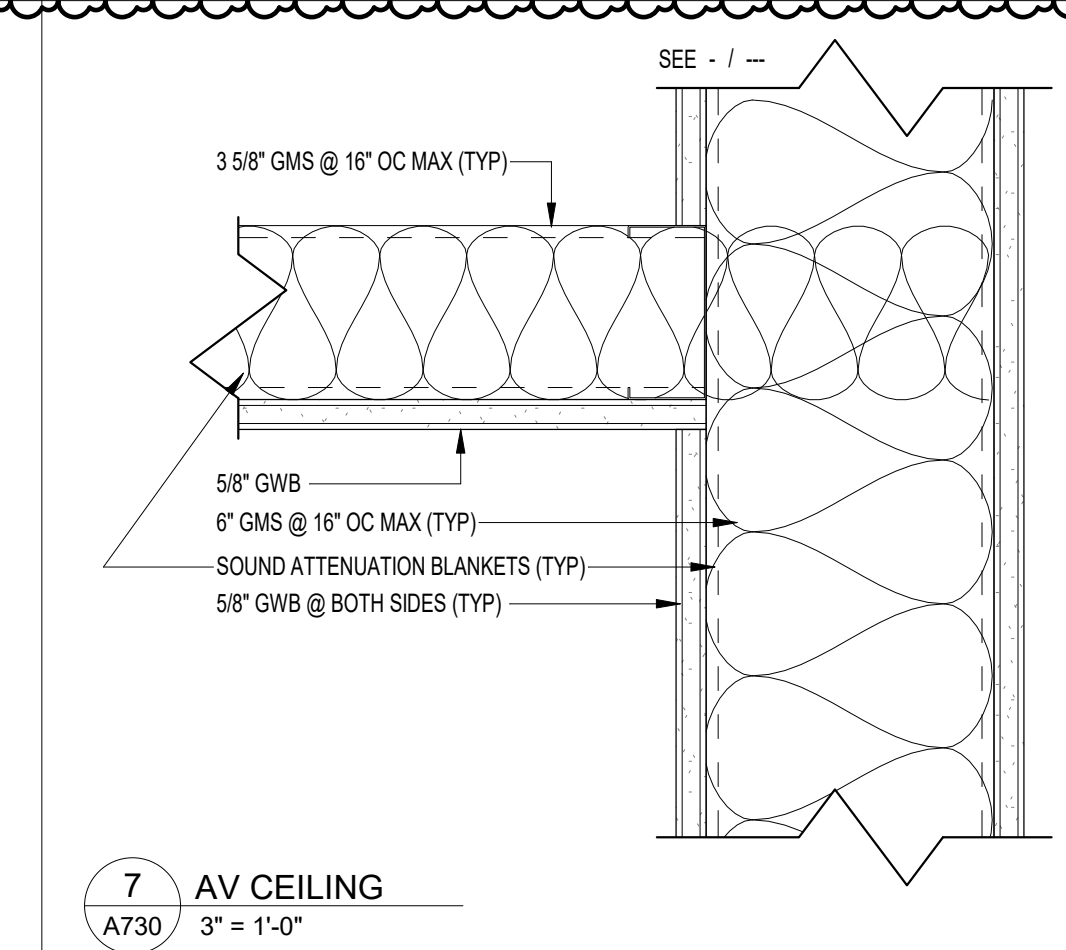


7 AV CEILING
A730 3" = 1'-0"

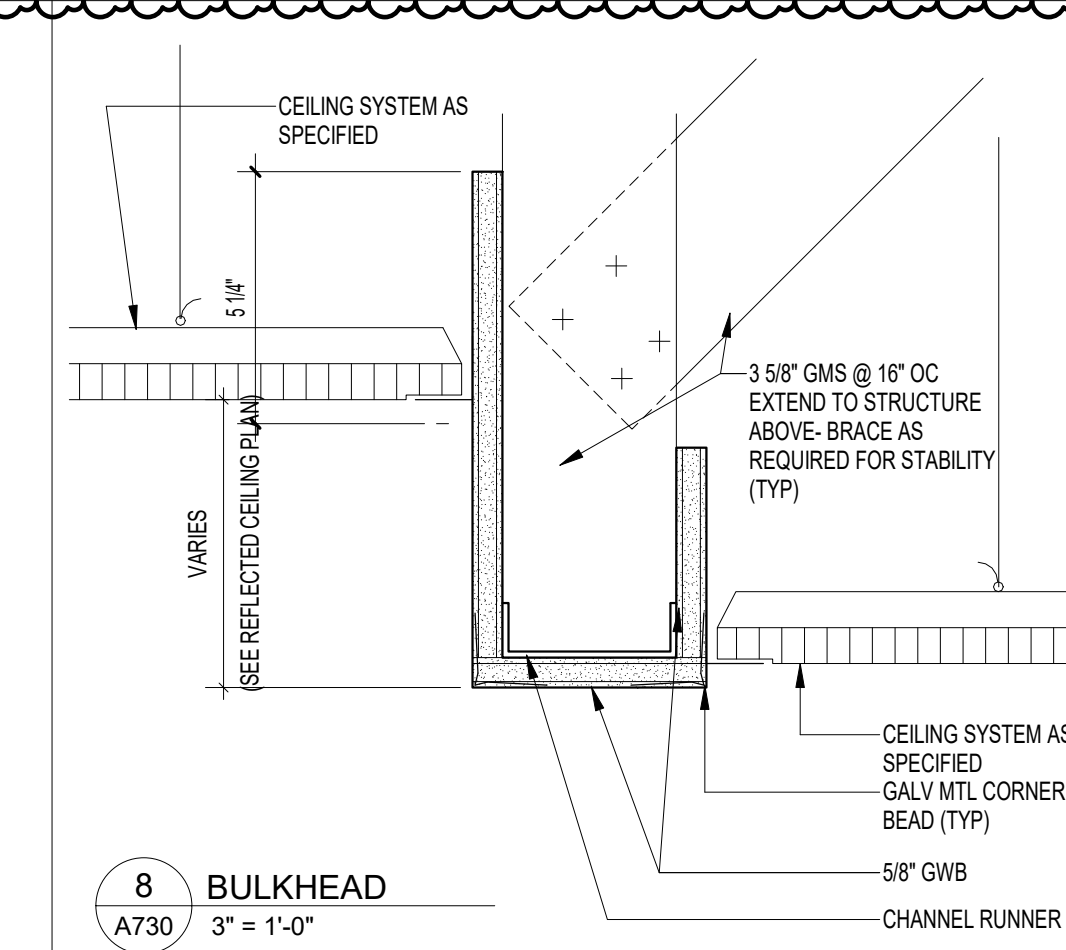

8 BULKHEAD
A730 3" = 1'-0"

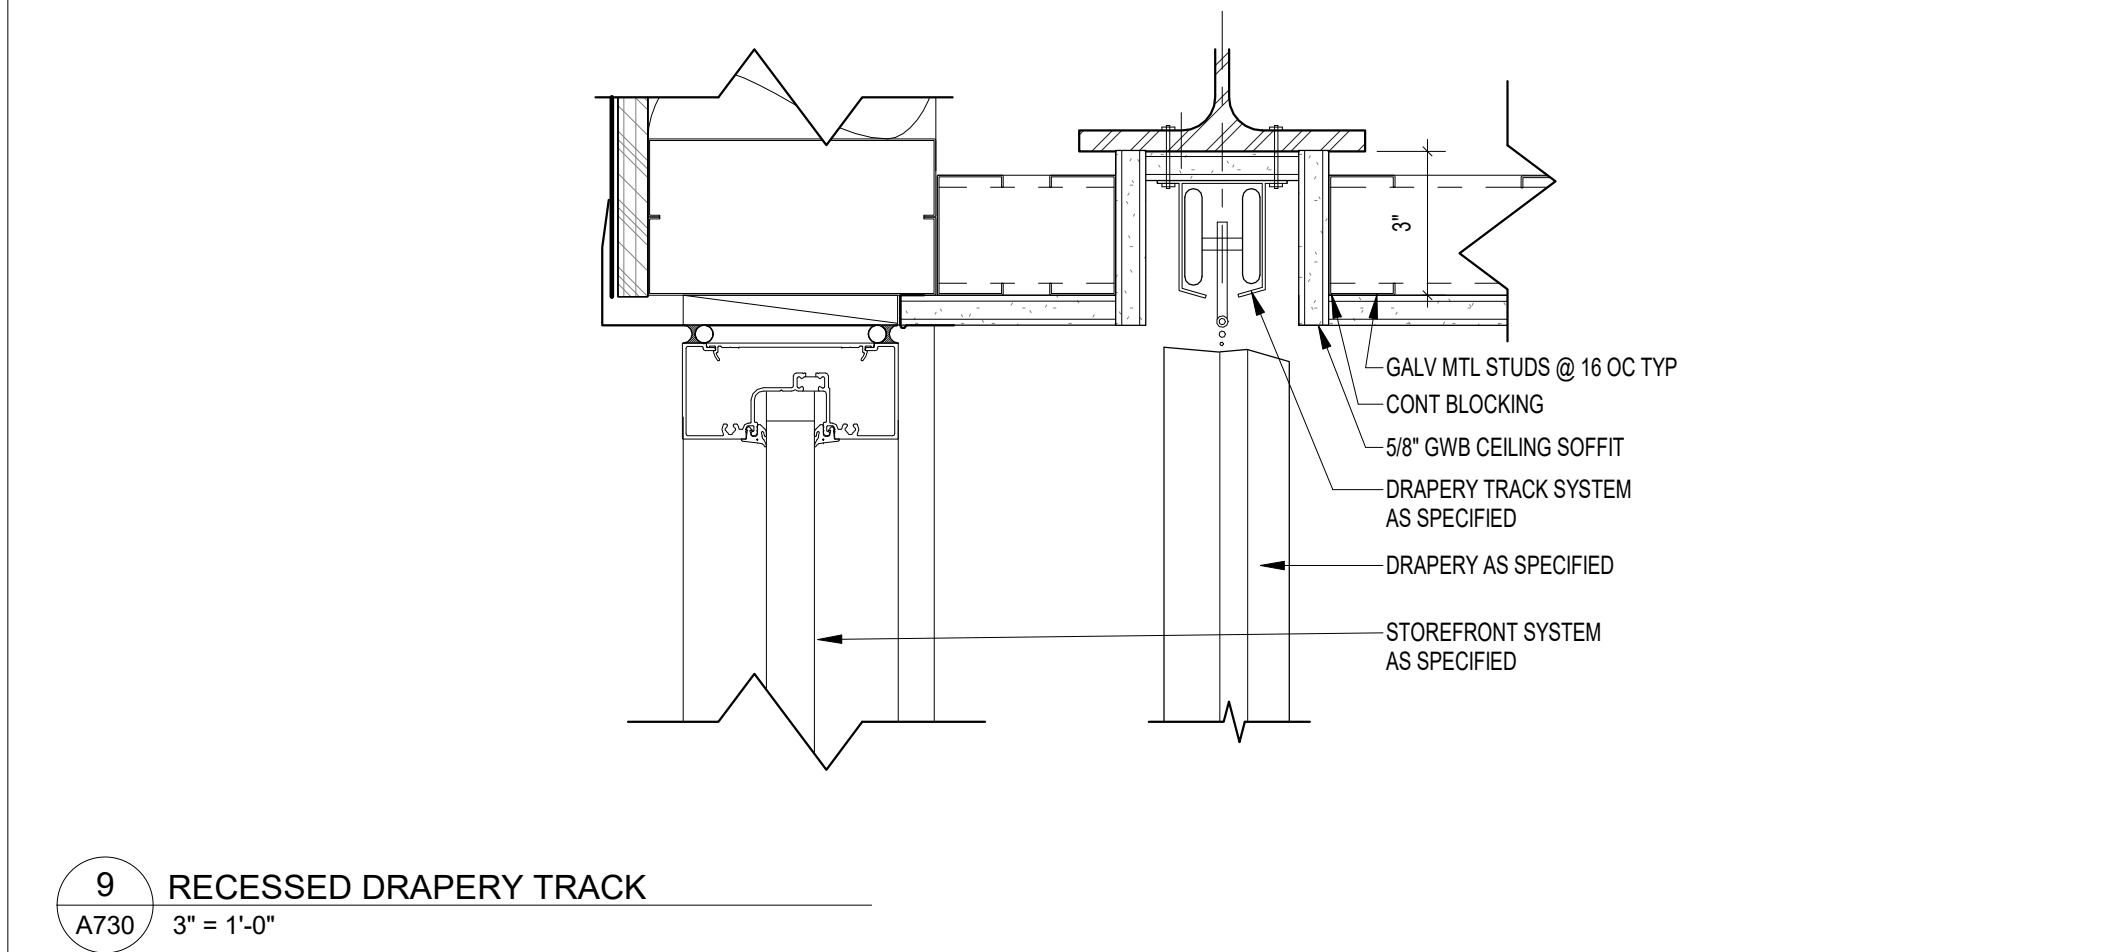


9 RECESSED DRAPERY TRACK
A730 3" = 1'-0"

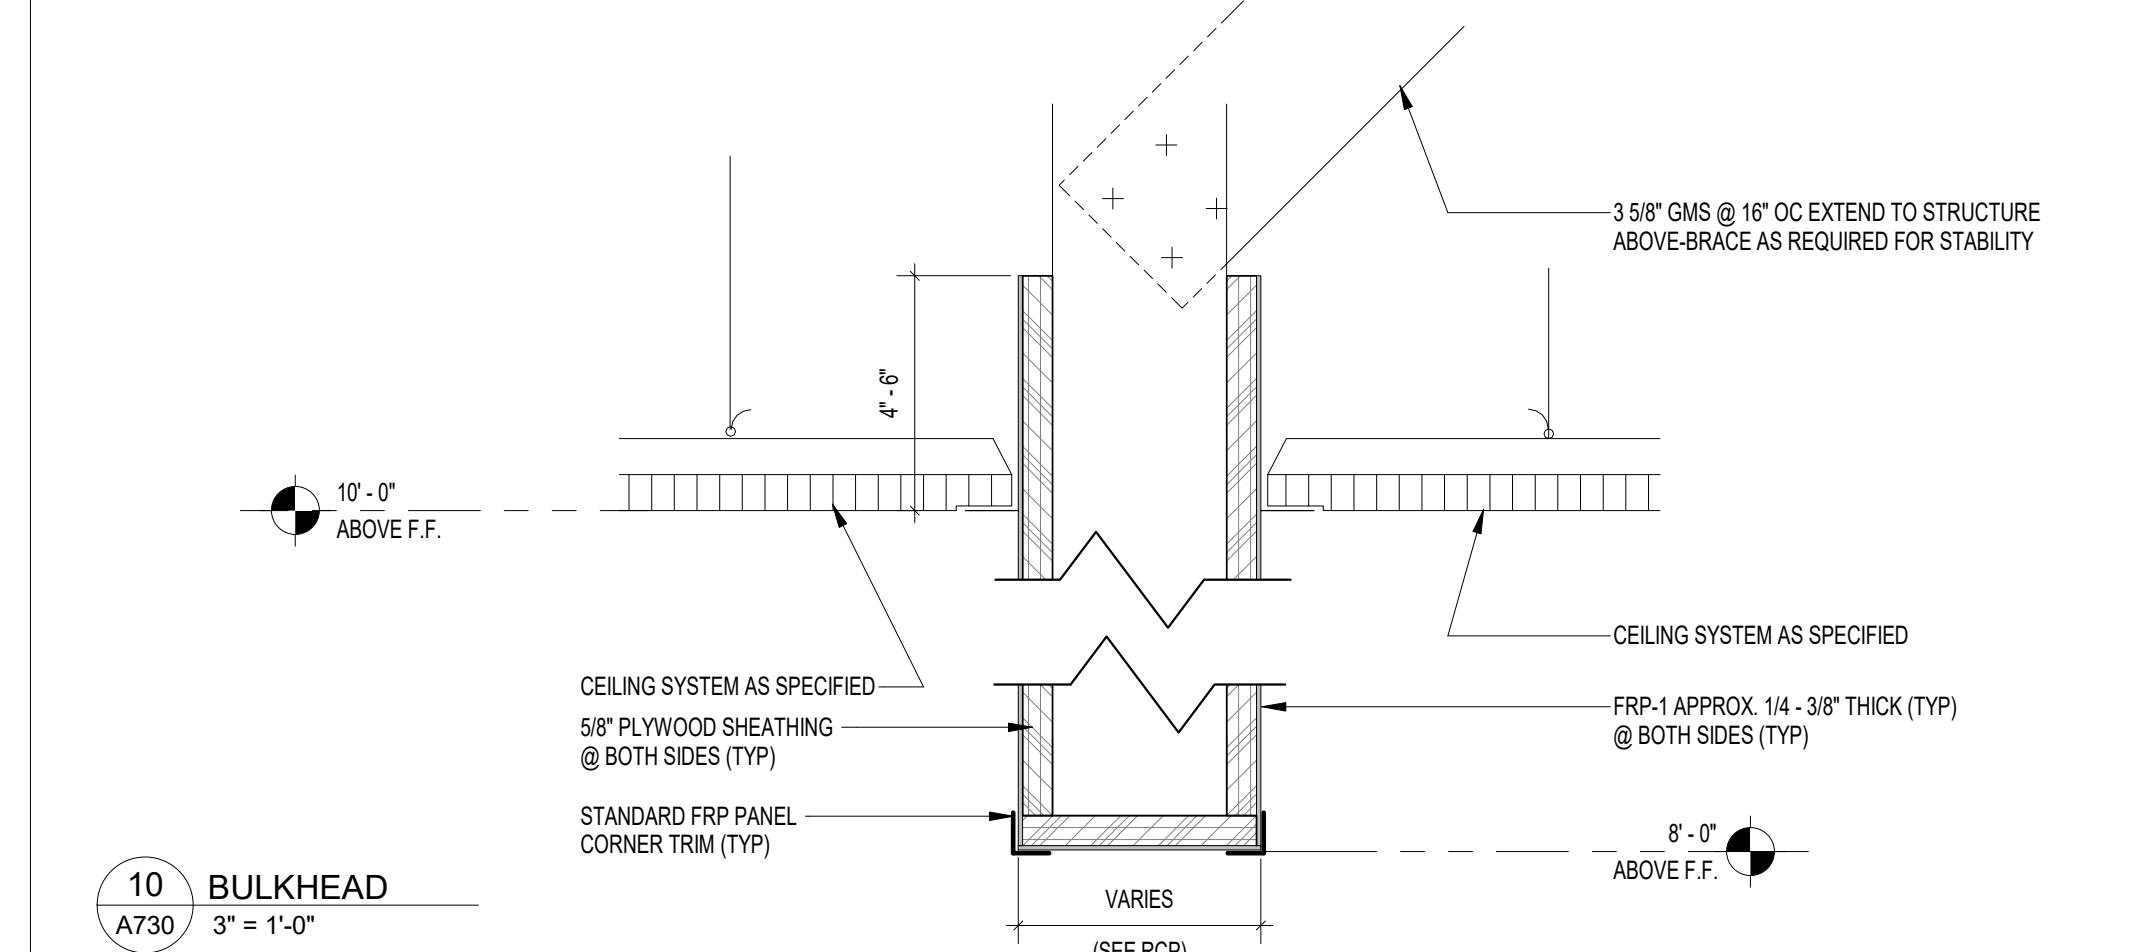

10 BULKHEAD
A730 3" = 1'-0"

NOTE:
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THE SCALE NOTED ON THESE DRAWINGS

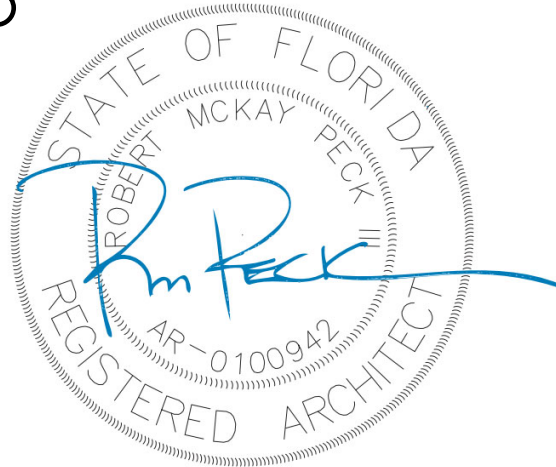


**FSU TURNBULL
CONFERENCE CENTER
RENOVATIONS**

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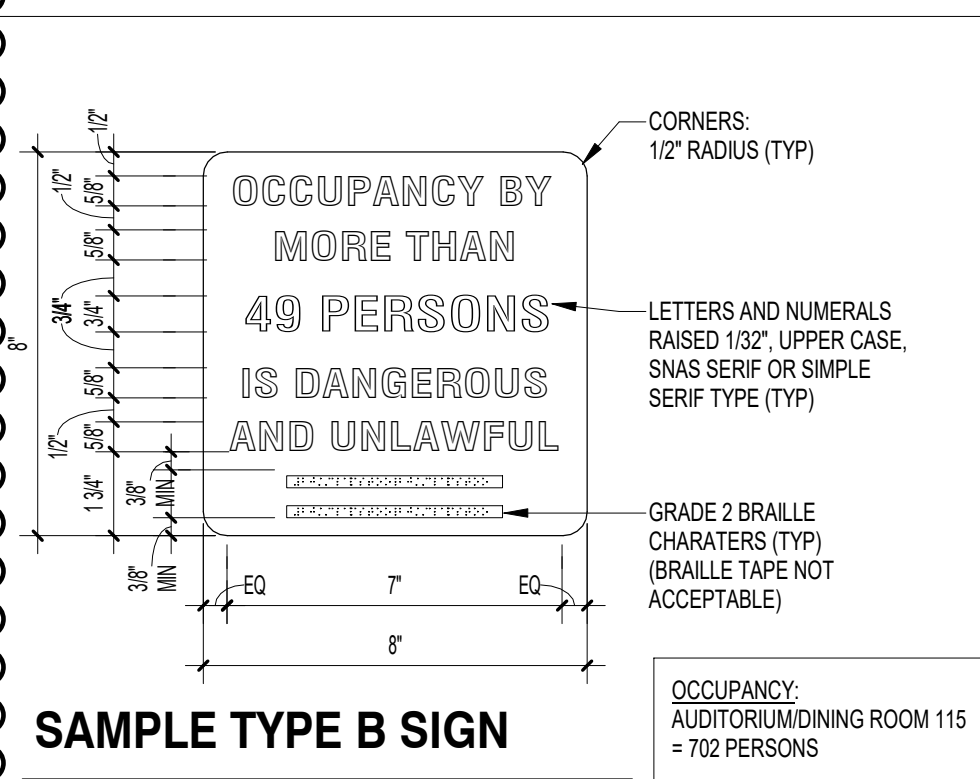
CEILING DETAILS

SHEET NO	REV NO
A730	1




SAMPLE TYPE A SIGN

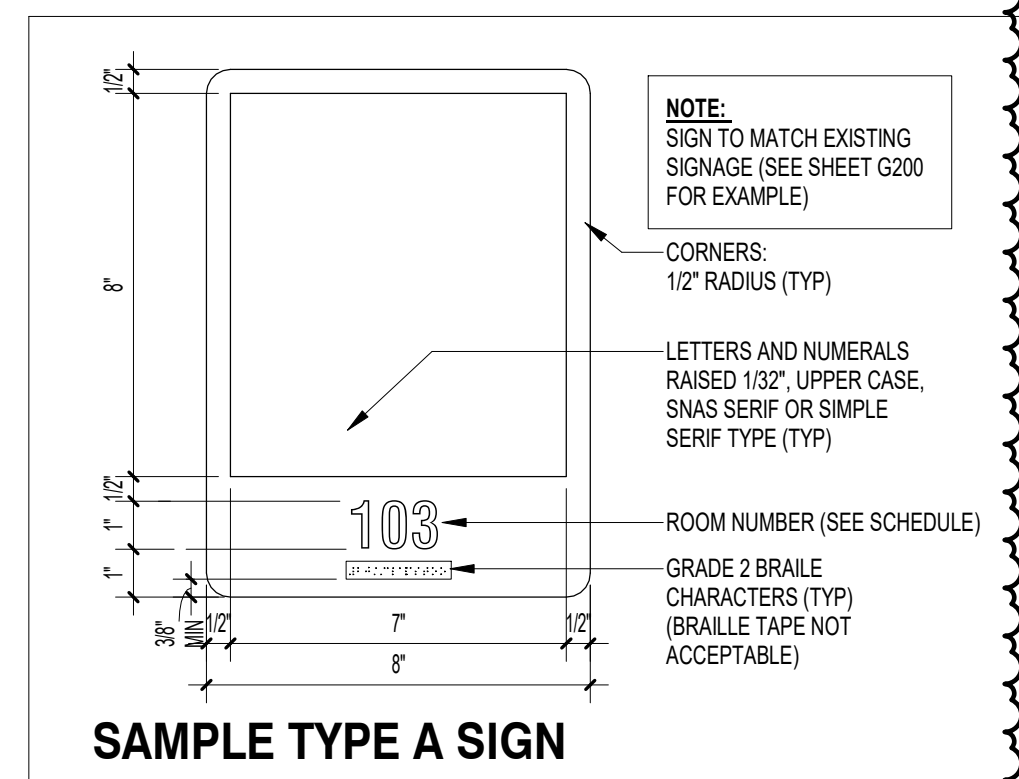WALL MOUNTED ROOM IDENTIFICATION SIGN. PROVIDE COMBINATION ROOM NUMBER AND ROOM NAME. RAISED LETTERS MUST BE ACCOMPANIED WITH GRADE 2 BRAILLE.




SAMPLE TYPE B SIGN

WALL MOUNTED ROOM OCCUPANCY SIGN. MOUNT SIGN ADJACENT TO THE MAIN ENTRANCE DOOR. VERIFY NUMBER OF PERSONS WITH ARCHITECT BEFORE PROCEEDING WITH FABRICATION.

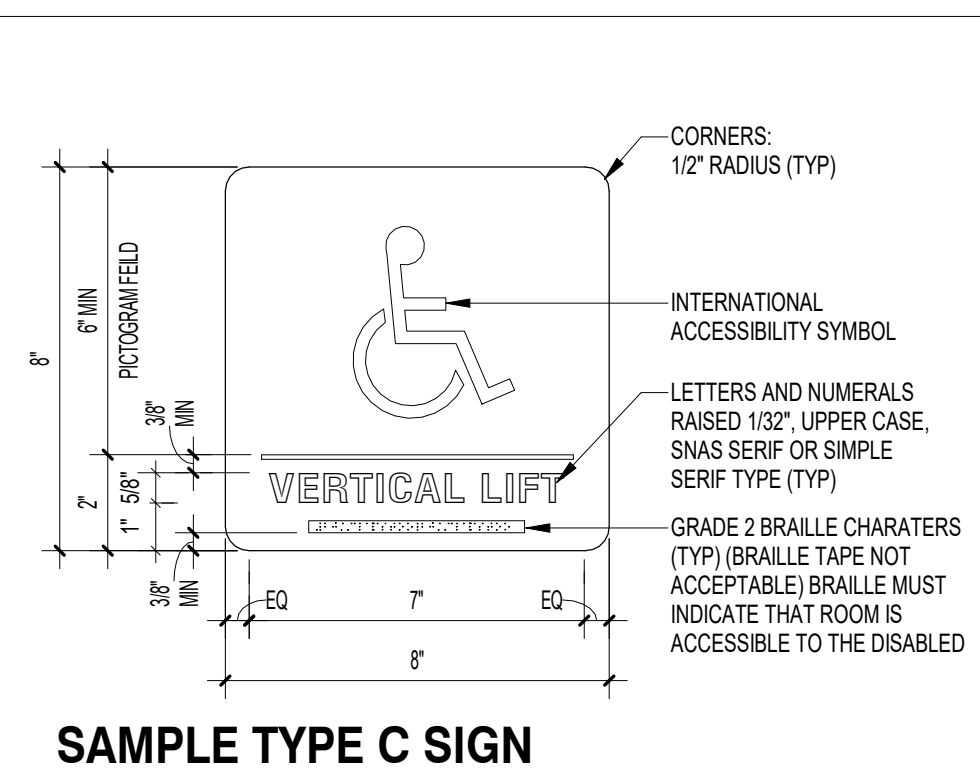

SAMPLE TYPE C SIGN

WALL MOUNTED SIGN. RAISED LETTERS MUST BE ACCOMPANIED WITH GRADE 2 BRAILLE. SIGN TO BE UV RESISTANT.

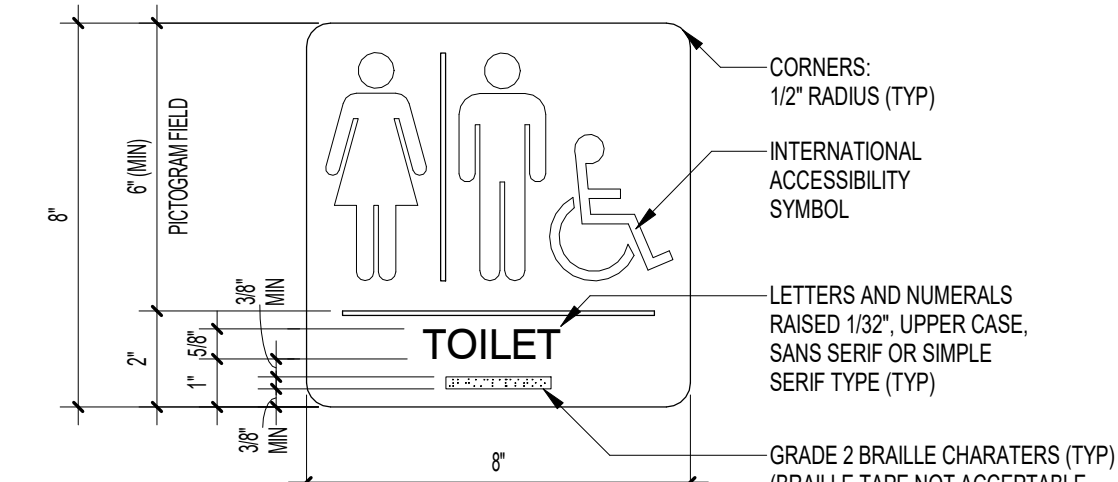


SAMPLE TYPE D SIGN

WALL MOUNTED RESTROOM IDENTIFICATION SIGN WITH ROOM NUMBER, INTERNATIONAL ACCESSIBILITY SYMBOL AND MALE AND FEMALE LOGO. RAISED LETTERS MUST BE ACCOMPANIED BY GRADE 2 BRAILLE.




SAMPLE TYPE E SIGN

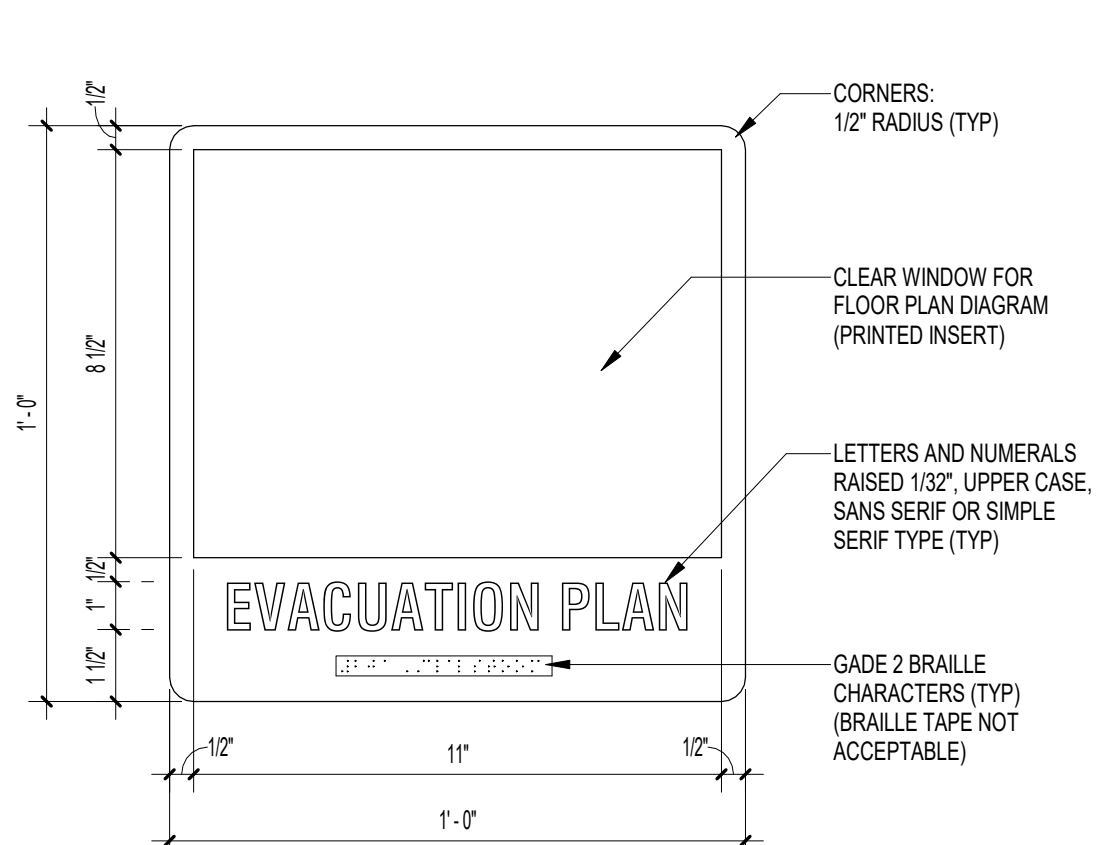


SAMPLE TYPE F SIGN

WALL MOUNTED SIGN WITH PRIMARY AND SECONDARY EVACUATION ROUTES INDICATED BY CONTRASTING COLORS AND NUMBERS. MOUNT SIGN ADJACENT TO THE PRIMARY EXIT DOOR FROM EACH STUDENT OCCUPIED SPACE. RAISED LETTERS MUST BE ACCOMPANIED WITH GRADE 2 BRAILLE.

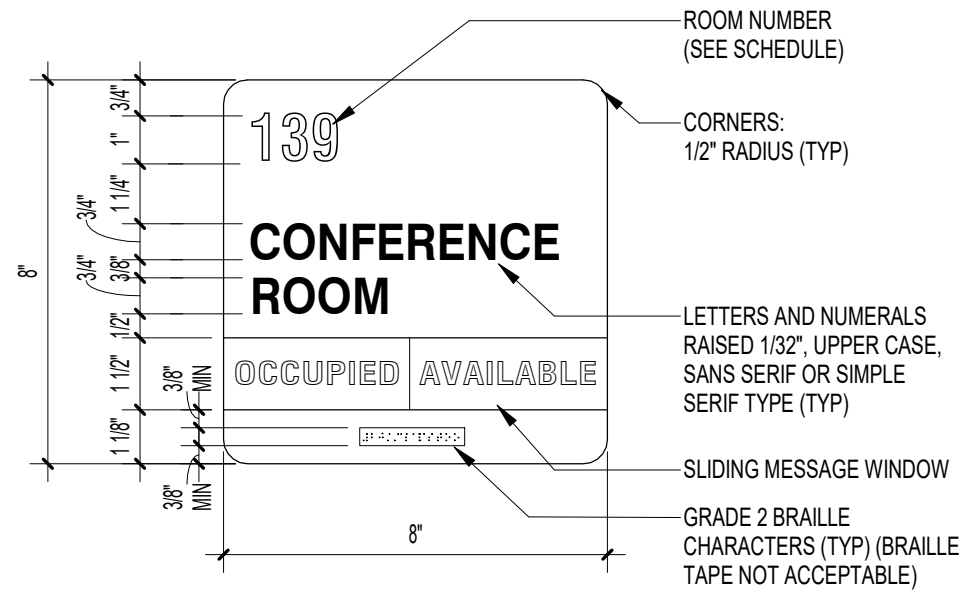



SAMPLE TYPE G SIGN

WALL MOUNTED ROOM IDENTIFICATION SIGN. RAISED LETTERS MUST BE ACCOMPANIED WITH GRADE 2 BRAILLE. PROVIDE COMBINATION ROOM NUMBER AND ROOM NAME WITH SLIDING MESSAGE WINDOW.

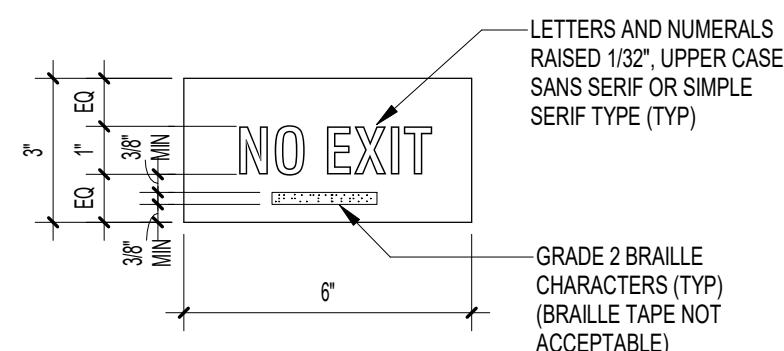

SAMPLE TYPE H SIGN

WALL MOUNTED SIGN.

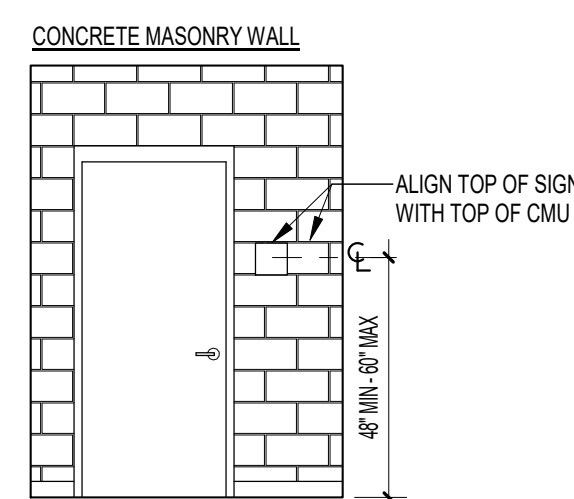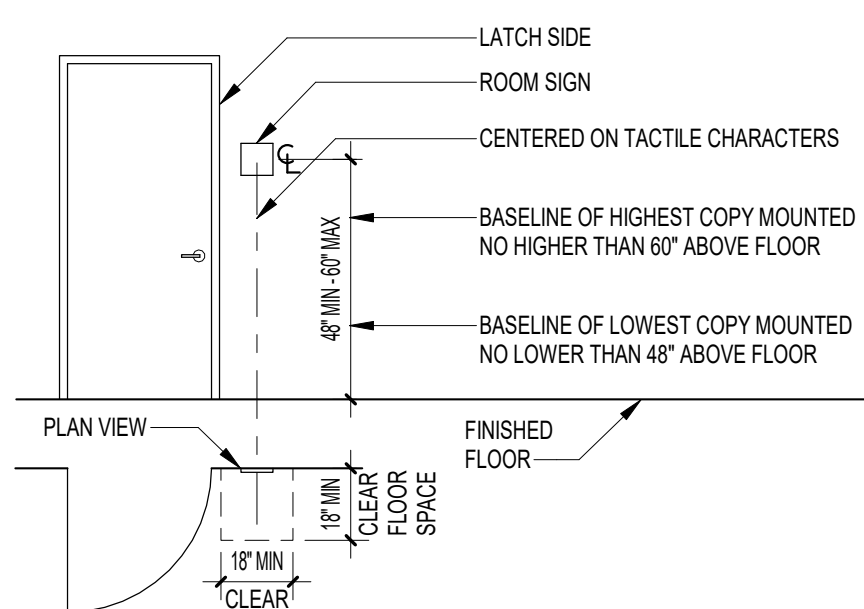

1 SIGNAGE LOCATION

- SIGN SCHEDULE NOTES:**
1. VERIFY ROOM NAMES, NUMBERS AND LOCATION WITH OWNER BEFORE PROCEEDING WITH FABRICATION. ROOM NUMBERS MAY REQUIRE RENUMBERING DUE TO ADJACENCIES.
 2. PLACEMENT OF SIGNS SHALL BE COORDINATED IN THE FIELD WITH THE ARCHITECT.
 3. EXTERIOR SIGNS SHALL BE UV RESISTANT.
 4. WHERE SIGNS OCCUR ON A GLASS PANEL, PROVIDE A PLAIN PANEL TO MATCH SIGN COLOR ON THE OPPOSITE SIDE OF THE GLASS.
 5. SIGNS WITH AN ASTERISK (*) IN THE NOTE COLUMN SHALL BE REVIEWED WITH OWNER TO DETERMINE NAMING OF SIGN.

SIGN SCHEDULE


NOTE	NO.	SPACE NAME	SIGN TYPE	QTY	LOCATION	NOTES
*	0101	CORE LOBBY	A	1	ADJACENT TO DOORS 0101C	
	115	CLASSROOM	A	1	ADJACENT TO DOOR 115	
	115	CLASSROOM	B	1	ADJACENT TO DOOR 115	
	143	STORAGE	A	1	ADJACENT TO DOOR 143	
	113V	VENDING	A	1	ADJACENT TO OPENING	
	144	AV ROOM	A	1	ADJACENT TO DOOR 144	
	144S	STORAGE	A	1	ADJACENT TO DOOR 144S	
	108	AUDITORIUM / DINING ROOM	A	1	ADJACENT TO DOOR 108A, 108B	
	108	AUDITORIUM / DINING ROOM	B	1	ADJACENT TO DOORS 108A, 108B	
	146	STAGE	A	1	ADJACENT TO LIFT	
	146	STAGE	C	1	ADJACENT TO LIFT	
	117A	KITCHEN	A	1	ADJACENT TO DOOR 117A	
	117A	KITCHEN	B	1	ADJACENT TO DOOR 117A	
	117B	KITCHEN	A	1	ADJACENT TO OPENING	BEVERAGE AREA
	117B	KITCHEN	B	1	ADJACENT TO OPENING	BEVERAGE AREA
	117C	KITCHEN	A	1	ADJACENT TO OPENING	KITCHEN (COLD PREP)
	117D	KITCHEN	A	1	ADJACENT TO OPENING	DISH PIT
	117E	KITCHEN	A	1	ADJACENT TO DOOR 117E	KITCHEN ACCESS
	117E	KITCHEN	B	1	ADJACENT TO DOOR 117E	KITCHEN ACCESS
	117F	KITCHEN RESTROOM	D	1	ADJACENT TO DOOR 117F	
	117S	STORAGE	A	1	ADJACENT TO DOOR 117S	
*	119	RECEIVING	A	1	ADJACENT TO DOOR 118	RECEIVING & HOLDING
	120	ELEC	A	1	ADJACENT TO DOOR 120	
	124	VESTIBULE	A	1	ADJACENT TO DOOR 124	
	124B	VESTIBULE	A	1	ADJACENT TO DOOR 124B	
	125	SERVICE AREA	A	1	ADJACENT TO DOOR 125	
	126	ELEC	A	1	ADJACENT TO DOOR 126	
	0200F	CORRIDOR	A	1	ADJACENT TO DOOR 0200F	
	0200F	CORRIDOR	B	1	ADJACENT TO DOOR 0200F	
	209	JANITOR	A	1	ADJACENT TO DOOR 209	
	211M	MECHANICAL	A	1	ADJACENT TO DOOR 211M	
	212	STORAGE	A	1	ADJACENT TO DOOR 212	
	213	STORAGE	A	1	ADJACENT TO DOOR 213	
	213A	STAGING AREA	A	1	ADJACENT TO DOOR	
	214	CLASSROOM	A	1	ADJACENT TO DOOR	
	214	CLASSROOM	B	1	ADJACENT TO DOOR	
	S301	STAIR	A	1	ADJACENT TO DOOR	



ARCHITECTURE
PLANNING INTERIORS
GRAPHICS

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251 E. 7TH AVENUE, TALLAHASSEE FL 32303
(850) 222-7442
www.emiarch.com
LICENSE #A-AC-000409 IB C200153

NOTE:
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**FSU TURNBULL
CONFERENCE CENTER
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SHEET TITLE
SIGNAGE SCHEDULE
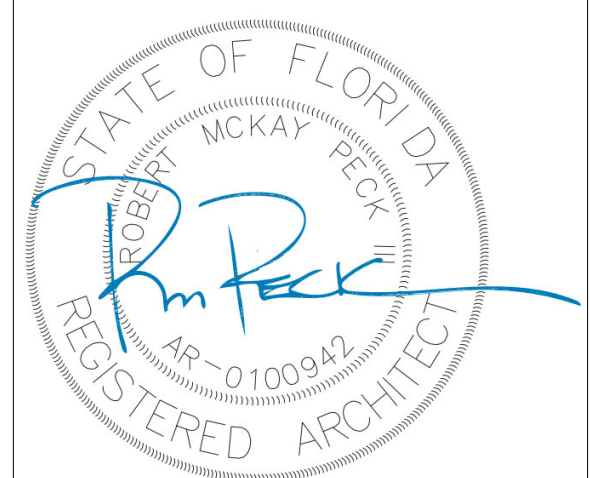
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