


DATE	07-21-24
DRAWN BY	DBC
REVISED	
JOB NO.	23-208
DATE	
SHEET NUMBER	A1.1

- GENERAL ROOF NOTES**
- DIMENSIONS NOTED ON ROOF PLANS ARE MEASURED HORIZONTALLY, NOT ALONG SLOPE OF ROOF. COORDINATE DIMENSIONS WITH FLOOR PLAN.
 - COORDINATE EXHAUST FAN AND VTR QUANTITY AND LOCATIONS WITH MECH / PLUMBING DRAWINGS.
 - ROOF PENETRATIONS SHALL BE TIED TOGETHER AS ALLOWABLE BY CODE TO REDUCE NUMBER OF PENETRATIONS. VTR AND EXHAUST PENETRATIONS SHALL BE A MINIMUM OF 4'-0" FROM EDGE OF ROOF (TYP.)
 - PROVIDE AND MAINTAIN A WARRANTY AGAINST DEFECTS IN MATERIAL AND WORKMANSHIP INCLUDING WEATHER-TIGHTNESS. THE WEATHER-TIGHTNESS WARRANTY SHALL INCLUDE ROOF, RIDGE FLASHING, ETC. MEETING THE WIND DESIGN SPEED FOR THE PROJECT LOCATION.
 - PROVIDE ALL COMPONENTS FOR A COMPLETE ROOF SYSTEM AND FLASHING SYSTEM, EVEN IF NOT SPECIFICALLY NOTED TO PROVIDE COMPLETE WATER-TIGHTNESS CONDITION.
 - A SEPARATE ROOFING PERMIT SHALL BE REQUIRED PRIOR TO ANY ROOF COVERING MATERIAL BEING INSTALLED.
 - BASIC WIND SPEED PER FBC: 140 MPH (3-SECOND GUST) PER ASCE-7.
 - COORDINATE WITH STRUCTURAL / WIND LOAD ANALYSIS.
 - IF APPLICABLE, SIZE AND INSTALL GUTTERS AND DOWNSPOUTS PER SMACNA GUIDELINES. LOCATE DOWNSPOUTS AS INDICATED IN DRAWINGS AND NOTIFY ARCHITECT IF ANY CONFLICTS OCCUR.
 - VERIFY ALL DIMENSIONS WITH FINAL PEMB SHOP DRAWINGS.
 - ALL CONSTRUCTION SHALL BE PER CODES STATED ON THE COVER SHEET.
 - SEE BUILDING SECTIONS, WALL SECTIONS AND ELEVATIONS FOR ALL BUILDING HEIGHTS.
 - VENTILATION OF CONCEALED ROOF SPACES SHALL BE MAINTAINED.
 - COORDINATE ALL SECONDARY ROOF DRAIN LOCATIONS WITH ELEVATIONS.
 - COORDINATE ALL PLUMBING FOR STORM PIPING ROUTING REQUIREMENTS.

- GENERAL NOTES**
- M.B.M. - METAL BUILDING MANUFACTURER. ALL STRUCTURAL STEEL, INCLUDING, BUT NOT LIMITED TO BEAMS, COLUMNS, JOISTS, PURLINS, GIRTS, DECKING, CLIP ANGLES, ROOFING, ROOF FLASHING, BACK PANELS AND ALL ASSOCIATED CONNECTIONS SHALL BE DESIGNED, ENGINEERED AND SUPPLIED BY THE M.B.M. SUPPLIED BY A FLORIDA REGISTERED ENGINEER. SHOP DRAWINGS SHALL BE FORWARDED TO CONN ARCHITECTS.
 - THE M.B.M. SHALL CHECK AND VERIFY ALL METAL BUILDING COMPONENTS AND NOTIFY THE ARCHITECT IMMEDIATELY OF ANY DISCREPANCIES OR NECESSARY ADDITIONAL STRUCTURAL COMPONENTS.
 - THE CONTRACTOR SHALL CHECK AND VERIFY ALL CONDITIONS AND DIMENSIONS AND NOTIFY THE ARCHITECT / ENGINEER IMMEDIATELY OF ANY DISCREPANCIES.


PRE-ENGINEERED AWNING NOTE

DUE TO CONSTRUCTION VARIANCES, IT IS RECOMMENDED THAT THE CONTRACTOR COORDINATE THE INSTALLATION OF EXTERIOR FINISHES AT ALL PRE-ENGINEERED AWNING LOCATIONS. IT IS THE RESPONSIBILITY OF THE CONTRACTOR TO VERIFY THE EXACT DIMENSIONS OF ALL PRE-ENGINEERED AWNINGS PRIOR TO THEIR FABRICATION AND INSTALLATION. CONTRACTOR SHALL NOTIFY ARCHITECT OF ANY DISCREPANCIES PRIOR TO COMMENCEMENT OF WORK.

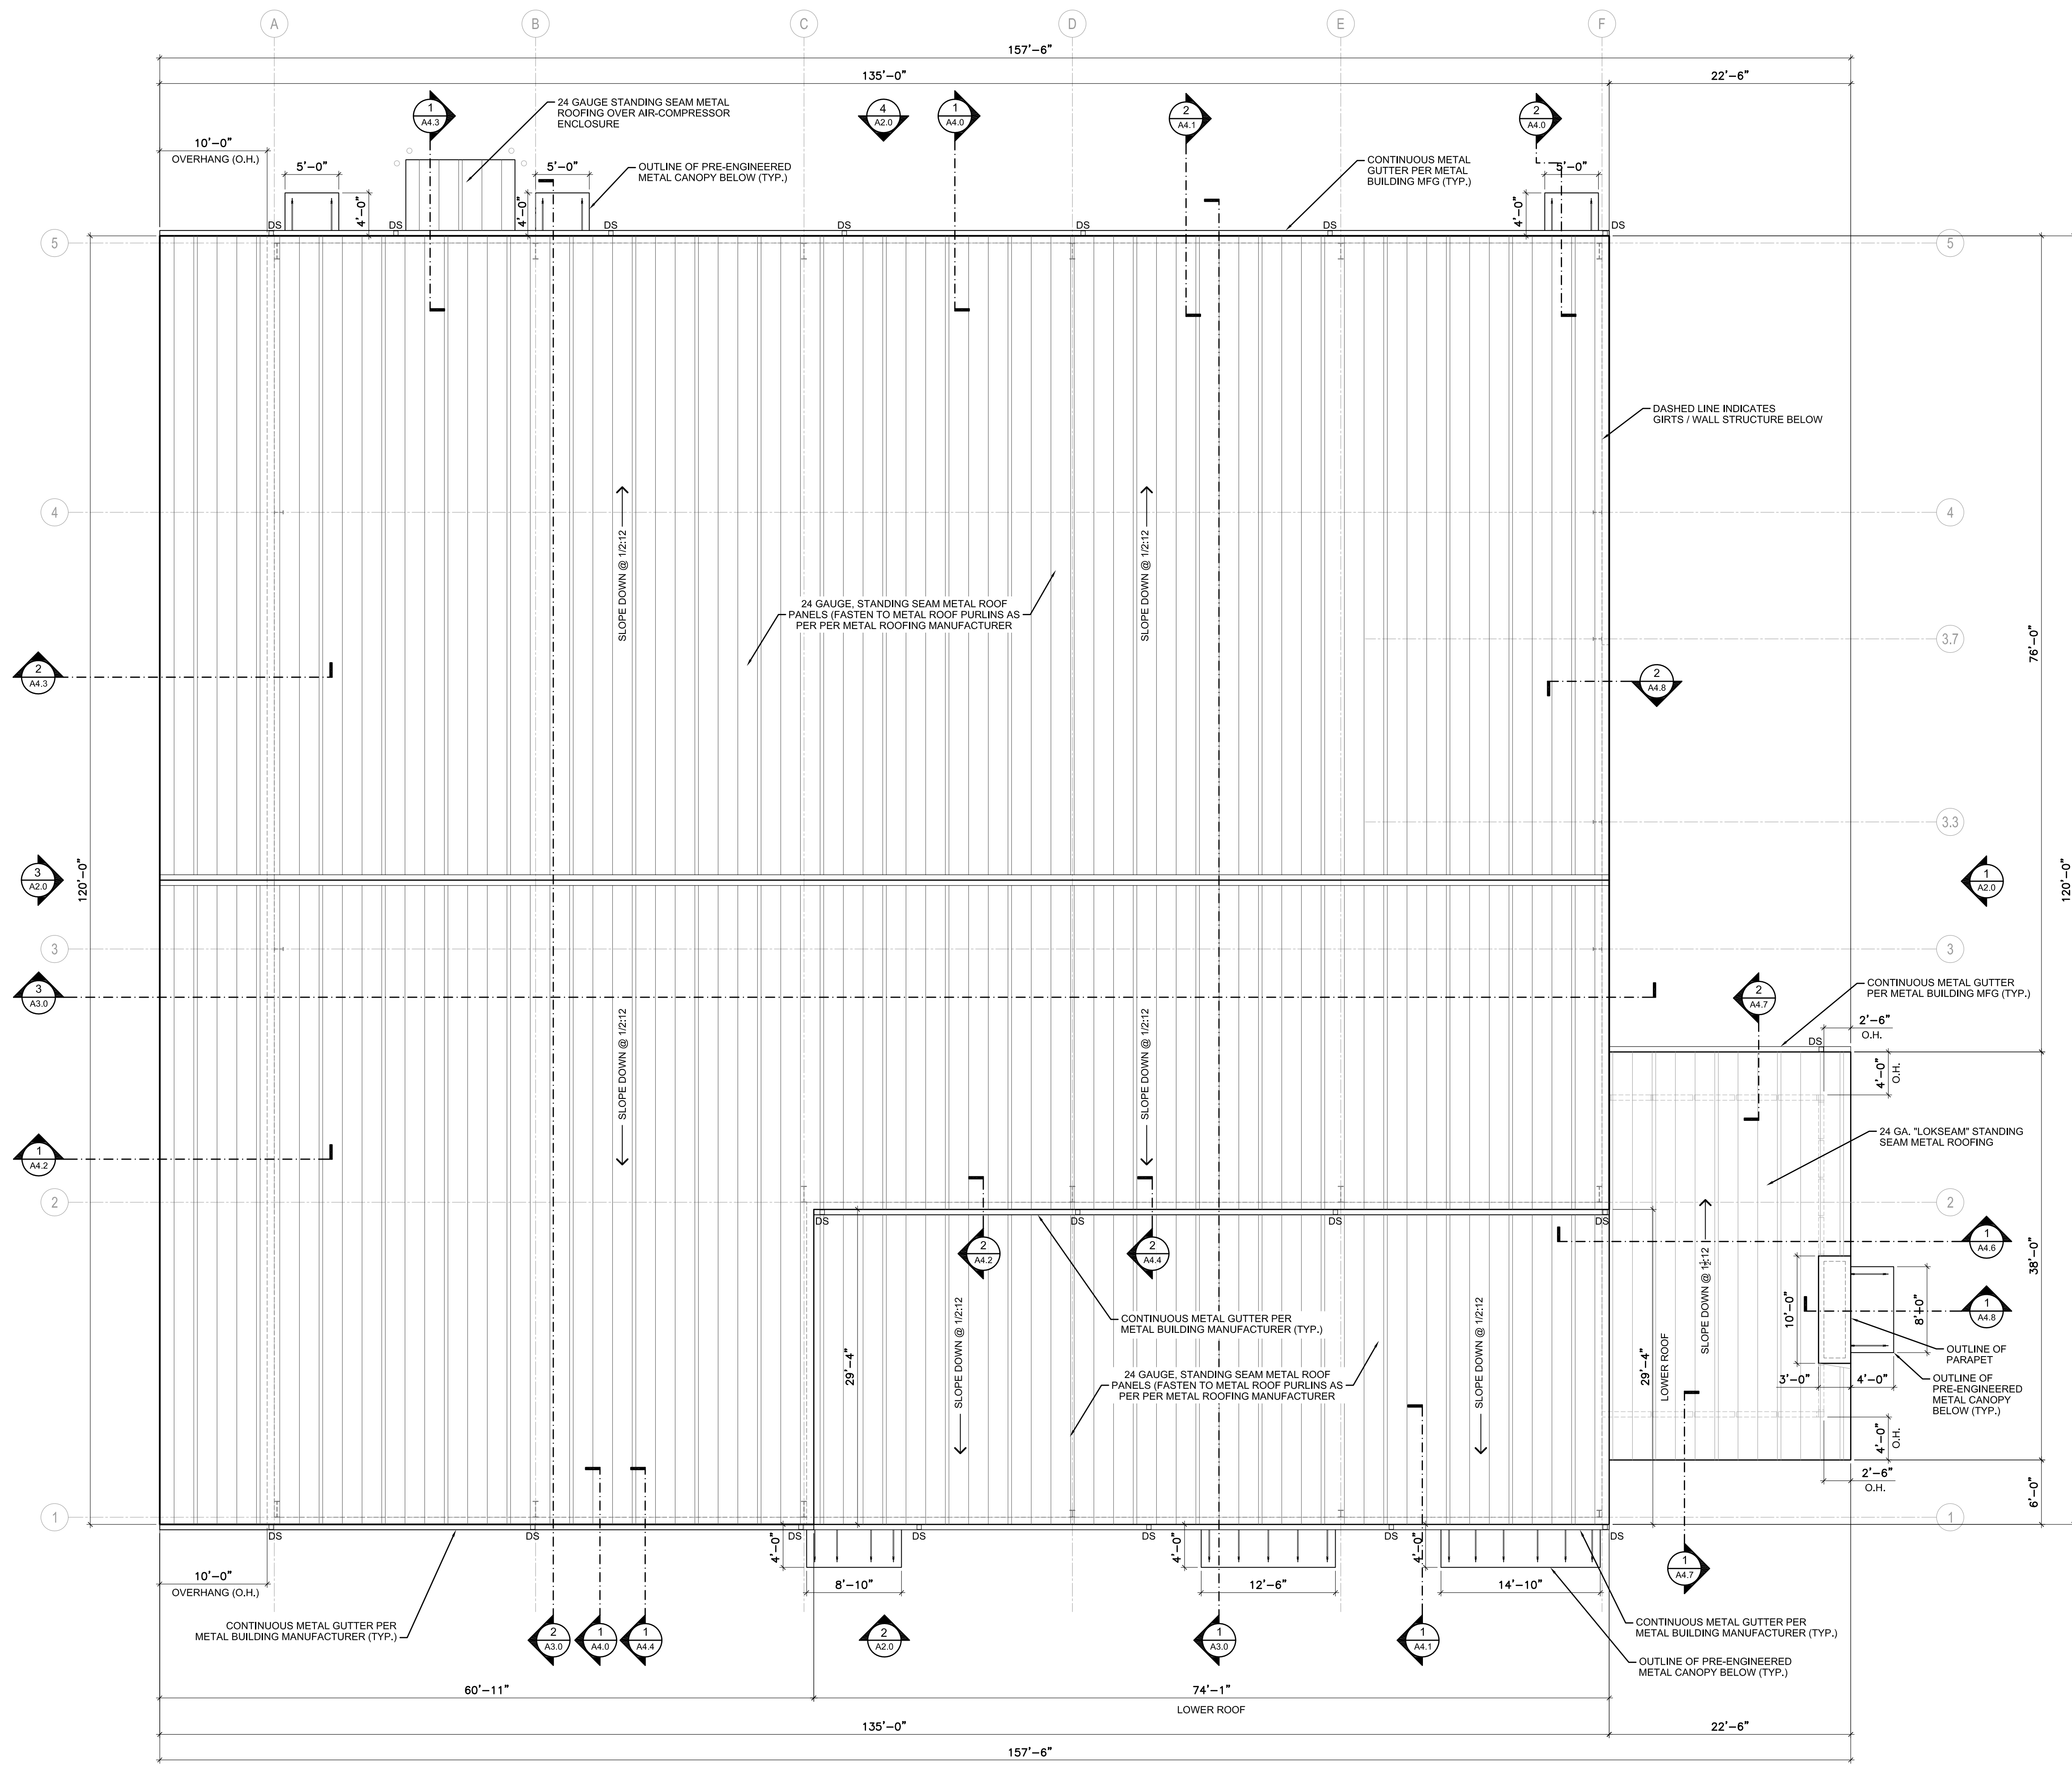

1 ROOF PLAN
A1.1 SCALE: 1/8" = 1'-0"

CONTRACTOR SHALL VERIFY ALL DIMENSIONS AND CONDITIONS PRIOR TO CONSTRUCTION. THE CONTRACTOR SHALL BE RESPONSIBLE FOR OBTAINING ALL NECESSARY PERMITS AND APPROVALS. ANY DISCREPANCIES OR CHANGES SHALL BE NOTIFIED IMMEDIATELY TO THE ARCHITECT. THIS DRAWING IS THE PROPERTY OF CONN ARCHITECTS AND SHALL NOT BE REPRODUCED, COPIED, OR TRANSMITTED IN ANY FORM OR BY ANY MEANS, ELECTRONIC OR MECHANICAL, INCLUDING PHOTOCOPIING, RECORDING, OR OTHERWISE, WITHOUT THE PRIOR WRITTEN PERMISSION OF CONN ARCHITECTS, P.C.

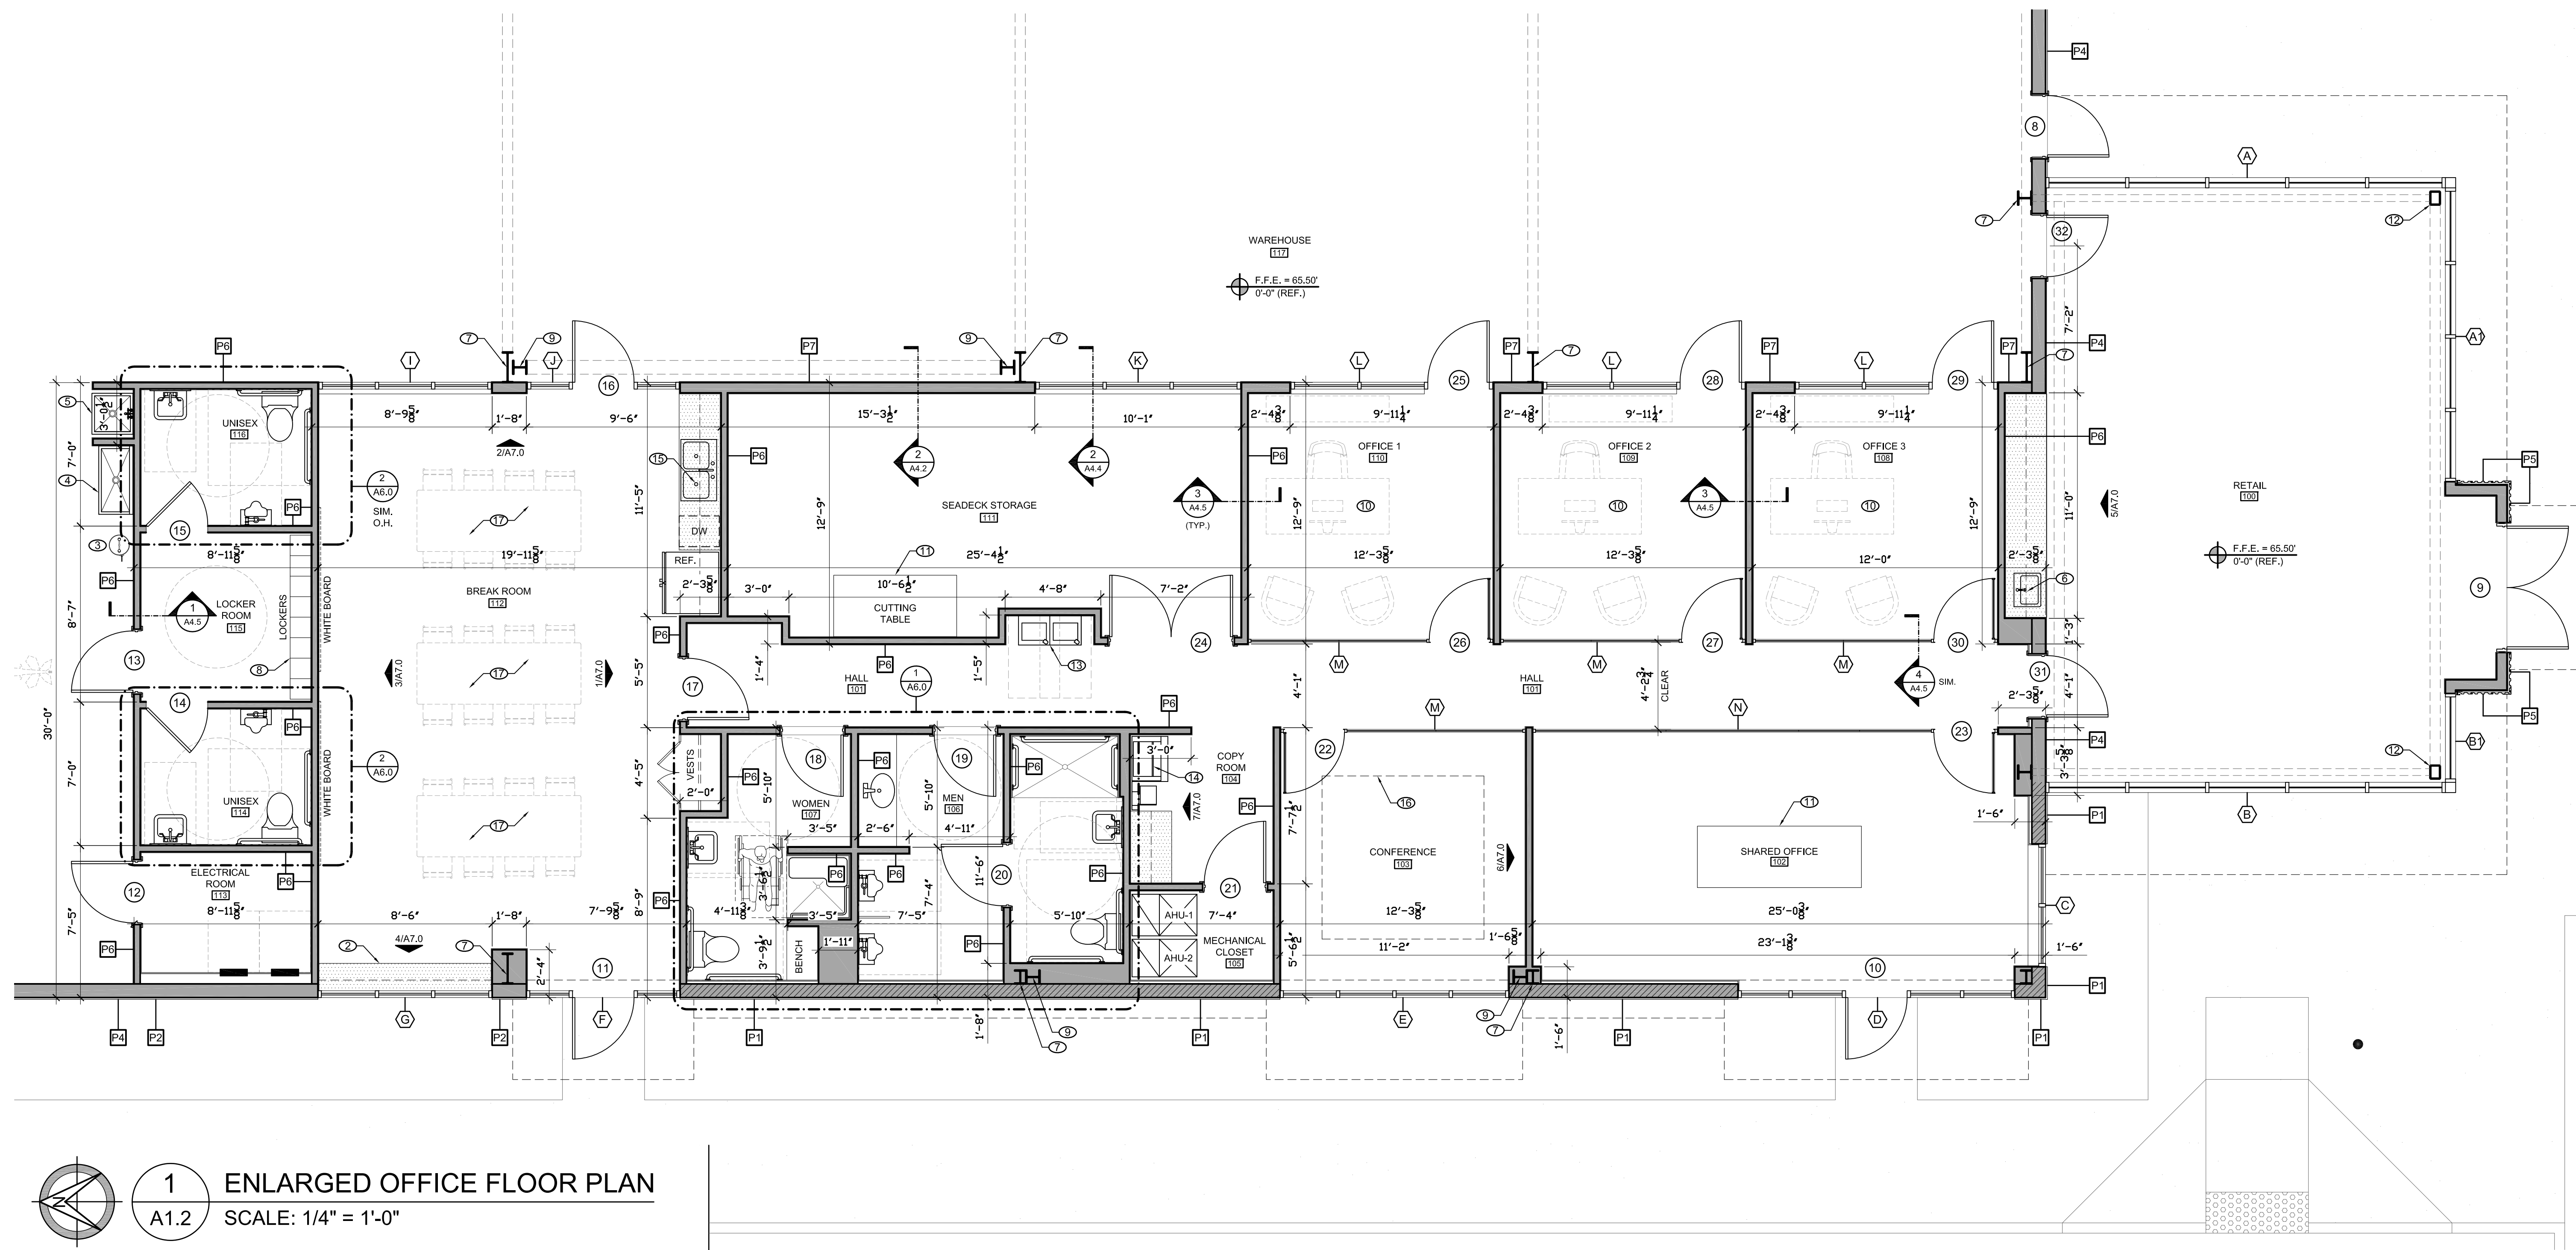

1 ENLARGED OFFICE FLOOR PLAN
A1.2 SCALE: 1/4" = 1'-0"

GENERAL NOTES

1. ALL CONSTRUCTION SHALL BE AS PER CODES STATED ON COVER SHEET.
2. ALL DIMENSIONS ARE TO FACE OF STUDS UNLESS OTHERWISE INDICATED.
3. THE ELEVATION OF FLOOR SURFACES ON BOTH SIDES OF ALL DOORS SHALL NOT VARY MORE THAN 1/2". THE ELEVATION SHALL BE MAINTAINED ON BOTH SIDES OF A DOORWAY FOR A DISTANCE AT LEAST EQUAL TO THE WIDEST LEAF.
4. SEE EQUIPMENT PLAN FOR EQUIPMENT LABELING AND LOCATIONS.
5. CONTRACTOR SHALL VERIFY ALL EQUIPMENT, SIZE AND LOCATIONS OF EQUIPMENT WITH OWNER PRIOR TO COMMENCEMENT OF WORK, AND SHALL NOTIFY ARCHITECT OF ANY DISCREPANCIES.
6. ALL EQUIPMENT SHALL BE INSTALLED AS PER THE MFG'S WRITTEN INSTRUCTIONS. CONTRACTOR SHALL INSTALL BLOCKING IN WALL AS REQUIRED TO SUPPORT EQUIPMENT BEING MOUNTED ON WALLS.
7. IT IS THE CONTRACTOR'S RESPONSIBILITY TO VERIFY AND COMPLY WITH MANEUVERING CLEARANCES, EQUIPMENT SPECIFICATIONS AND OWNER COORDINATION FOR ALL EQUIPMENT, PRIOR TO START OF CONSTRUCTION.
8. CONTRACTOR SHALL VERIFY ALL MILLWORK, SIZE AND LOCATIONS OF MILLWORK WITH OWNER, PRIOR TO COMMENCEMENT OF WORK, AND SHALL NOTIFY ARCHITECT OF ANY DISCREPANCIES. ALL MILLWORK WORK SURFACES SHALL COMPLY WITH 2023 (8TH ED) FBC-ACCESSIBILITY.

P.E.M.B. NOTES

1. M.B.M. - METAL BUILDING MANUFACTURER. ALL STRUCTURAL STEEL, INCLUDING BUT NOT LIMITED TO BEAMS, COLUMNS, BAR JOISTS, PURLINS, GIRTS, DECKING, CLIP ANGLES, ROOFING, ROOF FLASHING, SHALL BE DESIGNED, ENGINEERED AND SUPPLIED BY THE M.B.M. AND SHALL BE CERTIFIED BY A FLORIDA REGISTERED ENGINEER. SHOP DRAWINGS SHALL BE FORWARDED TO CONN & ASSOCIATES.
2. M.B.M. - METAL BUILDING MANUFACTURER. ALL COMPONENTS SUPPLIED BY THE M.B.M. SHALL BE DESIGNED, ENGINEERED, AND CERTIFIED BY A FLORIDA REGISTERED ENGINEER.
3. THE M.B.M. SHALL CHECK AND VERIFY ALL METAL BUILDING COMPONENTS AND NOTIFY THE ARCHITECT IMMEDIATELY OF ANY DISCREPANCIES OR NECESSARY ADDITIONAL STRUCTURAL COMPONENTS.
4. ALL STEEL FRAMES AND PURLINS TO BE PRIMED "RED".

KEY NOTES (THIS SHEET ONLY)

- ① ELECTRICAL PANEL. REFER TO ELECTRICAL DRAWINGS
- ② 16" DEEP SOLID SURFACE COUNTER TOP AT 34" A.F.F.
- ③ WALL-MOUNTED EMERGENCY EYE WASH STATION. REFER TO PLUMBING DRAWINGS.
- ④ S.S. 2-STATION WALL-HUNG SINK. REFER TO PLUMBING DRAWINGS.
- ⑤ SERVICE / MOP SINK. REFER TO PLUMBING DRAWINGS.
- ⑥ HAND SINK. REFER TO PLUMBING DRAWINGS.
- ⑦ PRE-ENGINEERED METAL BUILDING STEEL COLUMNS. REFER TO STRUCTURAL
- ⑧ 12" DEEP X 72" HIGH DOUBLE-TIER STEEL LOCKERS. COLOR: JET BLACK
- ⑨ STEEL PORTAL FRAME. REFER TO STRUCTURAL DRAWINGS.
- ⑩ OFFICE FURNITURE PER OWNER.
- ⑪ CUSTOM BUILT STEEL WORK TABLE (BY OWNER).
- ⑫ STRUCTURAL STEEL COLUMN. SEE STRUCTURAL DRAWINGS.
- ⑬ ADA COMPLIANT H2O ELECTRIC WATER COOLERS.
- ⑭ COPY MACHINE (BY OWNER).
- ⑮ 2-COMPARTMENT KITCHEN SINK. REFER TO PLUMBING DRAWINGS.
- ⑯ OUTLINE OF TRAY CEILING ABOVE. COORDINATE WITH REFLECTED CEILING PLAN.
- ⑰ BREAK ROOM FURNITURE (PER OWNER).

LEGEND

- 1-5/8", 25 GA. 16" O.C. STEEL STUDS (OVER P.E.M.B. WALL GIRTS) WITH ONE LAYER 5/8" G.W.B. ON INSIDE OVER 32" HIGH, 4X8X16 GROUND-FACE C.M.U. WATERTABLE WITH 3-5/8", 25 GA. 16" O.C. STEEL STUDS WITH ONE LAYER 1/2" P.T. PLYWOOD WITH CONTINUOUS PEEL AND STICK WEATHER-RESISTIVE BARRIER, METAL WALL PANELS PER P.E.M.B. M.F.G. ON EXTERIOR. SEE WALL SECTION 1/A4.1. **P1**
- 1-5/8", 25 GA. 16" O.C. STEEL STUDS (OVER P.E.M.B. WALL GIRTS) WITH ONE LAYER 5/8" G.W.B. ON INSIDE. METAL WALL PANELS PER P.E.M.B. M.F.G. ON EXTERIOR. SEE WALL SECTION 1/A4.1. **P2**
- 6", 20 GA. 16" O.C. STEEL STUDS (OVER P.E.M.B. WALL GIRTS) WITH ONE LAYER 5/8" G.W.B. ON INSIDE FACE OF WALL. METAL WALL PANELS PER P.E.M.B. M.F.G. ON EXTERIOR. SEE WALL SECTIONS. **P3**
- EXPOSED P.E.M.B. WALL GIRTS WITH METAL WALL PANELS PER P.E.M.B. M.F.G. ON EXTERIOR. SEE WALL SECTIONS. **P4**
- 6" METAL STUDS AT 16" O.C. WITH 1 LAYER OF 5/8" G.W.B. ON INSIDE FACE OF STUDS AND CORRUGATED "CENTRA" METAL WALL PANELS OVER STRUCTURAL SHEATHING ON EXTERIOR. COORDINATE WITH WALL SECTIONS AND ELEVATIONS. **P5**
- 3-5/8", 25 GA. 16" O.C. STEEL STUDS WITH ONE LAYER OF 5/8" G.W.B. ON EACH SIDE OF STUDS (TYPICAL). COORDINATE WITH WALL SECTIONS AND FINISH SCHEDULE. **P6**
- 6", 20 GA. 16" O.C. STEEL STUDS WITH ONE LAYER OF 5/8" G.W.B. ON EACH SIDE OF STUDS. COORDINATE WITH WALL SECTIONS AND FINISH SCHEDULE. **P7**
- 6", 20 GA. 16" O.C. STEEL STUDS WITH ONE LAYER OF 5/8" TYPE "X" G.W.B. ON EACH SIDE OF STUDS: UL U465. COORDINATE WITH WALL SECTIONS. FINISH SCHEDULE AND RATED ASSEMBLIES SHEETS A8.0 AND A8.1. **P8**
- MILLWORK PER CONTRACTOR. INSTALLED BY CONTRACTOR. INSTALL ALL MILLWORK AS PER MILLWORK MFG'S SHOP DRAWINGS. COORD. AND VERIFY ALL DIMENSIONS PRIOR TO INSTALLING.
- STEEL STRUCTURAL COLUMNS. COORDINATE WITH STRUCTURAL.

METAL FABRICATIONS NEW FACILITY
4323 AVIATION AVENUE, TALLAHASSEE, FL 32310


CONN + ARCHITECTS
 1960-C Buford Boulevard Tallahassee, Florida 32308 | 850-878-9784
 www.CONNarchitects.com | Lic. No. AA-C001662

DATE	07-21-24
DRAWN BY	DBC
REVISIONS	
SHEET NO.	23-208
DATE	
SHEET NUMBER	A1.2

PRICING SET - NOT FOR CONSTRUCTION


ENLARGED OFFICE FLOOR PLAN

CONNECTIONS TO ELECTRICAL, MECHANICAL, AND PLUMBING SYSTEMS SHALL BE MADE IN ACCORDANCE WITH THE MANUFACTURER'S INSTRUCTIONS. ANY MEANS OF ELECTRICAL, MECHANICAL, OR PLUMBING SYSTEMS SHALL BE INSTALLED IN ACCORDANCE WITH THE MANUFACTURER'S INSTRUCTIONS. ANY MEANS OF ELECTRICAL, MECHANICAL, OR PLUMBING SYSTEMS SHALL BE INSTALLED IN ACCORDANCE WITH THE MANUFACTURER'S INSTRUCTIONS. ANY MEANS OF ELECTRICAL, MECHANICAL, OR PLUMBING SYSTEMS SHALL BE INSTALLED IN ACCORDANCE WITH THE MANUFACTURER'S INSTRUCTIONS.

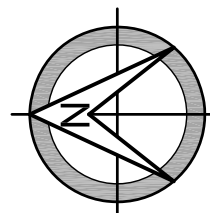

1
A1.3

OVERALL REFLECTED CEILING PLAN
SCALE: 1/4" = 1'-0"

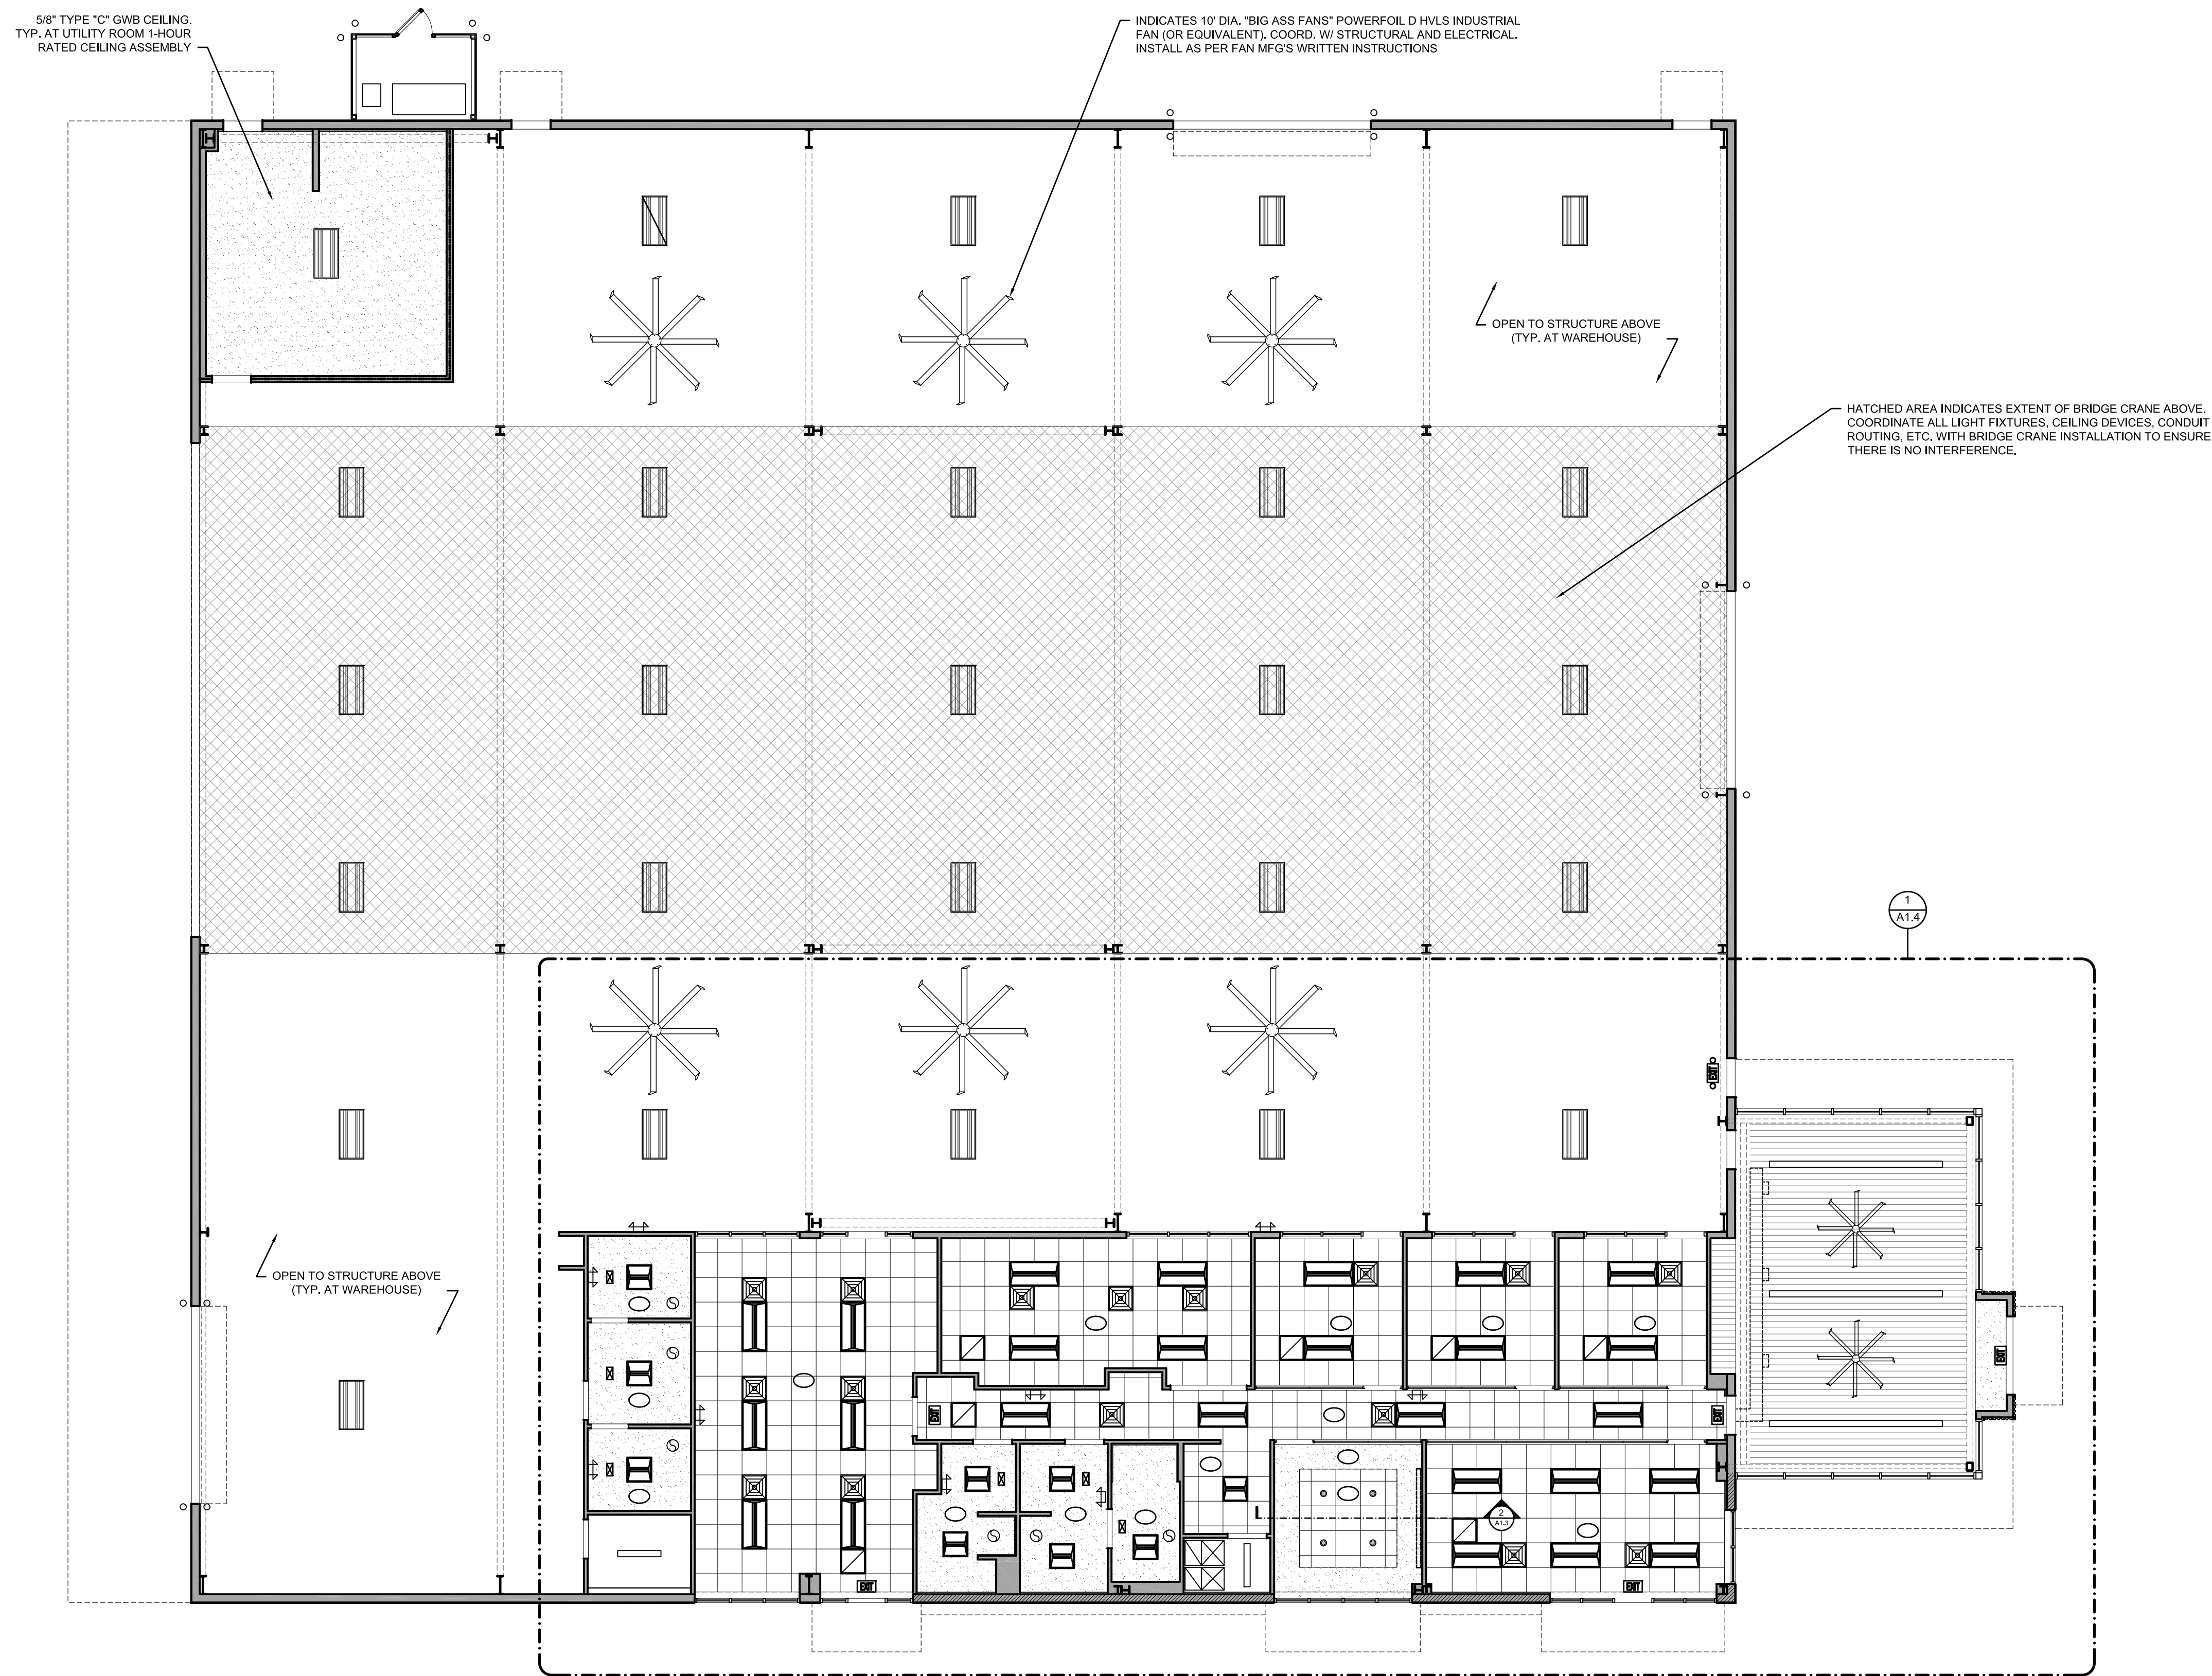


PRICING SET - NOT FOR CONSTRUCTION

DATE	07-21-24
DRAWN BY	DBC
REVISED	
JOB NO.	23-208
DATE	
SHEET NUMBER	A1.3

CONN + ARCHITECTS
1960-C Buford Boulevard | Tallahassee, Florida 32308 | 850-878-9784
www.CONNarchitects.com | Lic. No. AA-C011662


METAL FABRICATIONS NEW FACILITY
4323 AVIATION AVENUE, TALLAHASSEE, FL 32310

OVERALL REFLECTED CEILING PLAN

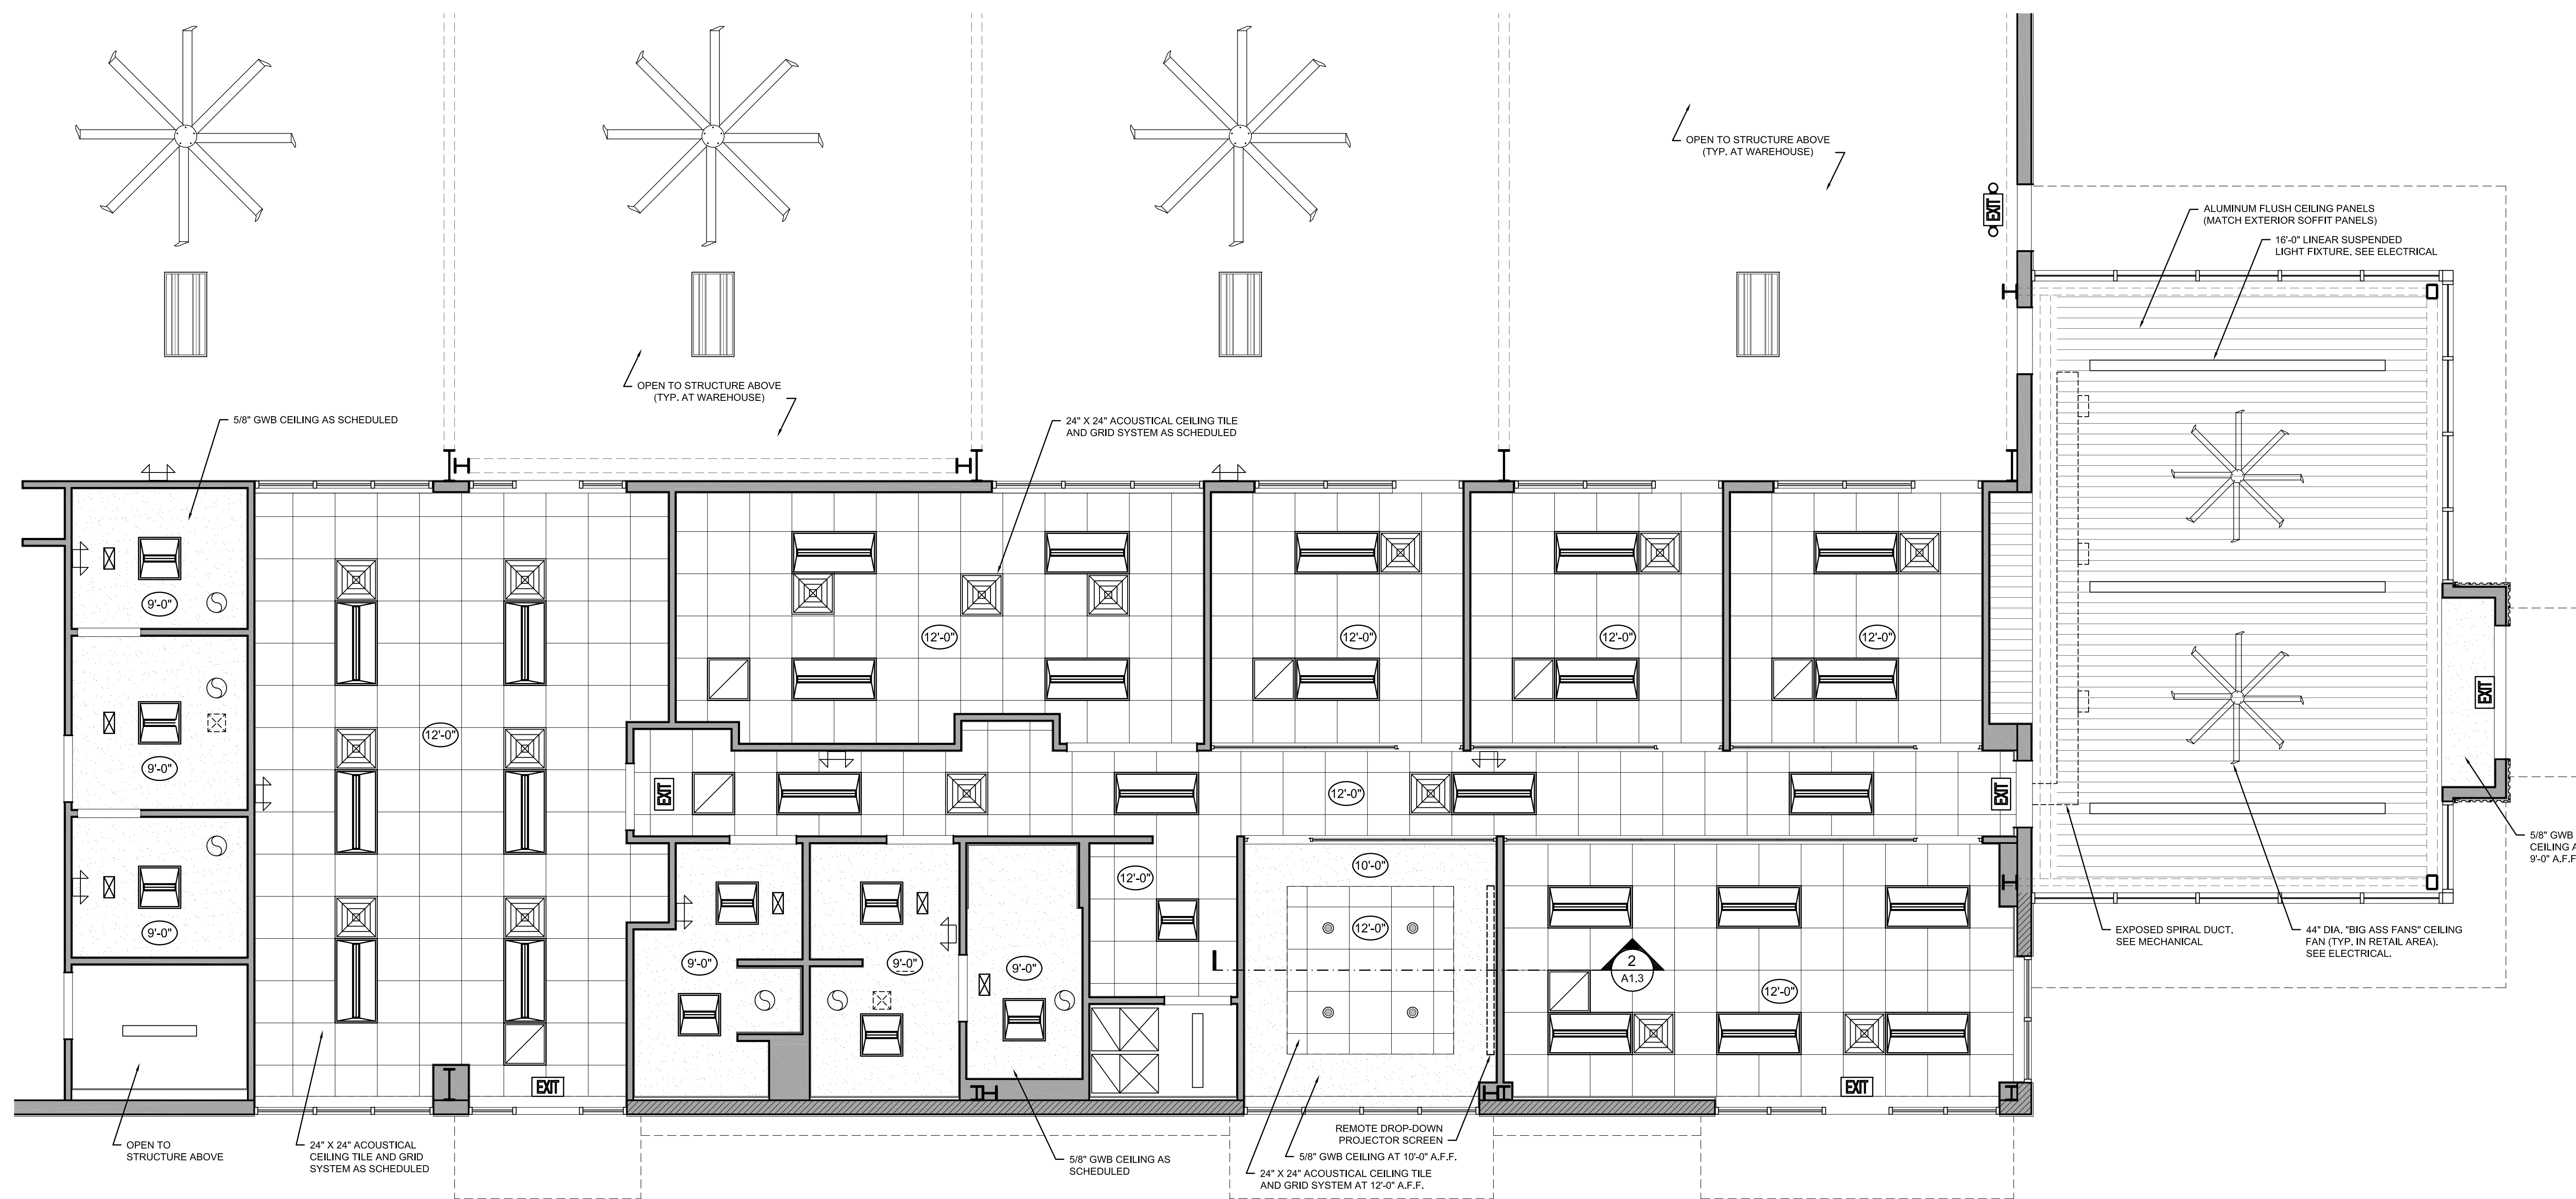

1 OFFICE REFLECTED CEILING PLAN
A1.4 SCALE: 1/4" = 1'-0"

DETAIL

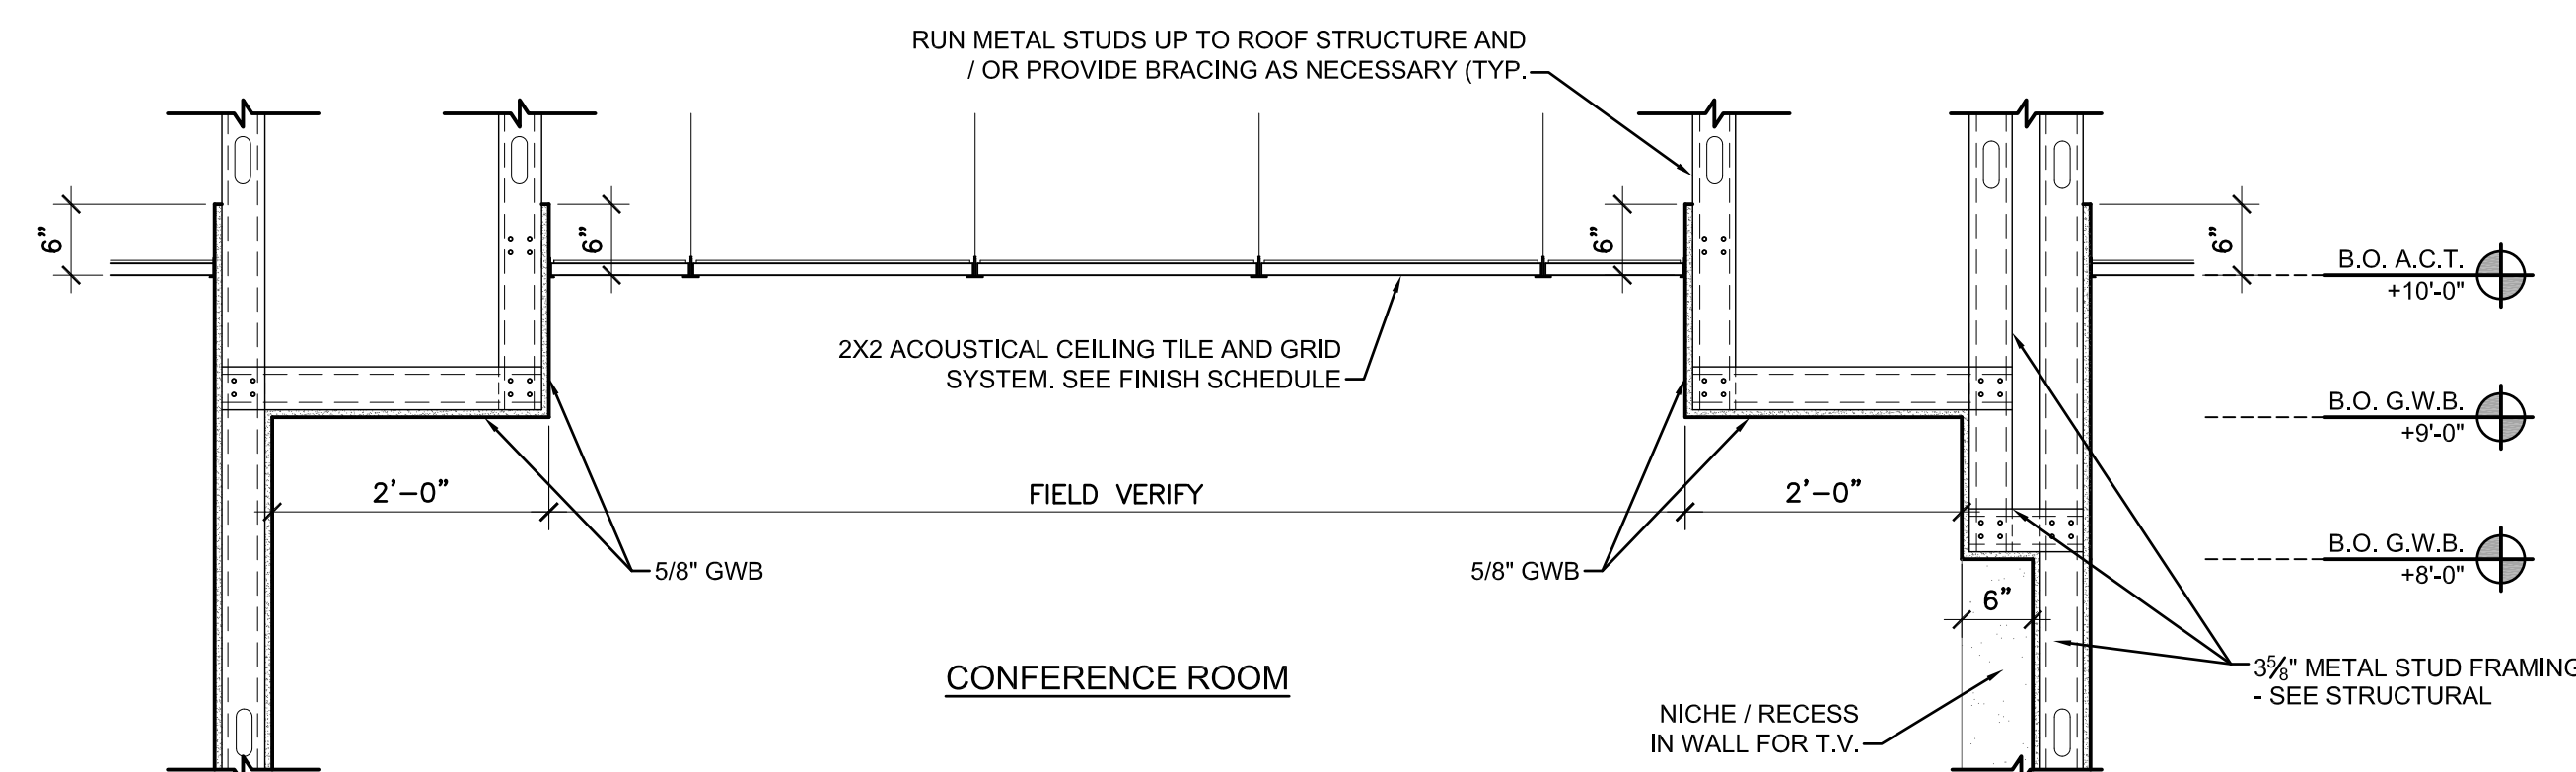

2 CEILING DETAIL
A1.4 SCALE: 1/4" = 1'-0" CONFERENCE ROOM

NOTES

- ALL CONSTRUCTION SHALL BE AS PER CODES STATED ON COVER SHEET.
- ALL DIMENSIONS ARE TO FACE OF STUDS OR FACE OF CMU UNLESS OTHERWISE INDICATED.
- ALL EQUIPMENT SHALL BE INSTALLED AS PER THE MFG'S WRITTEN INSTRUCTIONS. CONTRACTOR SHALL INSTALL BLOCKING IN WALL AS REQUIRED TO SUPPORT EQUIPMENT BEING MOUNTED ON WALLS.
- REFER TO MECHANICAL DRAWINGS FOR ALL MECHANICAL INFORMATION.
- REFER TO PLUMBING DRAWINGS FOR ALL PLUMBING INFORMATION.
- REFER TO ELECTRICAL DRAWINGS FOR ALL ELECTRICAL INFORMATION.
- REFER TO SHEET A1.3 FOR OVERALL REFLECTED CEILING PLAN.

CEILING SYMBOLS LEGEND

	2X2 LED LIGHT FIXTURE COORDINATE WITH ELECTRICAL.
	LED HIGH BAY LIGHT FIXTURE. COORDINATE WITH ELECTRICAL.
	16 FT LED SUSPENDED LINEAR FIXTURE. REFER TO ELECTRICAL.
	DECORATIVE PENDANT LIGHT FIXTURE. REFER TO ELECTRICAL.
	LED CAN LIGHT FIXTURE. REFER TO ELECTRICAL.
	LED CAN LIGHT FIXTURE. REFER TO ELECTRICAL.
	ILLUMINATED EXIT SIGNAGE / EMERGENCY EXIT LIGHT COMBO W/ BATTERY BACKUP. REFER TO ELECTRICAL.
	WALL-MOUNTED EMERGENCY EXIT LIGHT W/ BATTERY BACK-UP. REFER TO ELECTRICAL.
	SUPPLY-AIR DIFFUSER. REFER TO MECHANICAL.
	RETURN AIR REGISTER. REFER TO MECHANICAL.
	EXHAUST FAN. REFER TO MECHANICAL.

PRICING SET - NOT FOR CONSTRUCTION

DATE	07-21-24
DRAWN BY	DBC
REVISED	
SHEET NO.	23-208
DATE	
SHEET NUMBER	A1.4


METAL FABRICATIONS NEW FACILITY
4323 AVIATION AVENUE, TALLAHASSEE, FL 32310

OFFICE REFLECTED CEILING PLAN AND DETAILS

CONN + ARCHITECTS
1960-C Buford Boulevard Tallahassee, Florida 32308 | 850-878-9784
www.connarchitects.com | Lic. No. AA-C001662

COPYRIGHT © 2024 CONN ARCHITECTS, INC. ALL RIGHTS RESERVED. PERMISSION IS GRANTED TO REPRODUCE THIS DRAWING FOR ARCHITECTURAL PURPOSES ONLY. NO PART OF THESE DOCUMENTS MAY BE REPRODUCED, STORED IN A RETRIEVAL SYSTEM, OR TRANSMITTED IN ANY FORM OR BY ANY MEANS, ELECTRONIC, MECHANICAL, PHOTOCOPIING, RECORDING, OR OTHERWISE, WITHOUT THE PRIOR WRITTEN PERMISSION OF CONN ARCHITECTS, INC.

CONN ARCHITECTS, INC. IS PROVIDING THESE DRAWINGS AS A SERVICE TO THE CLIENT. THE CLIENT'S RESPONSIBILITY IS TO VERIFY THE ACCURACY OF ALL INFORMATION PROVIDED TO CONN ARCHITECTS, INC. AND TO OBTAIN ALL NECESSARY PERMITS AND APPROVALS FROM ALL APPLICABLE AGENCIES. CONN ARCHITECTS, INC. DOES NOT WARRANT THE ACCURACY OF ANY INFORMATION PROVIDED TO THE CLIENT. ANY REVISIONS TO THESE DRAWINGS SHALL BE MADE IN WRITING AND SHALL BE THE PROPERTY OF CONN ARCHITECTS, INC. ANY REVISIONS TO THESE DRAWINGS SHALL BE MADE IN WRITING AND SHALL BE THE PROPERTY OF CONN ARCHITECTS, INC.

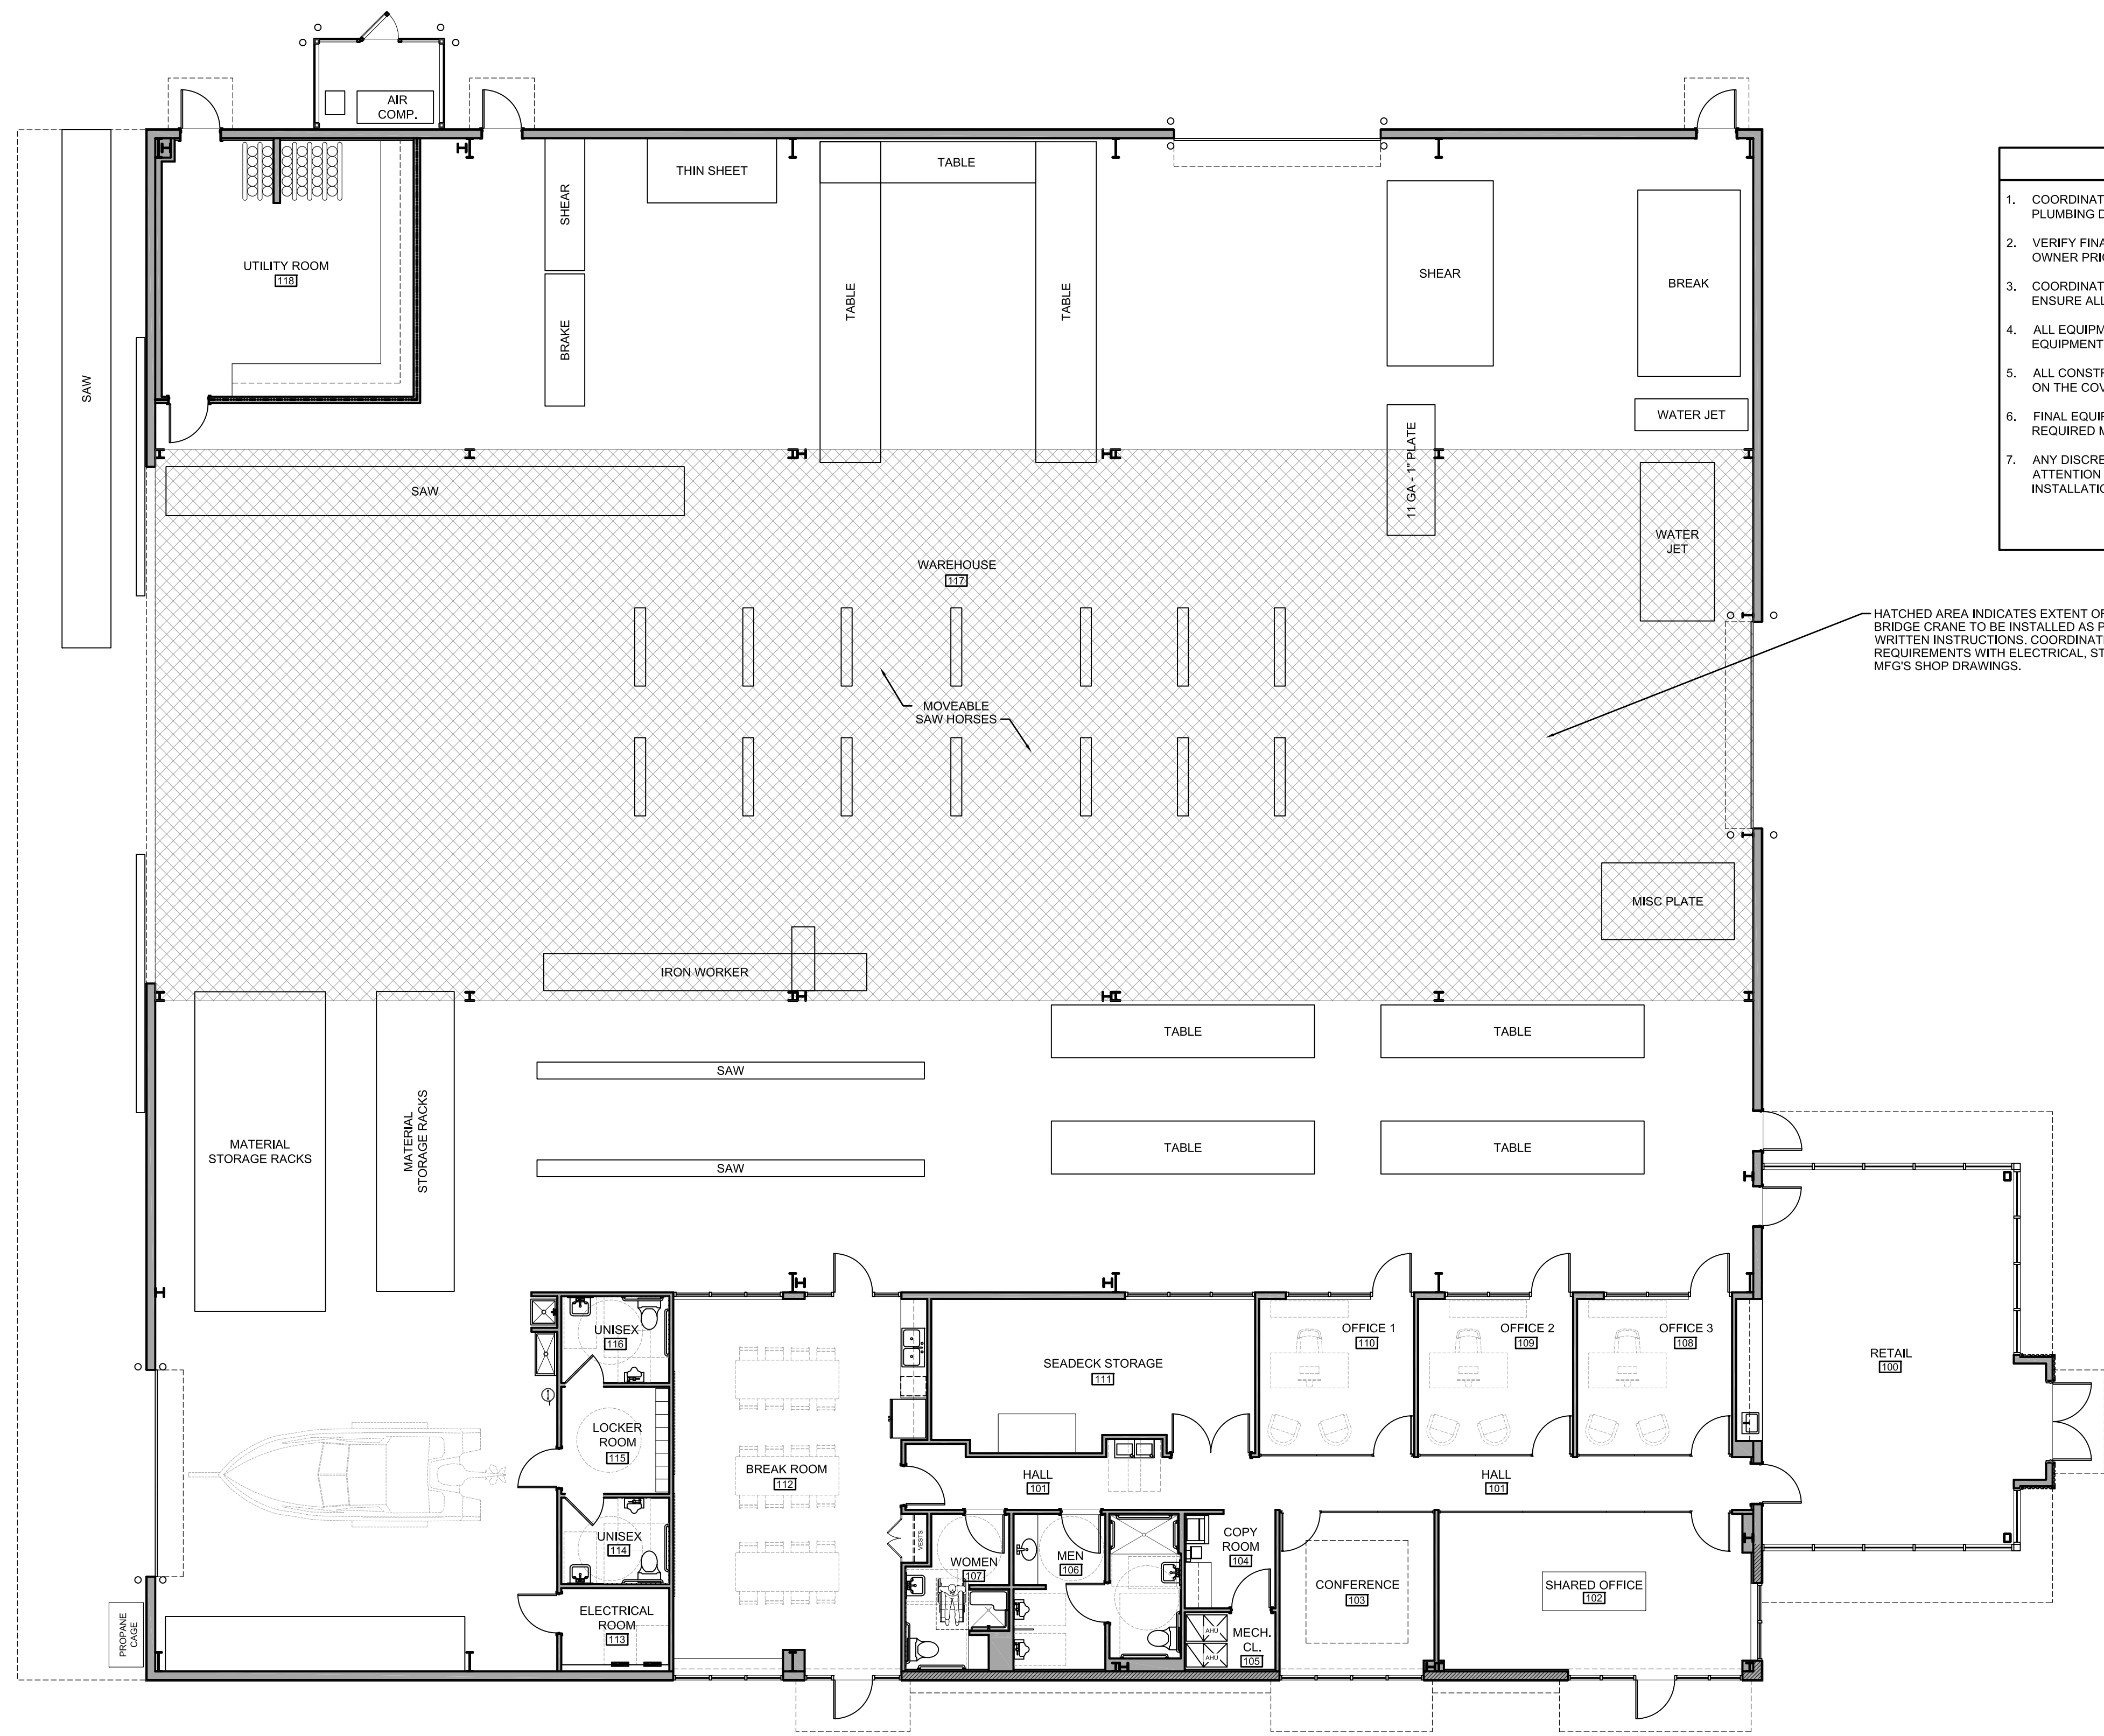

- | NOTES | |
|-------|--|
| 1. | COORDINATE WITH ELECTRICAL, MECHANICAL AND PLUMBING DRAWINGS. |
| 2. | VERIFY FINAL LOCATIONS OF EQUIPMENT WITH OWNER PRIOR TO INSTALLATION. |
| 3. | COORDINATE WITH EQUIPMENT MFG'S DRAWINGS TO ENSURE ALL REQUIRED CLEARANCES ARE MET. |
| 4. | ALL EQUIPMENT SHALL BE INSTALLED PER THE EQUIPMENT MFG'S WRITTEN INSTRUCTIONS. |
| 5. | ALL CONSTRUCTION SHALL BE PER CODES STATED ON THE COVER SHEET. |
| 6. | FINAL EQUIPMENT LOCATIONS SHALL NOT OBSTRUCT REQUIRED MEANS OF EGRESS. |
| 7. | ANY DISCREPANCY SHALL BE BROUGHT TO THE ATTENTION OF THE ARCHITECT PRIOR TO INSTALLATION OF ANY EQUIPMENT. |

HATCHED AREA INDICATES EXTENT OF BRIDGE CRANE ABOVE. BRIDGE CRANE TO BE INSTALLED AS PER THE CRANE MFG'S WRITTEN INSTRUCTIONS. COORDINATE ALL CRANE INSTALLATION REQUIREMENTS WITH ELECTRICAL, STRUCTURAL AND CRANE MFG'S SHOP DRAWINGS.

1 WAREHOUSE EQUIPMENT PLAN
A1.5 SCALE: 1/8" = 1'-0"


METAL FABRICATIONS NEW FACILITY
 4323 AVIATION AVENUE, TALLAHASSEE, FL 32310
WAREHOUSE EQUIPMENT PLAN

CONN + ARCHITECTS


1960-C Buford Boulevard | Tallahassee, Florida 32308 | 850-878-9784
 www.CONNarchitects.com | Lic. No. AA-C011662

DATE	07-21-24
DRAWN BY	DBC
REVISED	
JOB NO.	23-208
DATE SHEET NUMBER	A1.5


PRICING SET - NOT FOR CONSTRUCTION

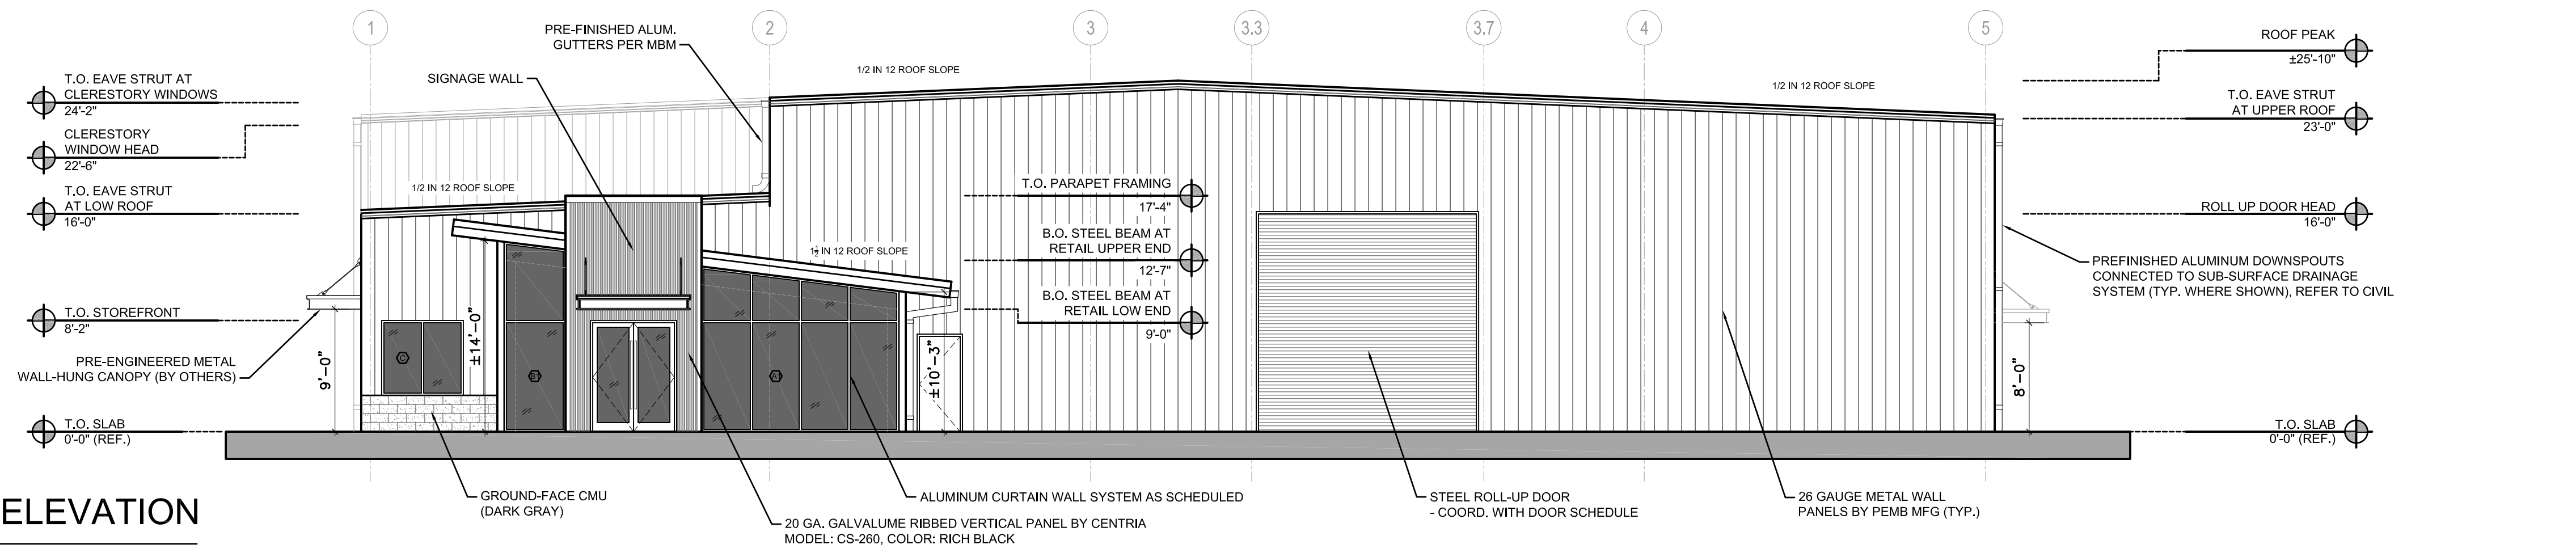


1 SOUTH (RIGHT SIDE) ELEVATION
A2.0 SCALE: 1/8" = 1'-0"

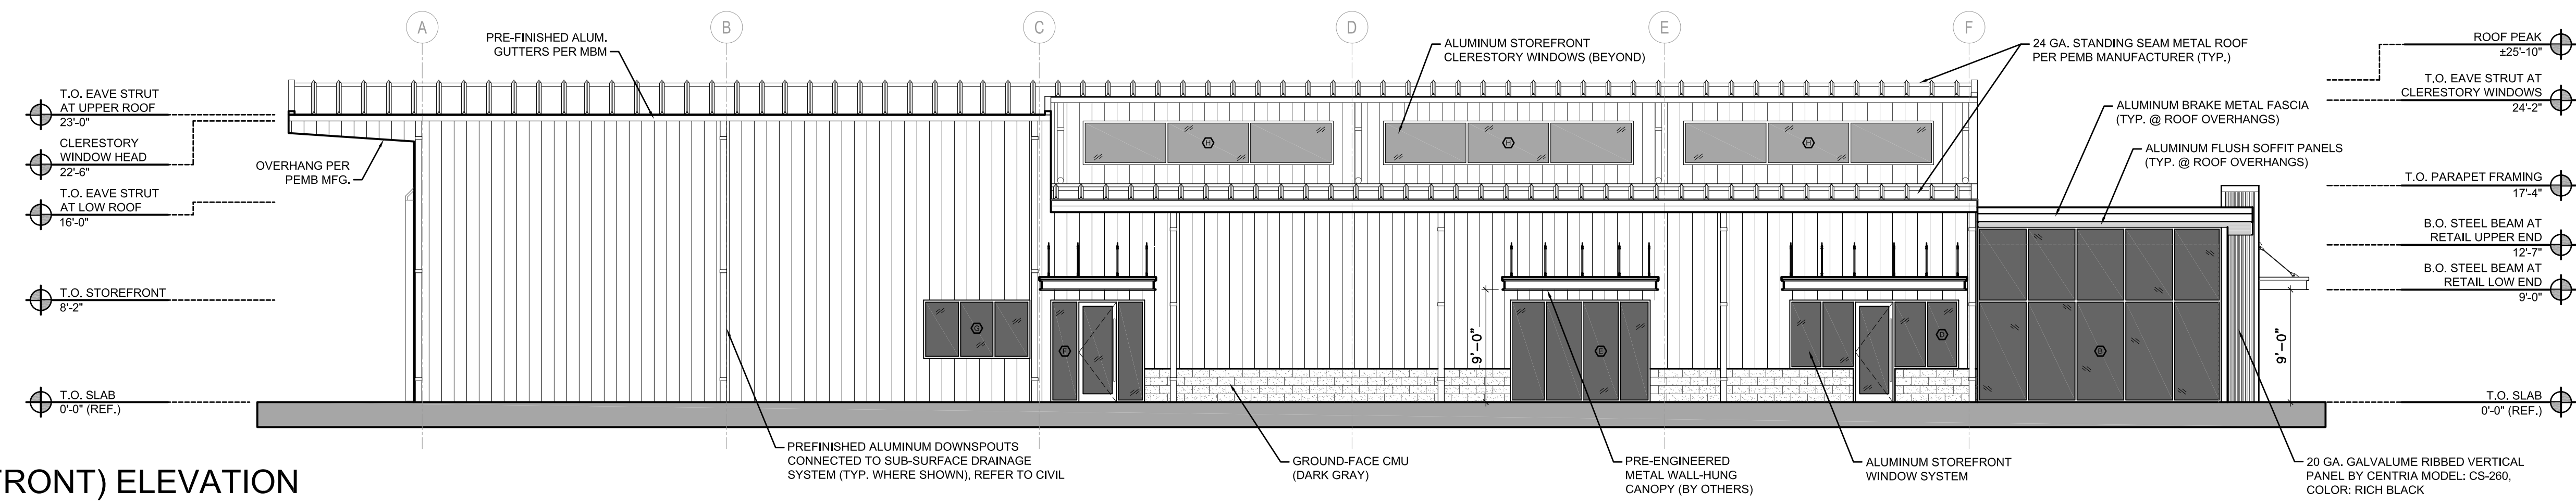

2 WEST (FRONT) ELEVATION
A2.0 SCALE: 1/8" = 1'-0"

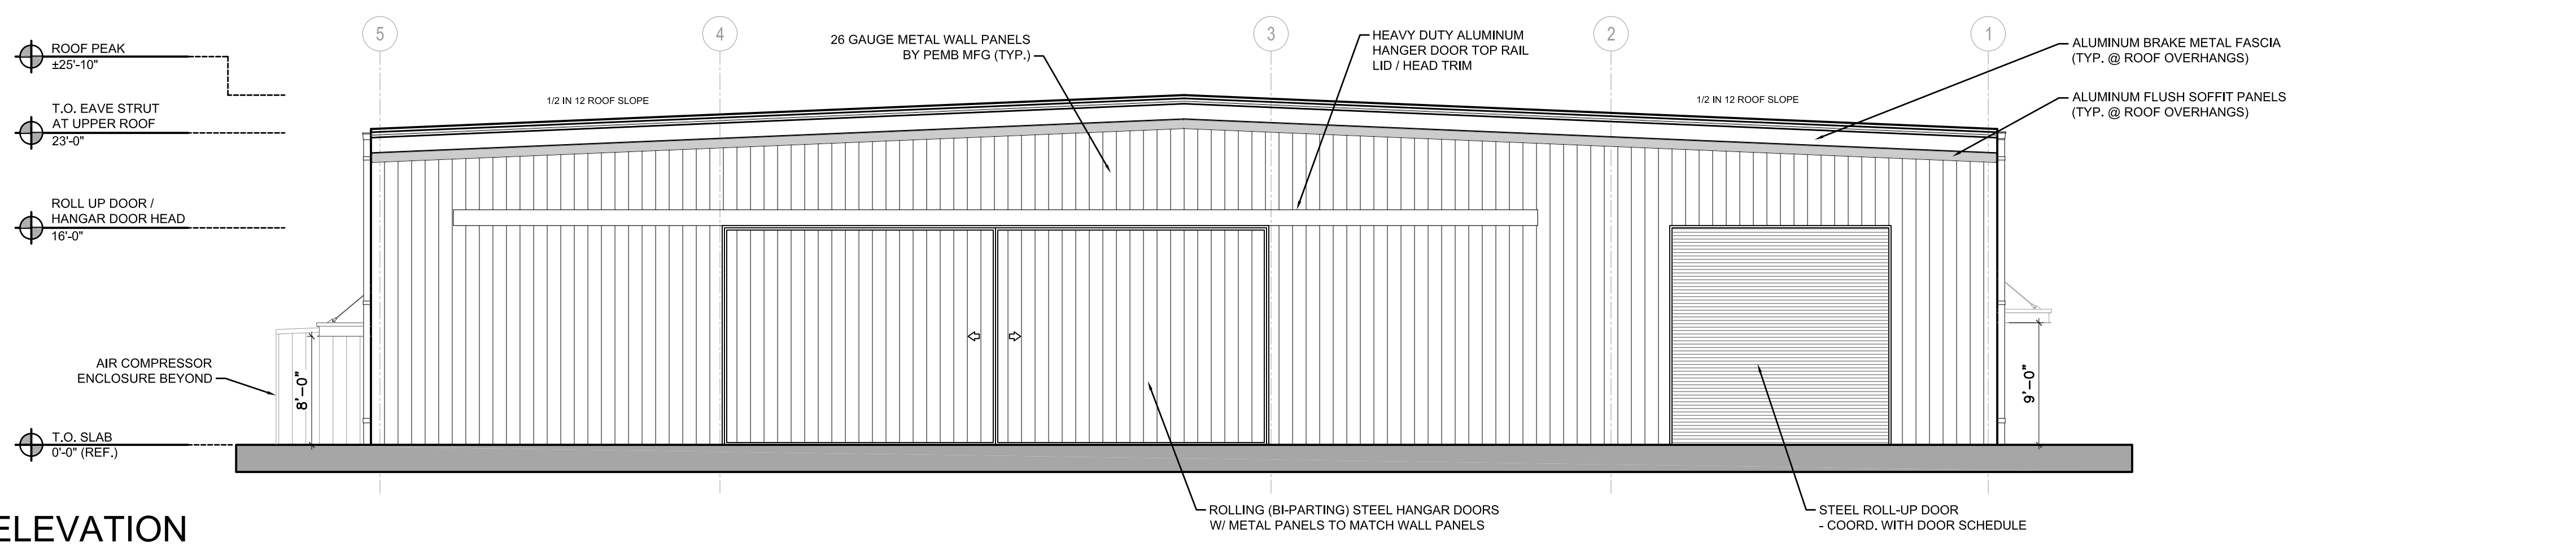

3 NORTH (LEFT SIDE) ELEVATION
A2.0 SCALE: 1/8" = 1'-0"

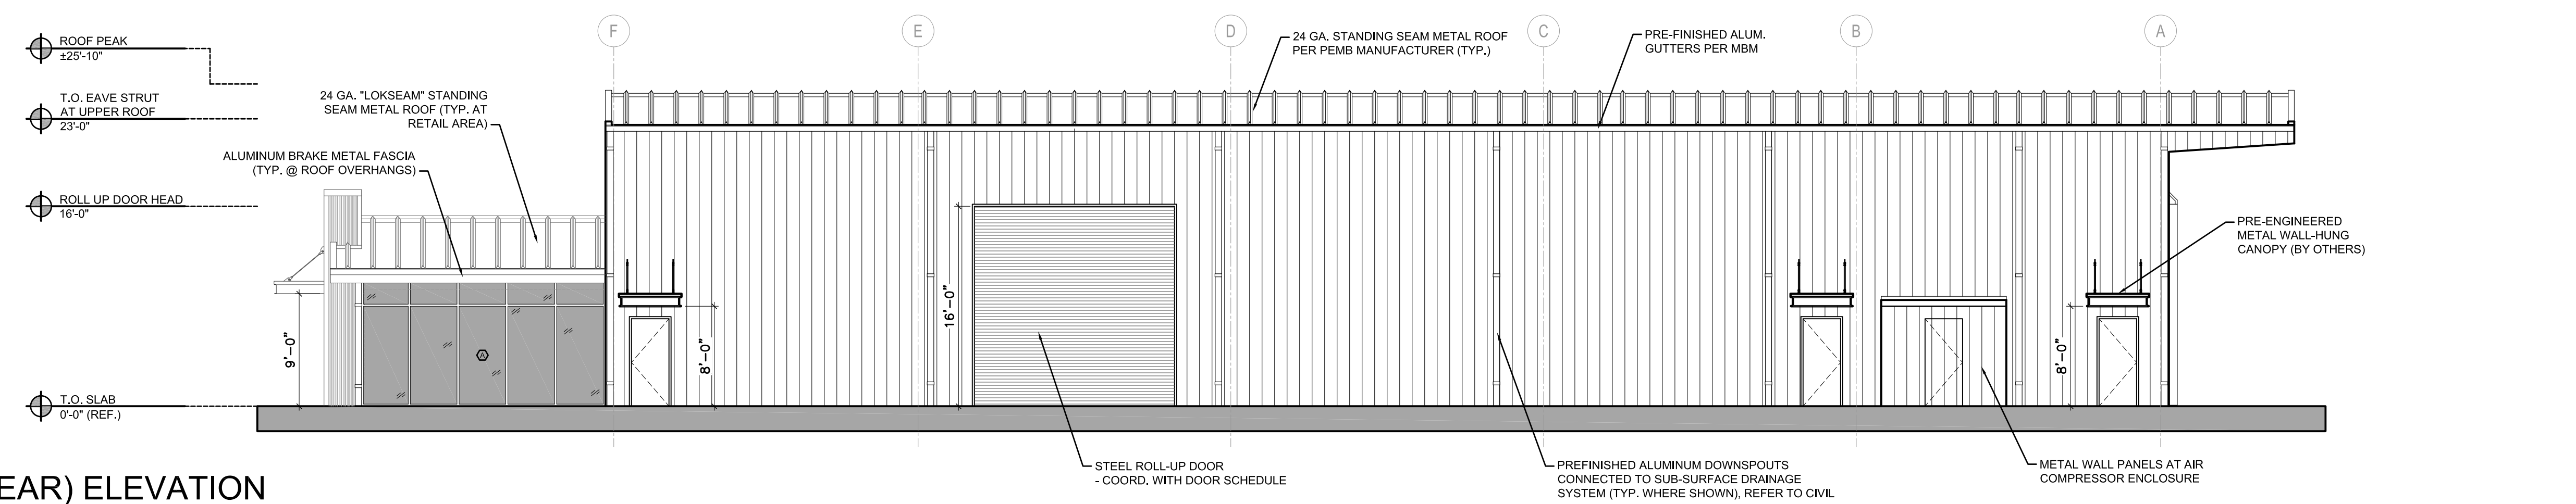

4 EAST (REAR) ELEVATION
A2.0 SCALE: 1/8" = 1'-0"

METAL FABRICATIONS NEW FACILITY
4323 AVIATION AVENUE, TALLAHASSEE, FL 32310


ELEVATIONS

CONN + ARCHITECTS
1960-C Buford Boulevard Tallahassee, Florida 32308 | 850-878-9784
www.CONNarchitects.com | Lic. No. AA-C011662


DATE	07-21-24
DRAWN BY	DBC
REVISED	
JOB NO.	23-208
DATE	
SHEET NUMBER	A2.0

PRICING SET - NOT FOR CONSTRUCTION


CONNECTIONS TO EXISTING STRUCTURES SHALL BE AS SHOWN. ALL DIMENSIONS ARE TO FACE UNLESS OTHERWISE NOTED. THE ARCHITECT'S OFFICE SHALL NOT BE RESPONSIBLE FOR THE ACCURACY OF ANY INFORMATION PROVIDED BY OTHERS. THE ARCHITECT'S OFFICE SHALL NOT BE RESPONSIBLE FOR THE ACCURACY OF ANY INFORMATION PROVIDED BY OTHERS. THE ARCHITECT'S OFFICE SHALL NOT BE RESPONSIBLE FOR THE ACCURACY OF ANY INFORMATION PROVIDED BY OTHERS.

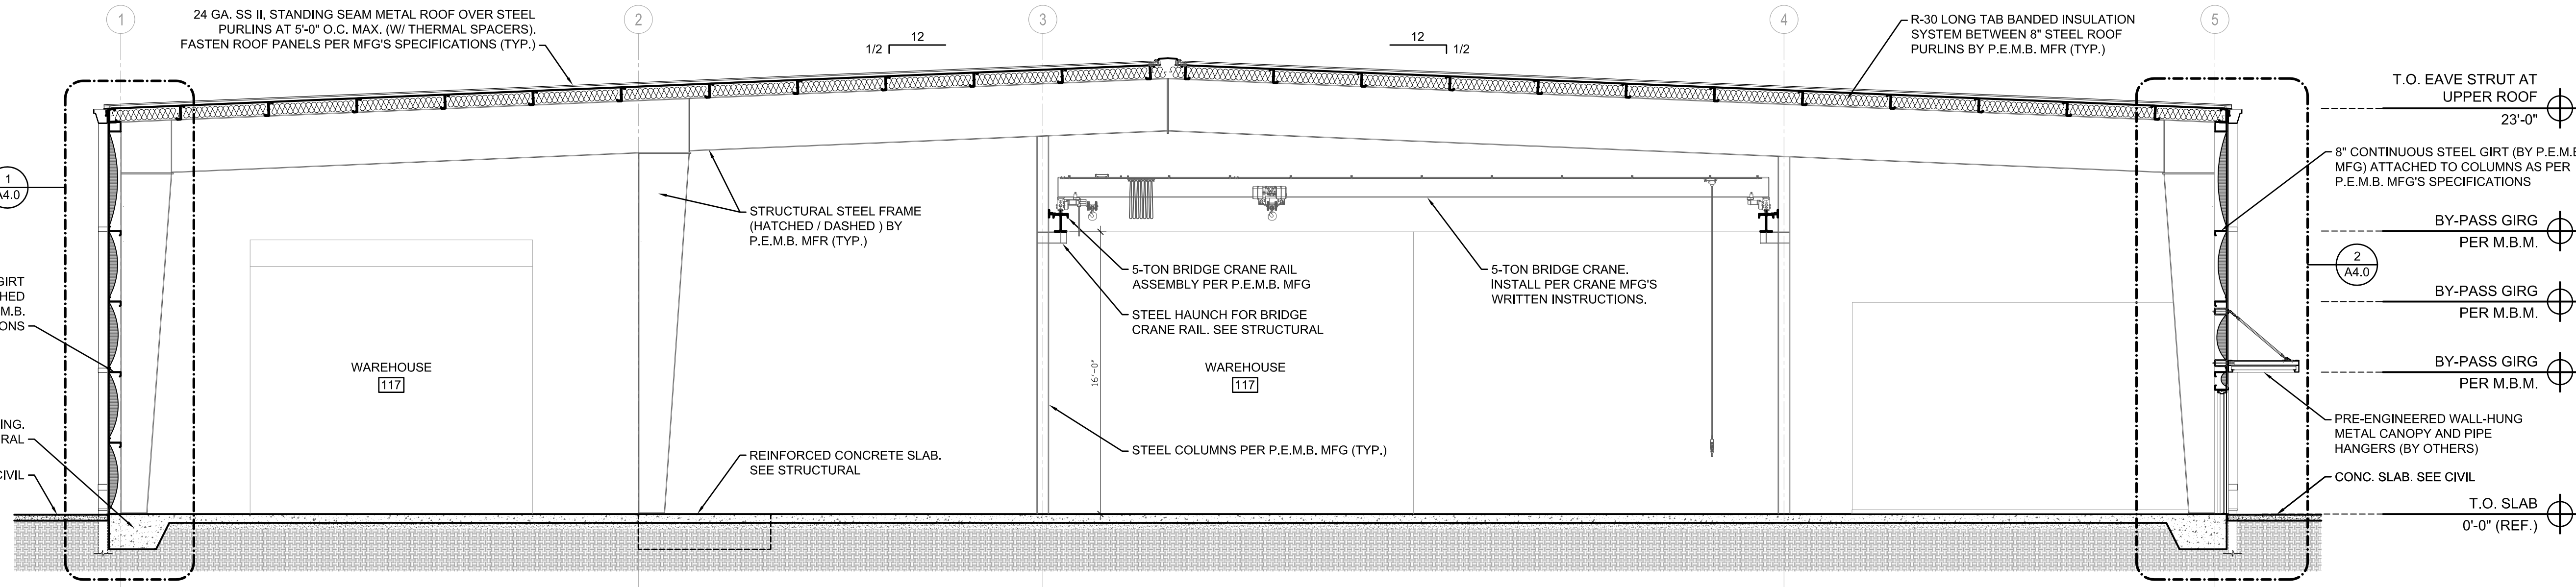

1 TRANSVERSE BUILDING SECTION
A3.0 SCALE: 1/4" = 1'-0"

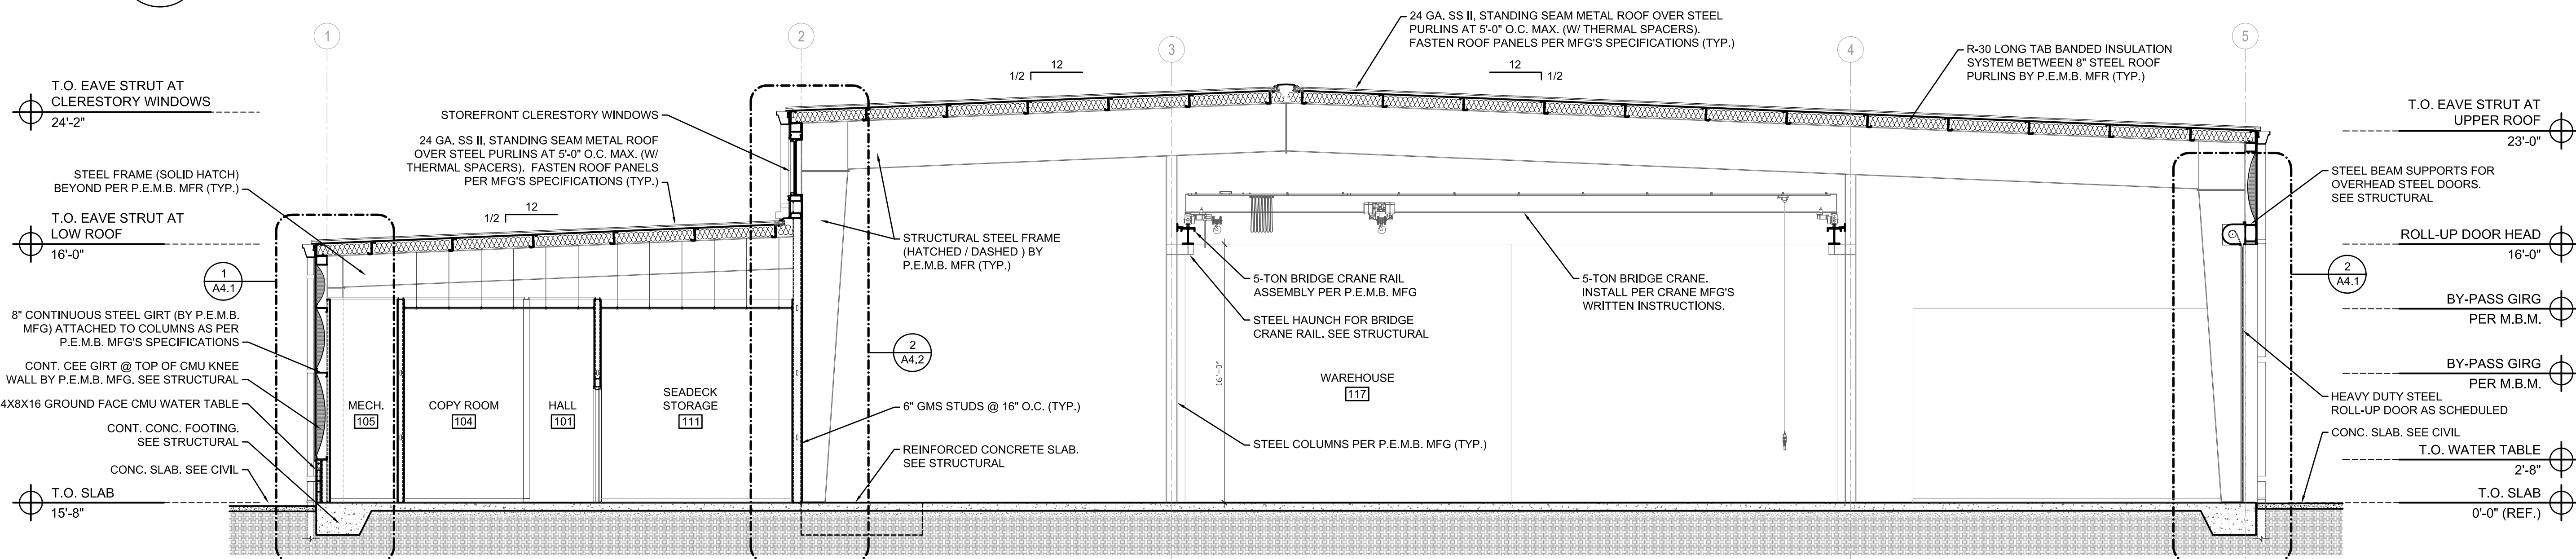

2 TRANSVERSE BUILDING SECTION
A3.0 SCALE: 1/4" = 1'-0"

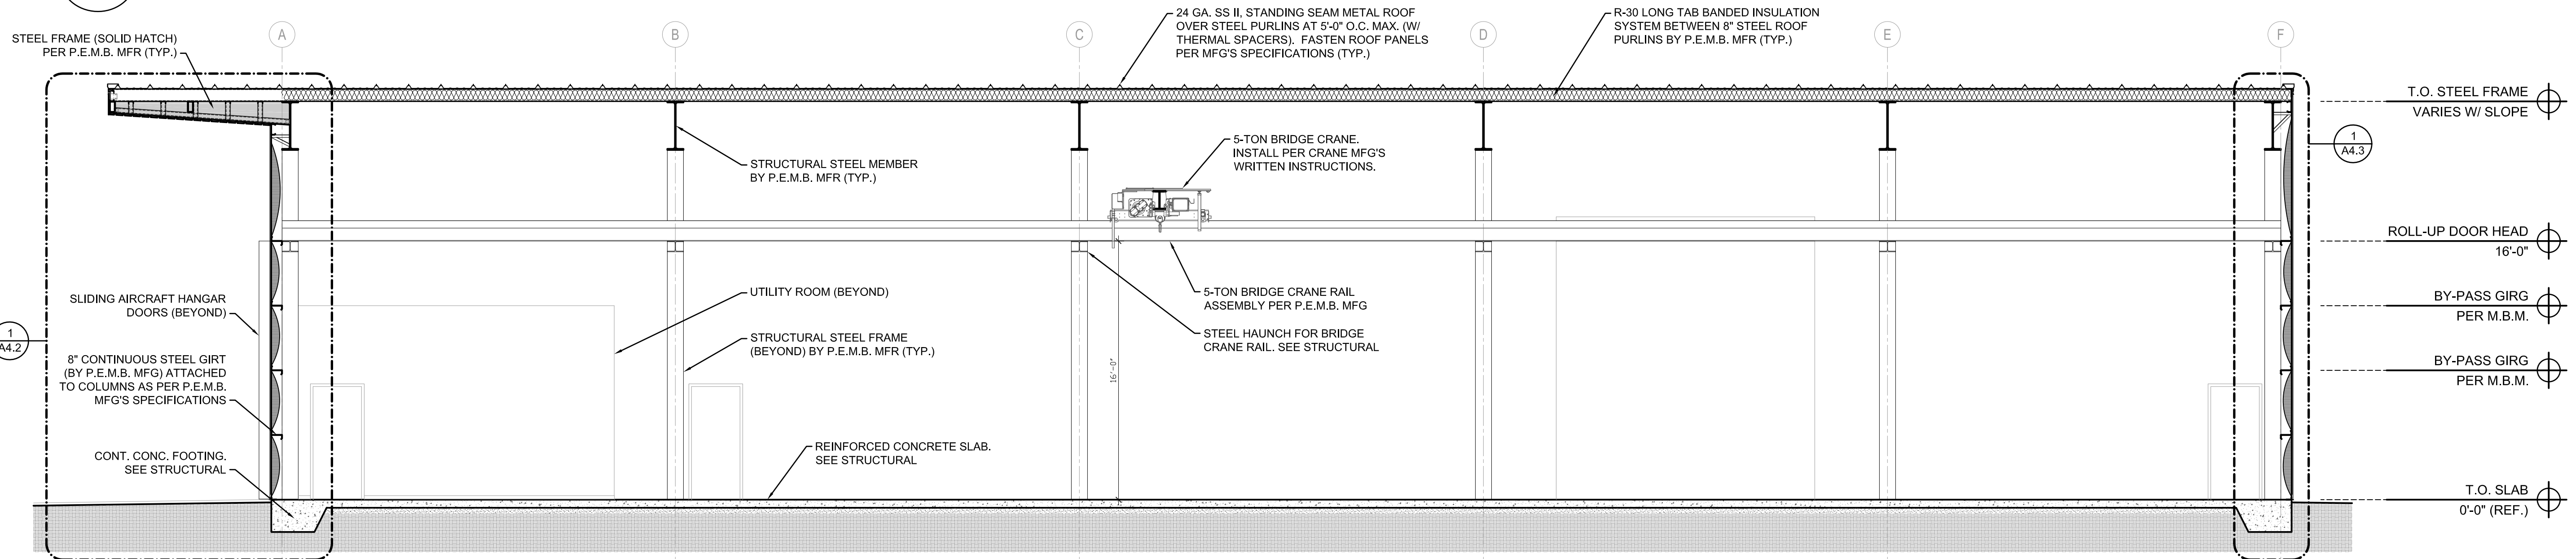

3 LONGITUDINAL BUILDING SECTION
A3.0 SCALE: 1/4" = 1'-0"

METAL FABRICATIONS NEW FACILITY
4323 AVIATION AVENUE, TALLAHASSEE, FL 32310

BUILDING SECTIONS

CONN + ARCHITECTS
1960-C Buford Boulevard Tallahassee, Florida 32308 | 850-878-9784
www.connarchitects.com | Lic. No. AA-C001662


DATE	07-21-24
DRAWN BY	DBC
REVISED	
JOB NO.	23-208
DATE	
SHEET NUMBER	A3.0

PRICING SET - NOT FOR CONSTRUCTION


CONNECTIONS TO BE SHOWN AND DIMENSIONS TO BE INDICATED. REVISIONS TO BE SHOWN IN THE MARGINS OF THIS SHEET. ANY MEANS, ELECTRONIC, MECHANICAL, PHOTOGRAPHIC, RECORDING, OR OTHERWISE, WITHOUT THE PRIOR WRITTEN PERMISSION OF CONN ARCHITECTS, P.C.

DATE	07-21-24
DRAWN BY	DBC
REVISED	
DWG NO.	23-208
DATE	
SHEET NUMBER	A4.0

PRICING SET - NOT FOR CONSTRUCTION

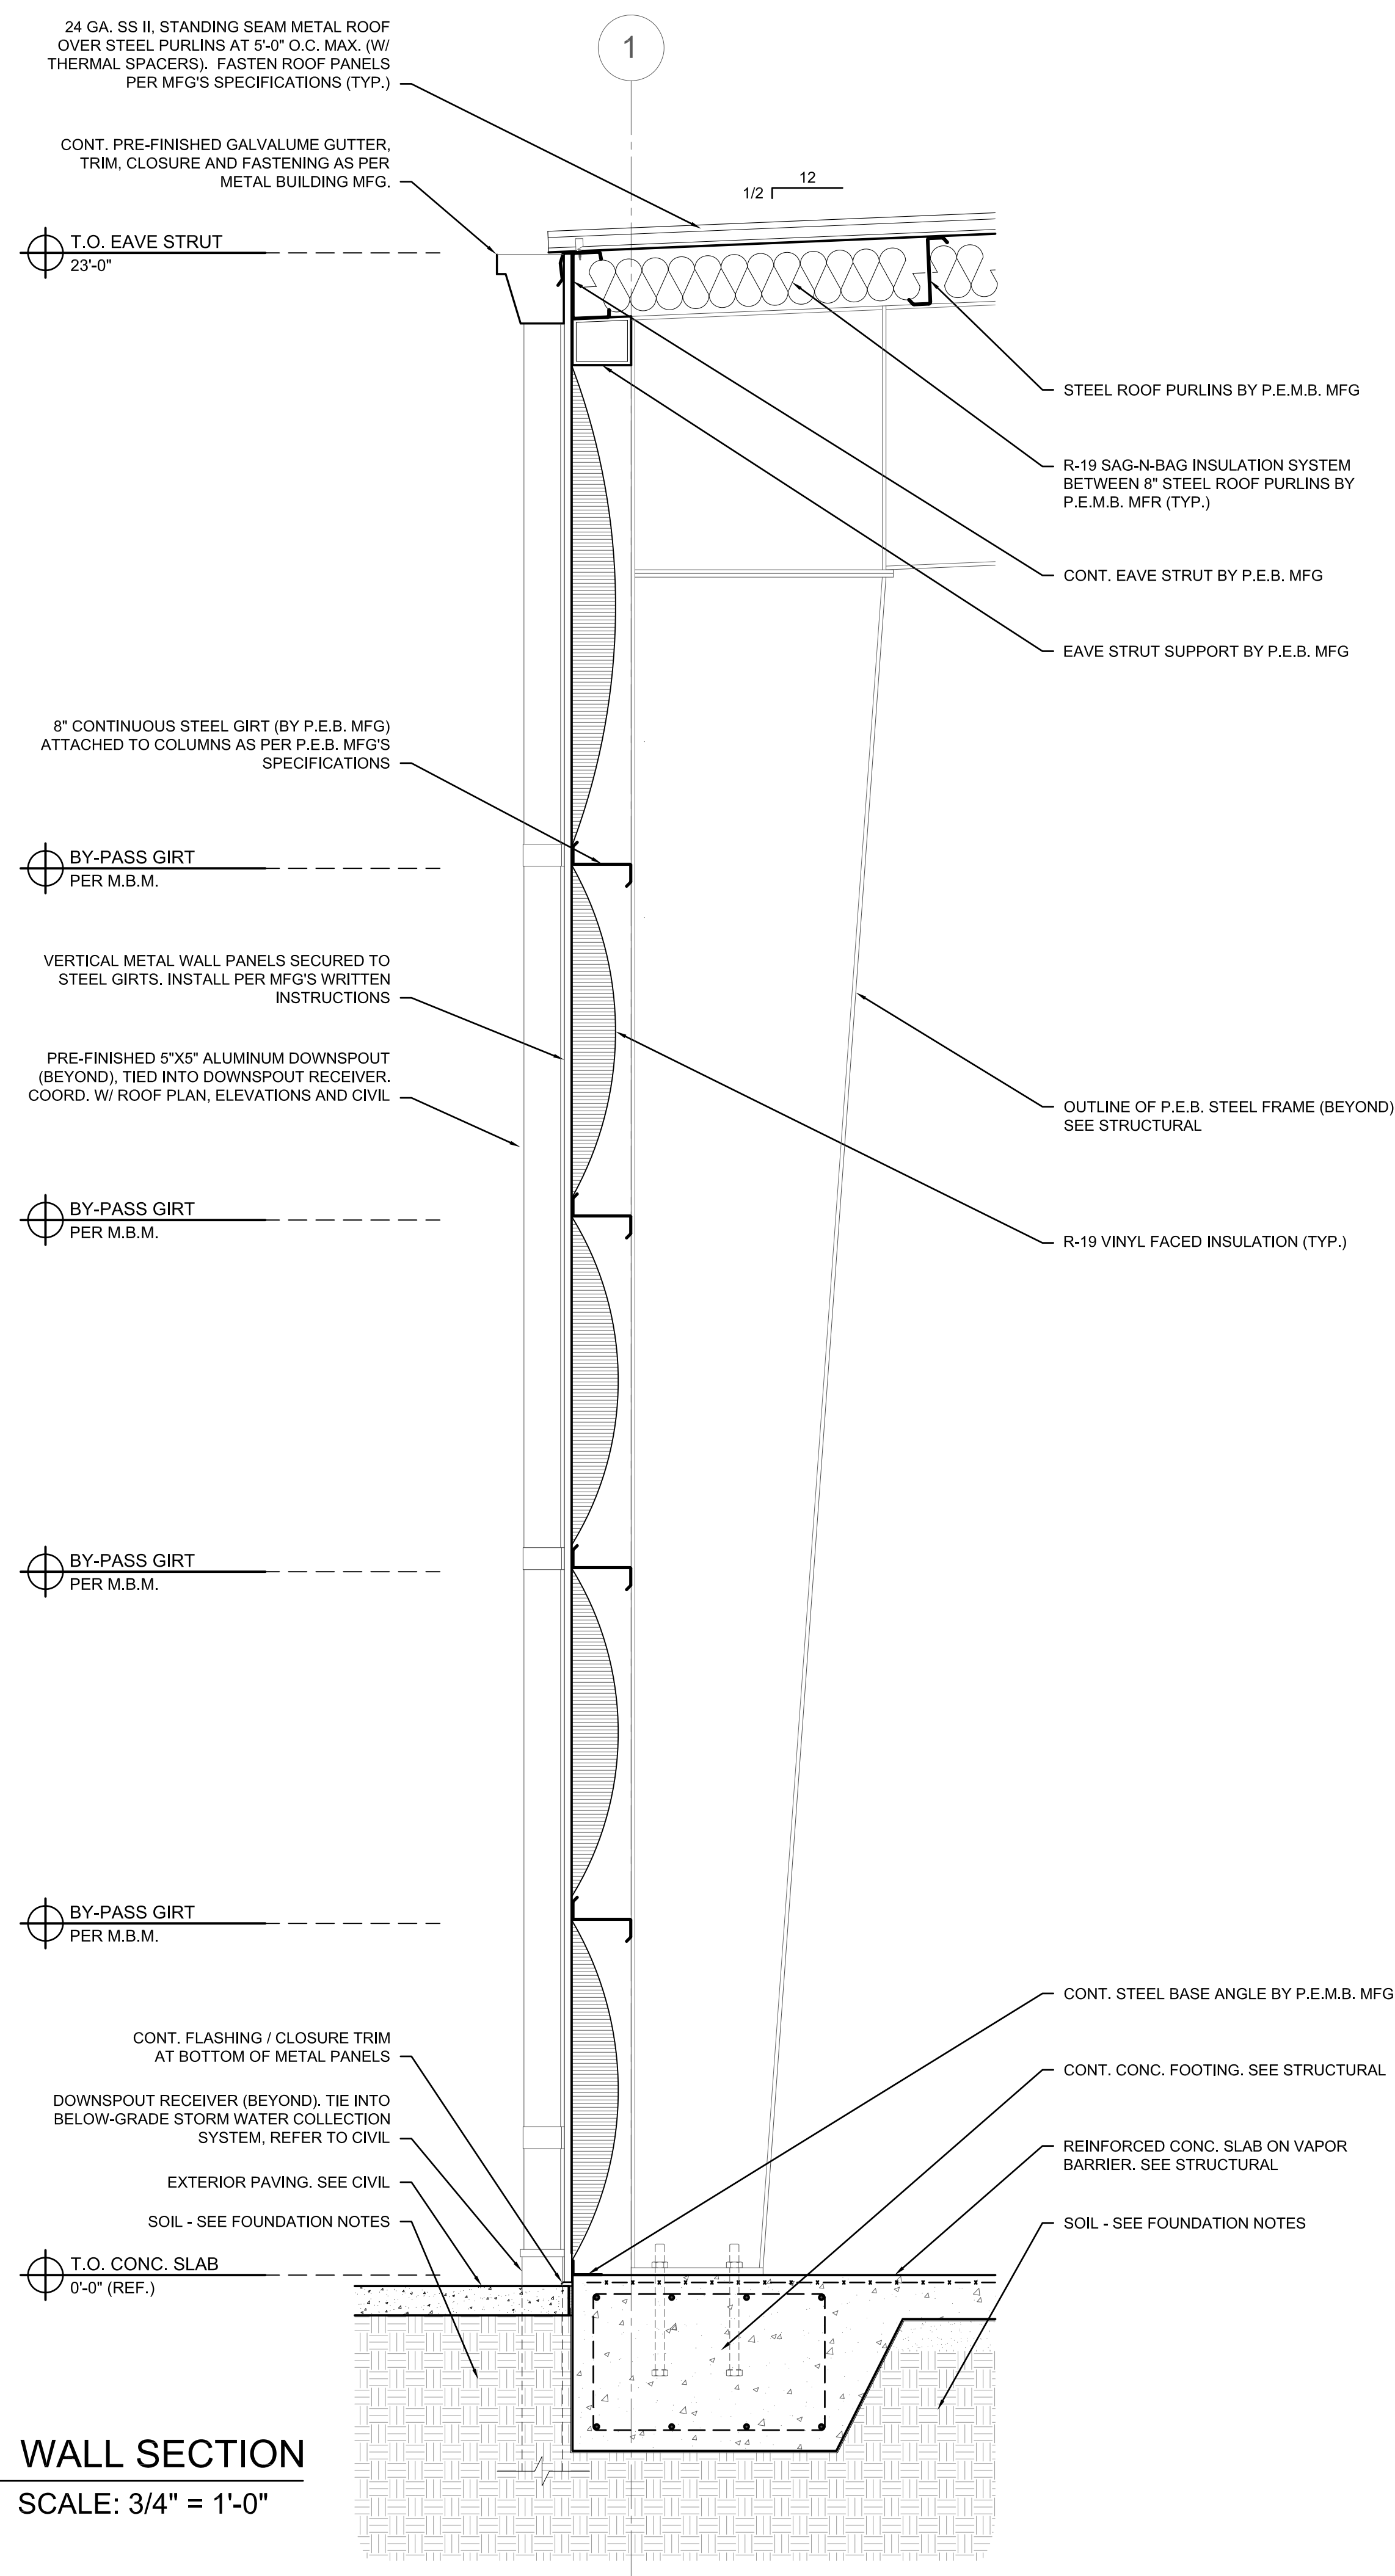

1 WALL SECTION
 A4.0 SCALE: 3/4" = 1'-0"

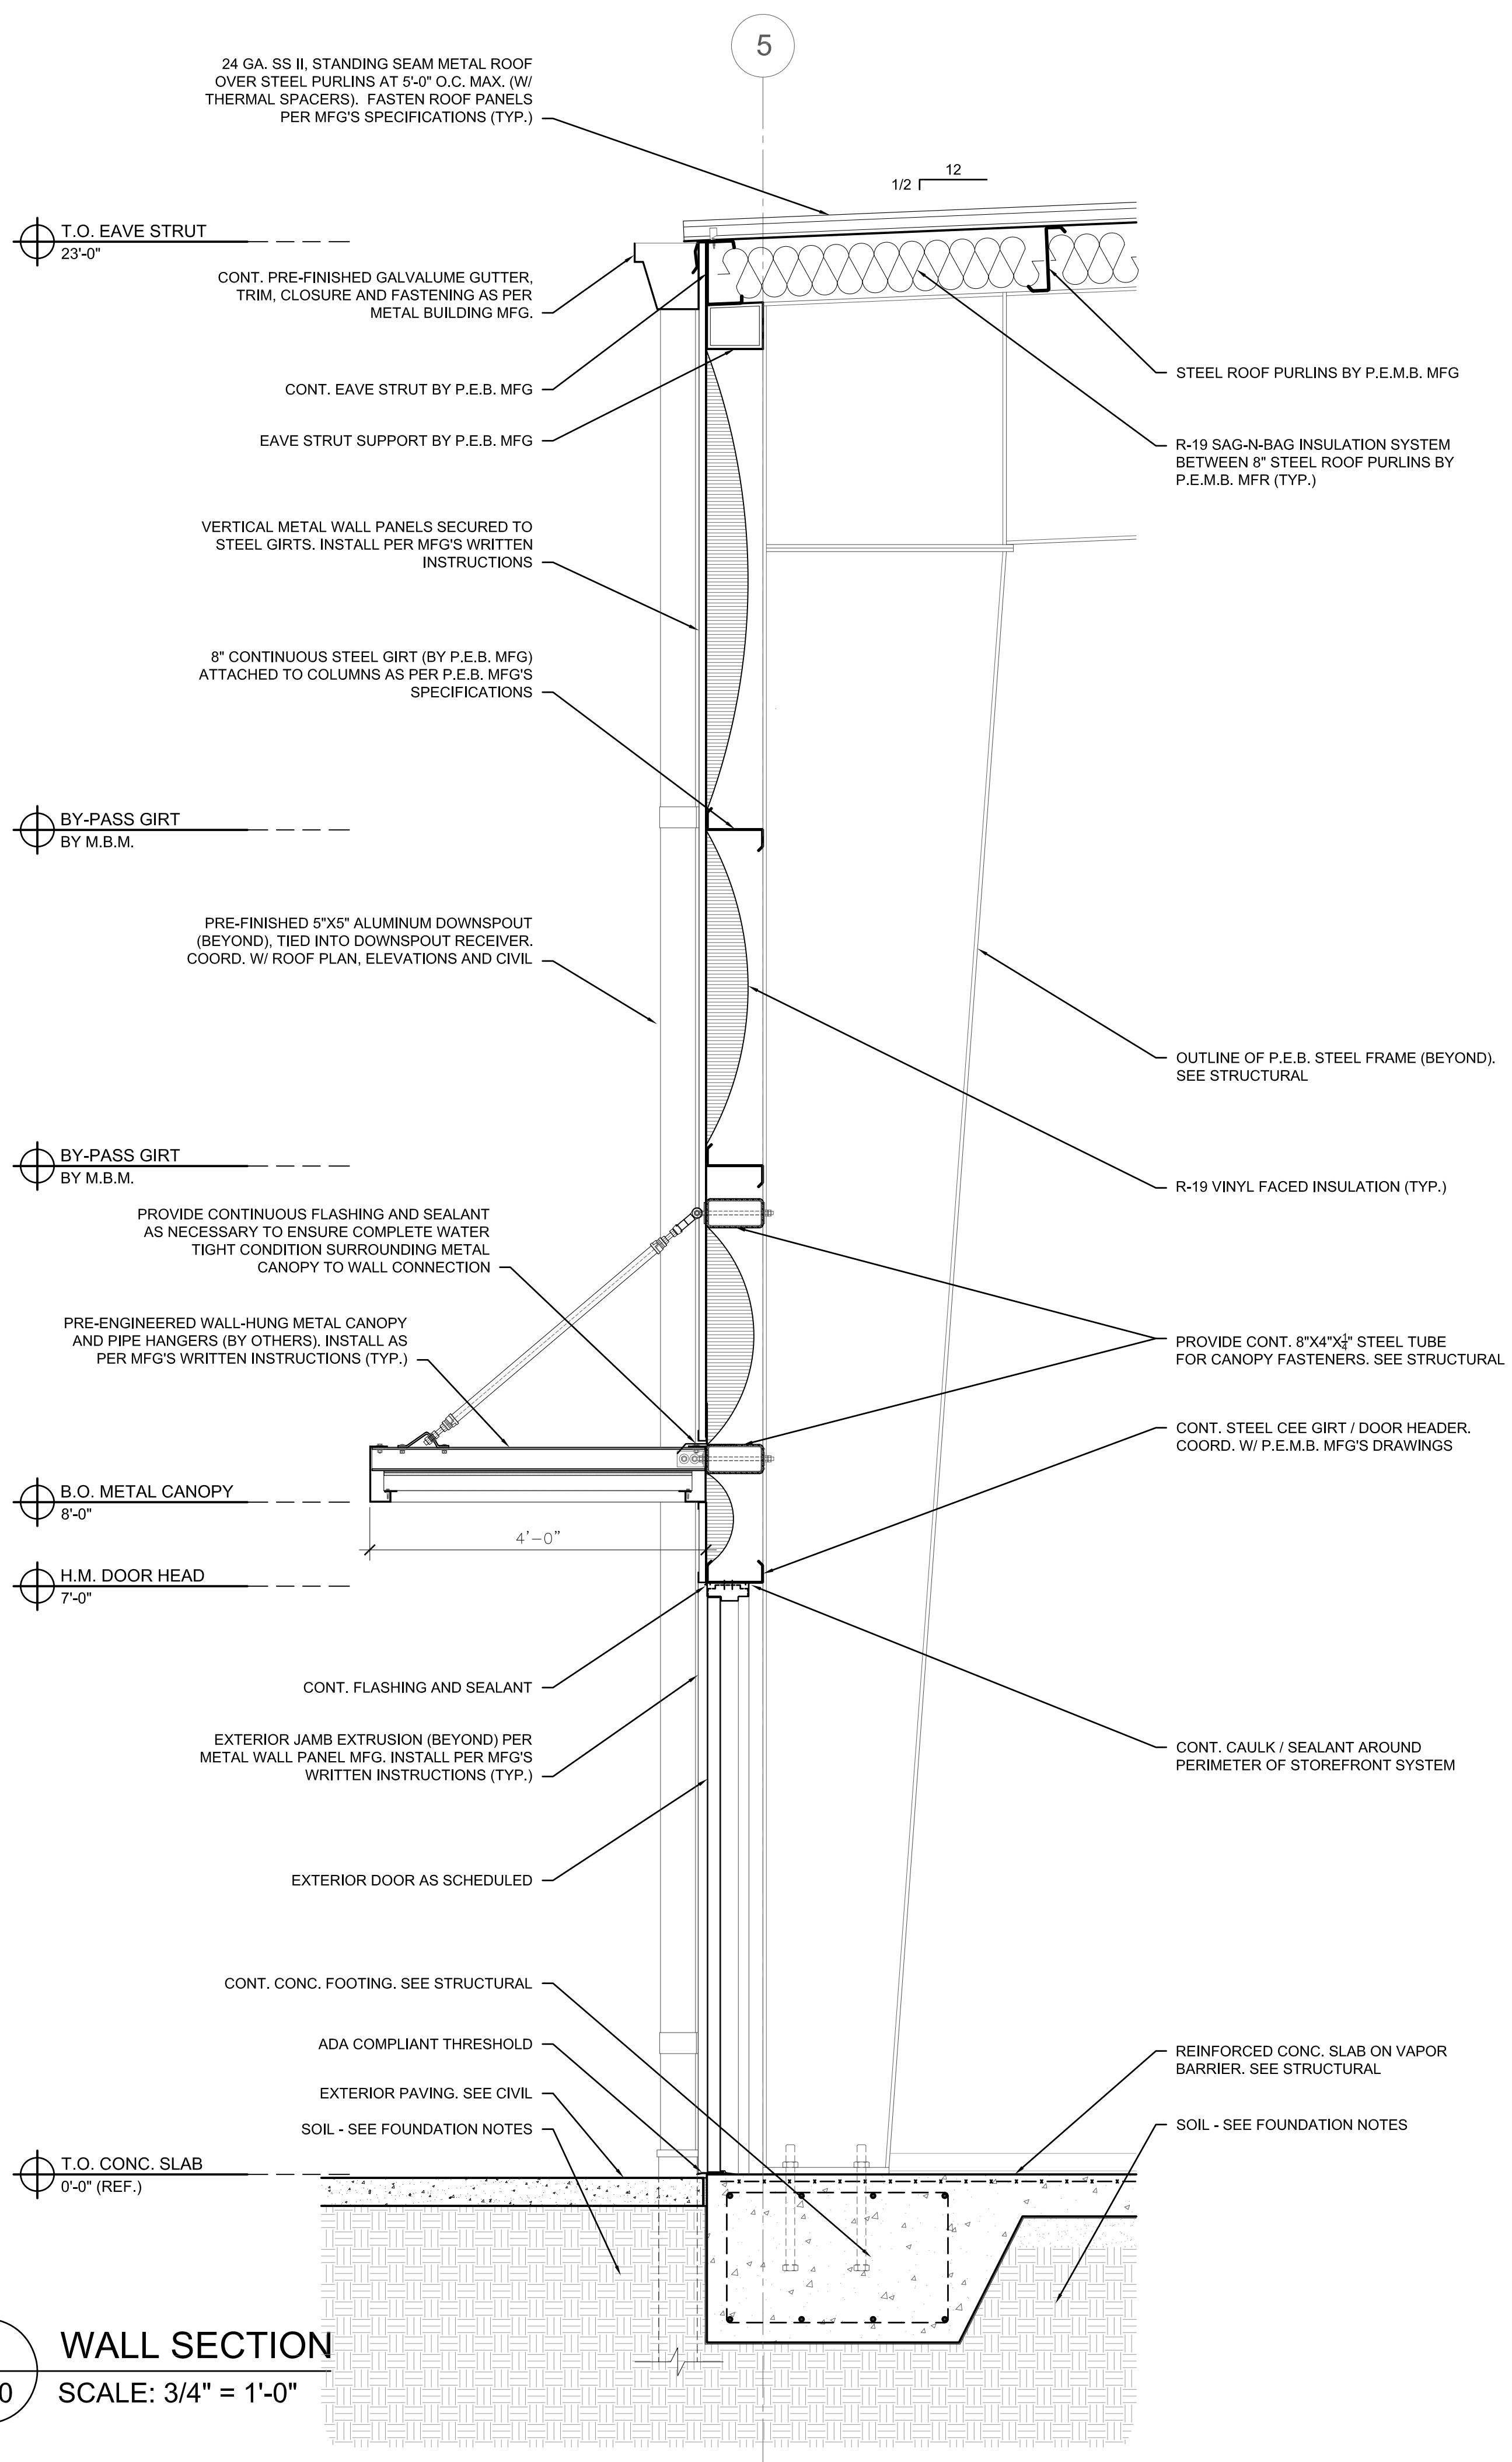


2 WALL SECTION
 A4.0 SCALE: 3/4" = 1'-0"


COPYRIGHT © 2024 CONN ARCHITECTS, INC. ALL RIGHTS RESERVED. NO PART OF THIS DOCUMENT MAY BE REPRODUCED, STORED IN A RETRIEVAL SYSTEM, OR TRANSMITTED IN ANY FORM OR BY ANY MEANS, ELECTRONIC, MECHANICAL, PHOTOCOPIING, RECORDING, OR OTHERWISE, WITHOUT THE PRIOR WRITTEN PERMISSION OF CONN ARCHITECTS, INC.

DATE	07-21-24
DRAWN BY	DBC
REVISED	
JOB NO.	23-208
DATE	
SHEET NUMBER	A4.1

PRICING SET - NOT FOR CONSTRUCTION

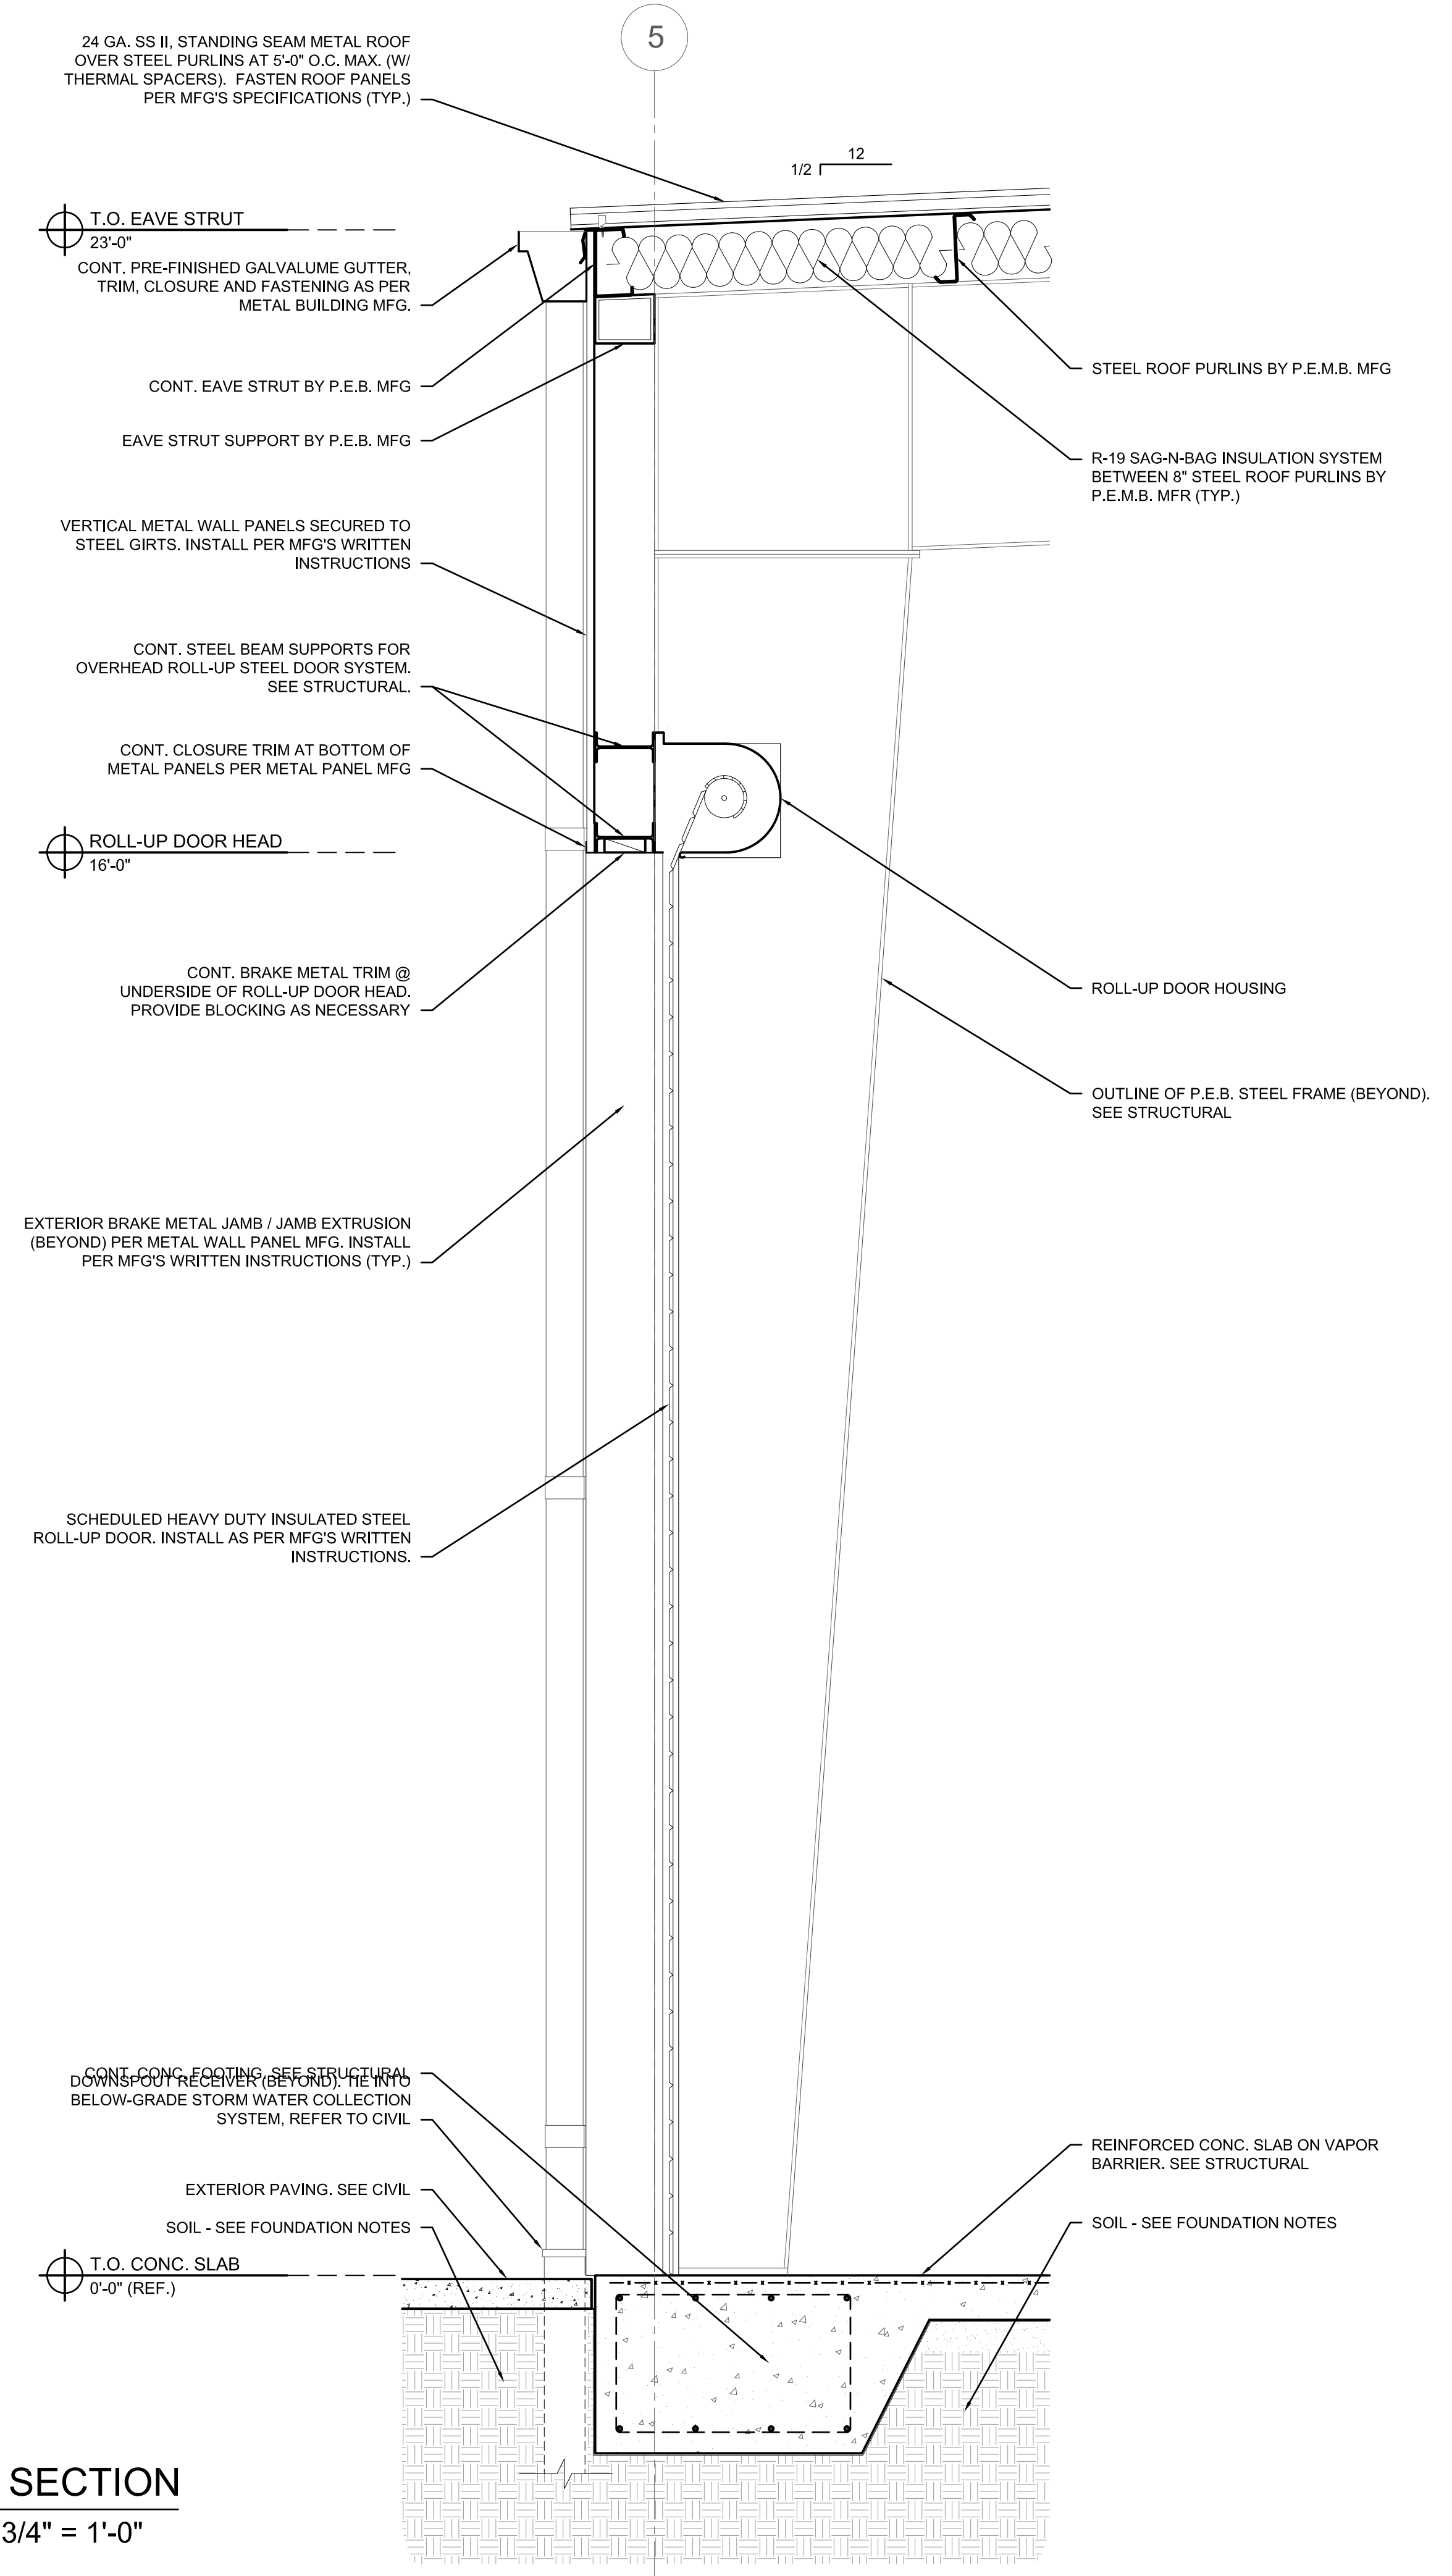


2 WALL SECTION
 A4.1 SCALE: 3/4" = 1'-0"

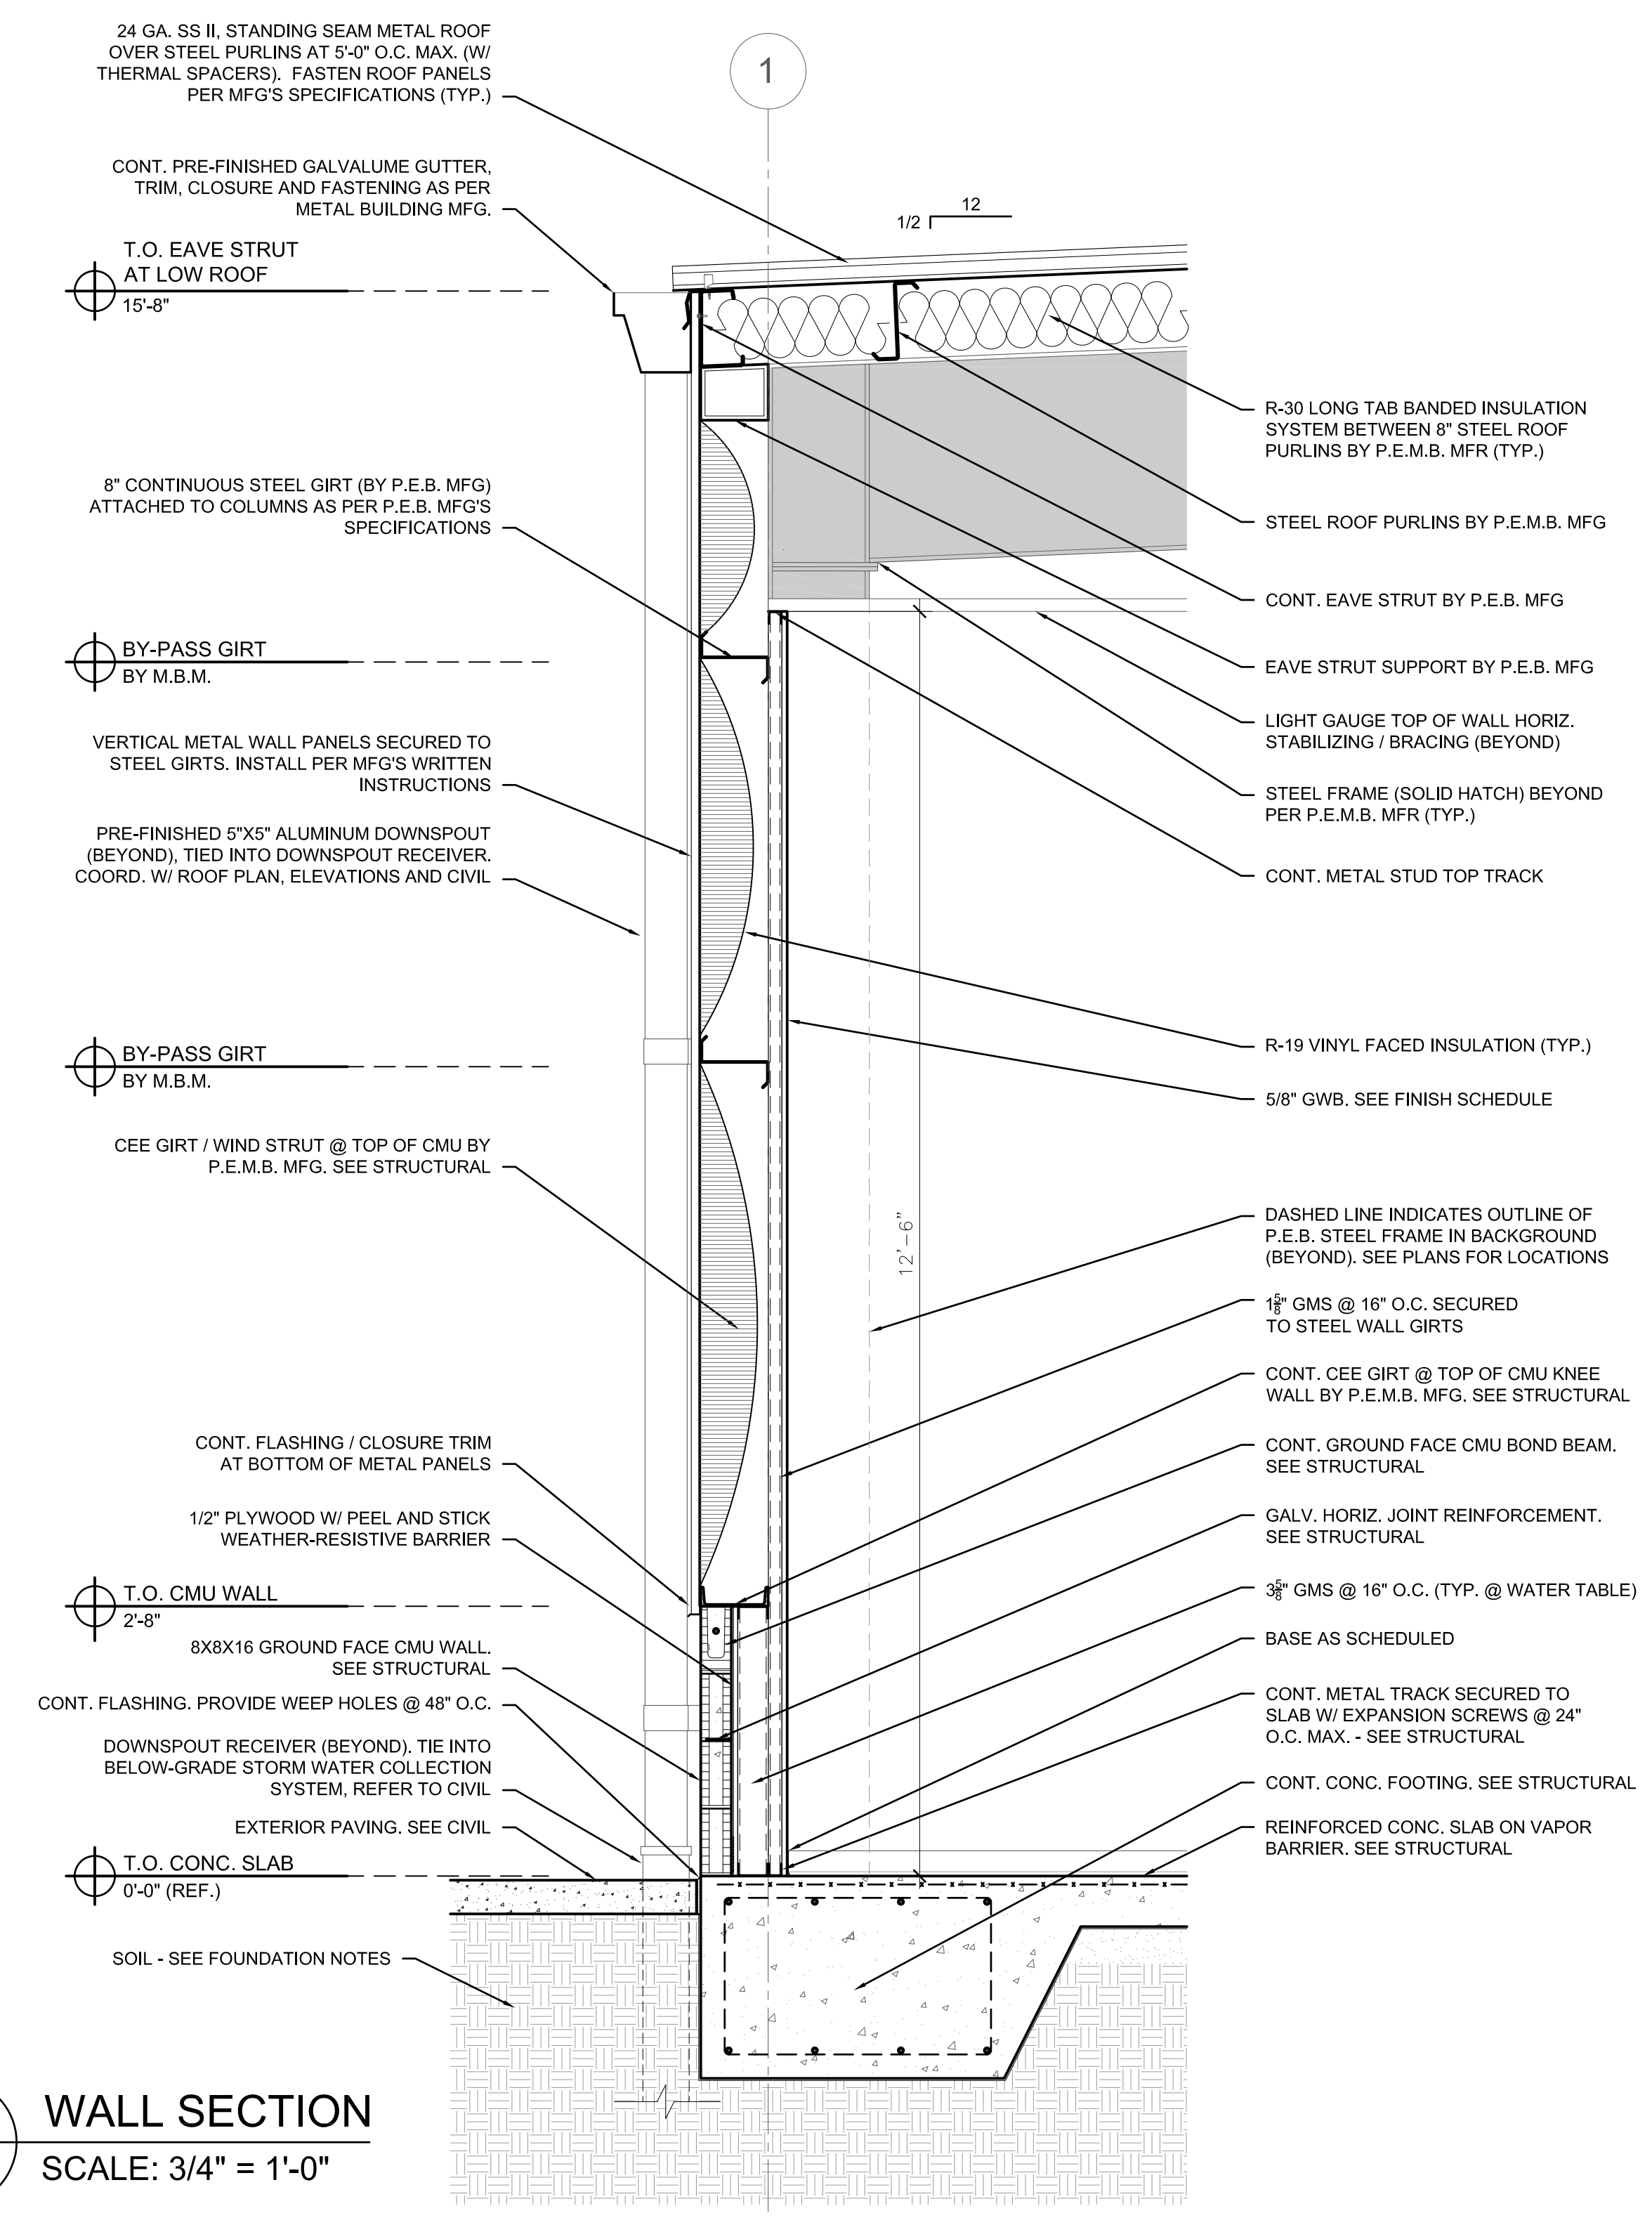


1 WALL SECTION
 A4.1 SCALE: 3/4" = 1'-0"

CONNECTIONS TO EXISTING STRUCTURE SHALL BE AS SHOWN. THE CONTRACTOR SHALL BE RESPONSIBLE FOR VERIFYING THE EXISTING STRUCTURE AND FOR PROVIDING ALL NECESSARY STRENGTHENING AND REPAIRS. THE CONTRACTOR SHALL BE RESPONSIBLE FOR OBTAINING ALL NECESSARY PERMITS AND FOR COMPLYING WITH ALL APPLICABLE CODES AND REGULATIONS. THE CONTRACTOR SHALL BE RESPONSIBLE FOR OBTAINING ALL NECESSARY PERMITS AND FOR COMPLYING WITH ALL APPLICABLE CODES AND REGULATIONS. THE CONTRACTOR SHALL BE RESPONSIBLE FOR OBTAINING ALL NECESSARY PERMITS AND FOR COMPLYING WITH ALL APPLICABLE CODES AND REGULATIONS.

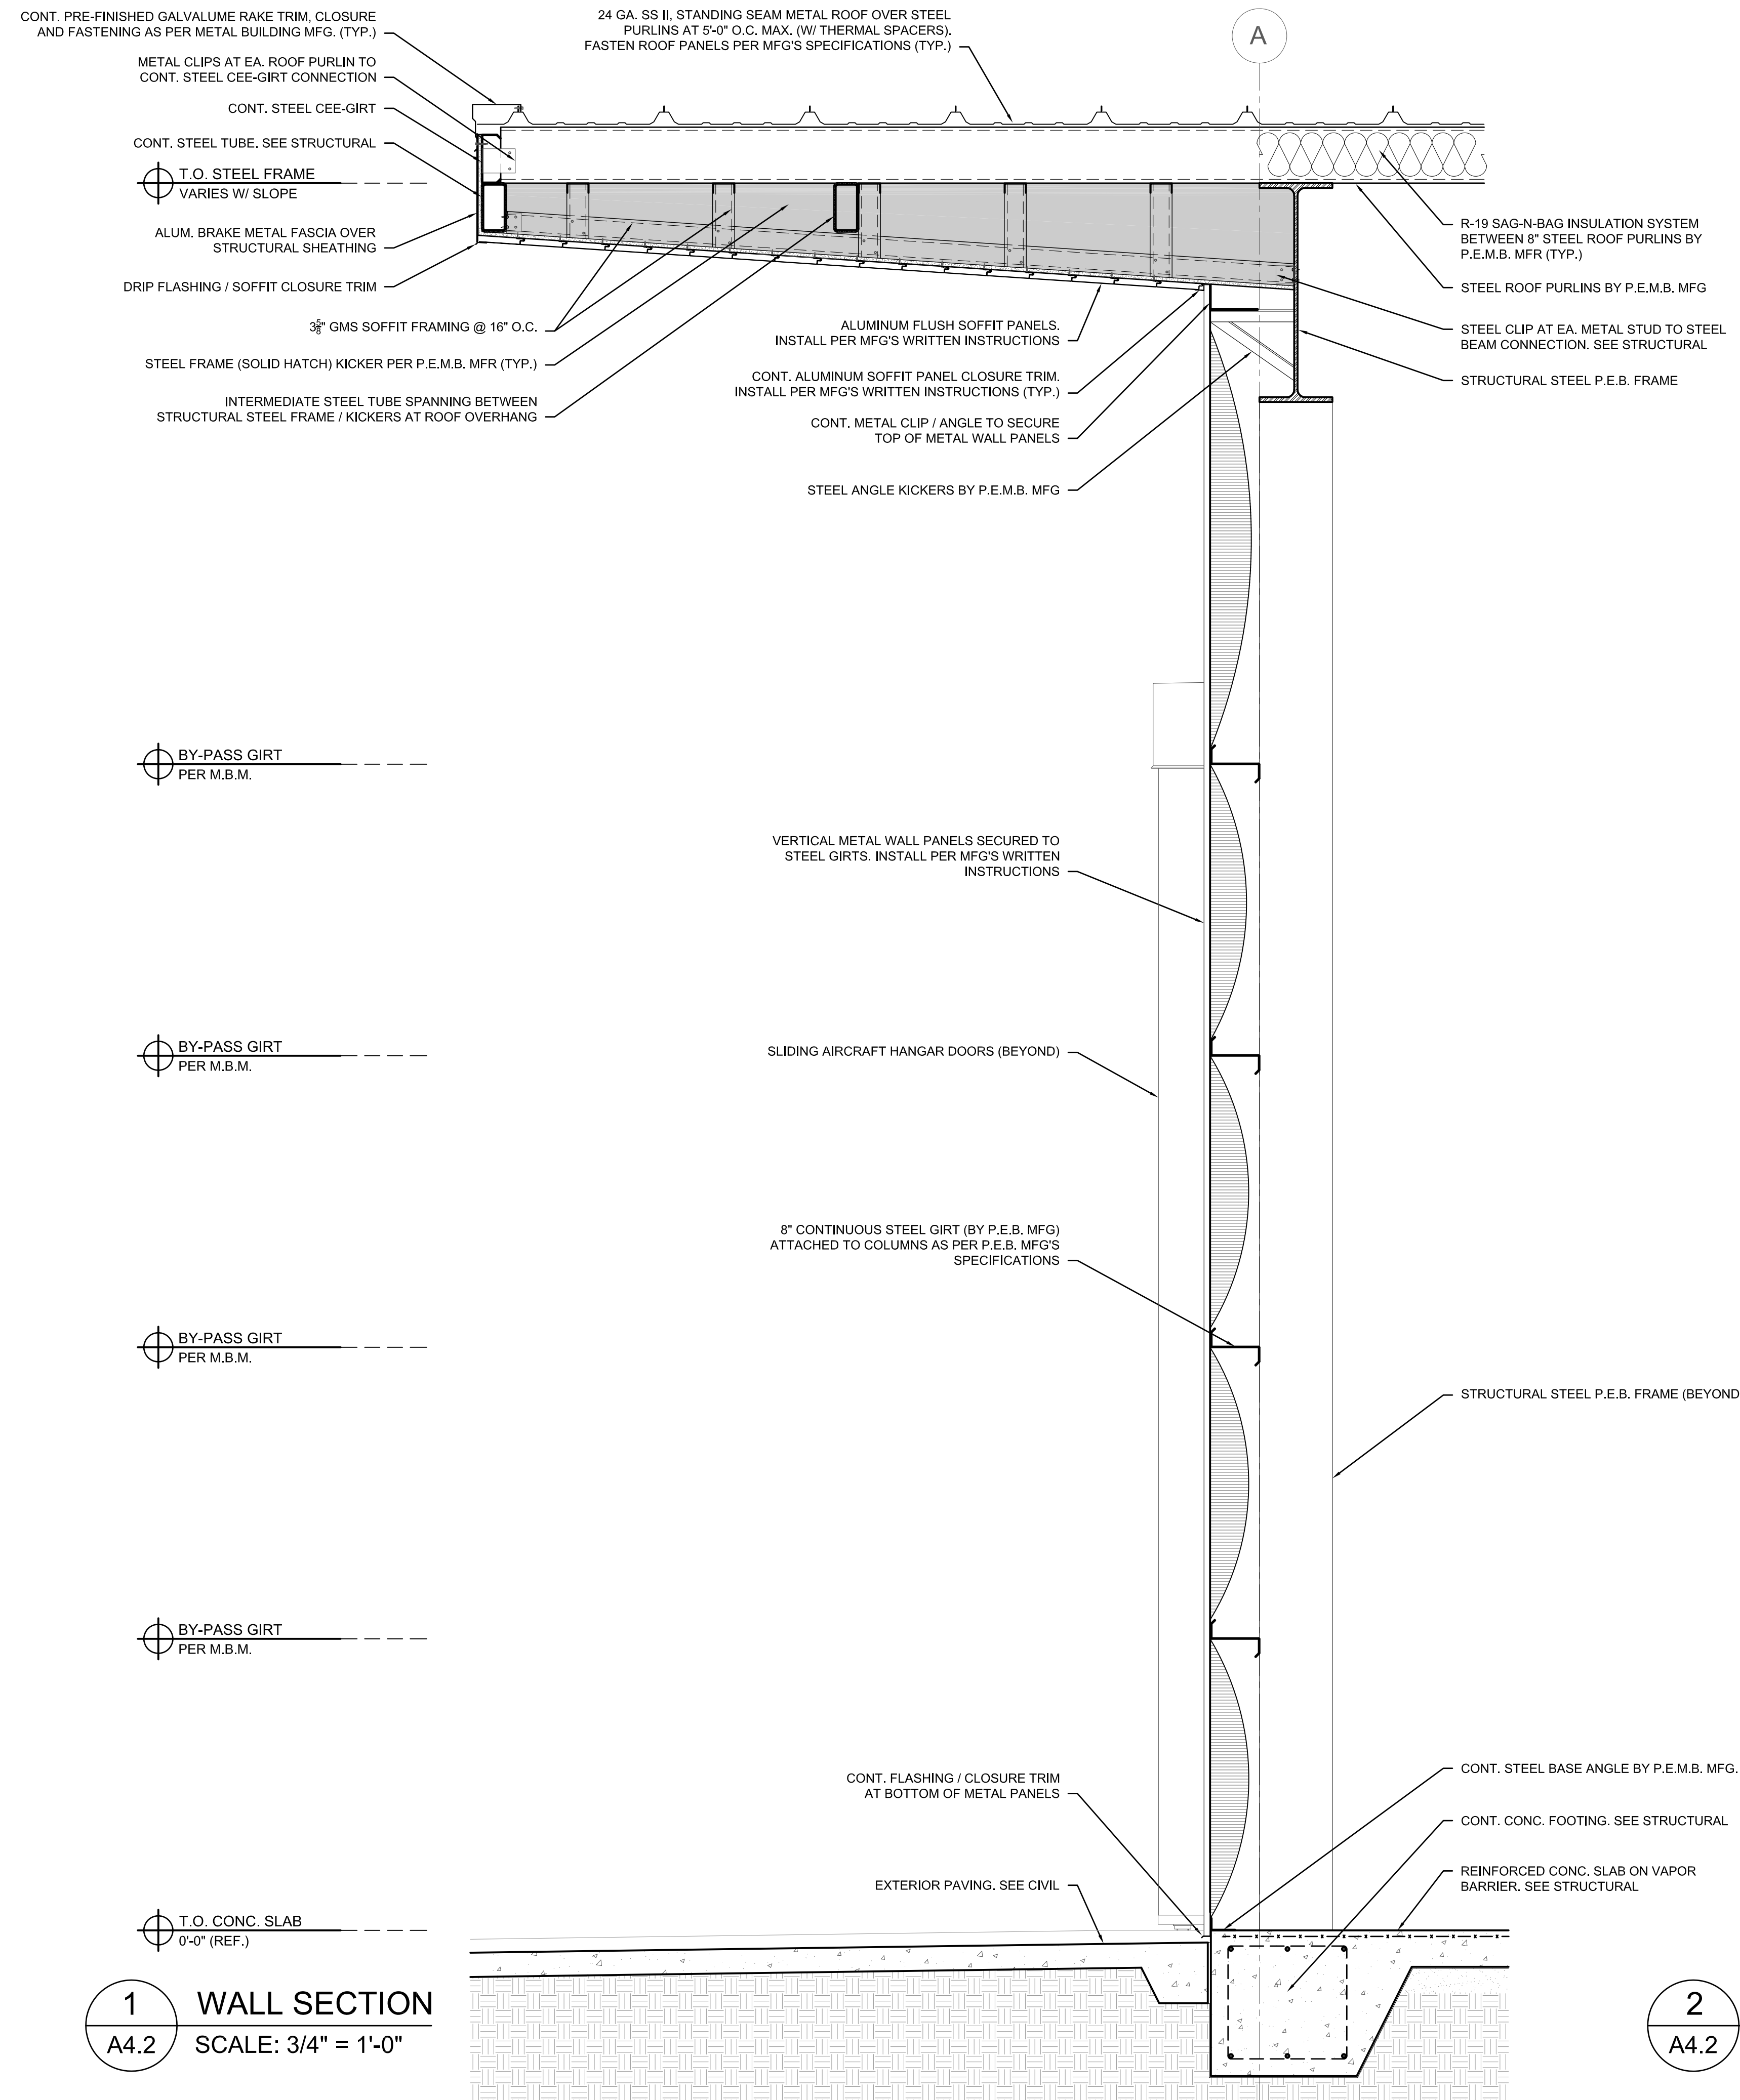

1 WALL SECTION
A4.2 SCALE: 3/4" = 1'-0"

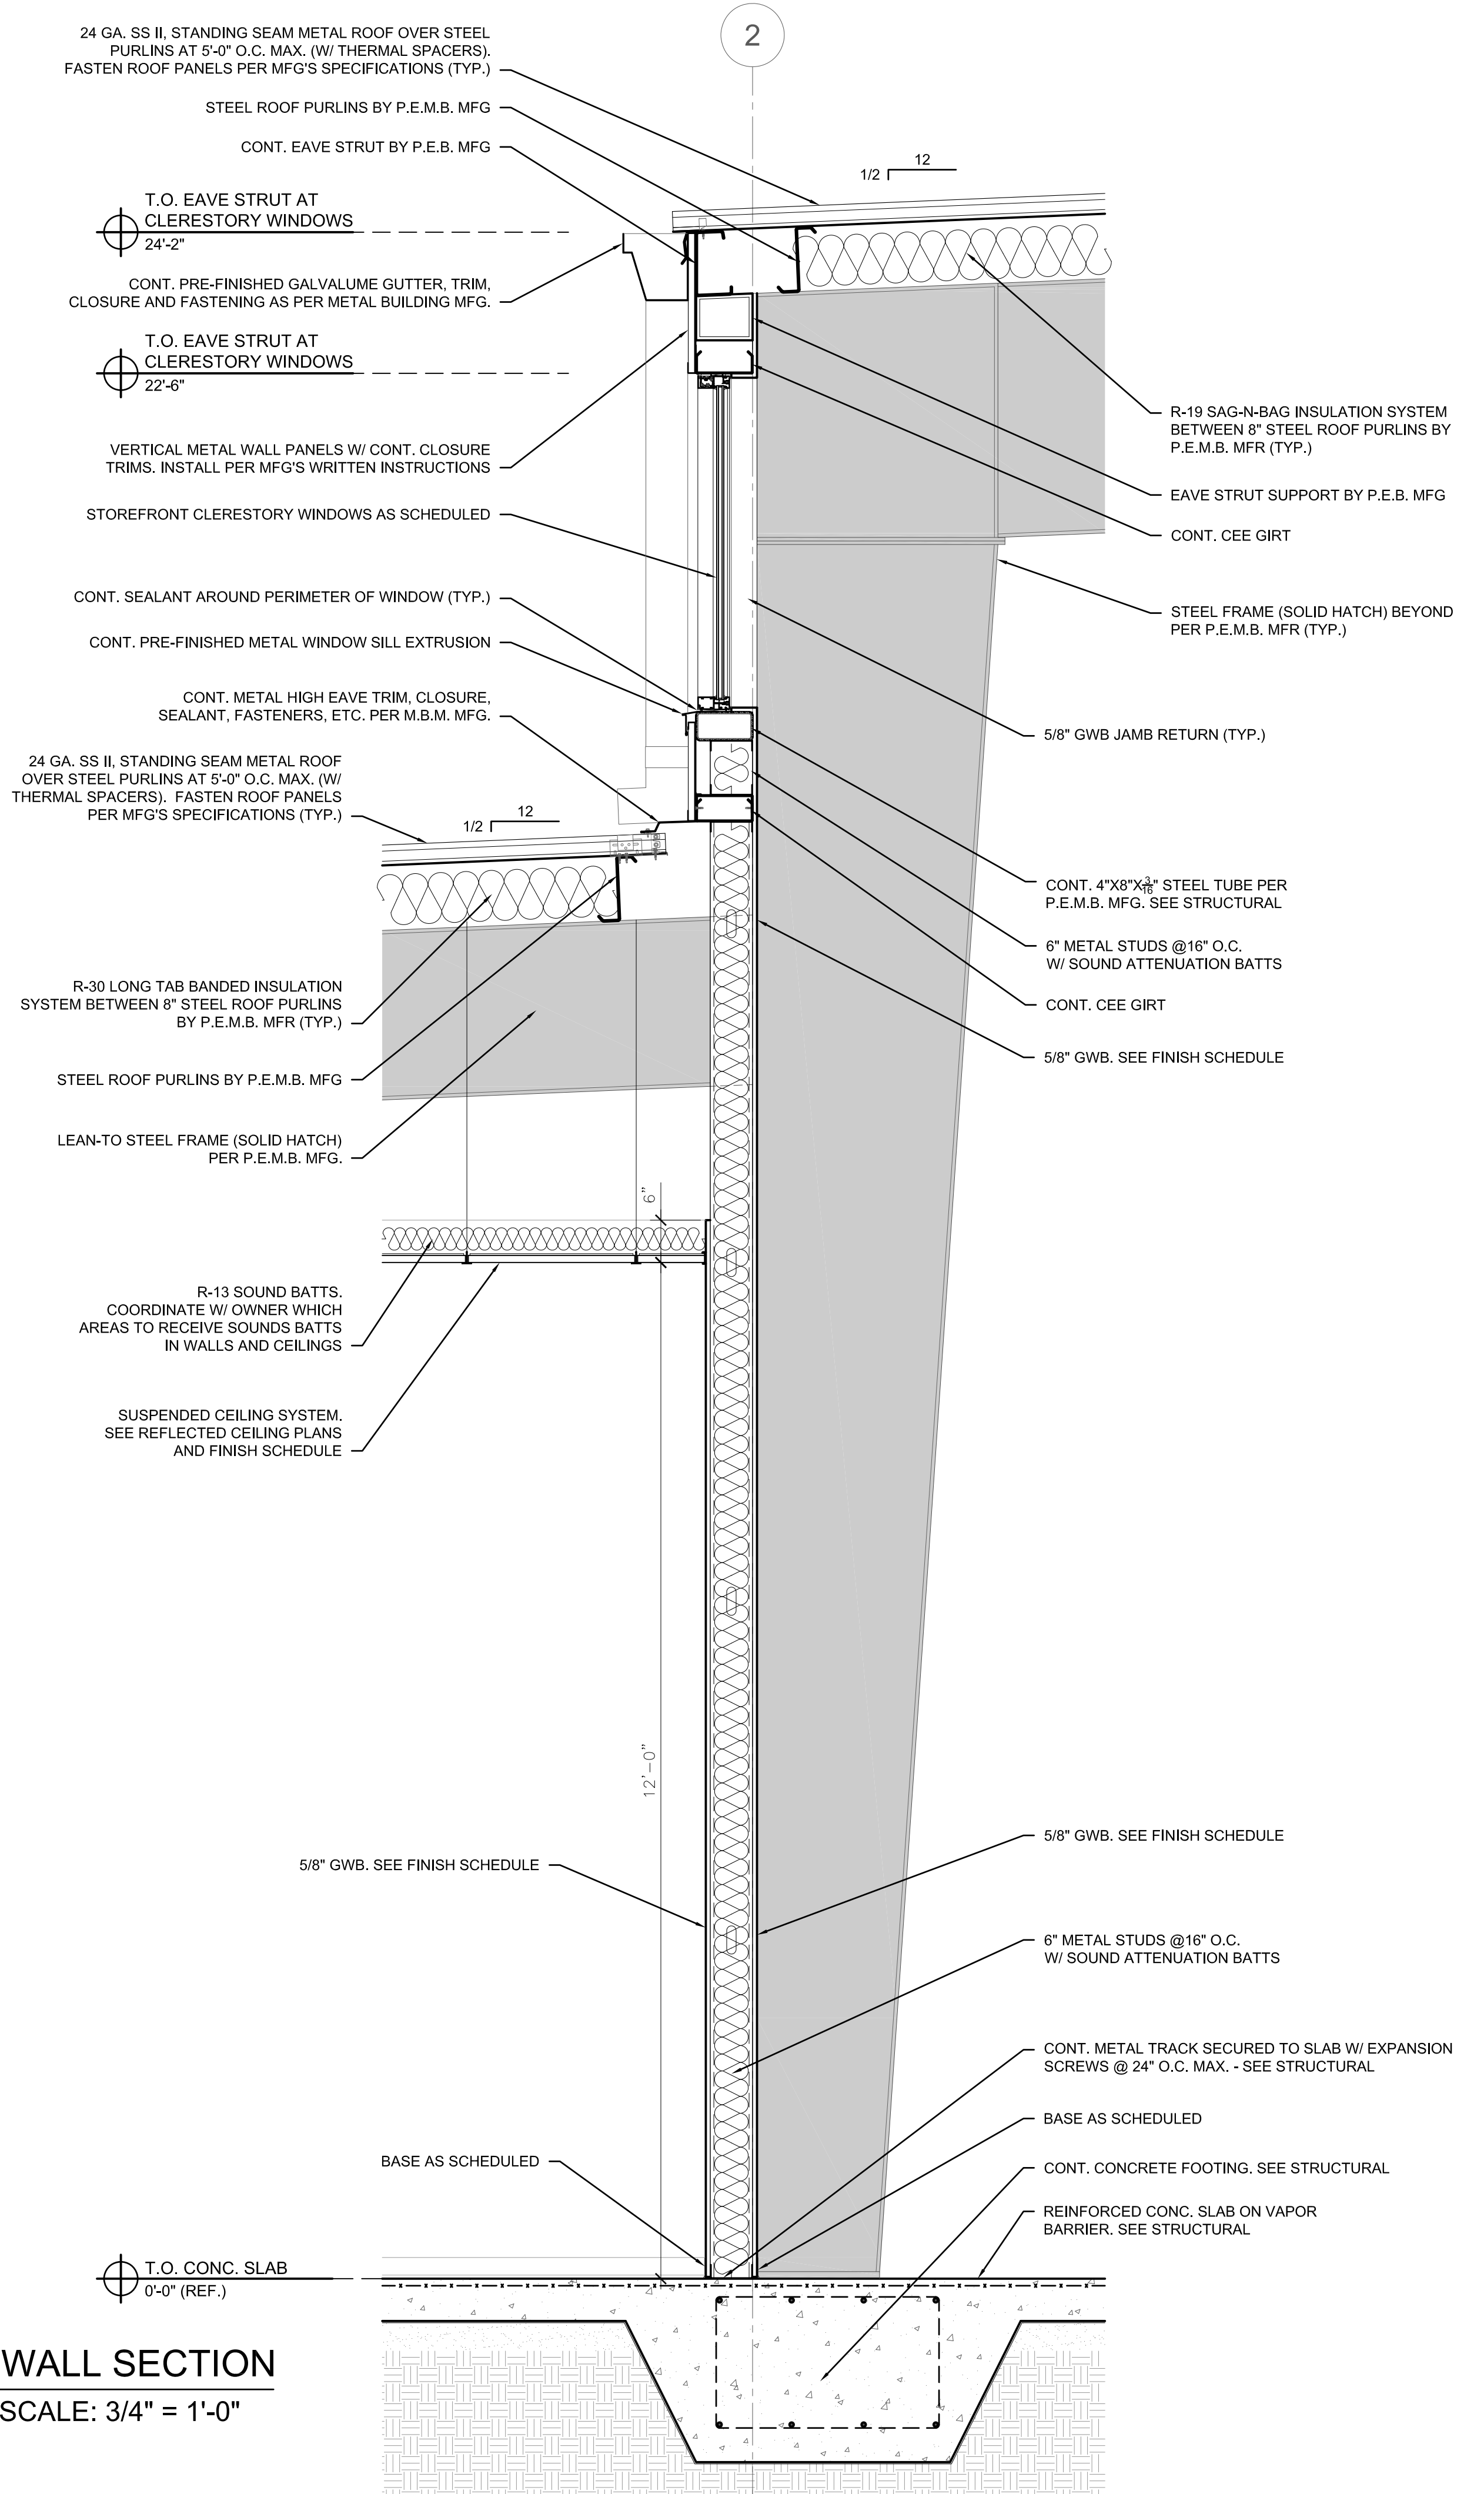

2 WALL SECTION
A4.2 SCALE: 3/4" = 1'-0"


CONTRACTOR: CONN + ARCHITECTS, INC. 1960-C Buford Boulevard Tallahassee, Florida 32308 | 850-878-9784
 NO PART OF THESE DOCUMENTS MAY BE REPRODUCED, STORED IN A RETRIEVAL SYSTEM, OR TRANSMITTED IN ANY FORM OR BY ANY MEANS, ELECTRONIC, MECHANICAL, PHOTOCOPIING, RECORDING, OR OTHERWISE, WITHOUT THE PRIOR WRITTEN PERMISSION OF CONN + ARCHITECTS, INC.

METAL FABRICATIONS NEW FACILITY
 4323 AVIATION AVENUE, TALLAHASSEE, FL 32310
WALL SECTIONS

CONN + ARCHITECTS
 1960-C Buford Boulevard Tallahassee, Florida 32308 | 850-878-9784
 www.CONNarchitects.com | Lic. No. AA-C001662

DATE	07-21-24
DRAWN BY	DBC
REVISED	
JOB NO.	23-208
DATE	
SHEET NUMBER	A4.2

PRICING SET - NOT FOR CONSTRUCTION

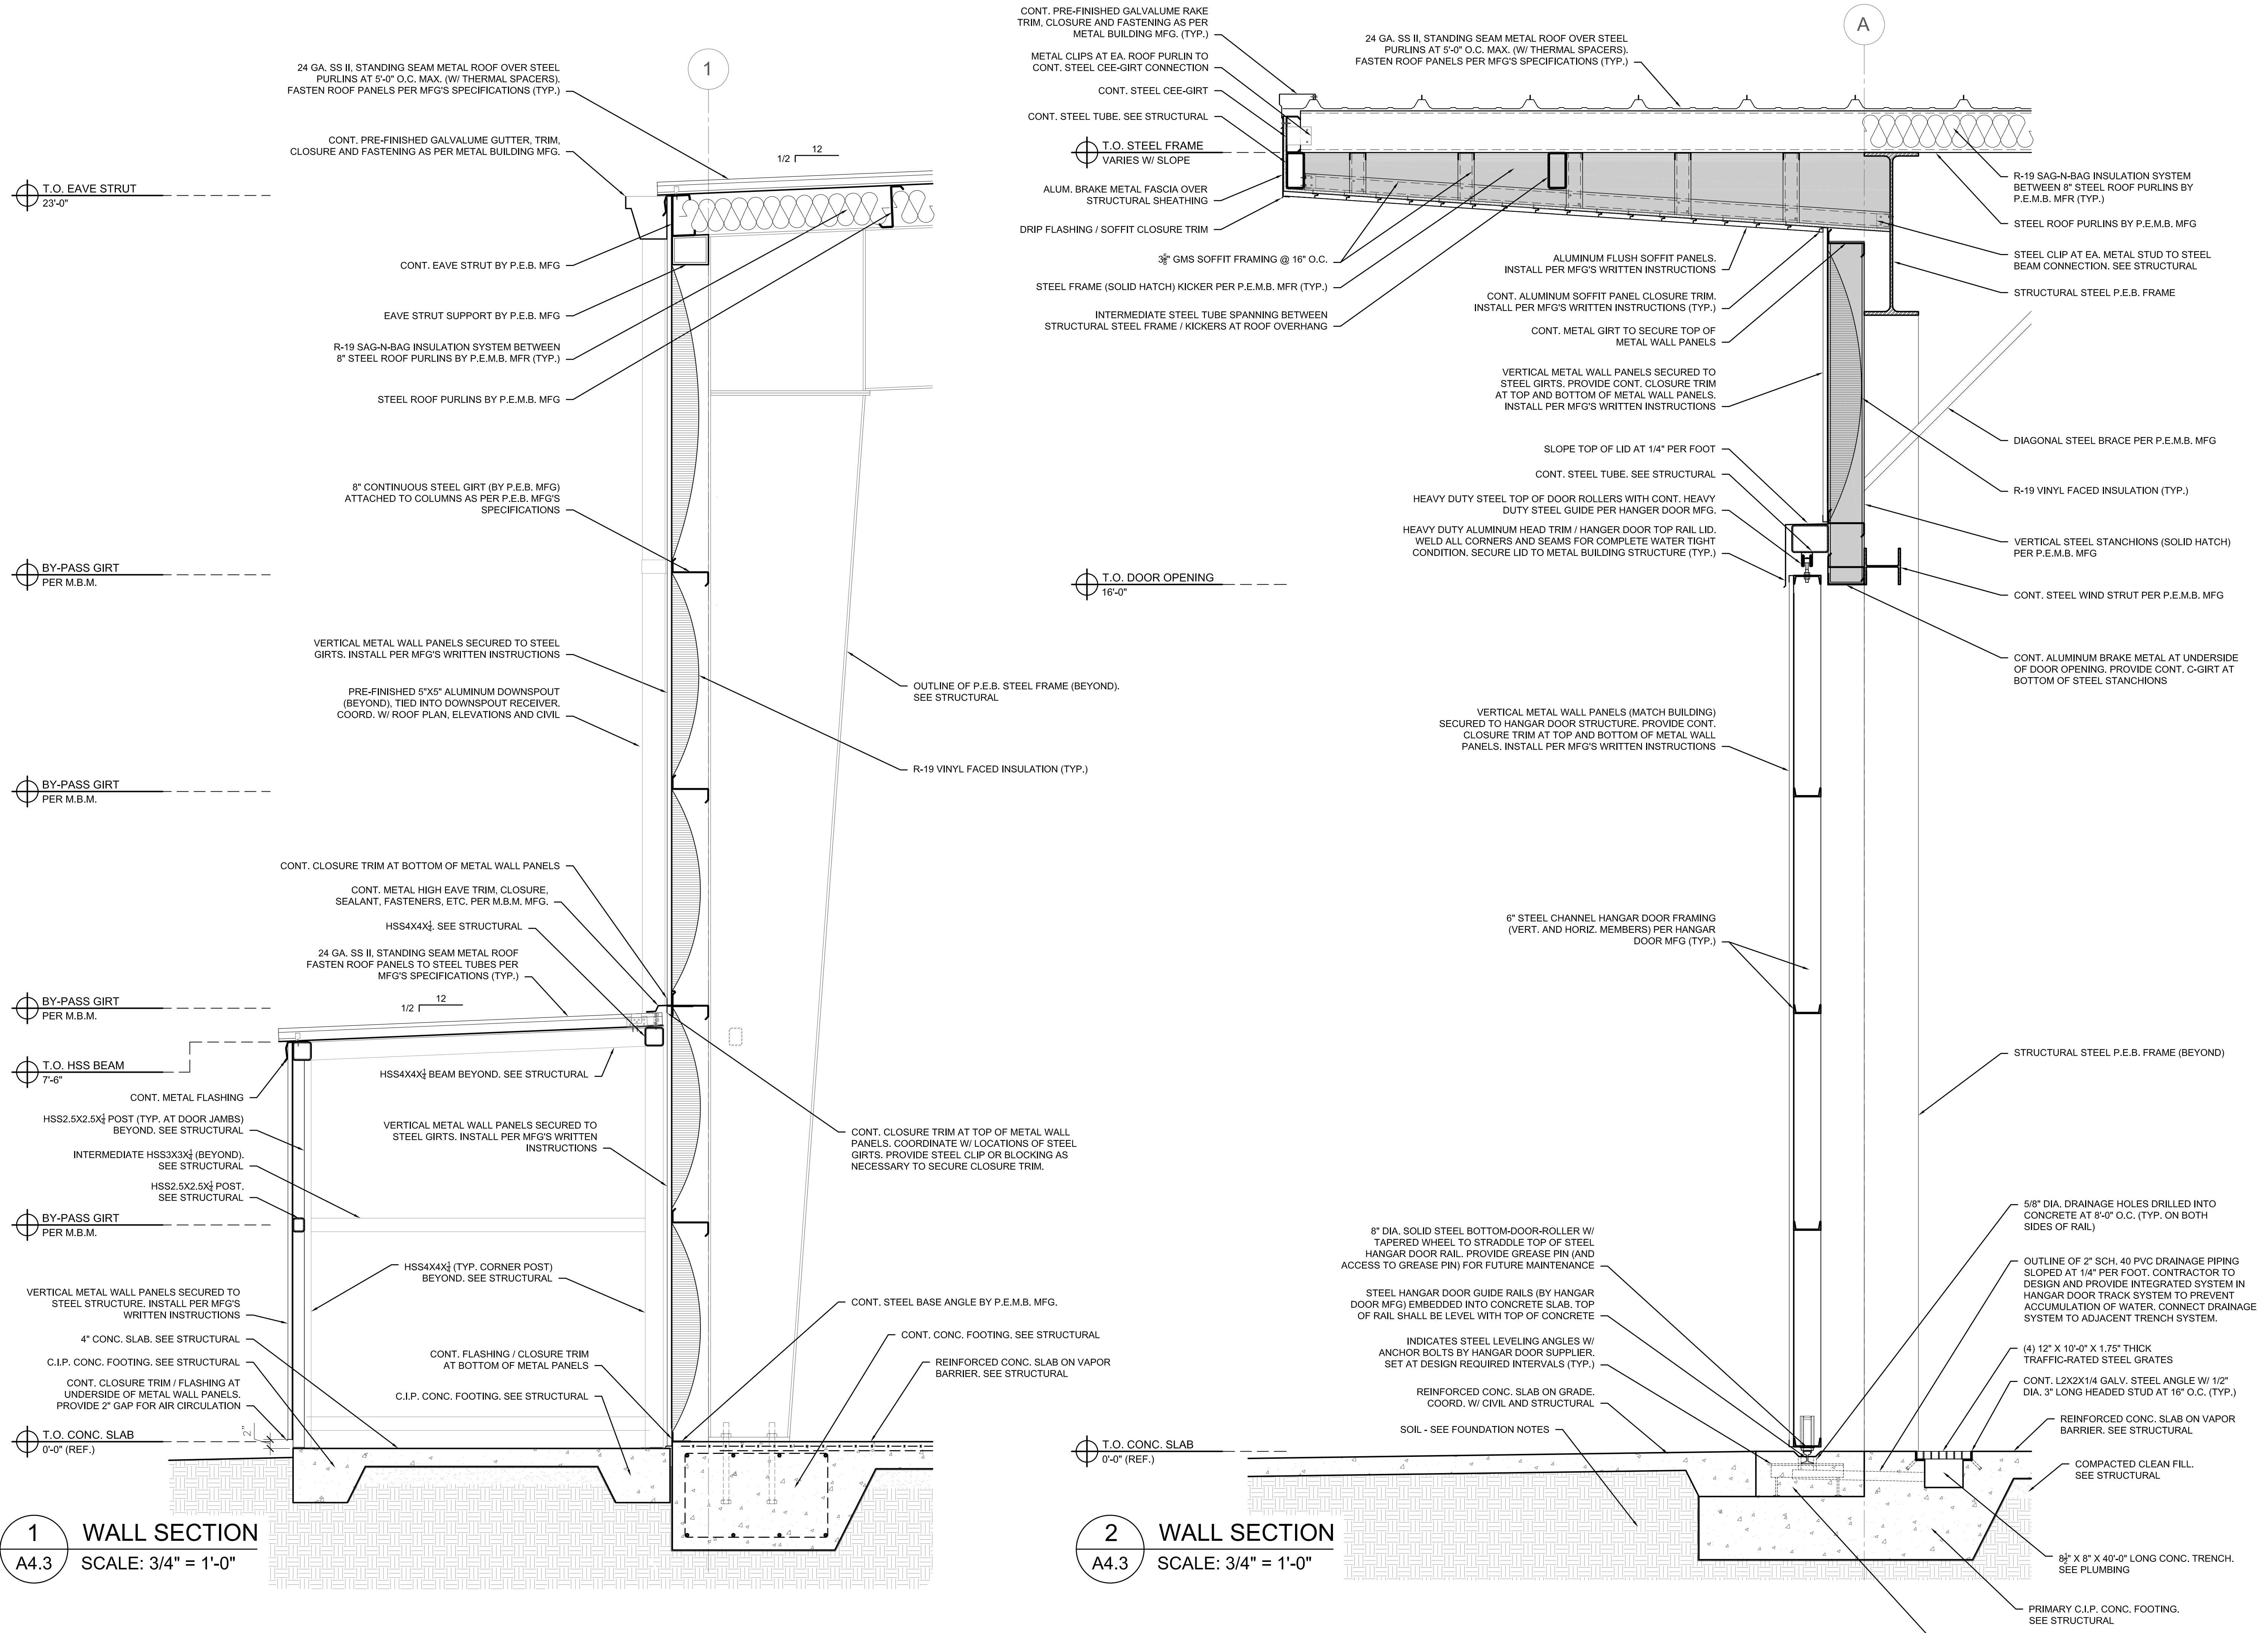

1 WALL SECTION
A4.3 SCALE: 3/4" = 1'-0"

2 WALL SECTION
A4.3 SCALE: 3/4" = 1'-0"

METAL FABRICATIONS NEW FACILITY
4323 AVIATION AVENUE, TALLAHASSEE, FL 32310


WALL SECTIONS

CONN + ARCHITECTS
1960-C Buford Boulevard Tallahassee, Florida 32308 | 850-878-9784
www.connarchitects.com | Lic. No. AA-C001662


DATE	07-21-24
DRAWN BY	DBC
REVISIONS	
SHEET NO.	23-208
DATE	
SHEET NUMBER	A4.3

PRICING SET - NOT FOR CONSTRUCTION

CONNECTIONS AND DETAILS ARE SUBJECT TO CHANGE WITHOUT NOTICE. THE CONTRACTOR SHALL VERIFY ALL DIMENSIONS AND CONDITIONS OF THE EXISTING STRUCTURE AND MATERIALS. ANY CHANGES TO THE DRAWINGS SHALL BE MADE BY THE ARCHITECT. THE CONTRACTOR SHALL BE RESPONSIBLE FOR OBTAINING ALL NECESSARY PERMITS AND APPROVALS. THE CONTRACTOR SHALL BE RESPONSIBLE FOR THE PROTECTION OF ALL UTILITIES AND STRUCTURES TO REMAIN. THE CONTRACTOR SHALL BE RESPONSIBLE FOR THE PROTECTION OF ALL ADJACENT PROPERTIES AND STRUCTURES. THE CONTRACTOR SHALL BE RESPONSIBLE FOR THE PROTECTION OF ALL ADJACENT PROPERTIES AND STRUCTURES. THE CONTRACTOR SHALL BE RESPONSIBLE FOR THE PROTECTION OF ALL ADJACENT PROPERTIES AND STRUCTURES.

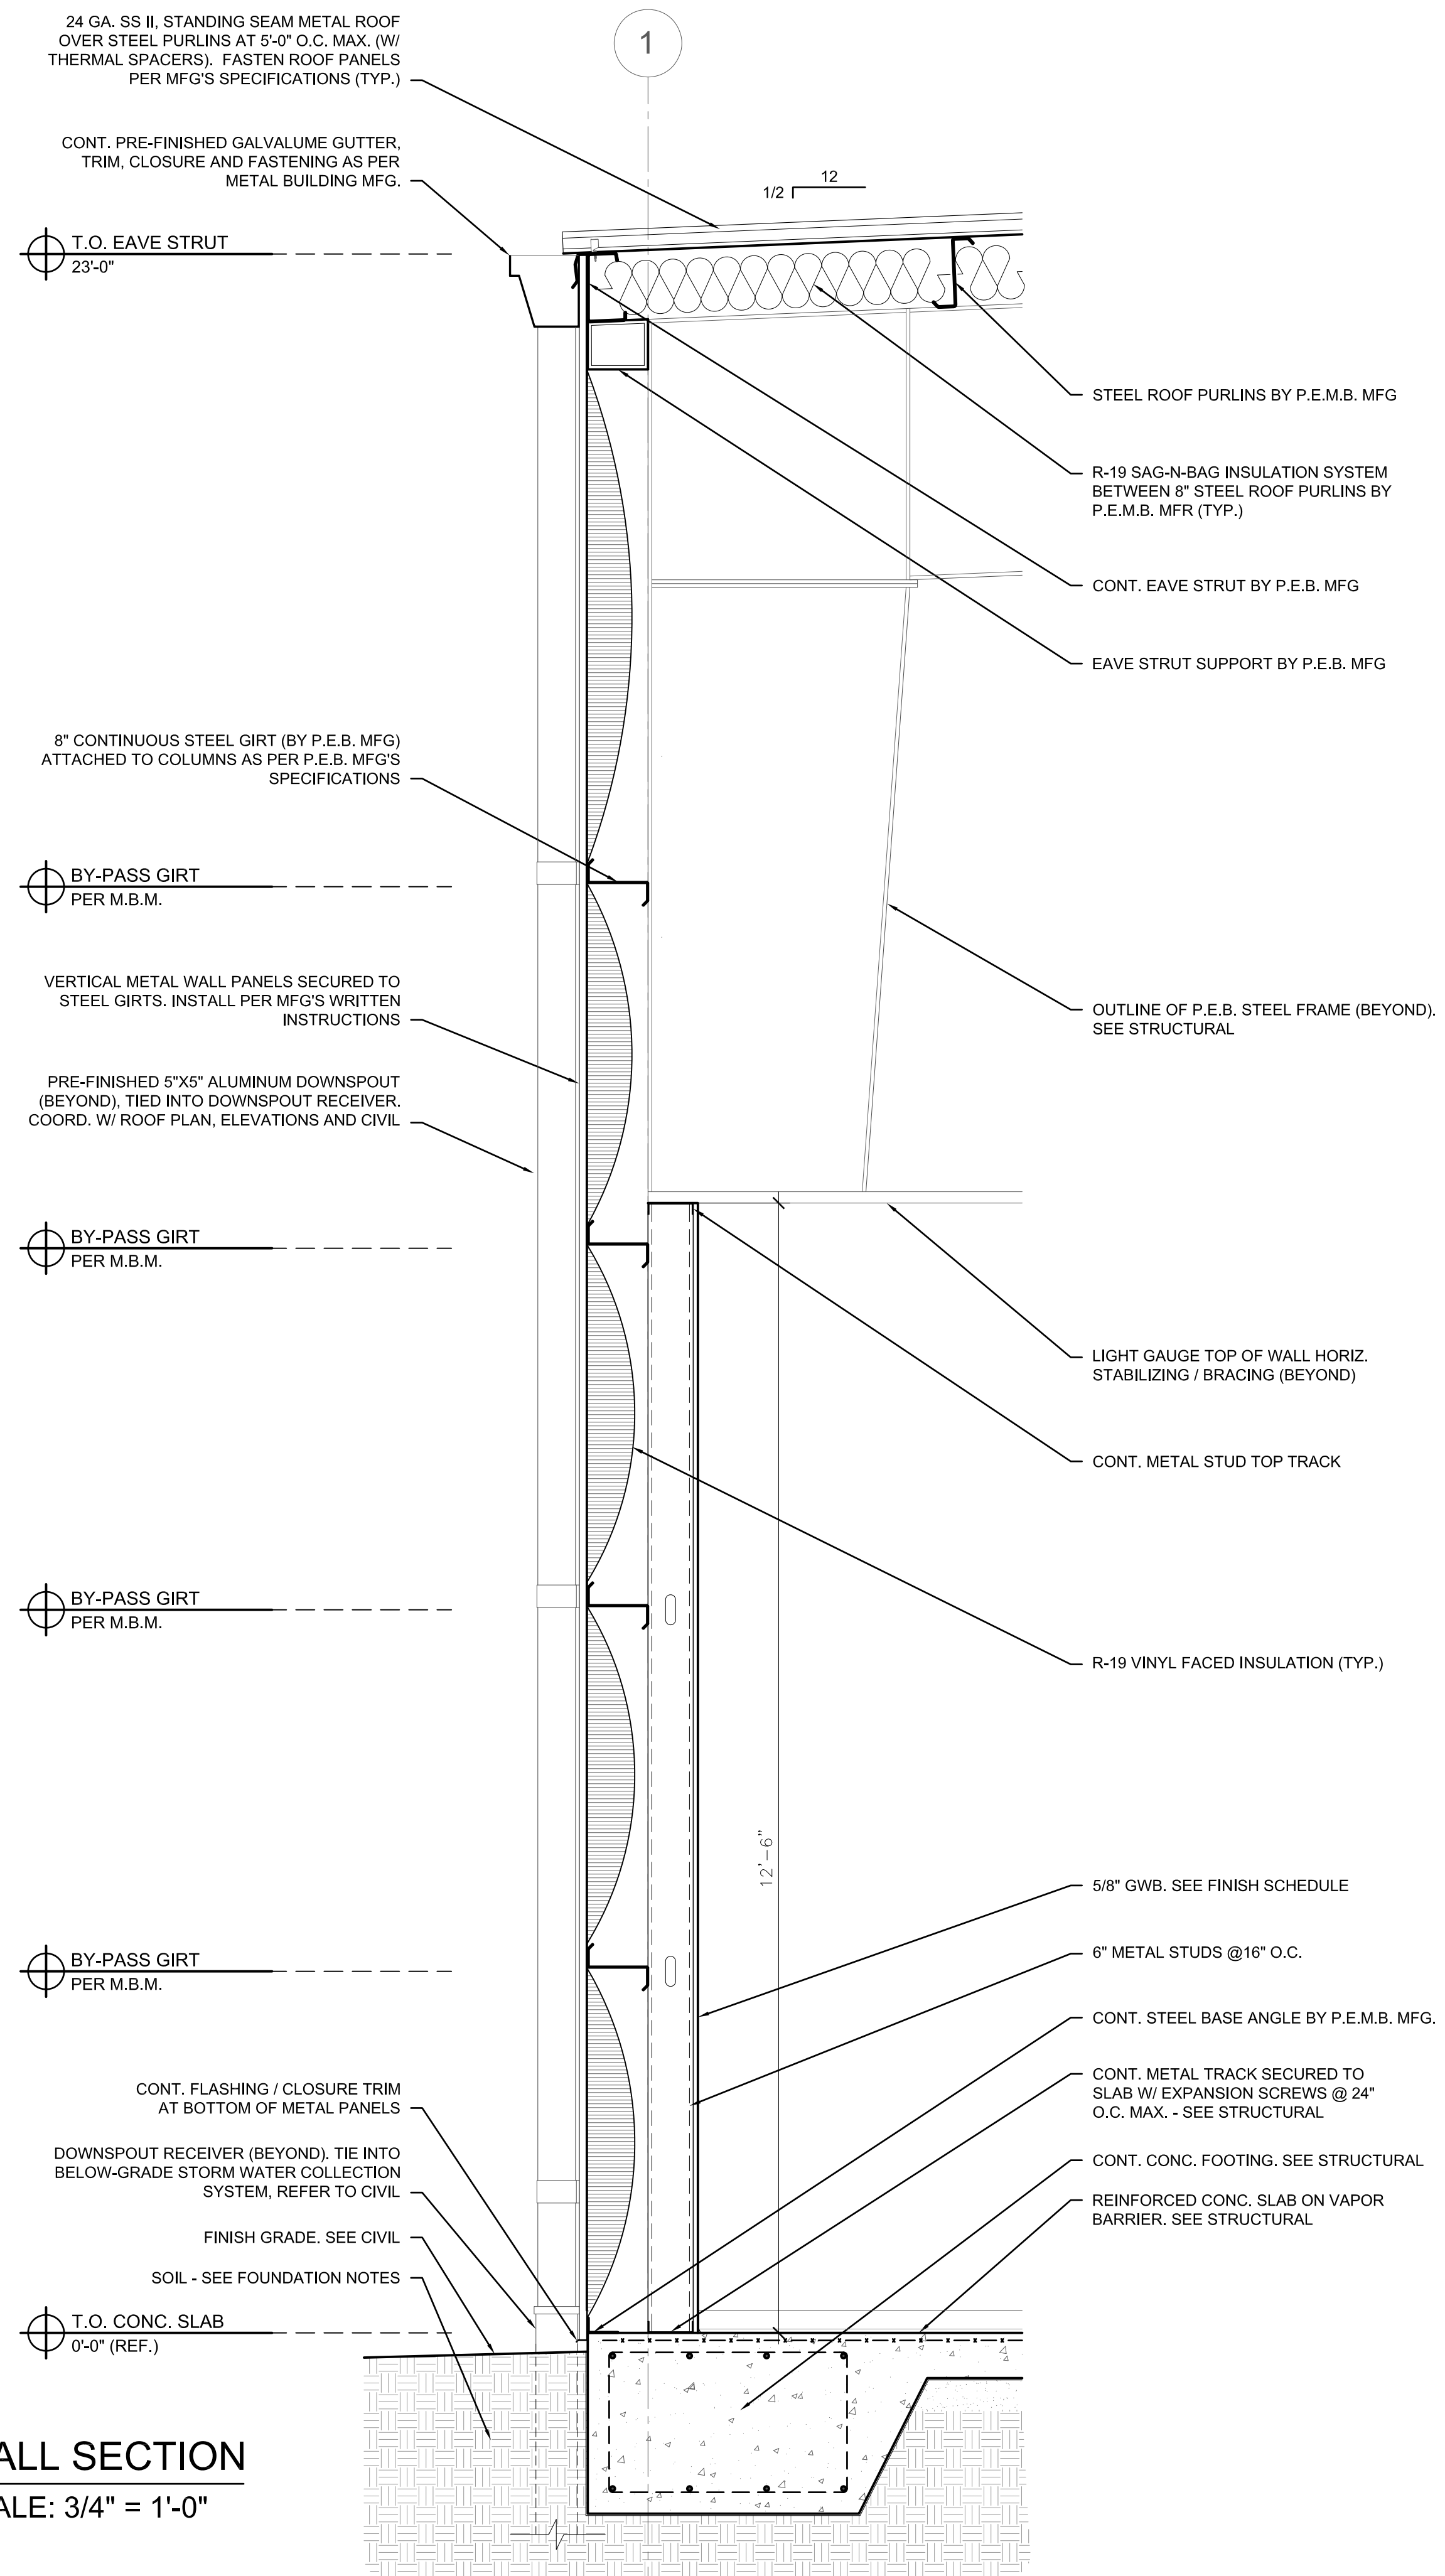

1 WALL SECTION
A4.4 SCALE: 3/4" = 1'-0"

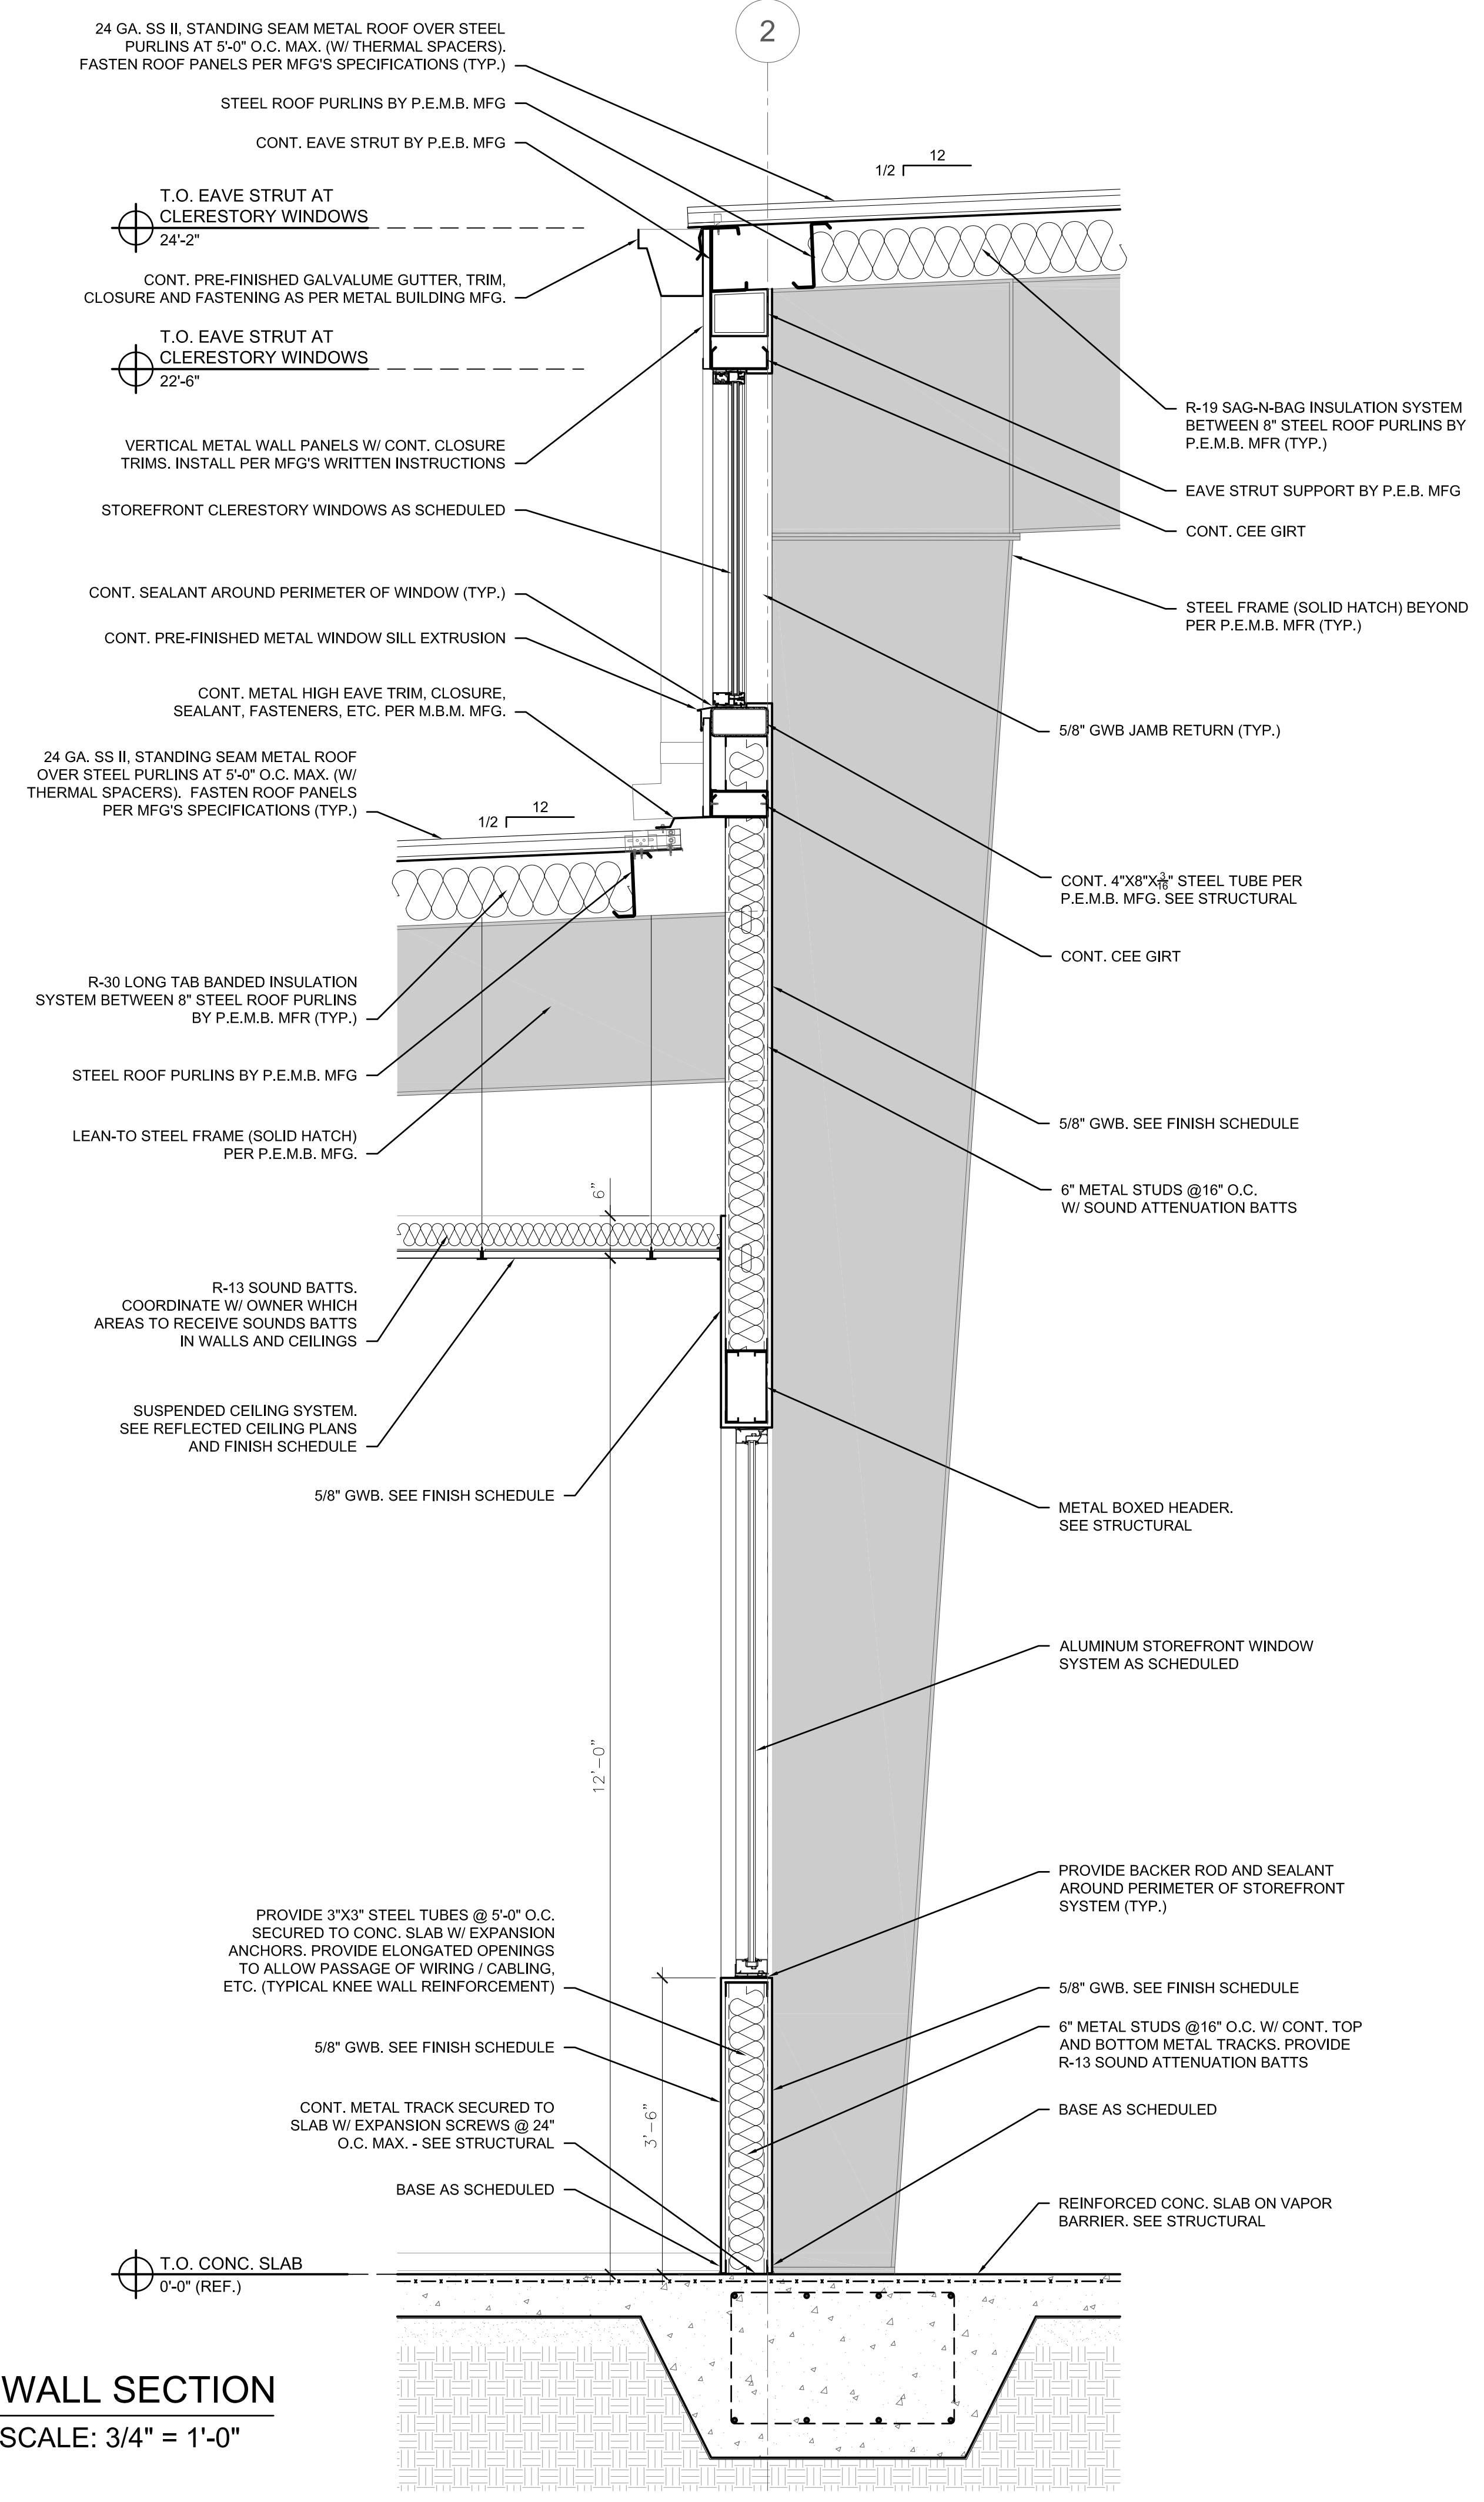

2 WALL SECTION
A4.4 SCALE: 3/4" = 1'-0"


CONN ARCHITECTS, INC. IS AN EQUAL OPPORTUNITY AFFIRMATIVE ACTION EMPLOYER. WE DO NOT DISCRIMINATE ON THE BASIS OF RACE, GENDER, RELIGION, NATIONAL ORIGIN, ANCESTRY, AGE, SEX, OR DISABILITY. ANY PART OF THESE DOCUMENTS MAY BE REPRODUCED, STORED IN A RETRIEVAL SYSTEM, OR TRANSMITTED IN ANY FORM OR BY ANY MEANS, ELECTRONIC, MECHANICAL, PHOTOCOPIING, RECORDING, OR OTHERWISE, WITHOUT THE PRIOR WRITTEN PERMISSION OF CONN ARCHITECTS, INC.

METAL FABRICATIONS NEW FACILITY
 4323 AVIATION AVENUE, TALLAHASSEE, FL 32310
WALL SECTIONS


CONN + ARCHITECTS
 1960-C Buford Boulevard Tallahassee, Florida 32308 | 850-878-9784
 www.connarchitects.com | Lic. No. AA-C011662

DATE	07-21-24
DRAWN BY	DBC
REVISED	
DATE	
JOB NO.	23-208
DATE	
SHEET NUMBER	A4.4


PRICING SET - NOT FOR CONSTRUCTION

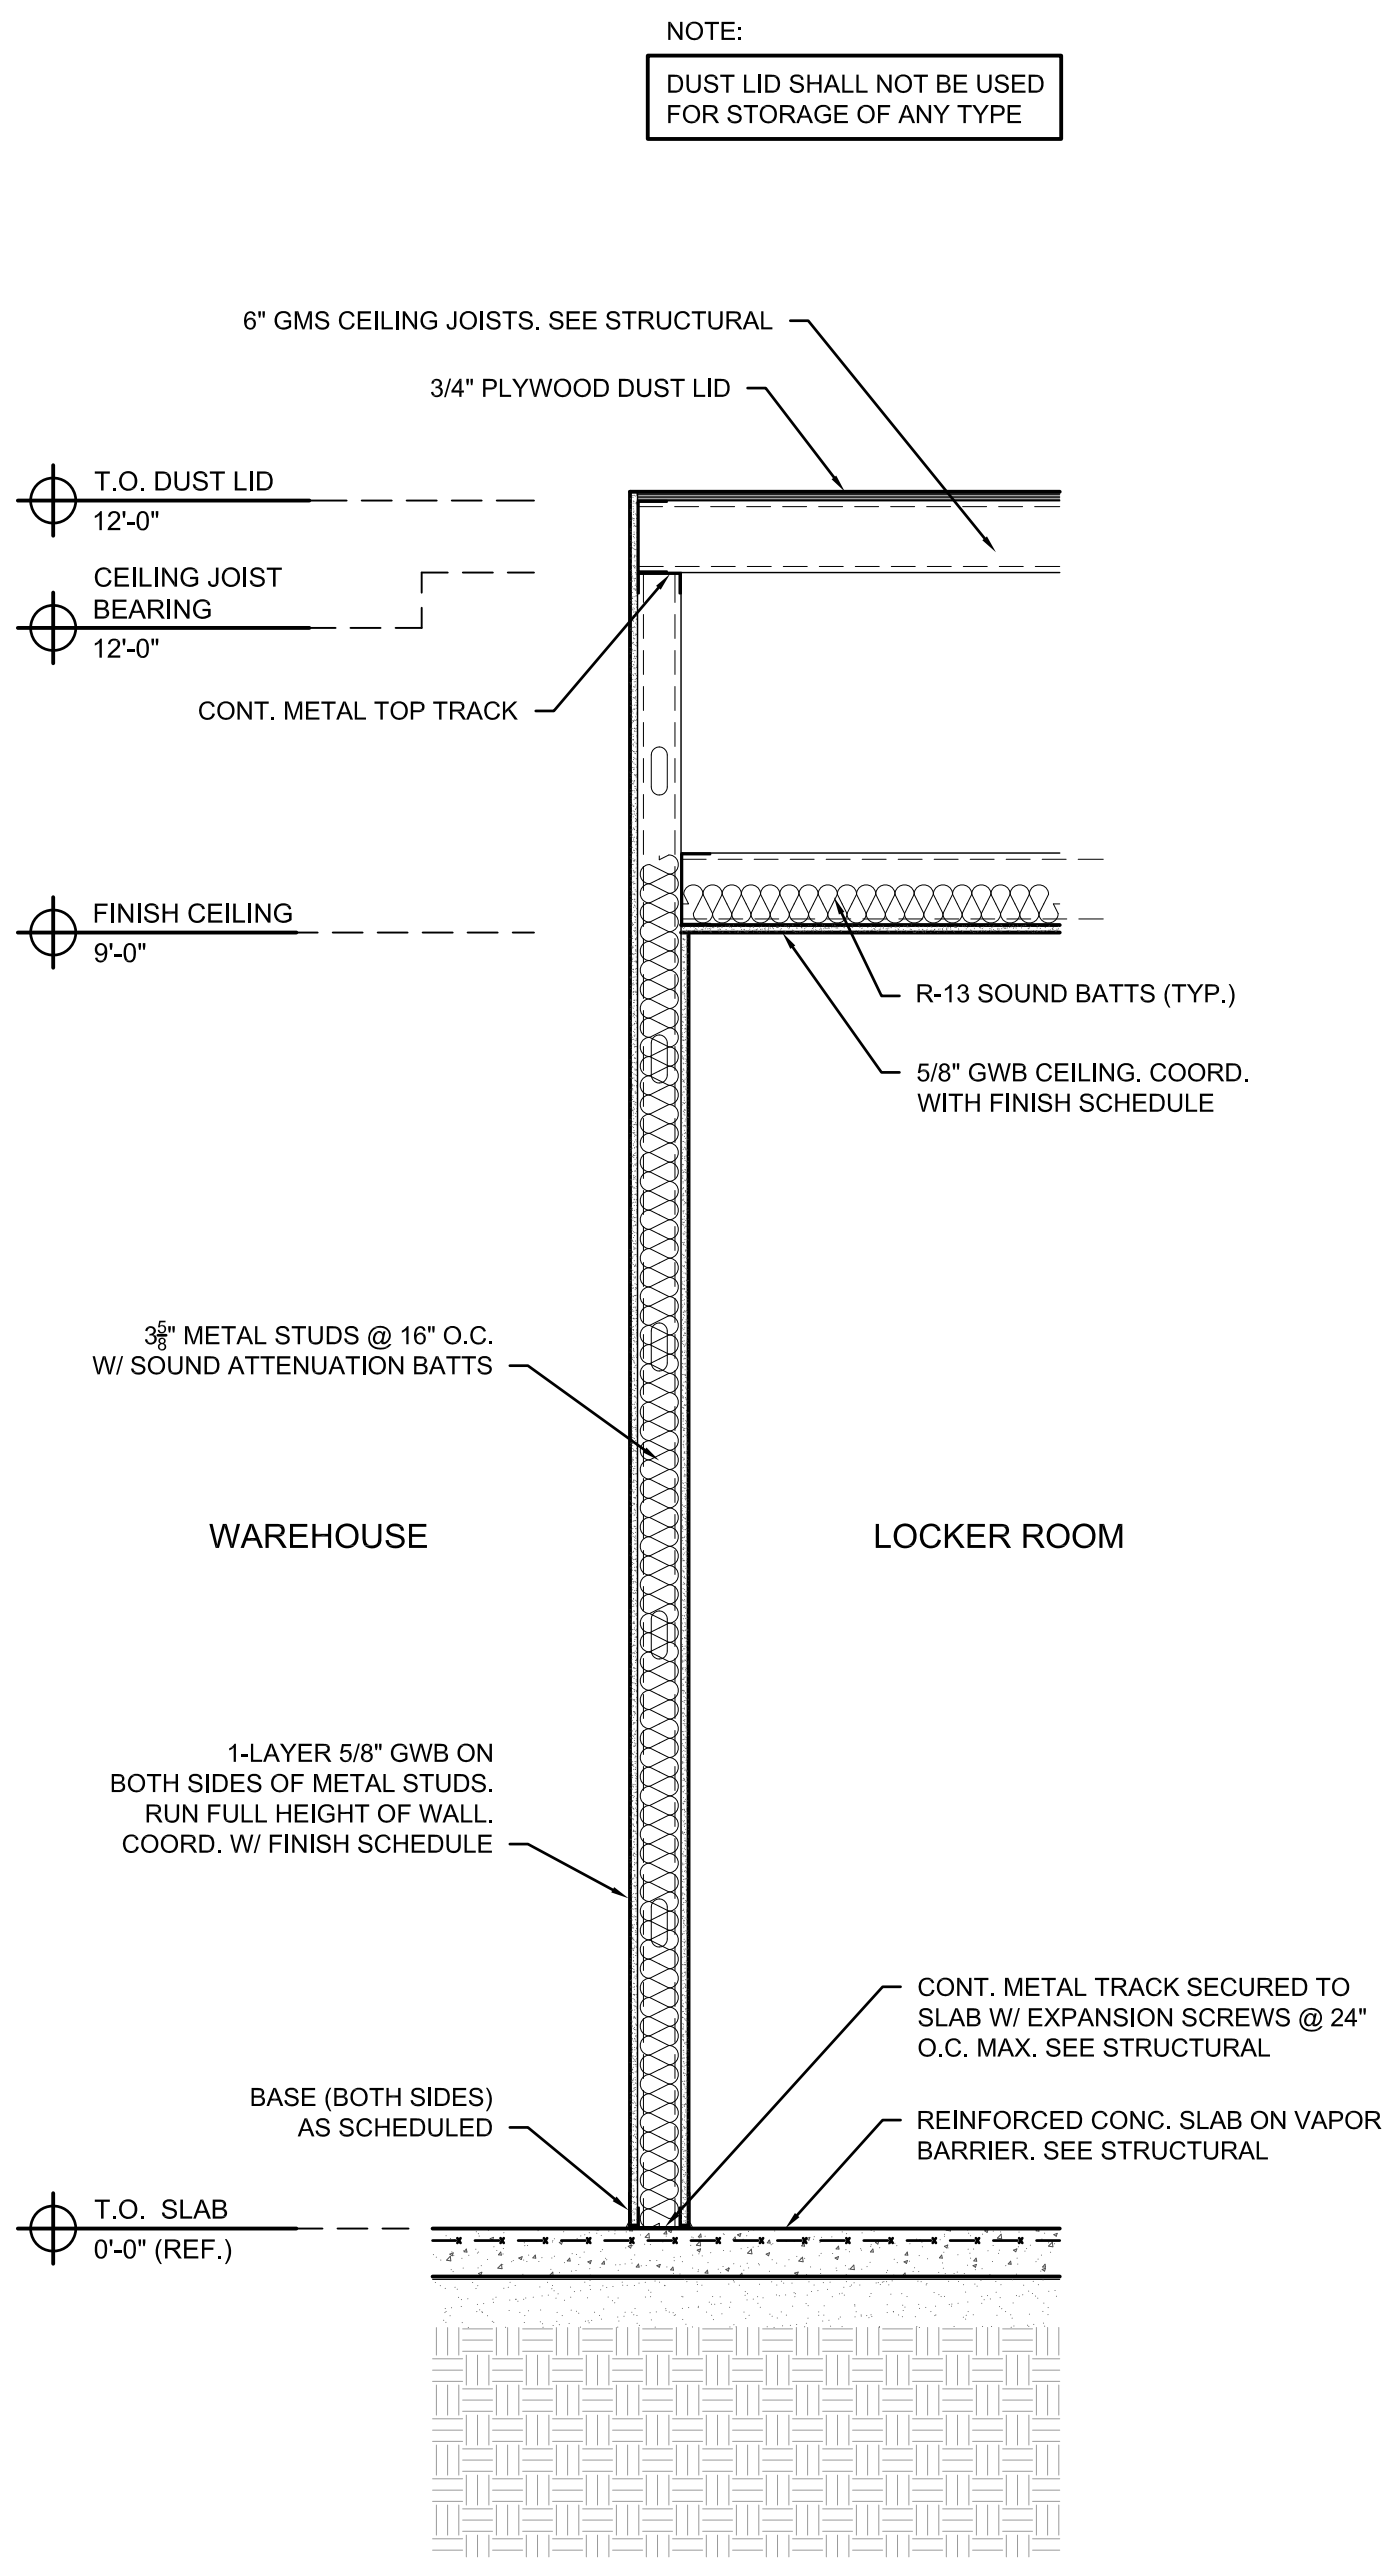


1 WALL SECTION
A4.5 SCALE: 3/4" = 1'-0"

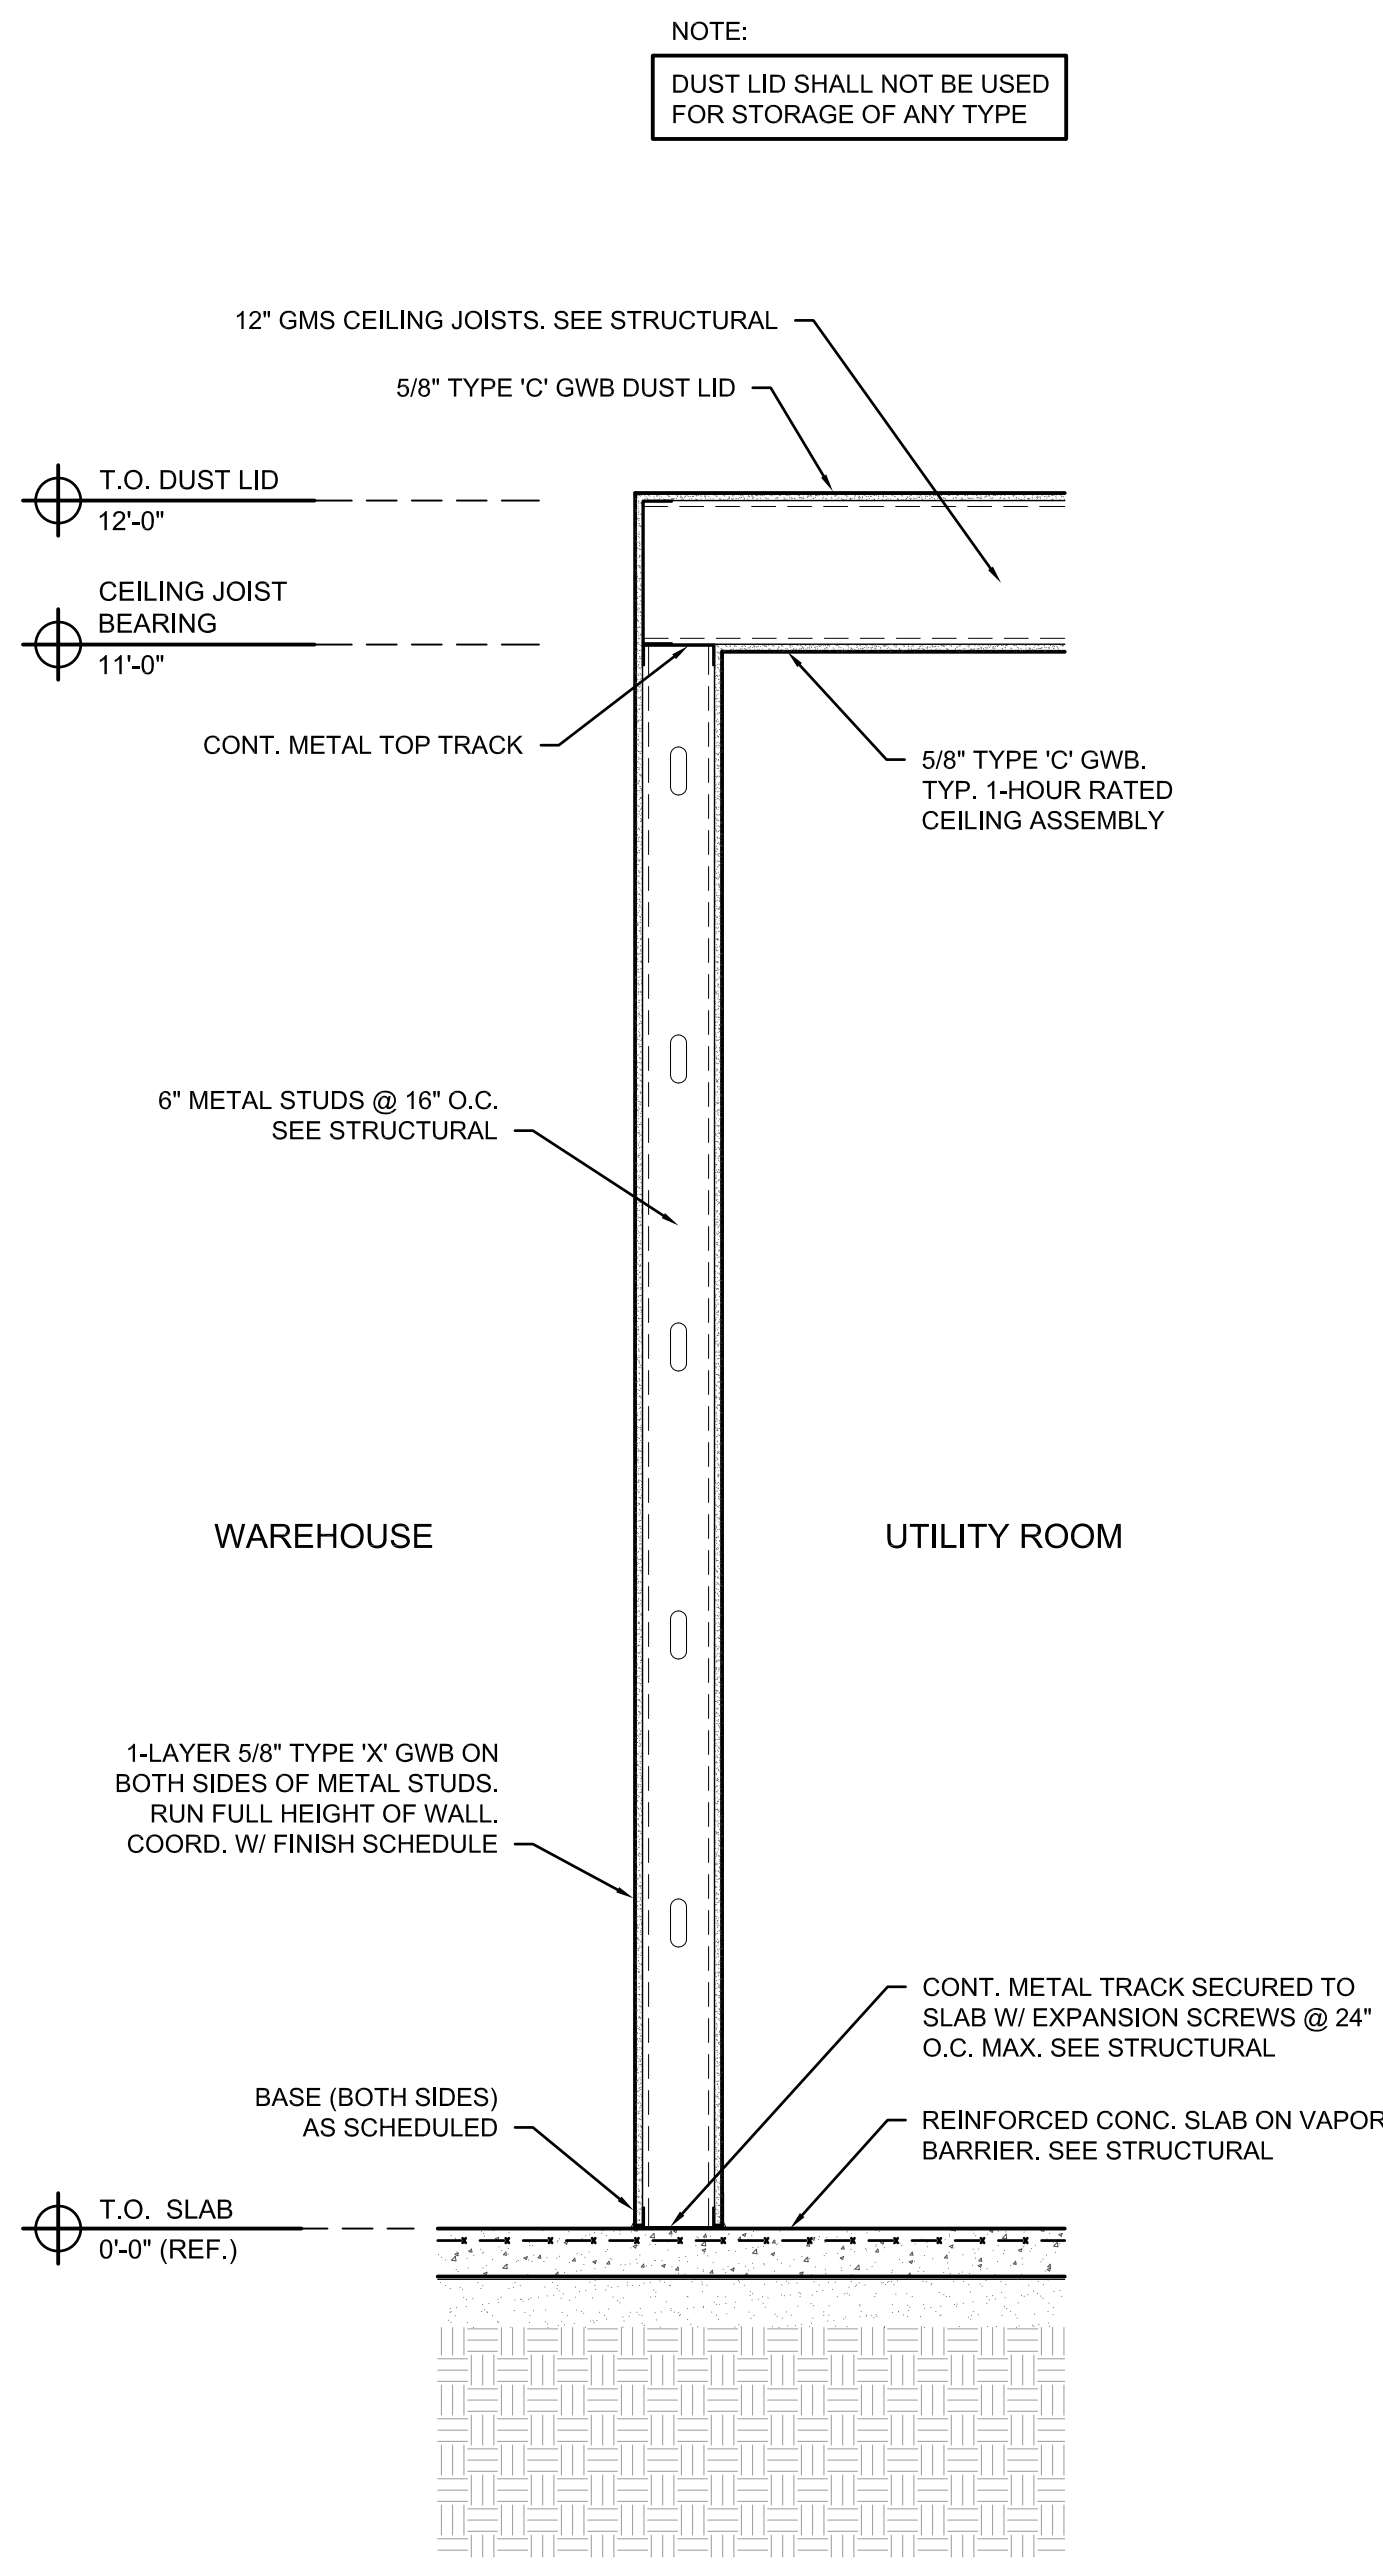

2 WALL SECTION
A4.5 SCALE: 3/4" = 1'-0"

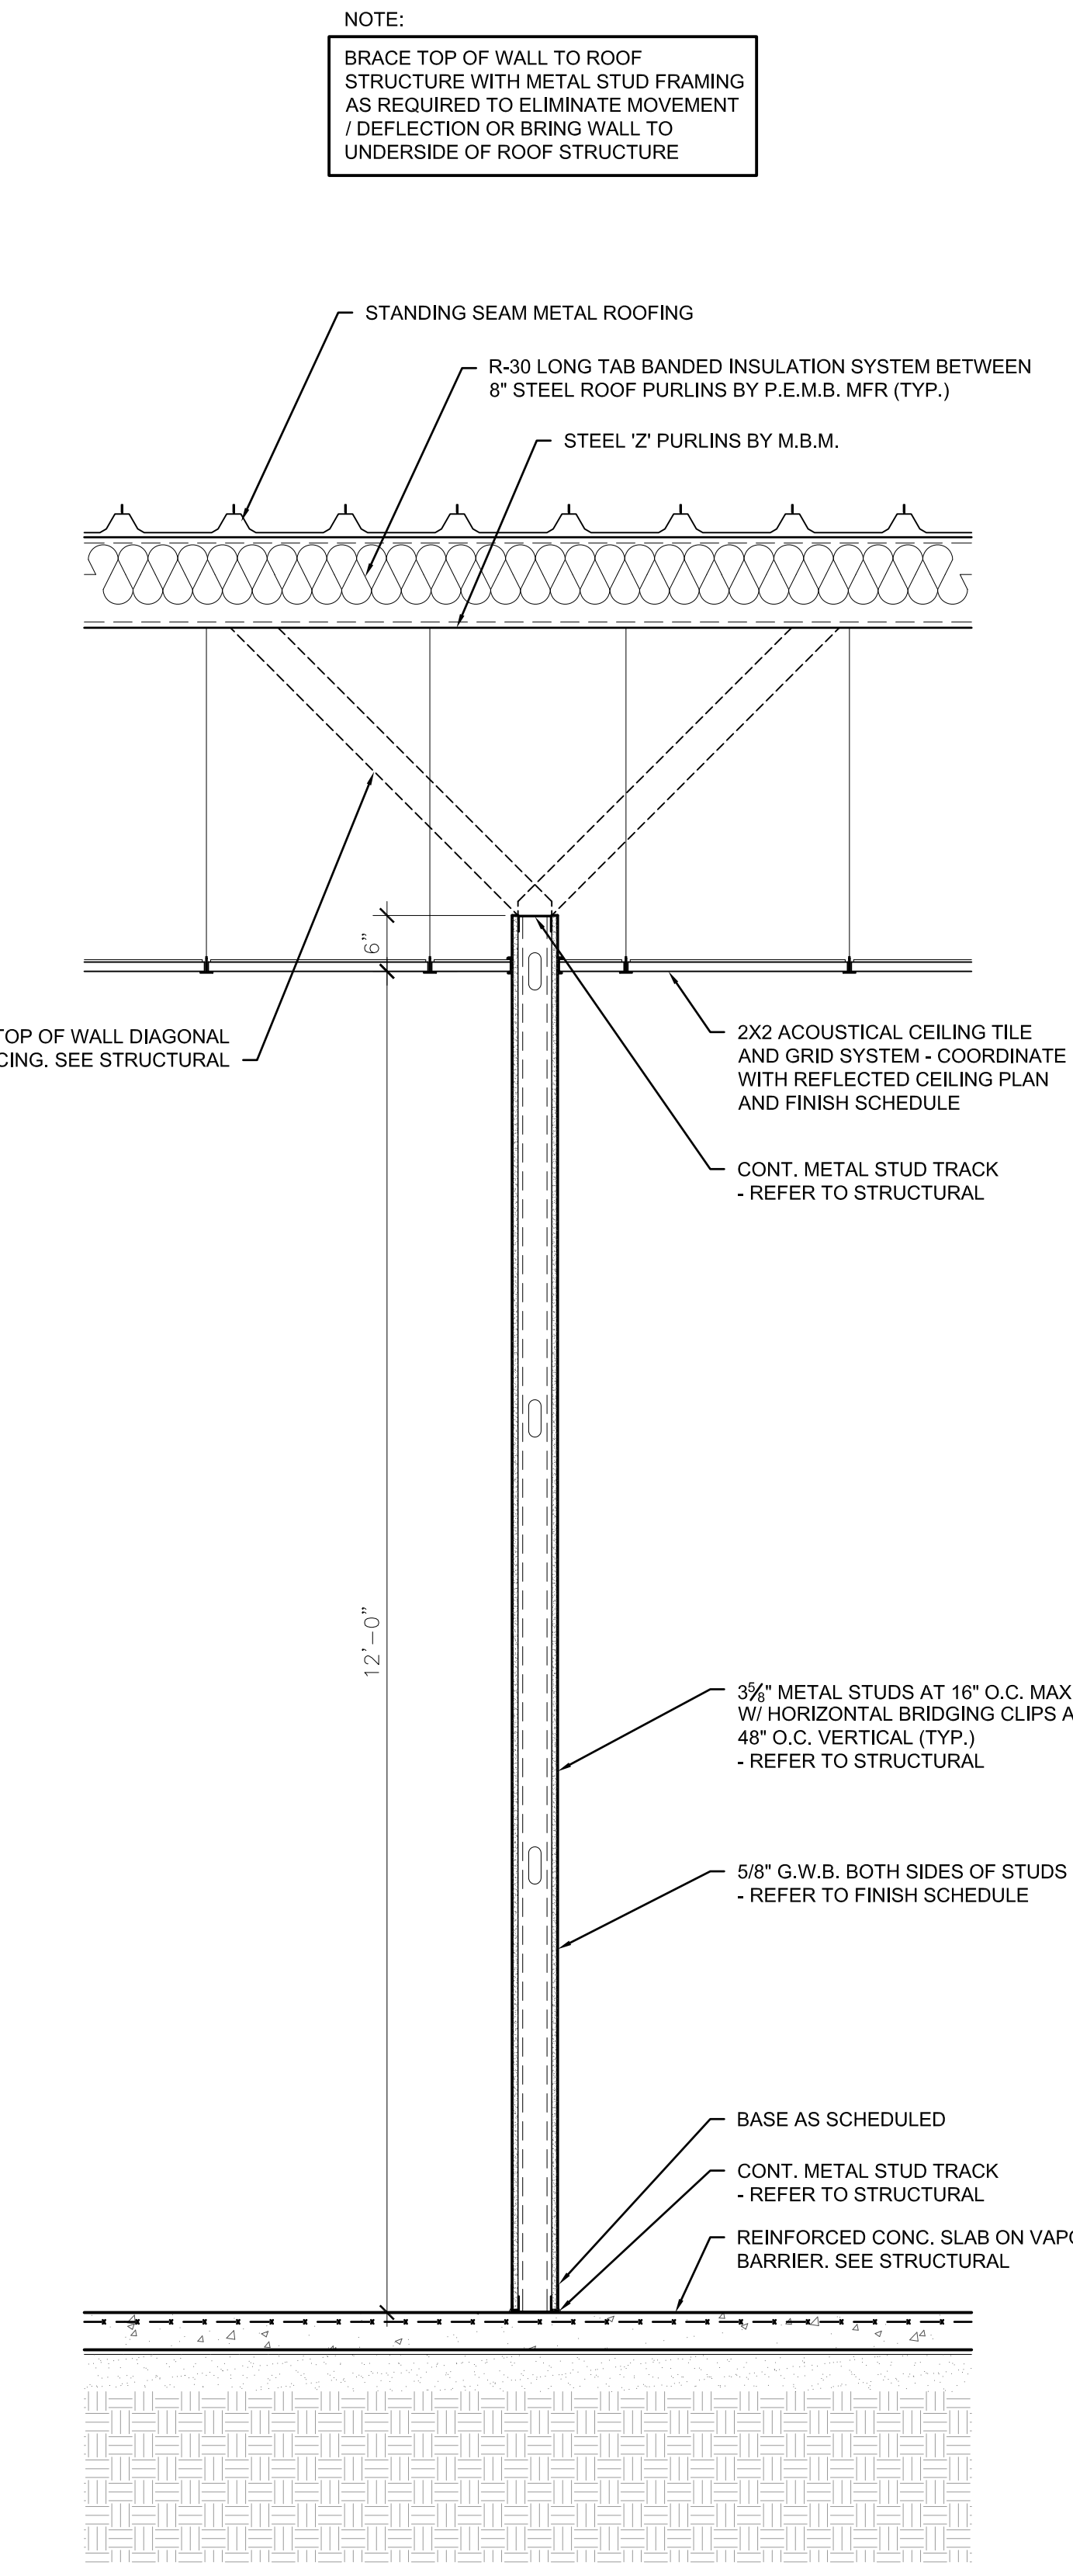

3 WALL SECTION
A4.5 SCALE: 3/4" = 1'-0"

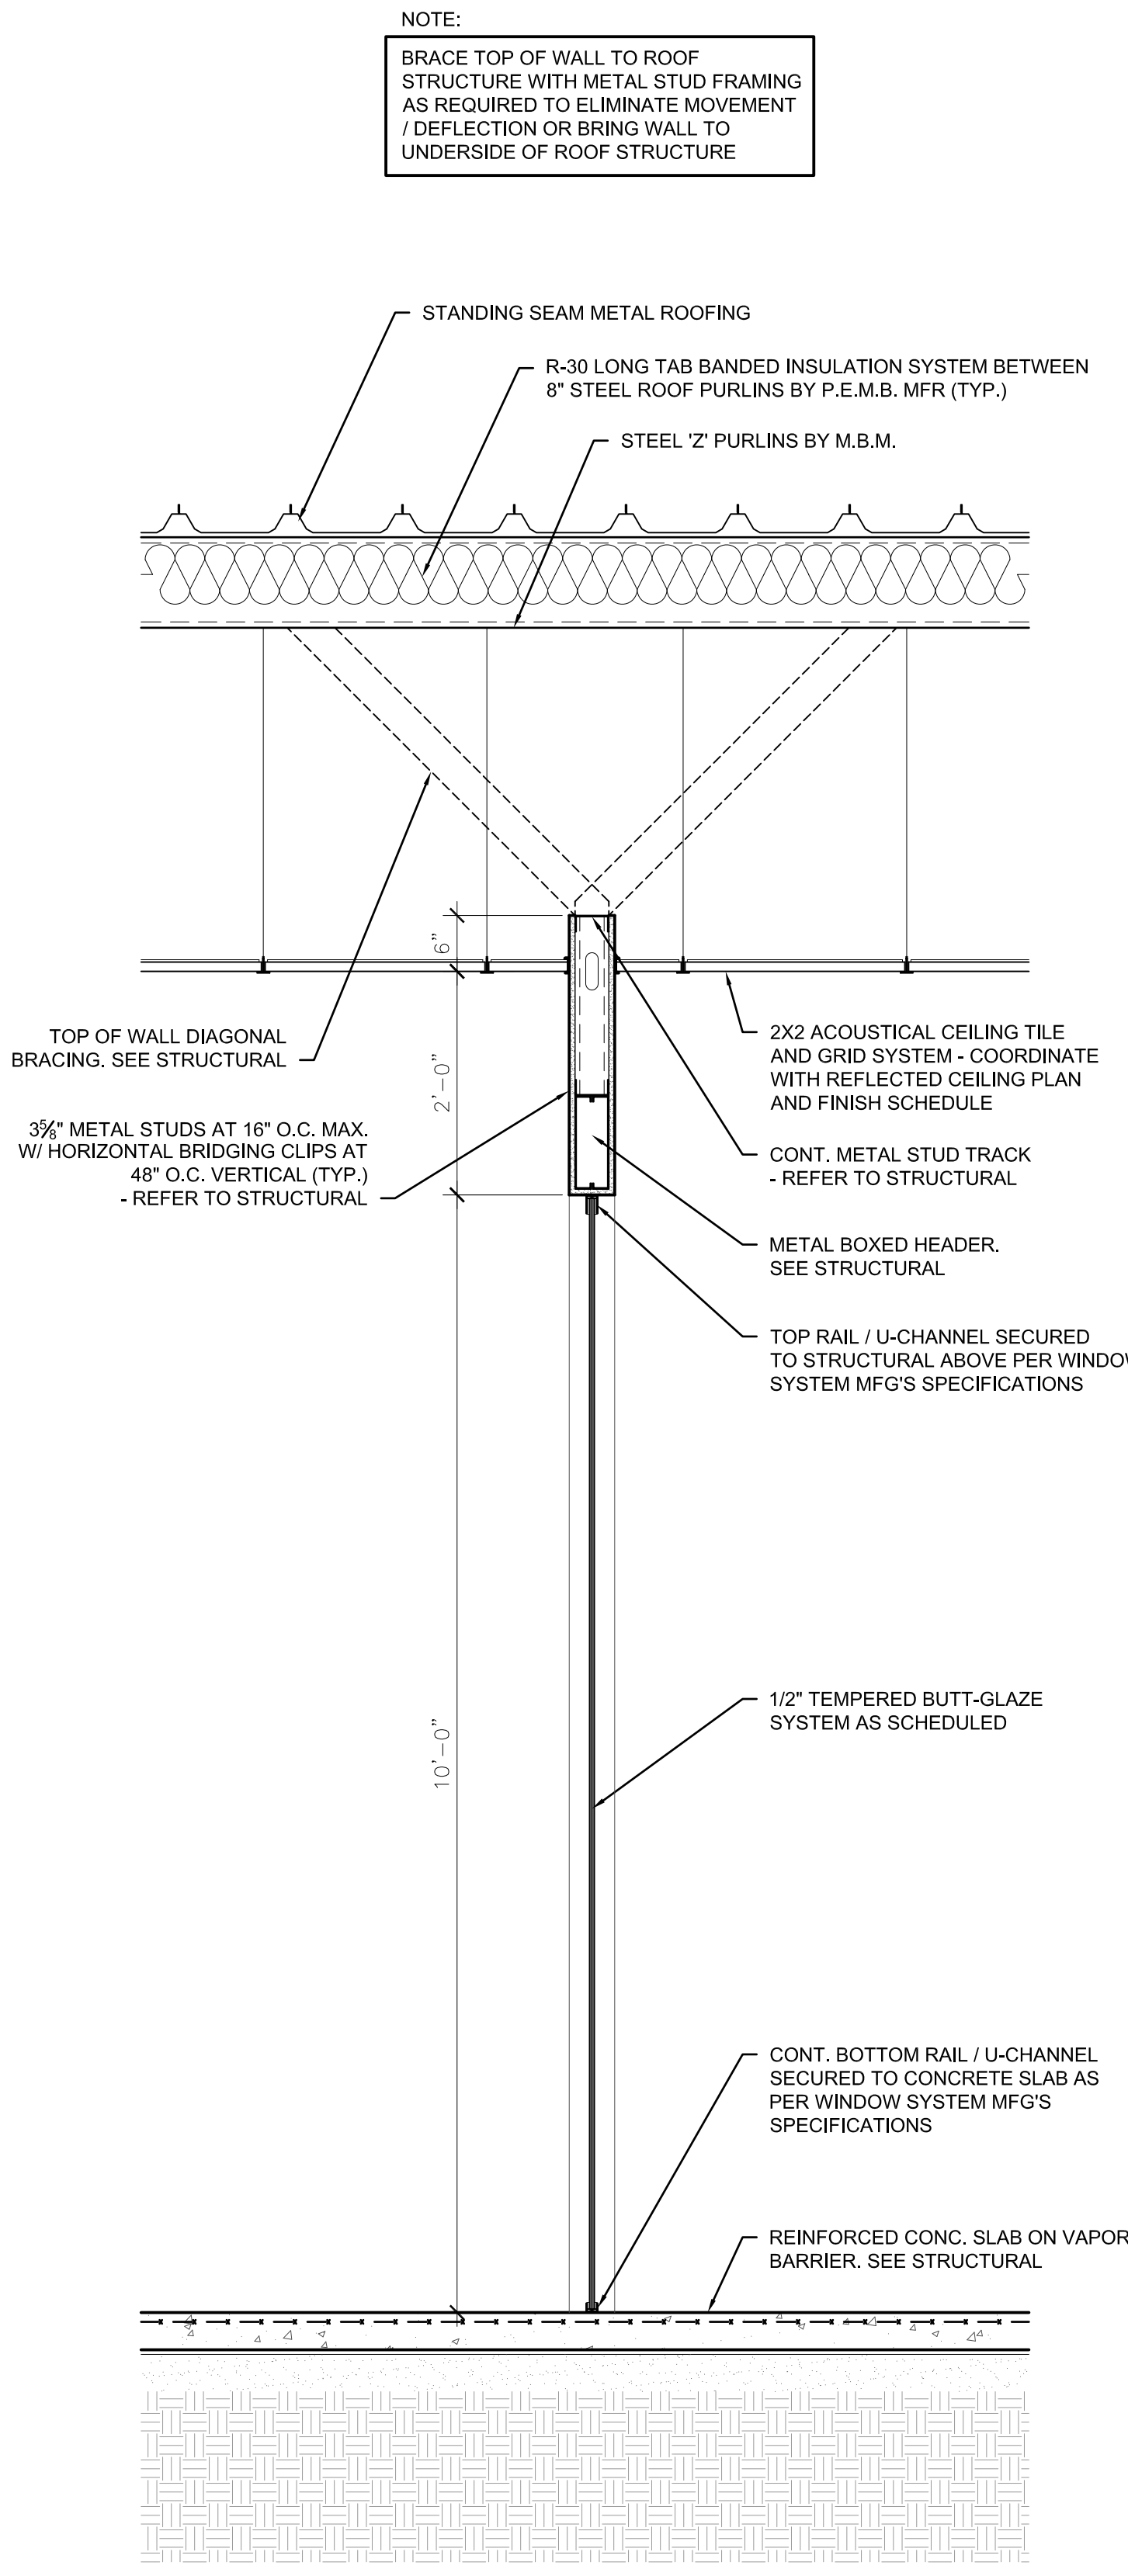

4 WALL SECTION
A4.5 SCALE: 3/4" = 1'-0"

NOTE:
DUST LID SHALL NOT BE USED FOR STORAGE OF ANY TYPE

NOTE:
DUST LID SHALL NOT BE USED FOR STORAGE OF ANY TYPE

NOTE:
BRACE TOP OF WALL TO ROOF STRUCTURE WITH METAL STUD FRAMING AS REQUIRED TO ELIMINATE MOVEMENT / DEFLECTION OR BRING WALL TO UNDERSIDE OF ROOF STRUCTURE

NOTE:
BRACE TOP OF WALL TO ROOF STRUCTURE WITH METAL STUD FRAMING AS REQUIRED TO ELIMINATE MOVEMENT / DEFLECTION OR BRING WALL TO UNDERSIDE OF ROOF STRUCTURE

CONN + ARCHITECTS, INC. IS AN EQUAL OPPORTUNITY AFFIRMATIVE ACTION EMPLOYER. WE DO NOT DISCRIMINATE ON THE BASIS OF RACE, GENDER, RELIGION, NATIONAL ORIGIN, ANCESTRY, COLOR, SEX, AGE, SEXUAL ORIENTATION, OR DISABILITY. ANY PART OF THESE DOCUMENTS MAY BE REPRODUCED, STORED IN A RETRIEVAL SYSTEM, OR TRANSMITTED IN ANY FORM OR BY ANY MEANS, ELECTRONIC, MECHANICAL, PHOTOCOPIING, RECORDING, OR OTHERWISE, WITHOUT THE PRIOR WRITTEN PERMISSION OF CONN + ARCHITECTS, INC.

METAL FABRICATIONS NEW FACILITY
 4323 AVIATION AVENUE, TALLAHASSEE, FL 32310

CONN + ARCHITECTS
 1960-C Buford Boulevard Tallahassee, Florida 32308 | 850-878-9784
 www.CONNarchitects.com | Lic. No. AA-C001662

DATE	07-21-24
DRAWN BY	DBC
REVISIONS	
JOB NO.	23-208
DATE	
SHEET NUMBER	A4.5


PRICING SET - NOT FOR CONSTRUCTION

WALL SECTIONS

DATE	07-21-24
DRAWN BY	DBC
REVISED	
DATE	
SHEET NUMBER	23-208
DATE	
SHEET NUMBER	A4.6

CONN ARCHITECTS, INC. IS AN EQUAL OPPORTUNITY AFFIRMATIVE ACTION EMPLOYER. WE DO NOT DISCRIMINATE ON THE BASIS OF RACE, GENDER, RELIGION, NATIONAL ORIGIN, ANCESTRY, AGE, SEX, OR DISABILITY. ANY REPRODUCTION OF THESE DOCUMENTS WITHOUT THE WRITTEN PERMISSION OF CONN ARCHITECTS, INC. IS PROHIBITED.


1 WALL SECTION
 A4.6 SCALE: 3/4" = 1'-0"

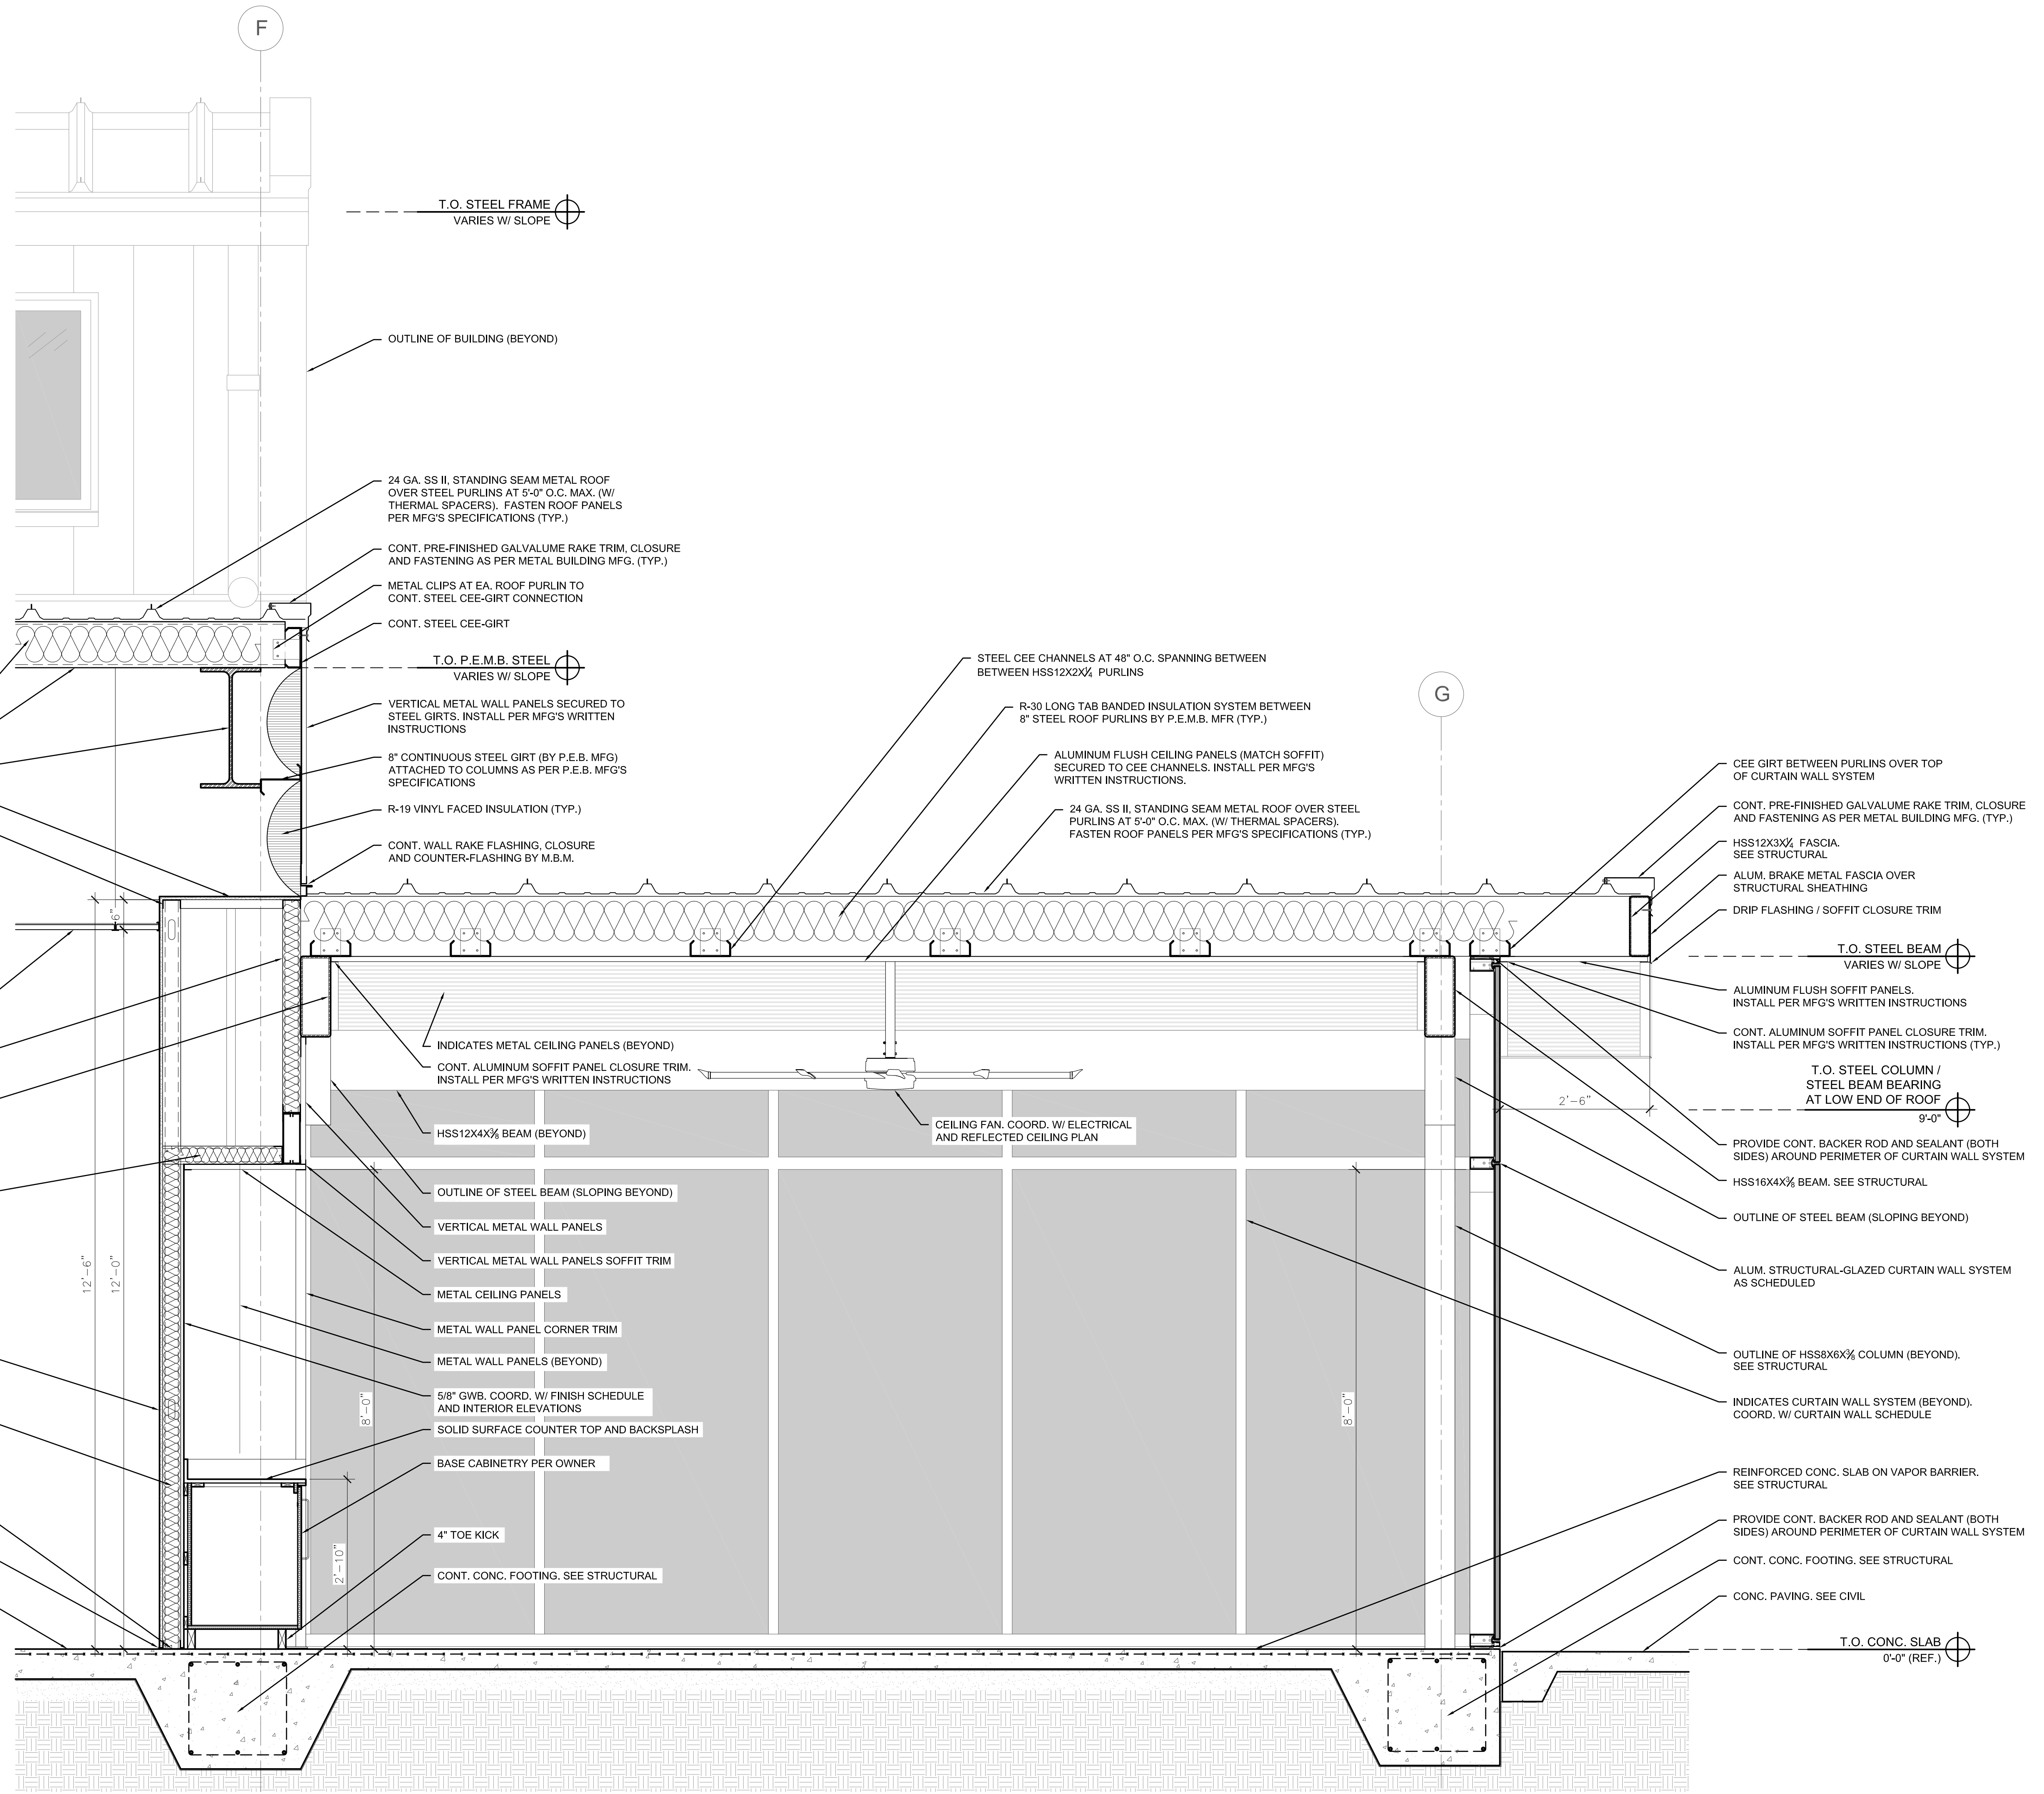


PRICING SET - NOT FOR CONSTRUCTION

DATE	07-21-24
DRAWN BY	DBC
REVISED	
JOB NO.	23-208
DATE	
SHEET NUMBER	A4.7

PRICING SET - NOT FOR CONSTRUCTION

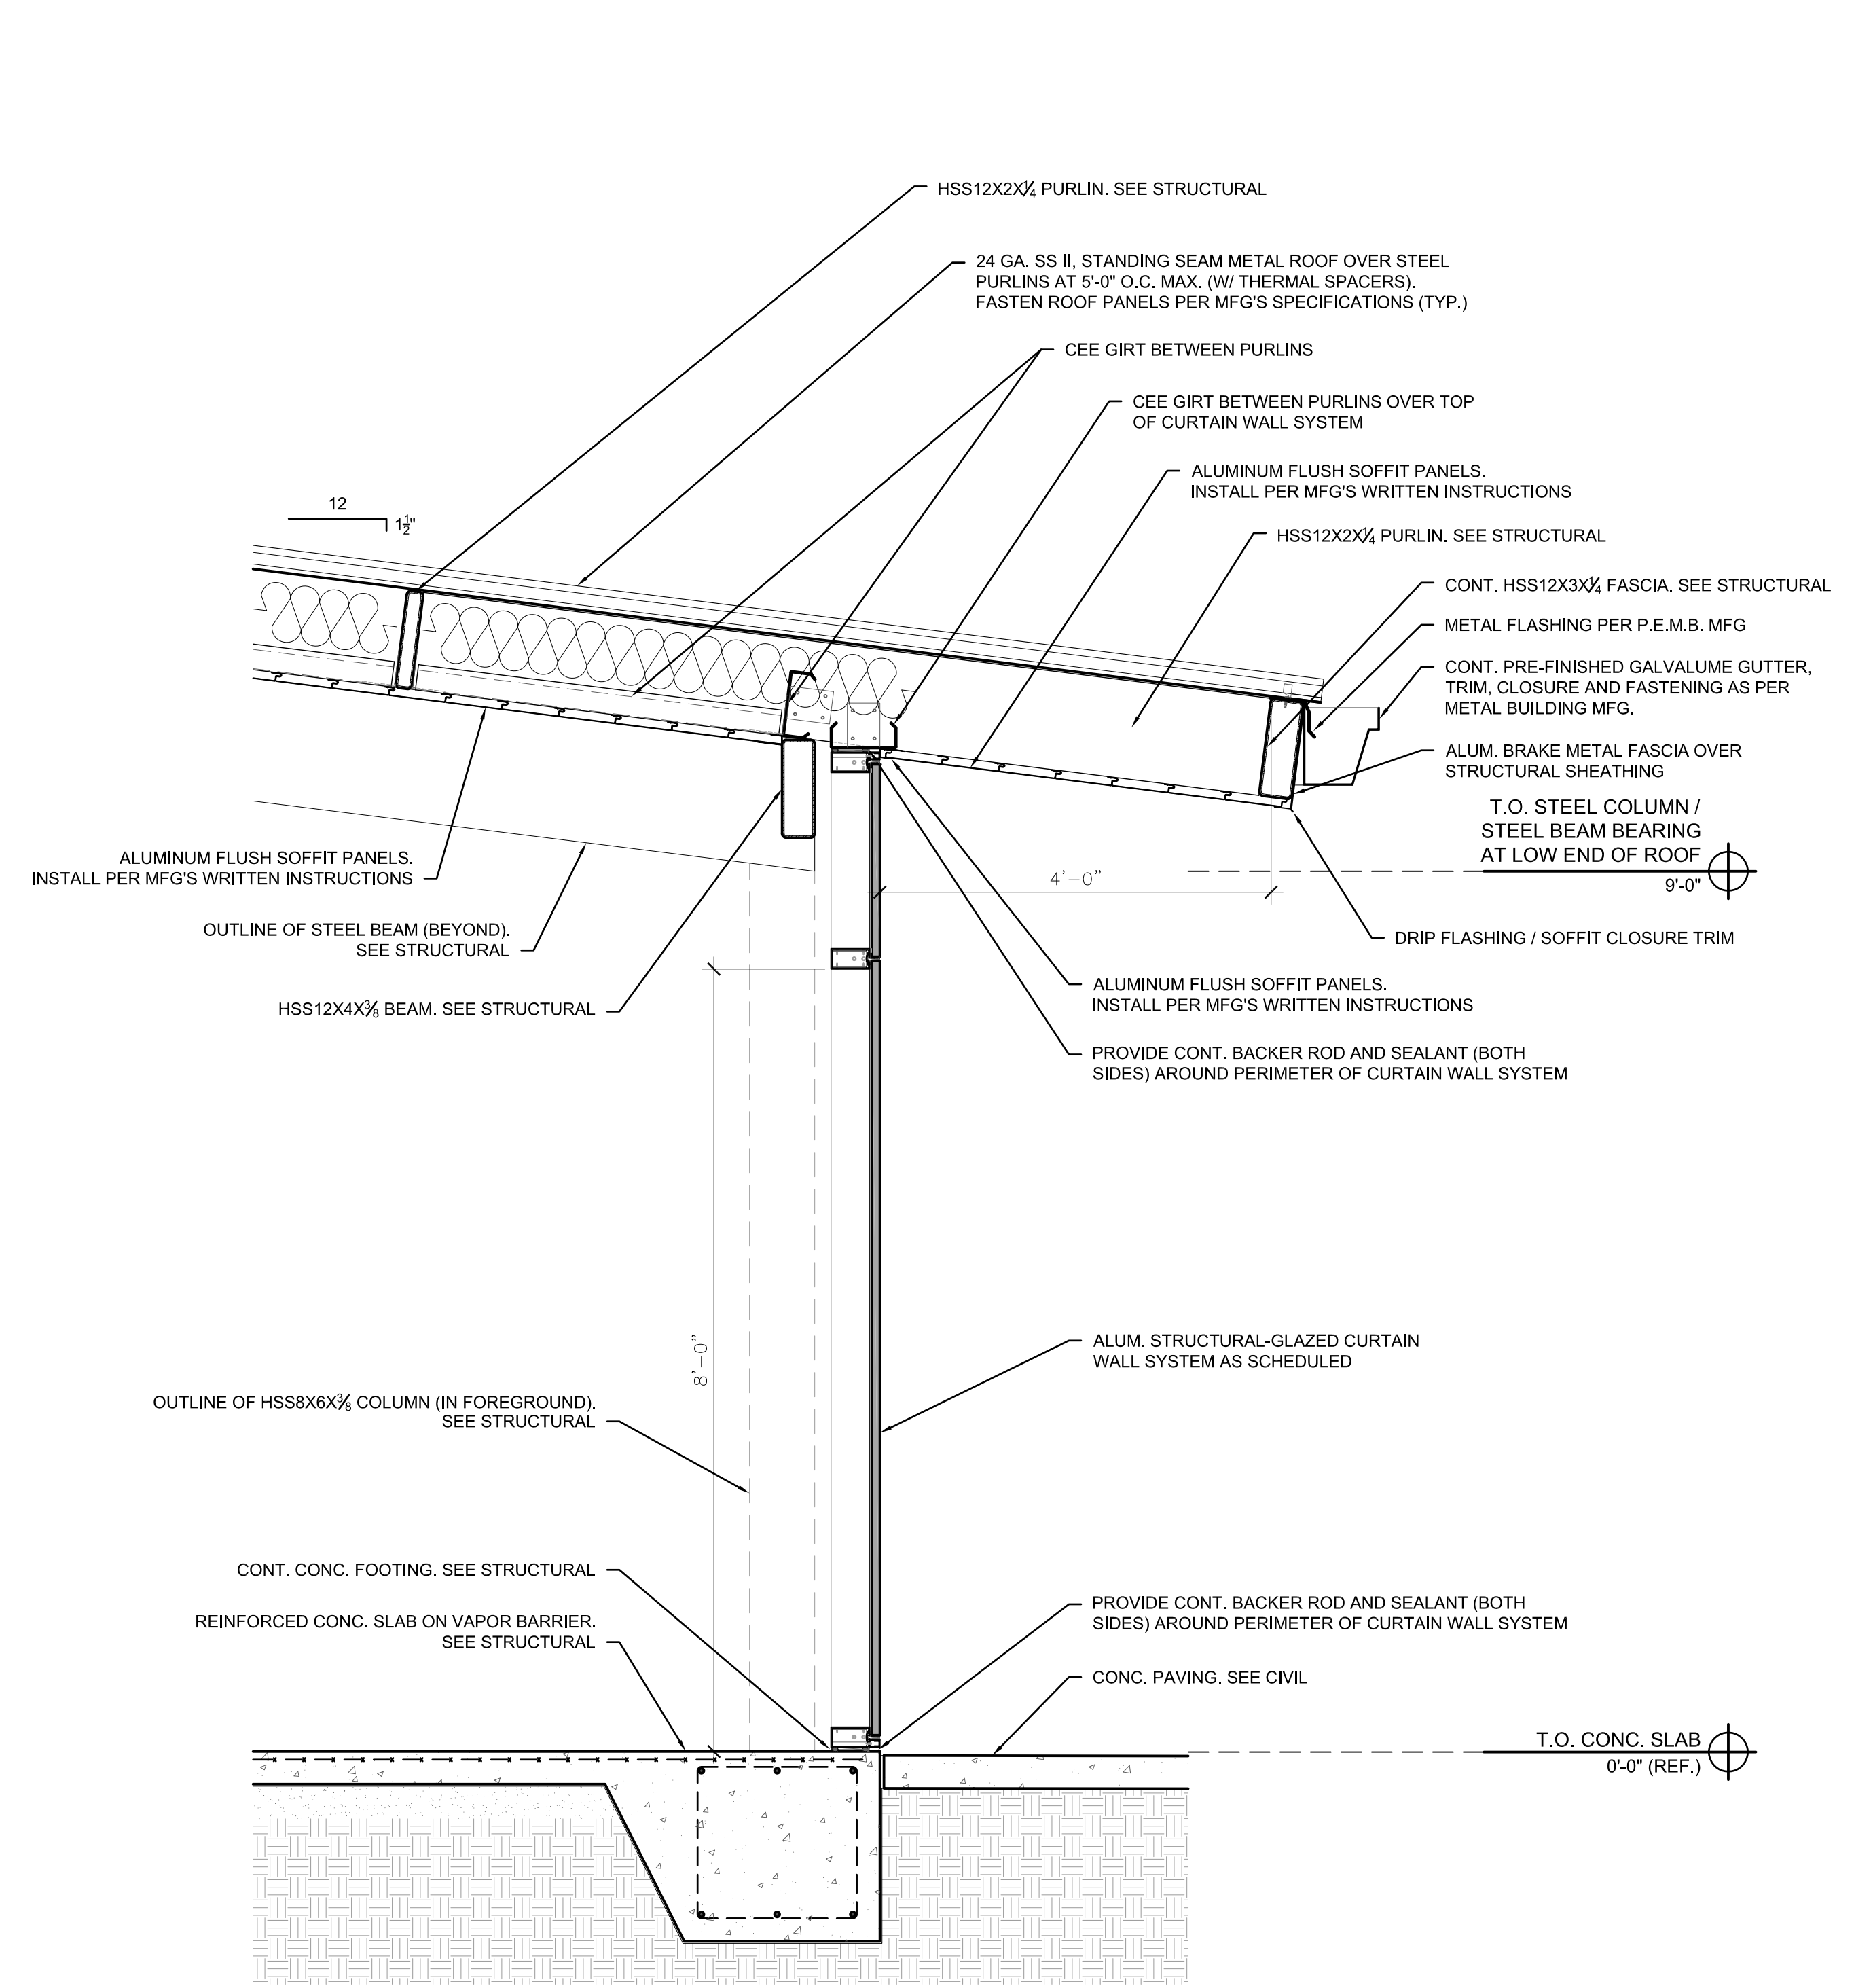

2 WALL SECTION
 A4.7 SCALE: 3/4" = 1'-0"

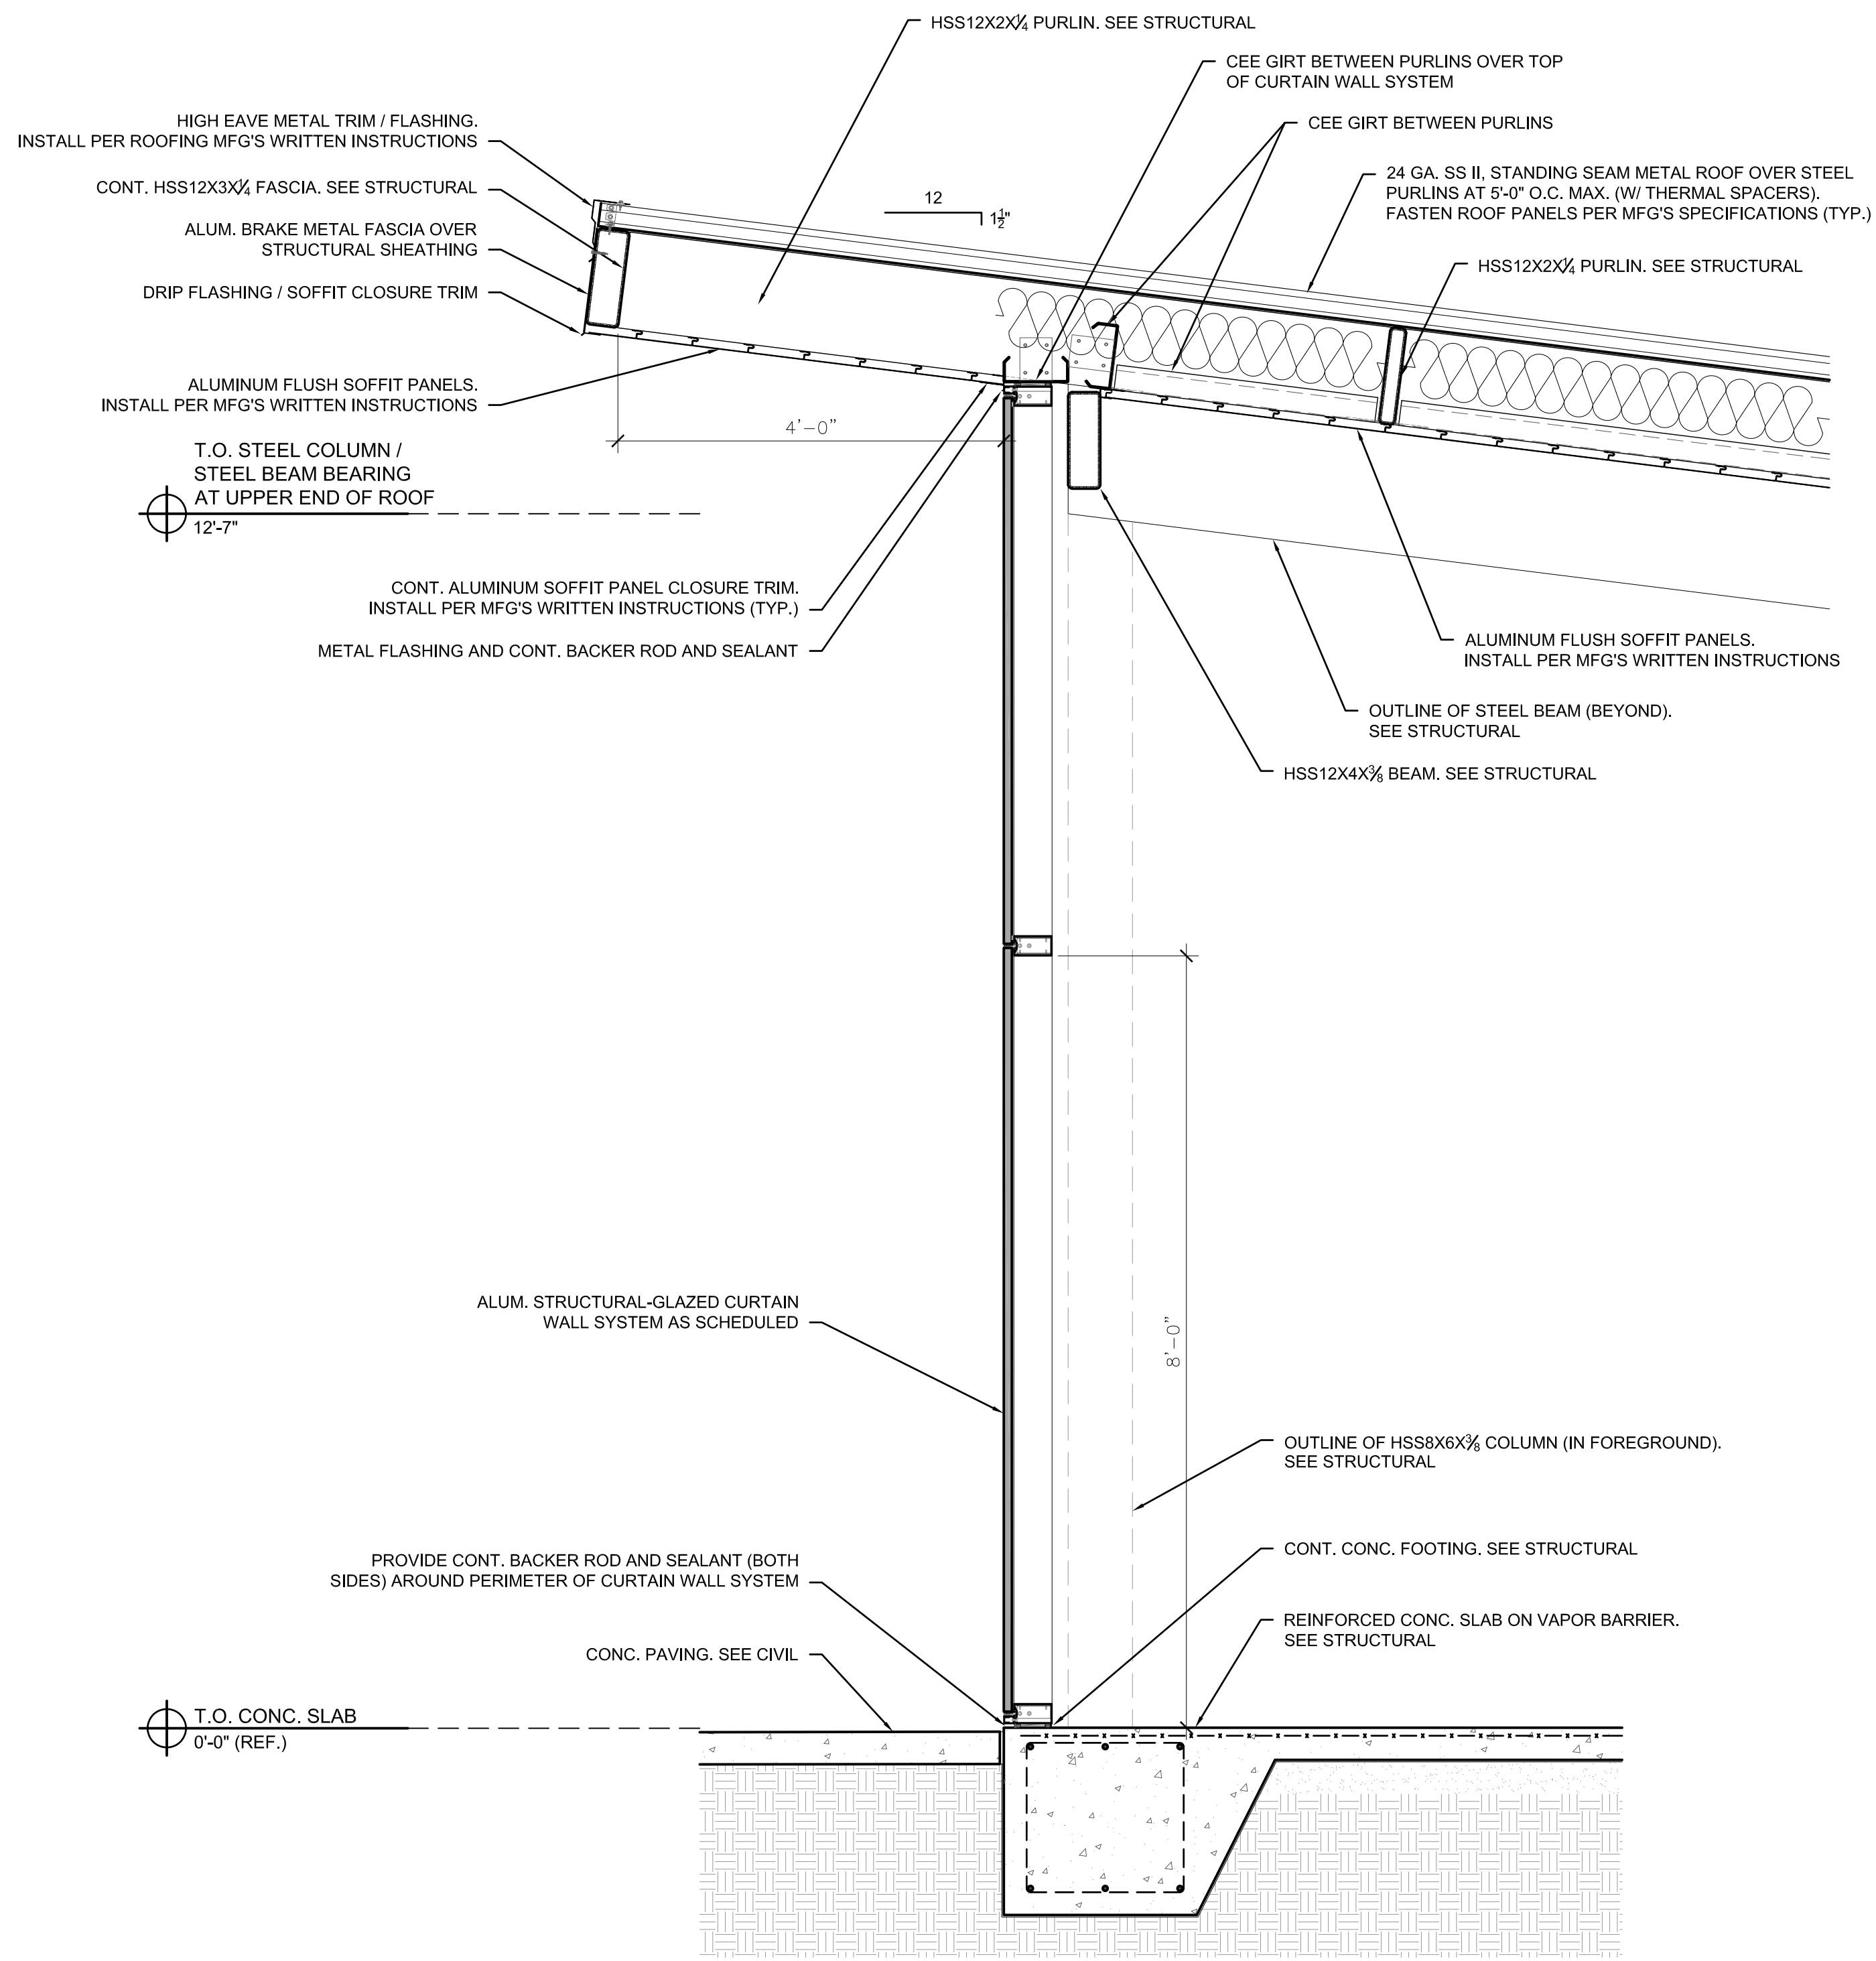

1 WALL SECTION
 A4.7 SCALE: 3/4" = 1'-0"


CONNECTIONS TO EXISTING STRUCTURE SHALL BE AS SHOWN. ALL DIMENSIONS ARE TO FACE UNLESS OTHERWISE NOTED. THIS DRAWING IS THE PROPERTY OF CONN + ARCHITECTS. ANY REPRODUCTION OR TRANSMISSION OF THIS DOCUMENT IN ANY FORM OR BY ANY MEANS, ELECTRONIC, MECHANICAL, PHOTOCOPIING, RECORDING, OR OTHERWISE, WITHOUT THE PRIOR WRITTEN PERMISSION OF CONN + ARCHITECTS, INC. IS PROHIBITED.

SINGLE PLY, FULLY ADHERED, 60 MIL. T.P.O. ROOFING W/ CONT. DRIP ON ALUMINUM CLEATS OVER TAPERED RIGID ISO INSULATION OVER STRUCTURAL PLYWOOD SHEATHING. INSTALL ROOFING COMPONENTS AS PER ROOF MFG'S WRITTEN INSTRUCTIONS (TYP.)

CONT. METAL DRIP FLASHING
 6" GMS DIAGONAL BRACING. SEE STRUCTURAL
 20 GA. GALVALUME RIBBED VERTICAL PANEL BY CENTRIA MODEL: CS-260, COLOR: RICH BLACK. INSTALL AS PER WALL PANEL MFG'S WRITTEN INSTRUCTIONS (TYP.)
 CONT. BOTTOM OF METAL WALL PANEL EXTRUSION, RAKE FLASHING, CLOSURE AND COUNTER-FLASHING BY ROOFING MFG.
 24 GA. SS II. STANDING SEAM METAL ROOF OVER STEEL PURLINS AT 5'-0" O.C. MAX. (W/ THERMAL SPACERS). FASTEN ROOF PANELS PER MFG'S SPECIFICATIONS (TYP.)
 STEEL CEE CHANNELS AT 48" O.C. SPANNING BETWEEN BETWEEN HSS12X2X $\frac{1}{2}$ PURLINS
 R-30 LONG TAB BANDED INSULATION SYSTEM BETWEEN 8" STEEL ROOF PURLINS BY P.E.M.B. MFR (TYP.)


ALUMINUM FLUSH CEILING PANELS (MATCH SOFFIT) SECURED TO CEE CHANNELS. INSTALL PER MFG'S WRITTEN INSTRUCTIONS.
 CONT. ALUMINUM SOFFIT PANEL CLOSURE TRIM. INSTALL PER MFG'S WRITTEN INSTRUCTIONS (TYP.)
 HSS16X4X $\frac{1}{2}$ BEAM. SEE STRUCTURAL
 OUTLINE OF STEEL BEAM (SLOPING BEYOND)
 5/8" GWB. COORD. W/ FINISH SCHEDULE
 OUTLINE OF HSS12X4X $\frac{1}{2}$ BEAM (BEYOND)
 6" GMS FRAMING AT 16" O.C. W/ R-19 BATT INSULATION. SEE STRUCTURAL
 METAL BOXED HEADER. SEE STRUCTURAL
 INDICATES CURTAIN WALL SYSTEM (BEYOND). COORD. W/ CURTAIN WALL SCHEDULE
 6" GMS CEILING JOISTS AT 16" O.C. W/ R-19 BATT INSULATION. SEE STRUCTURAL
 5/8" GWB CEILING

OUTLINE OF HSS8X6X $\frac{1}{2}$ COLUMN (BEYOND). SEE STRUCTURAL
 REINFORCED CONC. SLAB ON VAPOR BARRIER. SEE STRUCTURAL

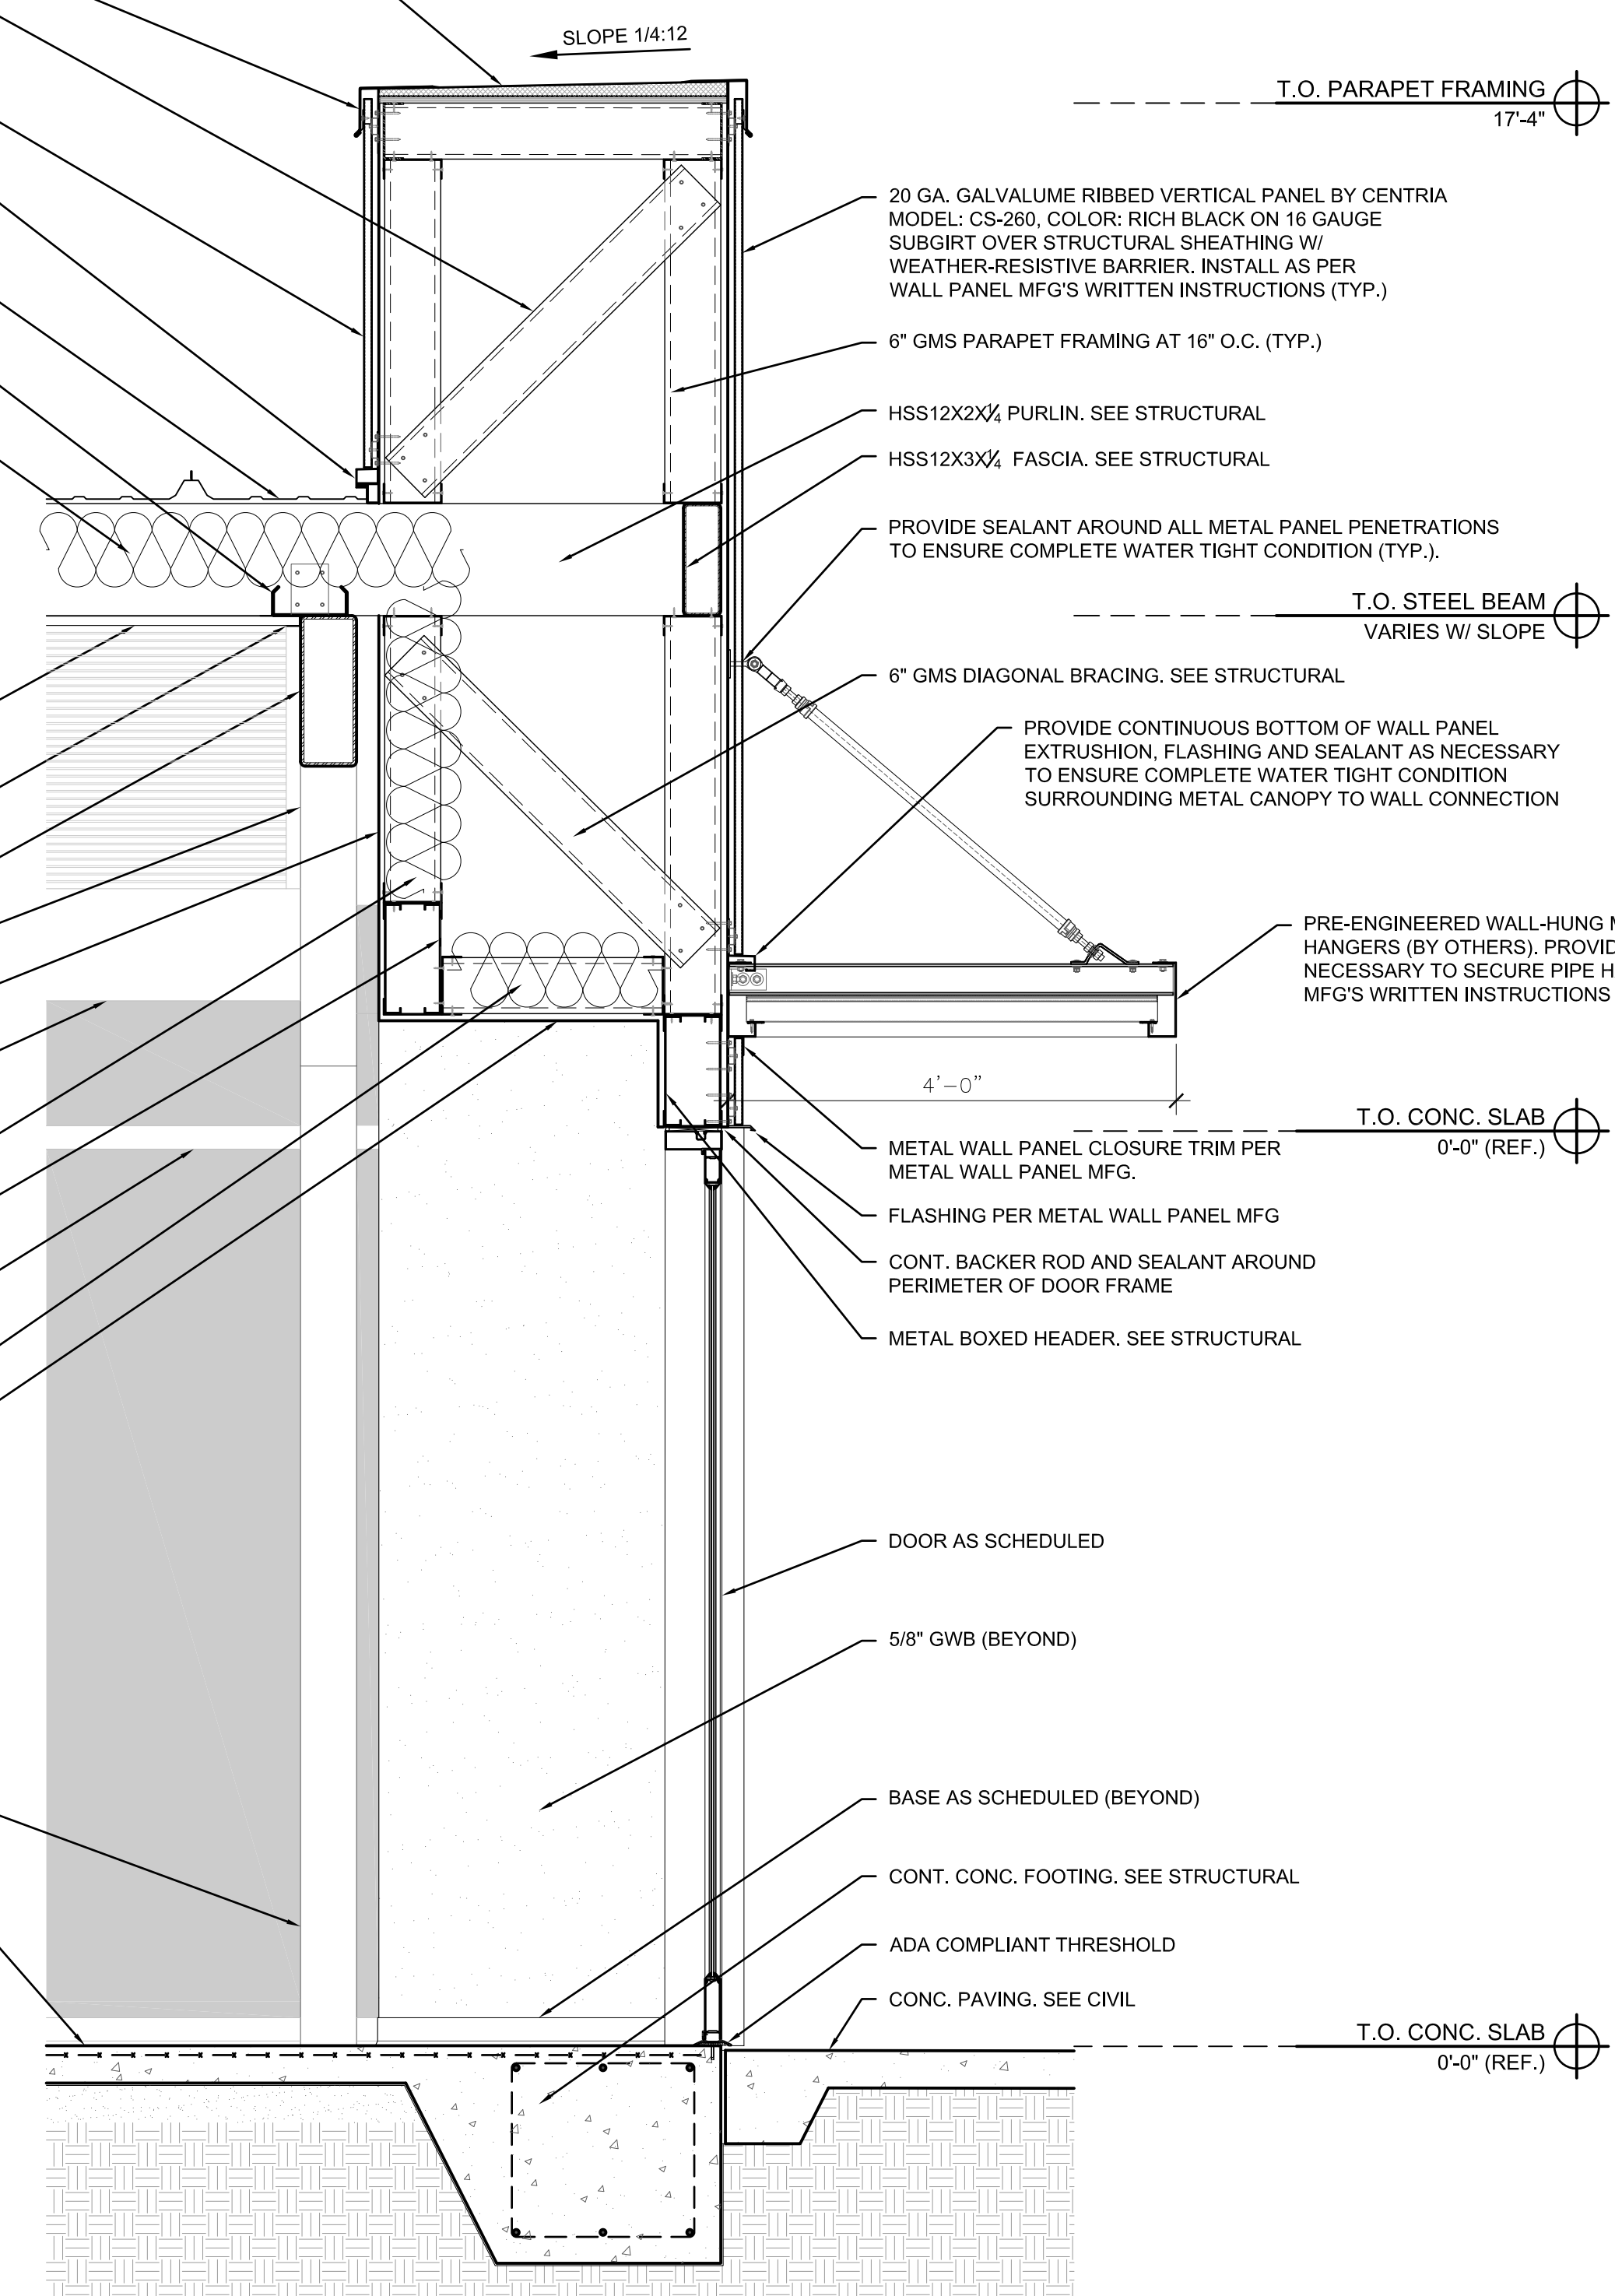

1 WALL SECTION
 A4.8 SCALE: 3/4" = 1'-0"

CONT. PRE-FINISHED GALVALUME RAKE TRIM, CLOSURE AND FASTENING AS PER METAL BUILDING MFG. (TYP.)
 CONT. STEEL CEE FASCIA
 T.O. STEEL FRAME VARIES W/ SLOPE
 8" CONTINUOUS STEEL GIRT (BY P.E.B. MFG) ATTACHED TO COLUMNS AS PER P.E.B. MFG'S SPECIFICATIONS
 24 GA. SS II. STANDING SEAM METAL ROOF OVER STEEL PURLINS AT 5'-0" O.C. MAX. (W/ THERMAL SPACERS). FASTEN ROOF PANELS PER MFG'S SPECIFICATIONS (TYP.)
 R-19 SAG-N-BAG INSULATION SYSTEM BETWEEN 8" STEEL ROOF PURLINS BY P.E.M.B. MFR (TYP.)
 STEEL ROOF PURLINS BY P.E.M.B. MFG
 STRUCTURAL STEEL P.E.B. FRAME
 STRUCTURAL STEEL P.E.B. FRAME (BEYOND)
 R-19 VINYL FACED INSULATION (TYP.)
 CONT. STEEL BEAM SUPPORTS FOR OVERHEAD ROLL-UP STEEL DOOR SYSTEM. SEE STRUCTURAL.
 ROLL-UP DOOR HOUSING
 ROLL-UP DOOR HEAD 16'-0"
 CONT. BRAKE METAL TRIM @ UNDERSIDE OF ROLL-UP DOOR HEAD. PROVIDE BLOCKING AS NECESSARY
 EXTERIOR BRAKE METAL JAMB / JAMB EXTRUSION (BEYOND) PER METAL WALL PANEL MFG. INSTALL PER MFG'S WRITTEN INSTRUCTIONS (TYP.)
 SCHEDULED HEAVY DUTY INSULATED STEEL ROLL-UP DOOR. INSTALL AS PER MFG'S WRITTEN INSTRUCTIONS.
 STRUCTURAL STEEL P.E.B. FRAME (BEYOND)

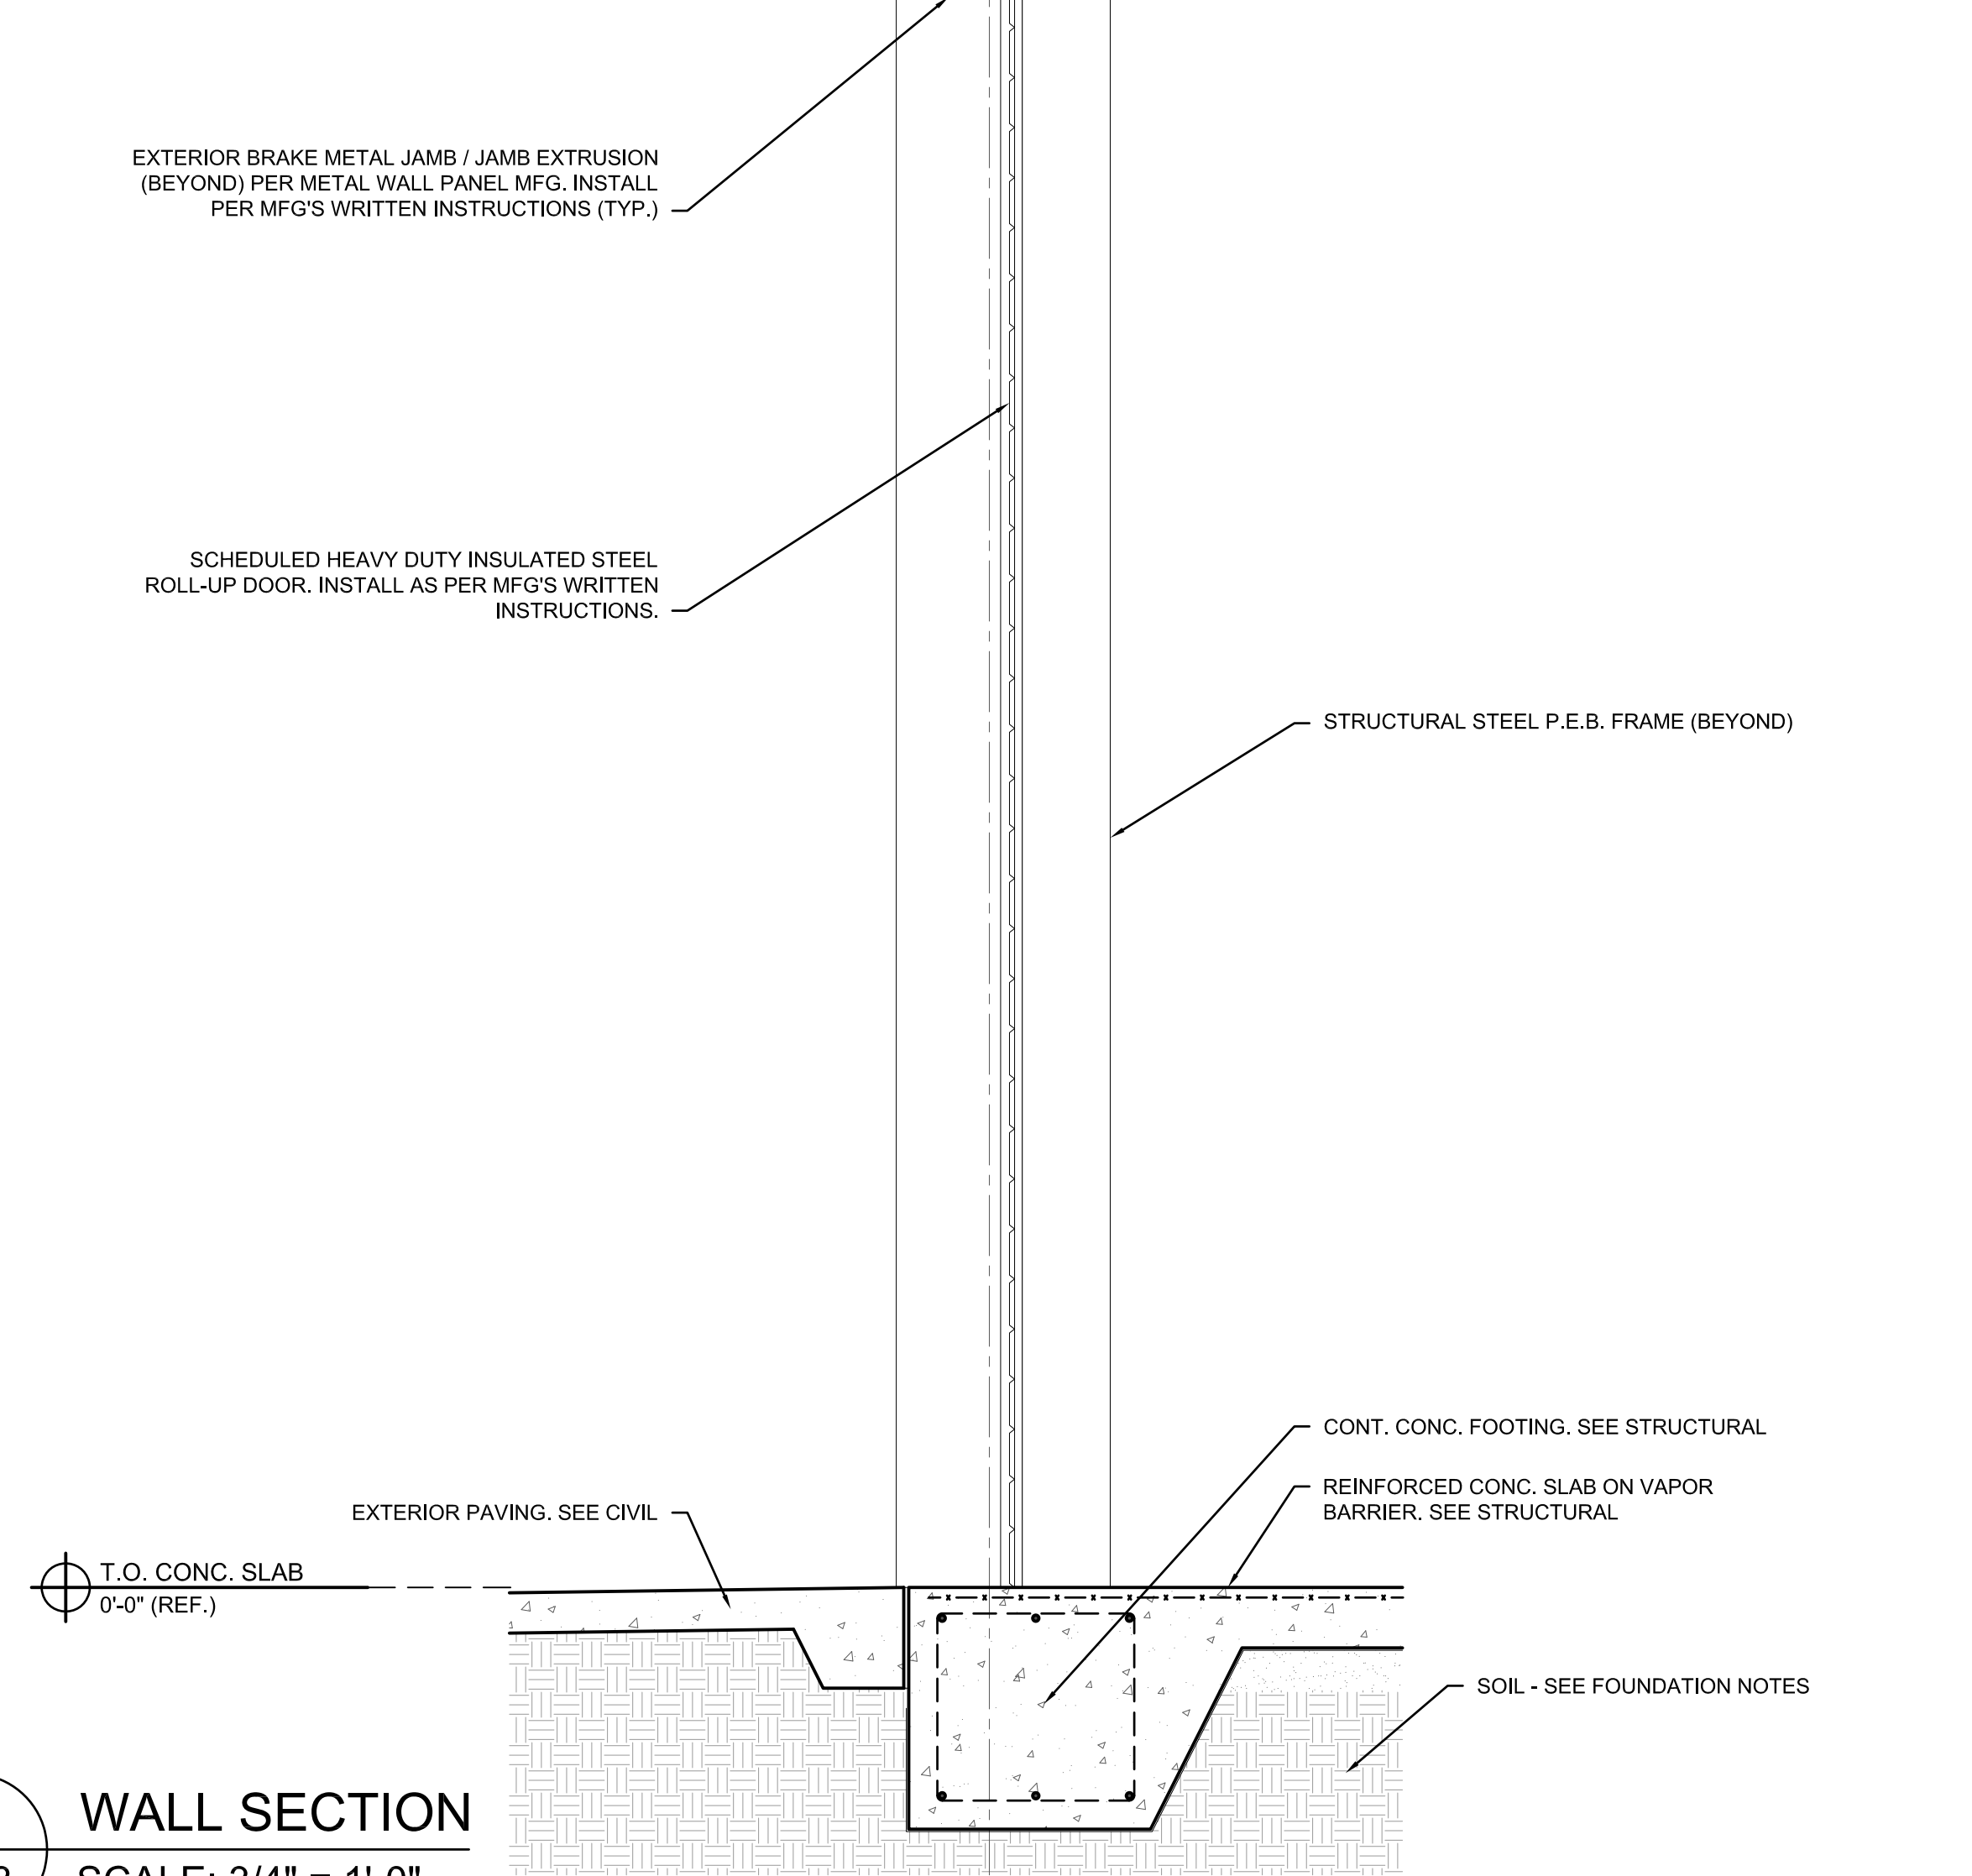

2 WALL SECTION
 A4.8 SCALE: 3/4" = 1'-0"

METAL FABRICATIONS NEW FACILITY
 4323 AVIATION AVENUE, TALLAHASSEE, FL 32310

WALL SECTIONS

CONN + ARCHITECTS
 1960-C Buford Boulevard Tallahassee, Florida 32308 | 850-878-9794
 www.connarchitects.com | Lic. No. AA-C001662

DATE	07-21-24
DRAWN BY	DBC
REVISED	
JOB NO.	23-208

DATE SHEET NUMBER
A4.8

COPYRIGHT © 2024 CONN + ARCHITECTS, INC. ALL RIGHTS RESERVED. NO PART OF THIS DOCUMENT MAY BE REPRODUCED, STORED IN A RETRIEVAL SYSTEM, OR TRANSMITTED IN ANY FORM OR BY ANY MEANS, ELECTRONIC, MECHANICAL, PHOTOCOPIING, RECORDING, OR OTHERWISE, WITHOUT THE PRIOR WRITTEN PERMISSION OF CONN + ARCHITECTS, INC.

PRICING SET - NOT FOR CONSTRUCTION

ROOM FINISH SCHEDULE									
MARK	ROOM NAME	FLOORING		BASE	WALLS	CEILING	WALL & CEILING RATING	CEILING HT.	REMARKS
		FINISH	CLASS						
100	RETAIL	CONC-3	I OR II	RC-1	GW-B / PAINT	OPEN / EXPOSED	A OR B	VARIES	2
101	HALL	CONC-3	I OR II	RC-1	GW-B / PAINT	ACT	A OR B	12'-0"	
102	SHARED OFFICE	CONC-3	I OR II	RC-1	GW-B / PAINT	ACT	A, B OR C	12'-0"	
103	CONFERENCE ROOM	CONC-3	I OR II	RC-1	GW-B / PAINT	ACT / GW-B	A, B OR C	10'-0" / 12'-0"	3
104	COPY ROOM	CONC-3	I OR II	RC-1	GW-B / PAINT	ACT	A OR B	12'-0"	
105	MECHANICAL CLOSET	CONC-3	I OR II	RC-1	GW-B / PAINT	OPEN / EXPOSED	A, B OR C		2
106	MEN'S RESTROOM	TILE	I OR II	TILE	GW-B-2 / PAINT	GW-B	A, B OR C	9'-0"	1
107	WOMEN'S RESTROOM	TILE	I OR II	TILE	GW-B-2 / PAINT	GW-B	A, B OR C	9'-0"	1
108	OFFICE 3	CONC-3	I OR II	RC-1	GW-B / PAINT	ACT	A, B OR C	12'-0"	
109	OFFICE 2	CONC-3	I OR II	RC-1	GW-B / PAINT	ACT	A, B OR C	12'-0"	
110	OFFICE 1	CONC-3	I OR II	RC-1	GW-B / PAINT	ACT	A, B OR C	12'-0"	
111	SEADECK STORAGE	CONC-3	I OR II	RC-1	GW-B / PAINT	ACT	A, B OR C	12'-0"	
112	BREAK ROOM	CONC-3	I OR II	RC-1	GW-B / PAINT	ACT	A, B OR C	12'-0"	
113	ELECTRICAL ROOM	CONC-2	I OR II	RC-1	GW-B / PAINT	OPEN / EXPOSED	CLASS A	12'-0"	
114	UNISEX RESTROOM 1	CONC-3	I OR II	TILE	GW-B-2 / PAINT	GW-B	A, B OR C	9'-0"	1
115	LOCKER ROOM	CONC-3	I OR II	TILE	GW-B / PAINT	GW-B	A, B OR C	9'-0"	1
116	UNISEX RESTROOM 2	CONC-3	I OR II	TILE	GW-B-2 / PAINT	GW-B	A, B OR C	9'-0"	1
117	WAREHOUSE	CONC-1	I OR II	RC-1	GW-B / PAINT	OPEN / EXPOSED	CLASS A		
118	UTILITY ROOM	CONC-2	I OR II	RC-1	GW-B-3 / PAINT	GW-B-4	CLASS A	12'-0"	

REMARKS:
 1. PROVIDE 5/8" MOISTURE RESISTANT GWB AT ALL PLUMBING / WET WALLS. 2. OPEN / EXPOSED CEILING HEIGHT VARIES WITH SLOPE OF ROOF STRUCTURE
 3. REFER TO REFLECTED CEILING PLAN

FLOOR	
TILE	30"x30" ESTATE WOOD "HALL" PORCELAIN TILE, GROUT COLOR: MAPEI # 42 MOCHA FA (OR EQUIVALENT).
CONC-1	POLISHED CONCRETE.
CONC-2	SEALED CONCRETE.
CONC-3	STAINED CONCRETE.
LVT	LUXURY VINYL TILES, COLOR AND STYLE SELECTED BY OWNER

BASE	
RC-1	6" RUBBER COVE BASE, JOHNSONITE, COLOR SELECTED BY OWNER
TILE	CUT FLOOR TILES TO GET 4" BASE

WALLS	
GW-B	5/8" GWB - LEVEL 4 SMOOTH FINISH, PAINTED WHERE EXPOSED, COLOR SELECTED BY OWNER.
GW-B-2	5/8" MOISTURE RESISTANT GWB - LEVEL 4 SMOOTH FINISH, PAINTED, COLOR SELECTED BY OWNER.
GW-B-3	5/8" TYPE 'X' GWB - LEVEL 4 SMOOTH FINISH, PAINTED, COLOR SELECTED BY OWNER.

CEILING	
ACT	ARMSTRONG "ULTIMA" 24" X 24" ACOUSTICAL CEILING TILE, ITEM# 1951, BEVELED TEGULAR 15/16, COLOR: WHITE (OR EQUIVALENT) IN ALUMINUM GRID
G.W.B.	5/8" GWB - LEVEL 4 SMOOTH FINISH, PAINTED, COLOR: WHITE
GW-B-4	5/8" TYPE 'C' GWB - LEVEL 4 SMOOTH FINISH, PAINTED, COLOR: WHITE

FINISH SCHEDULE GENERAL NOTES

- FINISH NOTES**
- ALL FINISHES AND COLORS SHALL BE SELECTED BY OWNER. CONTRACTOR SHALL COORDINATE / VERIFY ALL FINISHES, COLOR WITH OWNER PRIOR TO BIDDING.
 - INSTALL A.D.A. COMPLIANT TRANSITION STRIPS AT ALL CHANGES IN FINISH FLOORING.
 - FLOOR TILES AND TILE BASES SHALL BE NON-SLIP GRADE AND SHALL CONFORM TO STANDARDS SET BY THE TILE COUNCIL OF AMERICA AND ANSI.
 - IT IS THE CONTRACTOR'S RESPONSIBILITY TO VERIFY AND COMPLY WITH THE MANEUVERING CLEARANCES AT ALL DOORS PER A.D.A. DETAILS.
 - INSTALL SOLID BLOCKING WITHIN WALLS WHERE REQUIRED FOR NEW EQUIPMENT, ACCESSORIES AND TRIM.
 - ALL PAINT IN RESTROOMS SHALL BE EPOXY BASED.

- FLAMESPREAD CLASS RATING DEFINITION**
- CLASS A INTERIOR WALL AND CEILING FINISH - FLAME SPREAD 0-25, (NEW) SMOKE DEVELOPED 0-450
 CLASS B INTERIOR WALL AND CEILING FINISH - FLAME SPREAD 26-75, (NEW) SMOKE DEVELOPED 0-450
 CLASS C INTERIOR WALL AND CEILING FINISH - FLAME SPREAD 76-200, (NEW) SMOKE DEVELOPED 0-450

- FLAMESPREAD NOTES**
- ALL NEW INTERIOR WALL AND CEILING FINISHES SHALL MEET OR EXCEED CLASS B FLAME SPREAD 26-75, (NEW) SMOKE DEVELOPED 0-450 AS DEFINED BY NFPA 101, 12.3.3.
 - ALL NEW INTERIOR FLOOR FINISHES SHALL MEET OR EXCEED CLASS II AS DEFINED BY NFPA 101 12.3.3.

STOREFRONT WINDOW / GLASS WALL SCHEDULE					
MARK	UNIT SIZE		TYPE	FRAME MATERIAL	REMARKS
	WIDTH (R.O.)	HEIGHT (R.O.)			
(A)	20'-0"	±10'-4"	ALUMINUM STOREFRONT	ALUMINUM	2, 7
(B)	15'-0"	VARIES	ALUMINUM STOREFRONT	ALUMINUM	5, 7
(C)	20'-0"	±14'-0"	ALUMINUM STOREFRONT	ALUMINUM	2, 7
(D)	5'-0"	VARIES	ALUMINUM STOREFRONT	ALUMINUM	5, 7
(E)	6'-0"	5'-6"	ALUMINUM STOREFRONT	ALUMINUM	1
(F)	13'-6"	5'-6"	ALUMINUM STOREFRONT	ALUMINUM	1
(G)	11'-2"	8'-2"	ALUMINUM STOREFRONT	ALUMINUM	1
(H)	7'-6"	8'-2"	ALUMINUM STOREFRONT	ALUMINUM	1
(I)	8'-6"	4'-8"	ALUMINUM STOREFRONT	ALUMINUM	1
(J)	20'-0"	3'-6"	ALUMINUM STOREFRONT	ALUMINUM	1, 4
(K)	8'-4 1/2"	4'-8"	ALUMINUM STOREFRONT	ALUMINUM	2, 6
(L)	7'-4 1/2"	8'-2"	ALUMINUM STOREFRONT	ALUMINUM	2, 6
(M)	9'-1 1/2"	4'-8"	ALUMINUM STOREFRONT	ALUMINUM	2, 6
(N)	9'-10"	8'-2"	ALUMINUM STOREFRONT	ALUMINUM	2, 6
(O)	11'-10 1/2"	10'-0"	BUTT JOINT GLAZING	ALUMINUM	3, 6
(P)	22'-7 1/2"	10'-0"	BUTT JOINT GLAZING	ALUMINUM	3, 6

- REMARKS:**
- TEMPERED INSULATED ALUMINUM STOREFRONT WINDOW SYSTEM (TYPICAL EXTERIOR STOREFRONT WINDOWS). FRAME COLOR TO BE BLACK.
 - TEMPERED ALUMINUM STOREFRONT WINDOW SYSTEM (TYPICAL INTERIOR STOREFRONT WINDOWS). FRAME COLOR TO BE BLACK.
 - TEMPERED BUTT-JOINT WINDOW SYSTEM W/ ALUMINUM PERIMETER FRAME / CHANNELS. PROVIDE PRE-FORMED NON-YELLOWING SEALANT BETWEEN GLASS PANELS. PROVIDE PERIMETER FRAME W/ GASKET AND DROP-DOWN THRESHOLD SEALS AT GLASS DOORS. FRAME COLOR TO BE BLACK.
 - ALUMINUM STOREFRONT CLEARESTORY WINDOWS. FRAME COLOR TO BE BLACK. COORDINATE WITH ELEVATIONS.
 - HEIGHT VARIES WITH SLOPE OF STOREFRONT WINDOW SYSTEM.
 - CENTER WINDOW FRAME ON WALL AND BULKHEAD ABOVE. COORDINATE WITH WALL SECTIONS.
 - TEMPERED INSULATED ALUMINUM CURTAIN WALL SYSTEM. FRAME COLOR TO BE BLACK.
 - HEIGHT OF CURTAIN WALL SYSTEM VARIES WITH SLOPE OF ROOF. FIELD VERIFY HEIGHTS PRIOR TO FABRICATION.

- WINDOW SPECIFICATION**
- ALL STOREFRONT / CURTAIN WALL WINDOWS ARE INSULATED, ALUMINUM WINDOWS AS SCHEDULED W/ FACTORY FINISH. FINISH SHALL BE "ANODIZED", BLACK COLOR.
 - ALL EXTERIOR WINDOWS SHALL HAVE A U-FACTOR OF 0.45 AND A SHGC OF 0.52. (THESE FACTORS ARE MINIMUM REQUIREMENTS) - COORDINATE WITH ENERGY FORMS.
 - ALL EXTERIOR DOORS SHALL HAVE A U-FACTOR OF 0.45 AND A SHGC OF 0.52. (THESE FACTORS ARE MINIMUM REQUIREMENTS) - COORDINATE WITH ENERGY FORMS.

- GENERAL NOTES**
- ALL EXTERIOR WINDOW AND DOOR GLAZING SHALL BE LOW-E, INSULATING GLASS.
 - FIELD VERIFY ALL WINDOW TYPE OPENINGS PRIOR TO FABRICATION AND INSTALLATION OF WINDOWS.
 - ALL GLASS WITHIN DOORS, WITHIN 24" OF A DOOR, OR WITHIN 18" FROM FINISHED FLOOR SHALL BE TEMPERED.
 - EXTERIOR WINDOWS AND GLASS DOORS SHALL BEAR THE "AMA", "WDM", OR OTHER APPROVED LABEL INDICATING COMPLIANCE WITH ANSI / AAMA / NWEDA 1011.S.2-97 AND SHALL MEET THE DESIGN PRESSURE AS NOTED ON THE STRUCTURAL DRAWINGS.
 - PROVIDE INSPECTOR WITH MANUFACTURER'S SHOP DRAWINGS FOR INSTALLATION.
 - ALL WINDOWS AND DOORS SHALL BE (WHERE REQUIRED) OF THE TYPE DESIGNED FOR AND INTENDED FOR USE IN MASONRY CONSTRUCTION.
 - ALL DOORS, WINDOWS, FRAMES AND GLAZING SHALL BE INSTALLED AS PER MANUFACTURER'S WRITTEN INSTRUCTIONS.
 - COORDINATE WITH STOREFRONT WINDOW ELEVATIONS SHEET A5.1.


DOOR SCHEDULE							
MARK	DOOR			FRAME		HARDWARE SET	REMARKS
	SIZE	MATERIAL	ELEV.	GLAZING	MATERIAL		
1	16'-0" x 16'-0"	STEEL	2	-	STEEL	-	SET 1
2	(2) 20'-0" x 16'-0"	STEEL	1	-	STEEL	-	SET 1
3	3'-0" x 7'-0"	H.M.	5	-	H.M.	-	SET 7
4	3'-0" x 7'-0"	H.M.	5	-	H.M.	-	SET 7
5	16'-0" x 16'-0"	STEEL	2	-	STEEL	-	SET 1
6	3'-0" x 7'-0"	H.M.	5	-	H.M.	-	SET 7
7	16'-0" x 16'-0"	STEEL	2	-	STEEL	-	SET 1
8	3'-0" x 7'-0"	H.M.	5	-	H.M.	-	SET 7
9	(2) 3'-0" x 8'-0"	ALUMINUM / GLASS	3	CLEAR	ALUMINUM	-	SET 6
10	3'-0" x 8'-0"	ALUMINUM / GLASS	4	CLEAR	ALUMINUM	-	SET 6
11	3'-0" x 8'-0"	ALUMINUM / GLASS	4	CLEAR	ALUMINUM	-	SET 6
12	3'-0" x 7'-0"	S.C. WOOD	8	-	H.M.	-	SET 3
13	3'-0" x 7'-0"	S.C. WOOD	8	-	H.M.	-	SET 5
14	3'-0" x 7'-0"	S.C. WOOD	8	-	H.M.	-	SET 2
15	3'-0" x 7'-0"	S.C. WOOD	8	-	H.M.	-	SET 2
16	3'-0" x 8'-0"	ALUMINUM / GLASS	4	CLEAR	ALUMINUM	-	SET 5
17	3'-0" x 7'-0"	S.C. WOOD / GLASS	9	CLEAR	H.M.	-	SET 5
18	3'-0" x 7'-0"	S.C. WOOD	8	-	H.M.	-	SET 2
19	3'-0" x 7'-0"	S.C. WOOD	8	-	H.M.	-	SET 2
20	3'-0" x 7'-0"	S.C. WOOD	8	-	H.M.	-	SET 2
21	3'-0" x 7'-0"	S.C. WOOD	8	-	H.M.	-	SET 3
22	3'-0" x 8'-0"	ALUMINUM / GLASS	10	CLEAR	ALUMINUM	-	SET 4
23	3'-0" x 8'-0"	ALUMINUM / GLASS	10	CLEAR	ALUMINUM	-	SET 4
24	(2) 3'-0" x 7'-0"	S.C. WOOD	11	-	H.M.	-	SET 3
25	3'-0" x 8'-0"	ALUMINUM / GLASS	4	CLEAR	ALUMINUM	-	SET 4
26	3'-0" x 8'-0"	ALUMINUM / GLASS	10	CLEAR	ALUMINUM	-	SET 4
27	3'-0" x 8'-0"	ALUMINUM / GLASS	10	CLEAR	ALUMINUM	-	SET 4
28	3'-0" x 8'-0"	ALUMINUM / GLASS	4	CLEAR	ALUMINUM	-	SET 4
29	3'-0" x 8'-0"	ALUMINUM / GLASS	4	CLEAR	ALUMINUM	-	SET 4
30	3'-0" x 8'-0"	ALUMINUM / GLASS	10	CLEAR	ALUMINUM	-	SET 4
31	3'-0" x 8'-0"	ALUMINUM / GLASS	4	CLEAR	ALUMINUM	-	SET 5
32	3'-0" x 7'-0"	H.M. / GLASS	7	CLEAR	H.M.	-	SET 3
33	3'-0" x 7'-0"	H.M. / GLASS	6	CLEAR	H.M.	-	SET 7

- REMARKS:**
- ALUMINUM STOREFRONT DOORS
 - HEAVY DUTY INSULATED ROLL-UP STEEL DOOR
 - EXTERIOR STEEL ROLLING HANGAR DOOR SYSTEM WITH WEATHER SEALS BY "WELL BILT INDUSTRIES" OR EQUIVALENT.
 - TEMPERED GLASS
 - SOLID CORE WOOD DOOR WITH 4"x25" TEMPERED VISION PANEL
 - PROVIDE PANIC EXIT ALARM PUSH-BAR DEVICE
 - PROVIDE 12" X 34" S.S. KICK PLATE
 - 1-HOUR RATED H.M. DOOR WITH 4"x25" TEMPERED VISION PANEL
 - H.M. DOOR WITH 23X35 TEMPERED GLASS PANEL
 - TEMPERED GLASS DOOR PER GLASS WALL SYSTEM MFG.

- DOOR SCHEDULE NOTES**
- ALL DOORS SHALL HAVE LEVER TYPE HARDWARE PER CODE.
 - COORDINATE WITH OWNER ALL FINISH, TYPE AND COLOR OF ALL DOORS AND WINDOWS.
 - COORDINATE ALL DOORS AND FINISHES WITH OWNER PRIOR TO BID.
 - DOOR SUPPLIER SHALL SUBMIT DOOR HARDWARE SCHEDULE TO THE OWNER FOR APPROVAL PRIOR TO CONSTRUCTION.
 - INSTALL PANIC, EXIST. CODE COMPLIANT, AND FIRE HARDWARE AS REQUIRED BY CODE.
 - ALL HARDWARE SHALL BE COMMERCIAL GRADE AND SHALL BE SELECTED BY OWNER.
 - ALL DOORS SHALL HAVE SILENCERS AND FLOOR-MOUNTED DOOR STOPS.
 - ALL GLASS WITHIN DOORS, WITHIN 48" OF A DOOR, OR WITHIN 18" FROM FINISHED FLOOR SHALL BE TEMPERED.
 - ALL EXTERIOR HOLLOW METAL DOORS SHALL BE INSULATED DOORS.
 - RUN CONTINUOUS BEAD OF CLEAR SILICONE CAULK AROUND ALL DOOR FRAMES AND ALL INTERIOR TILE CORNERS IN RESTROOMS.
 - ALL A.D.A. THRESHOLDS SHALL NOT EXCEED 1/2" A.F.F.
 - CONTRACTOR TO PROVIDE WOOD BLOCKING AT JAMBS AND HEAD OF ALL INTERIOR DOORS.
 - ALL WOOD AND HOLLOW METAL DOORS SHALL BE PRE-PAINTED FROM FACTORY, COLOR: TO BE SELECTED BY OWNER.
 - OVERHEAD DOORS AND ELEMENTS SHOULD, TO THE EXTENT POSSIBLE, BE POWDER-COATED, COLOR: TO BE SELECTED BY OWNER.

- INTERIOR & EXTERIOR DOOR ACCESSIBILITY NOTES**
- ALL DOORS SHALL BE OPERABLE BY A SINGLE EFFORT. THE DOORS AND CLOSERS SHALL BE ADJUSTED SUCH THAT EXTERIOR SWINGING DOORS CAN BE OPERATED BY NOT MORE THAN 8.5 POUNDS OF FORCE ON THE LATCH STYLE. INTERIOR DOORS BY NOT MORE THAN 5.0 POUNDS OF FORCE.
 - PUSH BARS, HANDRAILS, PULLS, LOCKSETS, AND OTHER OPERATING MECHANISMS ON ALL DOORS AND OTHER MECHANISMS, OR U-SHAPED HANDLES SHALL HAVE A SHAPE THAT IS EASY TO GRASP WITH ONE HAND AND DOES NOT REQUIRE TIGHT GRASPING, TIGHT PINCHING, OR TWISTING OF THE WRIST TO OPERATE. THIS REQUIREMENT SHALL BE SATISFIED BY THE 5 POUND FEET STANDARD. ALL DOORS SHALL MEET ACCESSIBILITY REQUIREMENTS AS PER CODES STATED ON THE COVER SHEET.

- DOOR HARDWARE SCHEDULE**
- SET 1: HARDWARE BY DOOR MFR.
 SET 2: 3 EA. HINGES, 1 EA. PRIVACY LOCKSET - 1 DOOR STOP, 2 KICKPLATES, 4 DOOR SILENCERS
 SET 3: 3 EA. HINGES, 1 EA. STOREROOM LOCKSET - 1 DOOR STOP, 4 DOOR SILENCERS
 SET 4: 4 EA. HINGES, 1 EA. OFFICE LOCKSET - 1 EA. DOOR STOP, 4 DOOR SILENCERS
 SET 5: 3 EA. HINGES, 1 EA. PASSAGE LOCKSET - 1 EA. DOOR STOP, 4 DOOR SILENCERS
 SET 6: 4 EA. HINGES, 1 EA. ENTRY LOCKSET - 1 EA. DOOR STOP, 1 EA. DOOR CLOSER, 1 EA. WEATHER STRIPPING, 1 EA. DOOR SWEEP, 1 EA. A.D.A. THRESHOLD
 SET 7: 3 EA. HINGES, 1 EA. RIM EXIT DEVICE WITH KEYED ENTRY LEVER TRIM, 1 EA. DOOR STOP, 1 EA. DOOR CLOSER, 1 EA. WEATHER STRIPPING, 1 EA. DOOR SWEEP, 1 EA. A.D.A. THRESHOLD

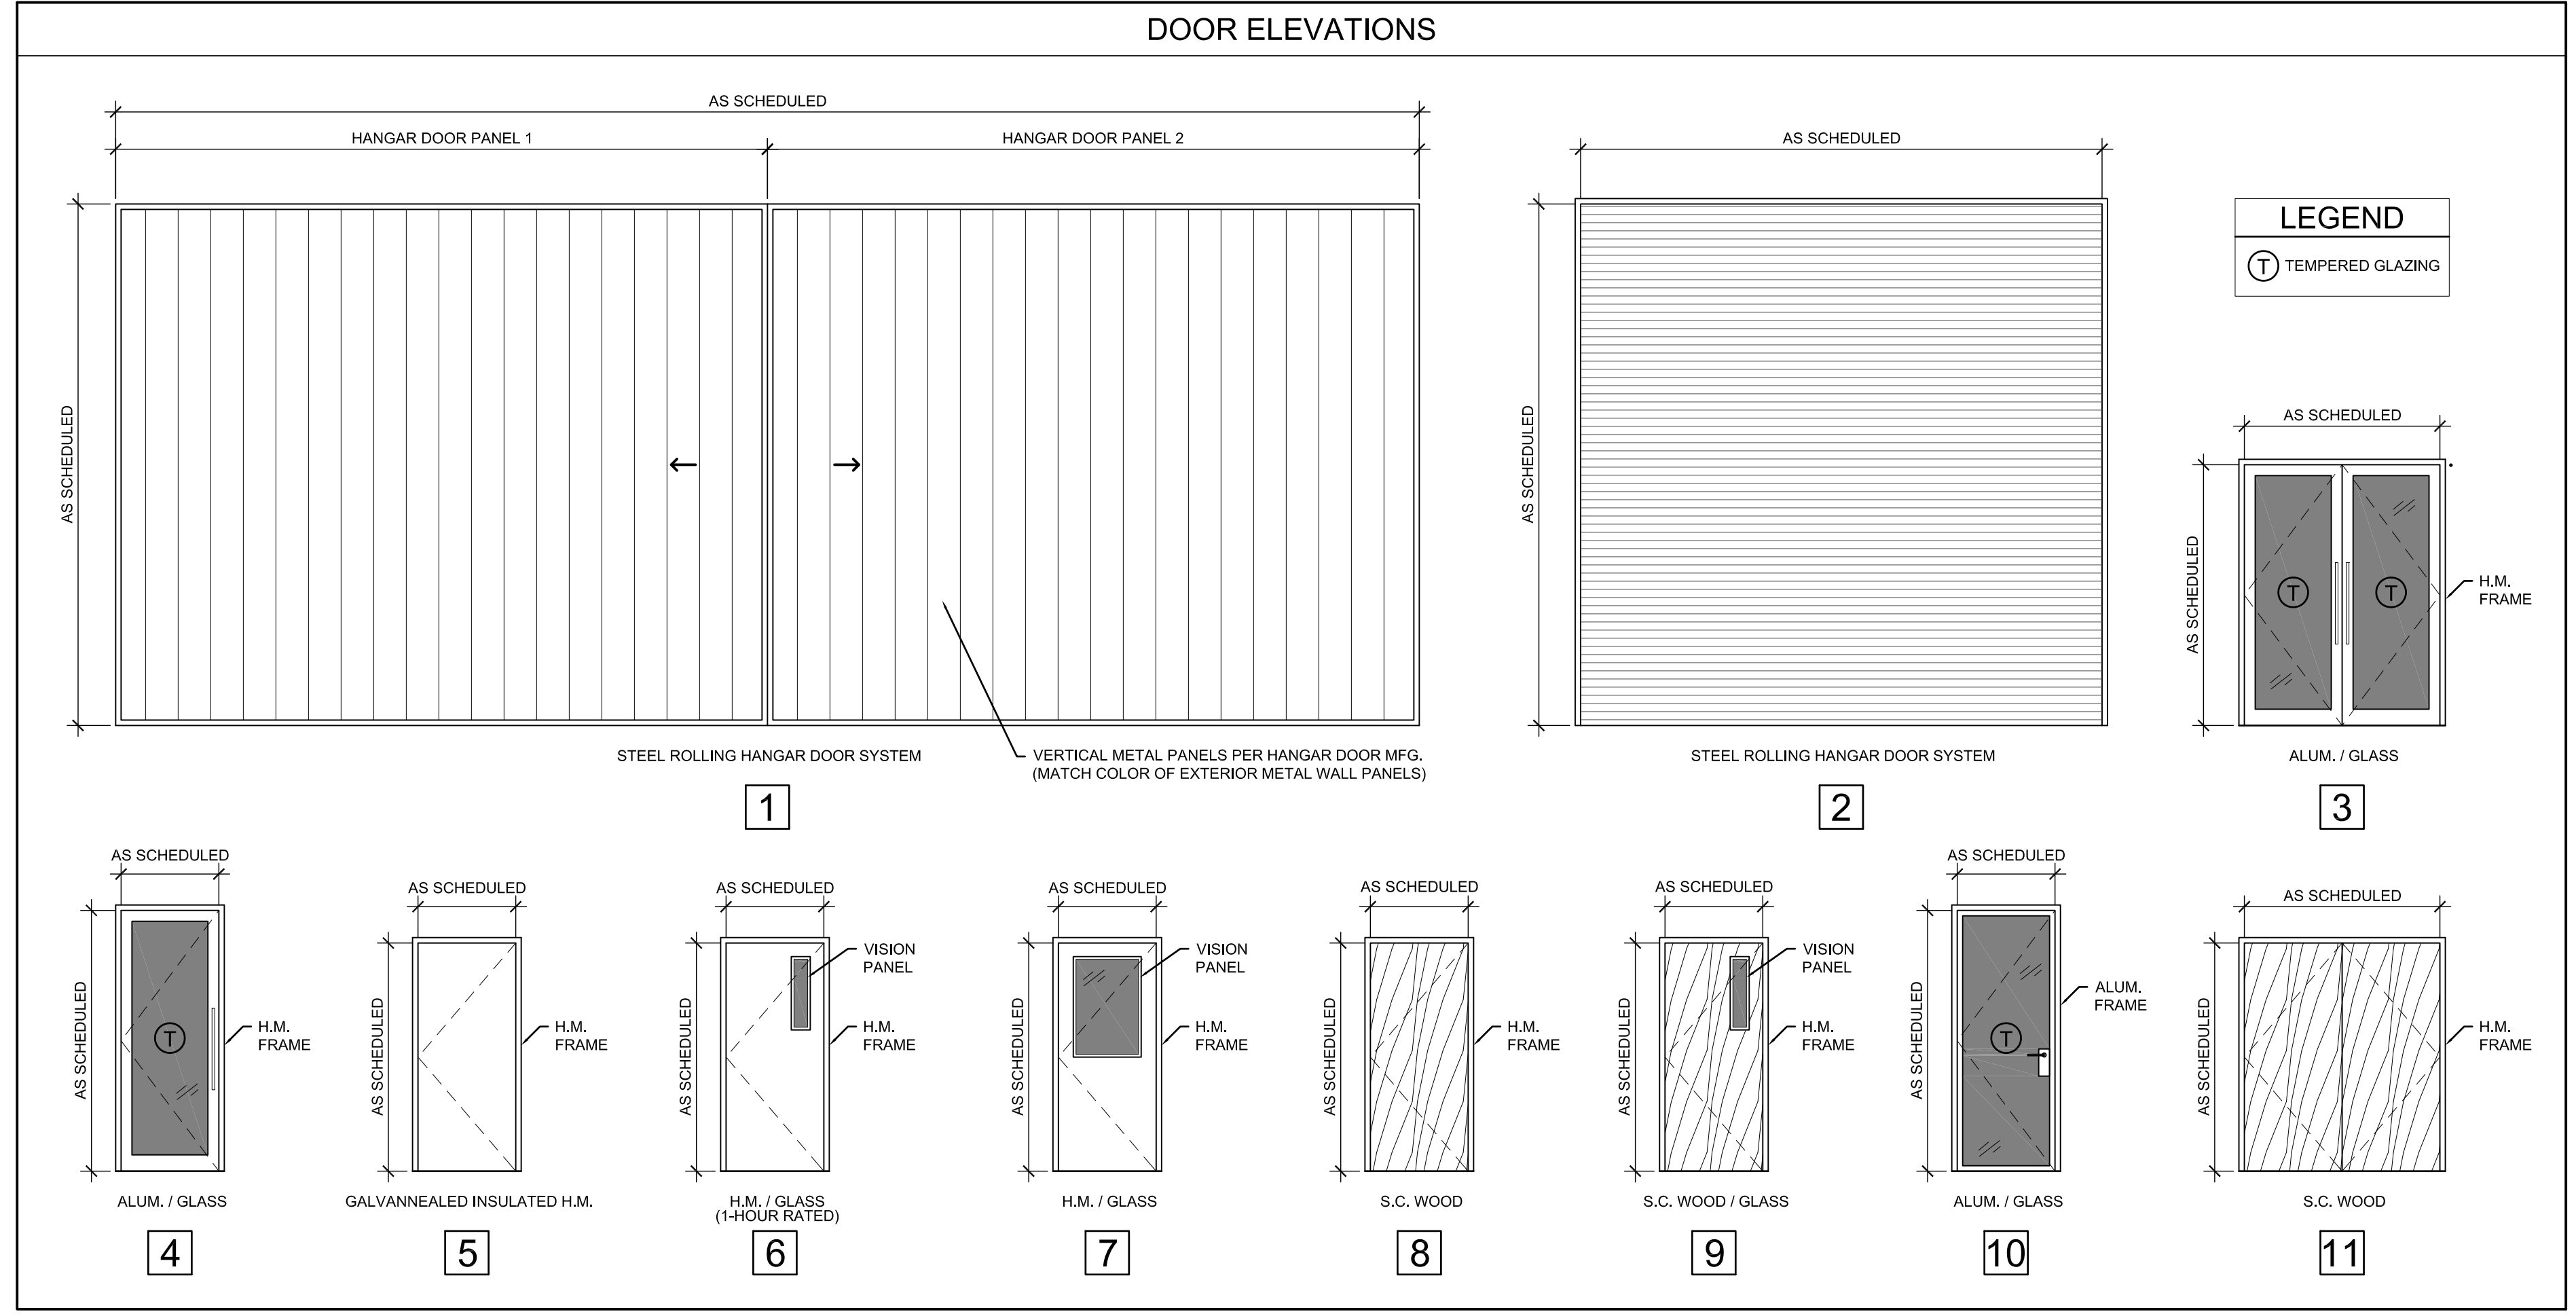




CONN ARCHITECTS, INC. IS AN EQUAL OPPORTUNITY AFFIRMATIVE ACTION EMPLOYER. WE DO NOT DISCRIMINATE ON THE BASIS OF RACE, GENDER, RELIGION, NATIONAL ORIGIN, ANCESTRY, AGE, SEX, OR DISABILITY. ANY MEANS OF COMMUNICATIONS SHALL BE REPRODUCED, STORED IN A RETRIEVAL SYSTEM, OR TRANSMITTED IN ANY FORM OR BY ANY MEANS, ELECTRONIC, MECHANICAL, PHOTOCOPIING, RECORDING, OR OTHERWISE, WITHOUT THE PRIOR WRITTEN PERMISSION OF CONN ARCHITECTS, INC.

METAL FABRICATIONS NEW FACILITY
 4323 AVIATION AVENUE, TALLAHASSEE, FL 32310
 SCHEDULES AND DOOR ELEVATIONS

CONN ARCHITECTS
 1960-C Buford Boulevard Tallahassee, Florida 32308 | 850-878-9794
 www.CONNarchitects.com | Lic. No. AA-C001662

PRICING SET - NOT FOR CONSTRUCTION

DATE	07-21-24
DRAWN BY	DBC
REVISED	
JOB NO.	23-208
SHEET NUMBER	A5.0

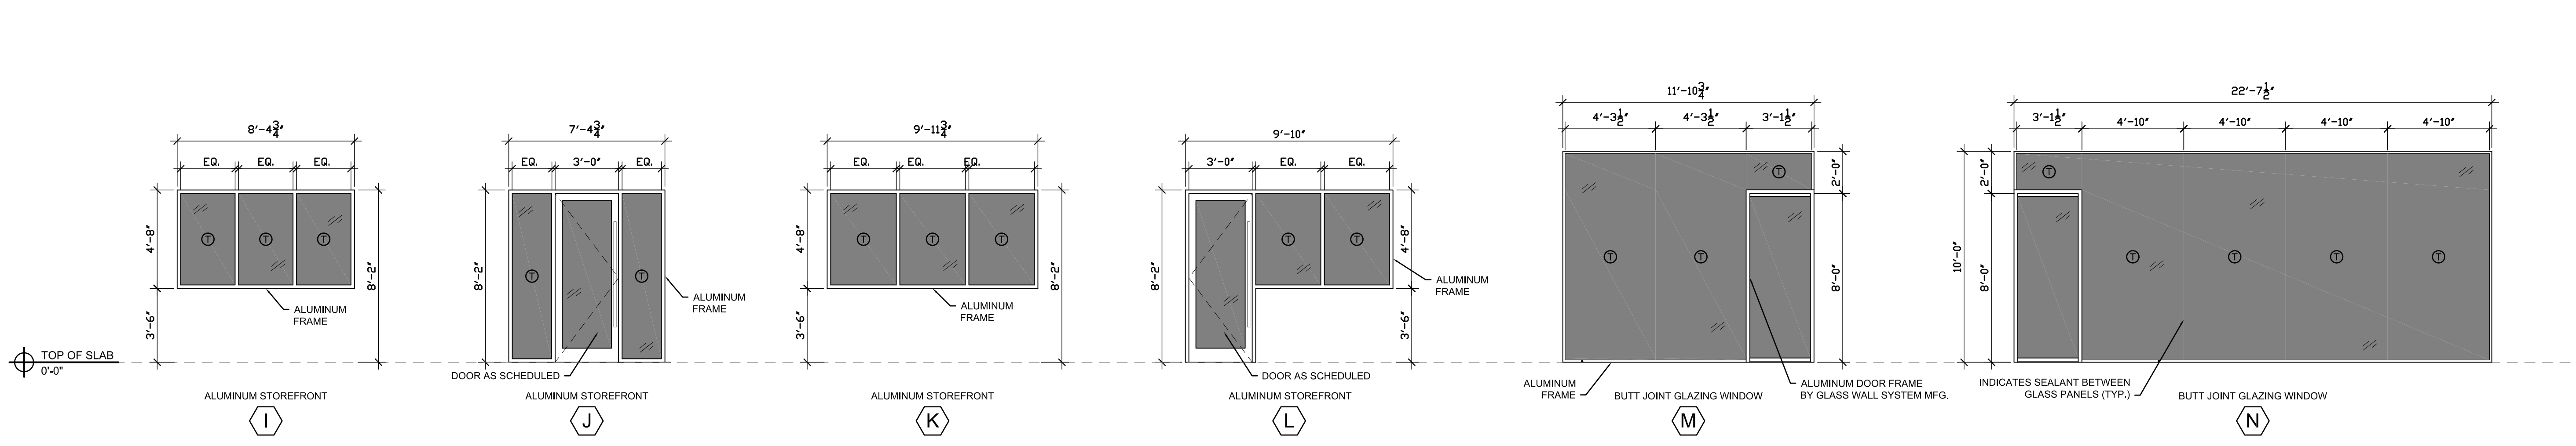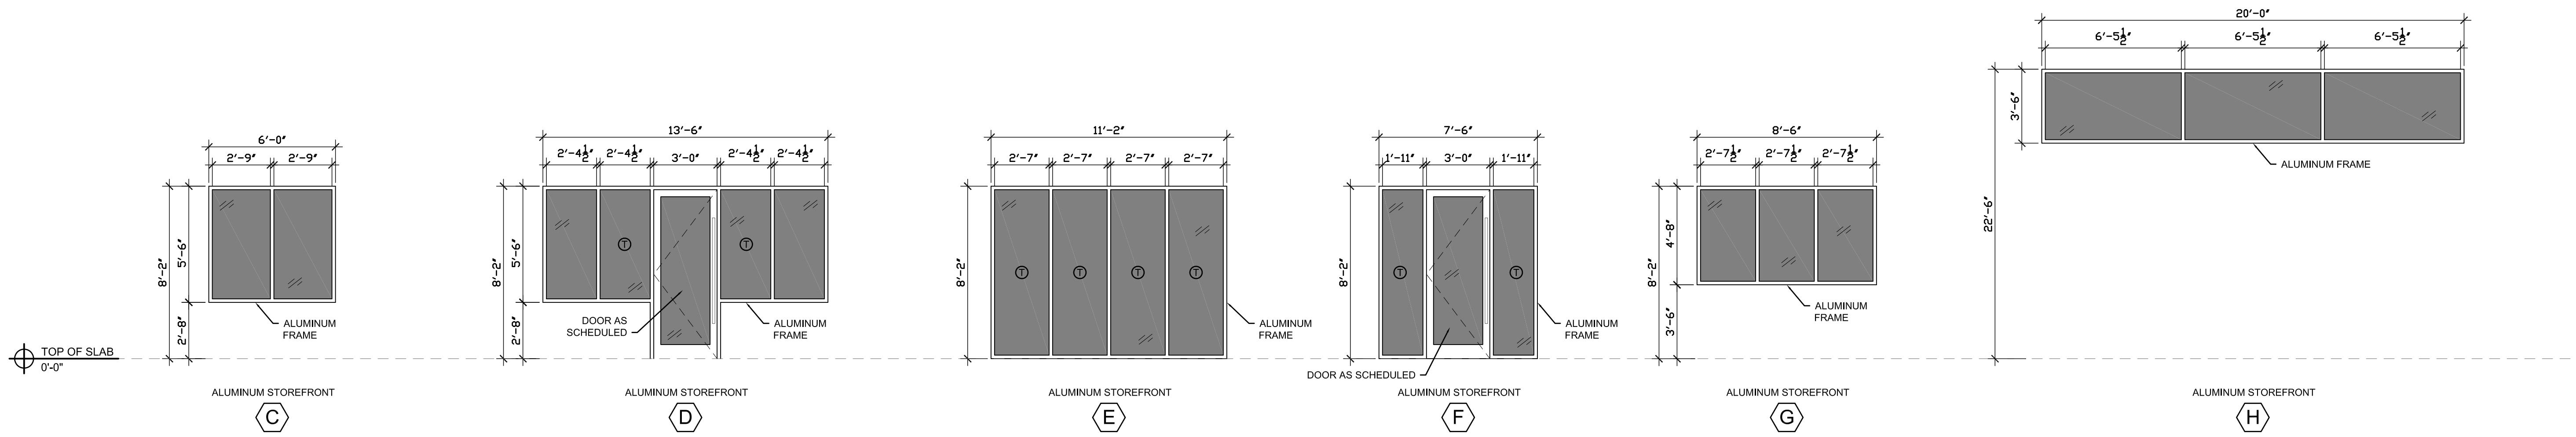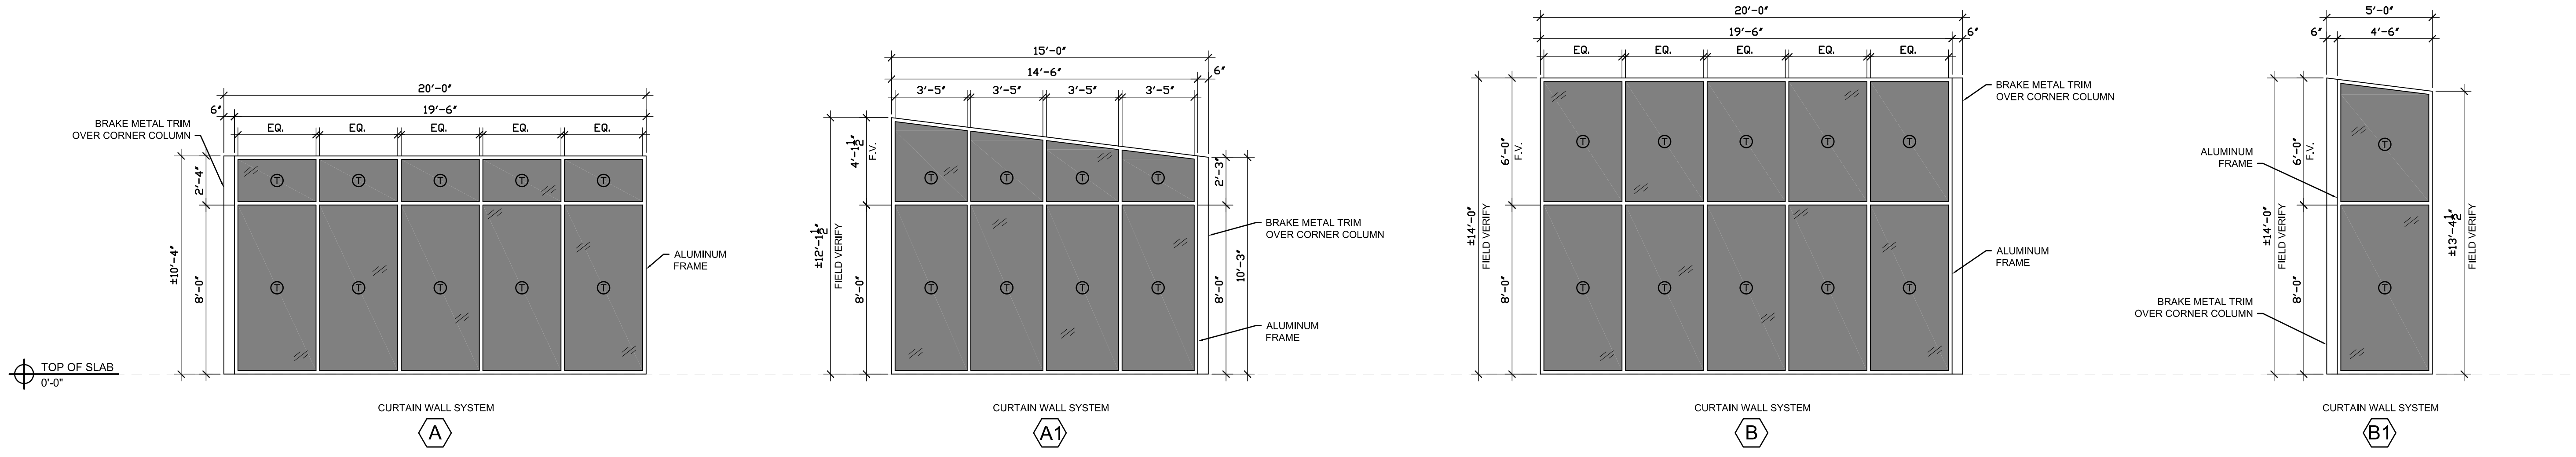

METAL FABRICATIONS NEW FACILITY
 4323 AVIATION AVENUE, TALLAHASSEE, FL 32310
 STOREFRONT WINDOW / GLASS WALL ELEVATIONS

CONN + ARCHITECTS
 1960-C Buford Boulevard Tallahassee, Florida 32308 | 850-878-9784
 www.connarchitects.com | Lic. No. AA-C001662

DATE	07-21-24
DRAWN BY	DBC
REVISED	
JOB NO.	23-208
DATE	
SHEET NUMBER	A5.1


PRICING SET - NOT FOR CONSTRUCTION

COPYRIGHT © 2024 CONN + ARCHITECTS, INC. ALL RIGHTS RESERVED. NO PART OF THIS DOCUMENT MAY BE REPRODUCED, STORED IN A RETRIEVAL SYSTEM, OR TRANSMITTED IN ANY FORM OR BY ANY MEANS, ELECTRONIC, MECHANICAL, PHOTOCOPIING, RECORDING, OR OTHERWISE, WITHOUT THE PRIOR WRITTEN PERMISSION OF CONN + ARCHITECTS, INC.

TOILET ACCESSORIES LEGEND	
	BRADLEY 8120-001360
	BRADLEY 8120-001420
	SEE PLUMBING
	SEE PLUMBING
	BRADLEY 5402-000000
	ASI 10-0620, SS FINISH
	SEE FINISH SCHEDULE
	SEE FINISH SCHEDULE
	SEE PLUMBING
	SELECTED BY OWNER
	SELECTED BY OWNER
	SELECTED BY OWNER
	SELECTED BY OWNER
	FREDDOM SHOWERS - APF6233BFF.875L

NOTES	
1.	INSULATE ALL EXPOSED HOT WATER PIPING AT HANDICAP LOCATIONS.
2.	LAVATORIES SHALL BE MOUNTED WITH LAVATORY APRON 2'-5" A.F.F. IN ACCORDANCE WITH 2023 (8TH ED.) FBC - ACCESSIBILITY REQUIREMENTS.
3.	MIRRORS SHALL BE CENTERED OVER SINKS, TYPICAL U.N.O.
4.	H/C TOILETS SHALL MEET REQUIREMENTS OF 2023 (8TH ED.) FBC - ACCESSIBILITY REQUIREMENTS.
5.	SHOULD ANY DISCREPANCY BE FOUND BETWEEN ITEMS NOTED IN THE CONTRACT DOCUMENTS AND APPLICABLE CODES, THE CONTRACTOR SHOULD BRING ITEMS TO THE ATTENTION OF THE ARCHITECT PRIOR TO ORDERING.
6.	PROVIDE SEALANT AROUND THE BASE OF ALL WATER CLOSETS.
7.	ALL BLOCKING REQUIRED FOR INSTALLATION SHALL BE PROVIDED BY CONTRACTOR.
8.	SHOULD EXISTING WALL DEPTH BE INADEQUATE TO ALLOW INSTALLATION OF RECESSED FIXTURES, SURFACE MOUNTED FIXTURES MAY BE ACCEPTABLE WITH ARCHITECT'S REVIEW.

GENERAL NOTES	
1.	ENLARGED TOILET PLANS SHOW LOCATION OF TOILET FIXTURES, ACCESSORIES AND NOTES. SEE FLOOR PLAN FOR INFORMATION REGARDING WALL TYPES, CONSTRUCTION NOTES AND ROOM FINISHES.
2.	ALL STUD WALLS SURROUNDING RESTROOMS SHALL HAVE SOUND ATTENUATION BATTING.
3.	DIMENSIONS LOCATING TOILET ACCESSORIES ARE TYPICAL UNLESS NOTED OTHERWISE.
4.	REFER TO FINISH SCHEDULE FOR ROOM FINISHES.
5.	TYPICAL ELEVATIONS ARE SHOWN FOR CLARITY OF FIXTURE AND ACCESSORY LOCATIONS AND HEIGHTS. REFER TO PLANS FOR LOCATIONS.
6.	ALL WALL MOUNTED GRAB BARS, SINKS OR OTHER EQUIPMENT SHALL HAVE BLOCKING INSTALLED AS REQUIRED.

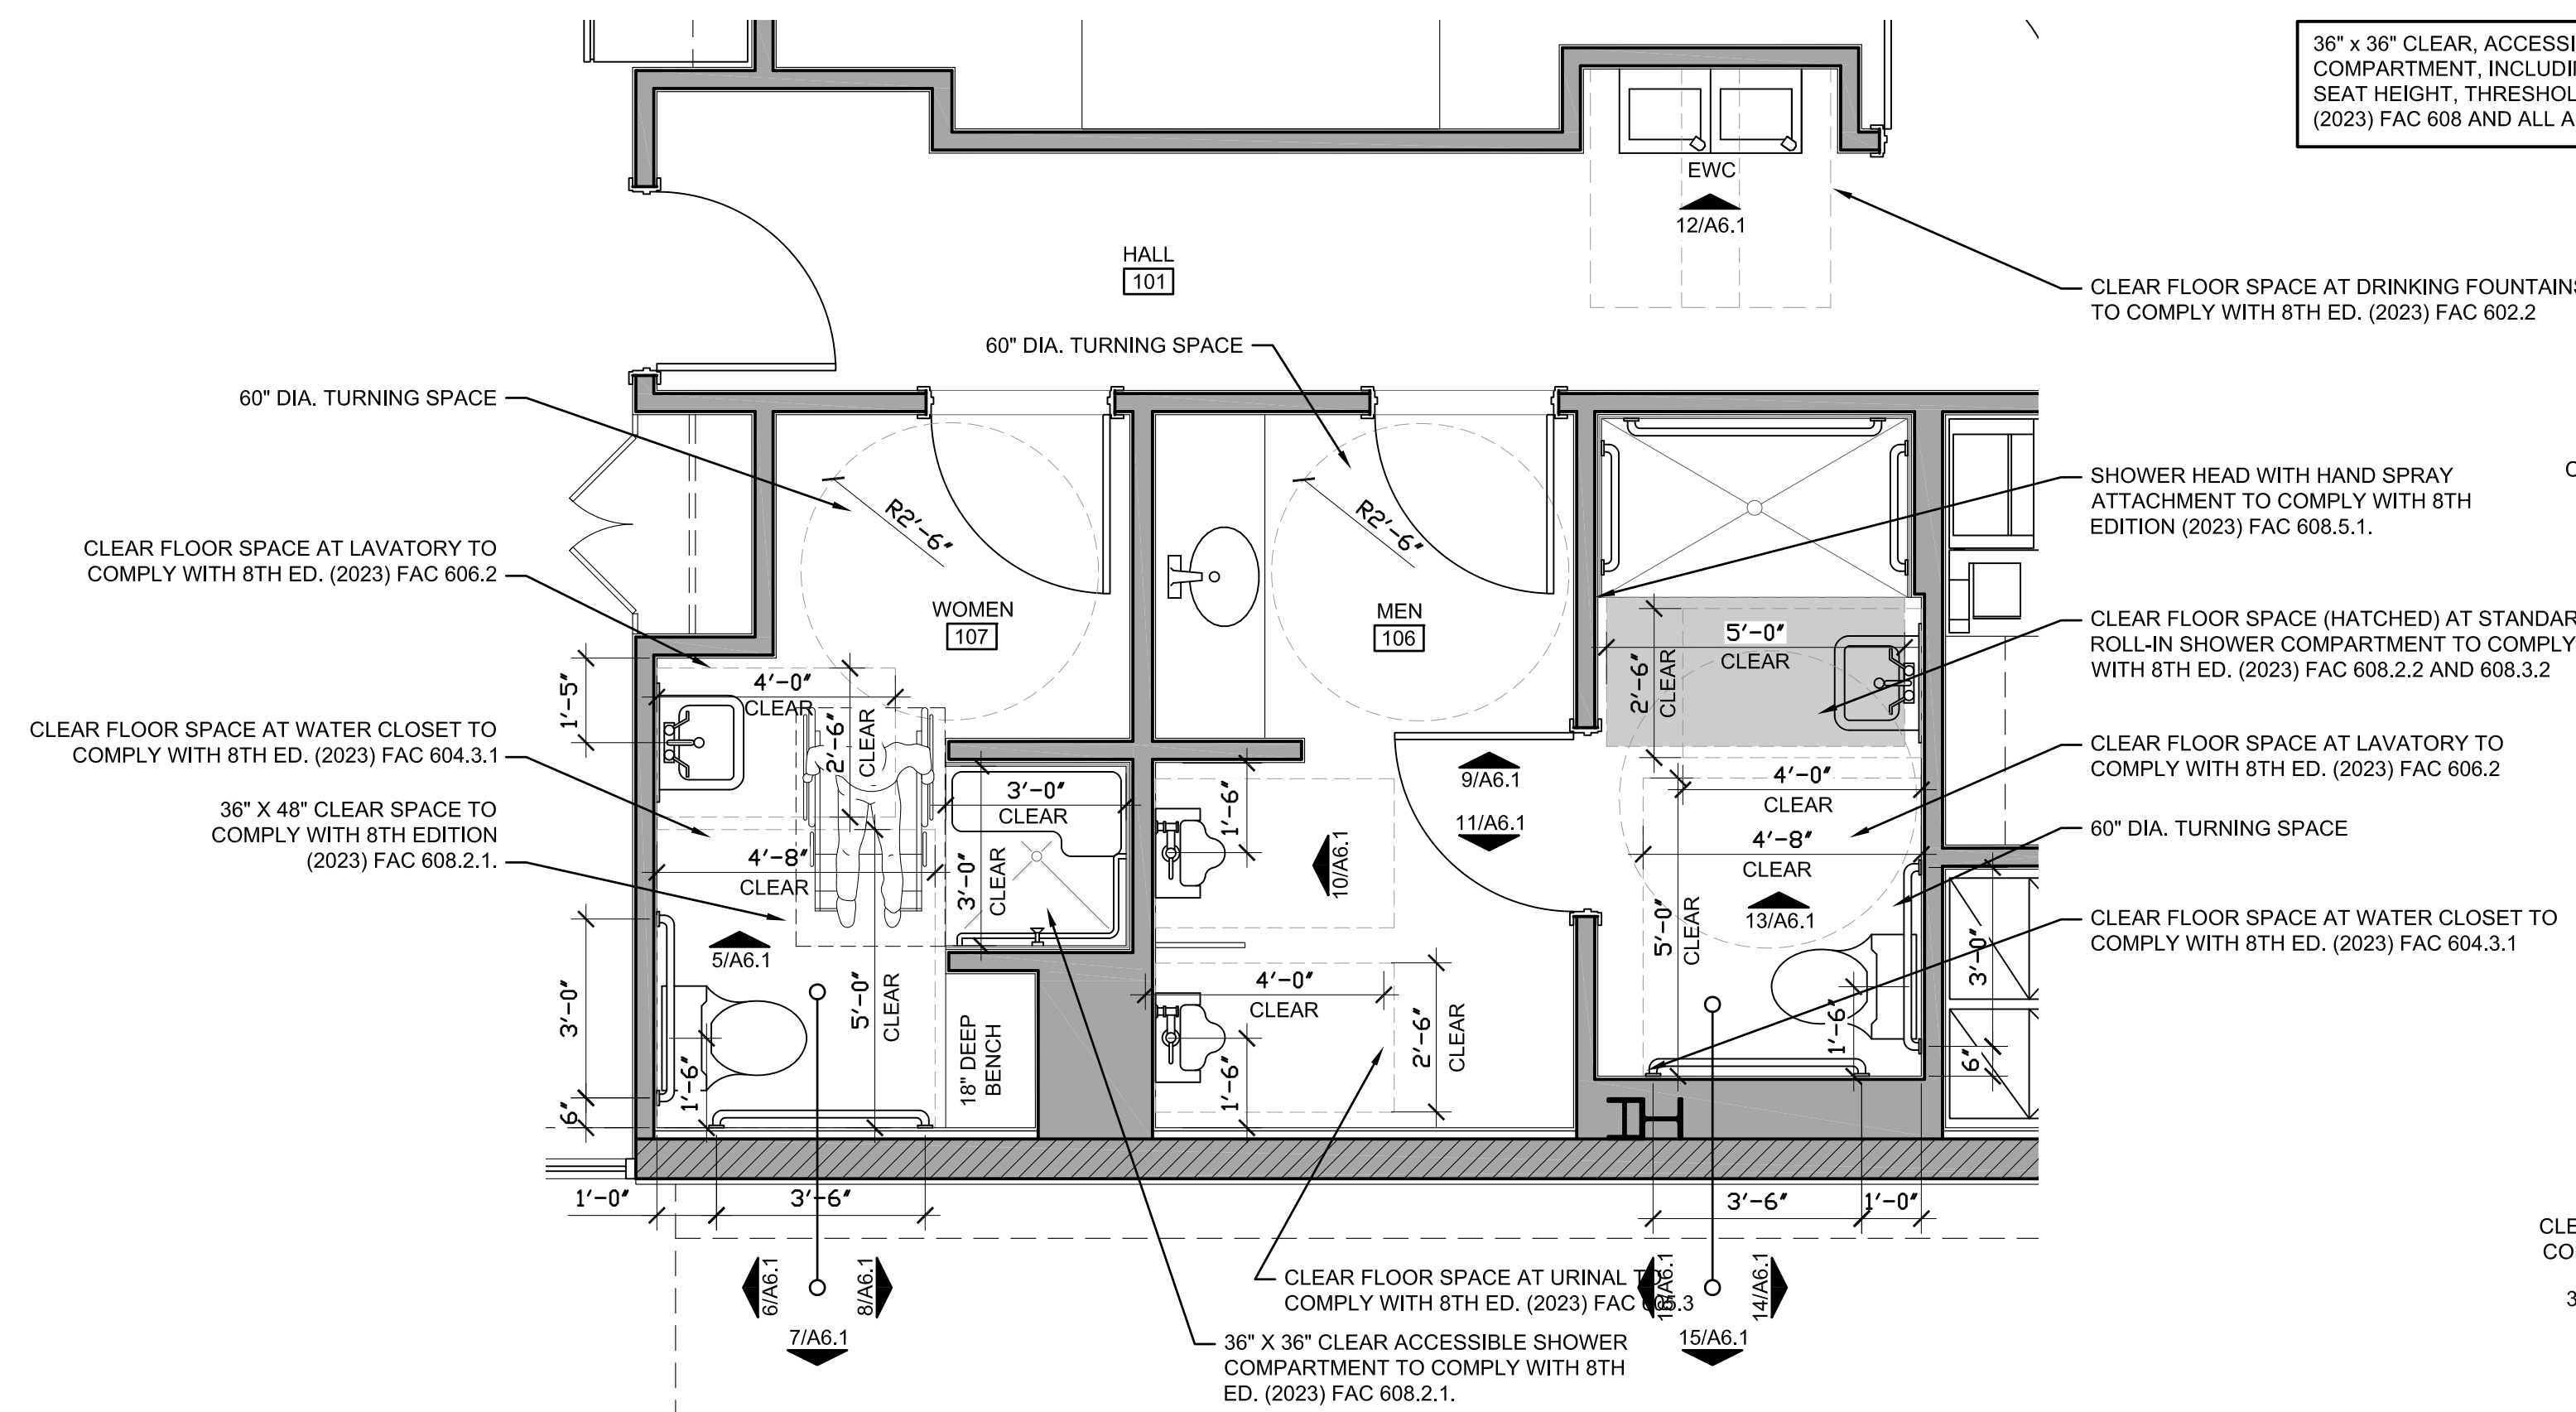


1 ENLARGED RESTROOMS PLAN
A6.0 SCALE 3/8" = 1'-0" MEN 106 AND WOMEN 107

36" x 60" CLEAR, ACCESSIBLE STANDARD ROLL-IN TYPE SHOWER COMPARTMENT, INCLUDING GRAB BARS, CONTROL LOCATIONS, SEAT HEIGHT, THRESHOLD, ETC. SHALL COMPLY WITH 8TH EDITION (2023) FAC 608 AND ALL APPLICABLE CODE SECTIONS.

GRAB BARS SHALL BE DESIGNED TO RESIST A SINGLE CONCENTRATED LOAD OF 250 LBS. 8TH ED. (2023) FBC-8 SECTION 1607.9.2


36" x 36" CLEAR, ACCESSIBLE TRANSFER TYPE SHOWER COMPARTMENT, INCLUDING GRAB BARS, CONTROL LOCATIONS, SEAT HEIGHT, THRESHOLD, ETC. SHALL COMPLY WITH 8TH EDITION (2023) FAC 608 AND ALL APPLICABLE CODE SECTIONS.

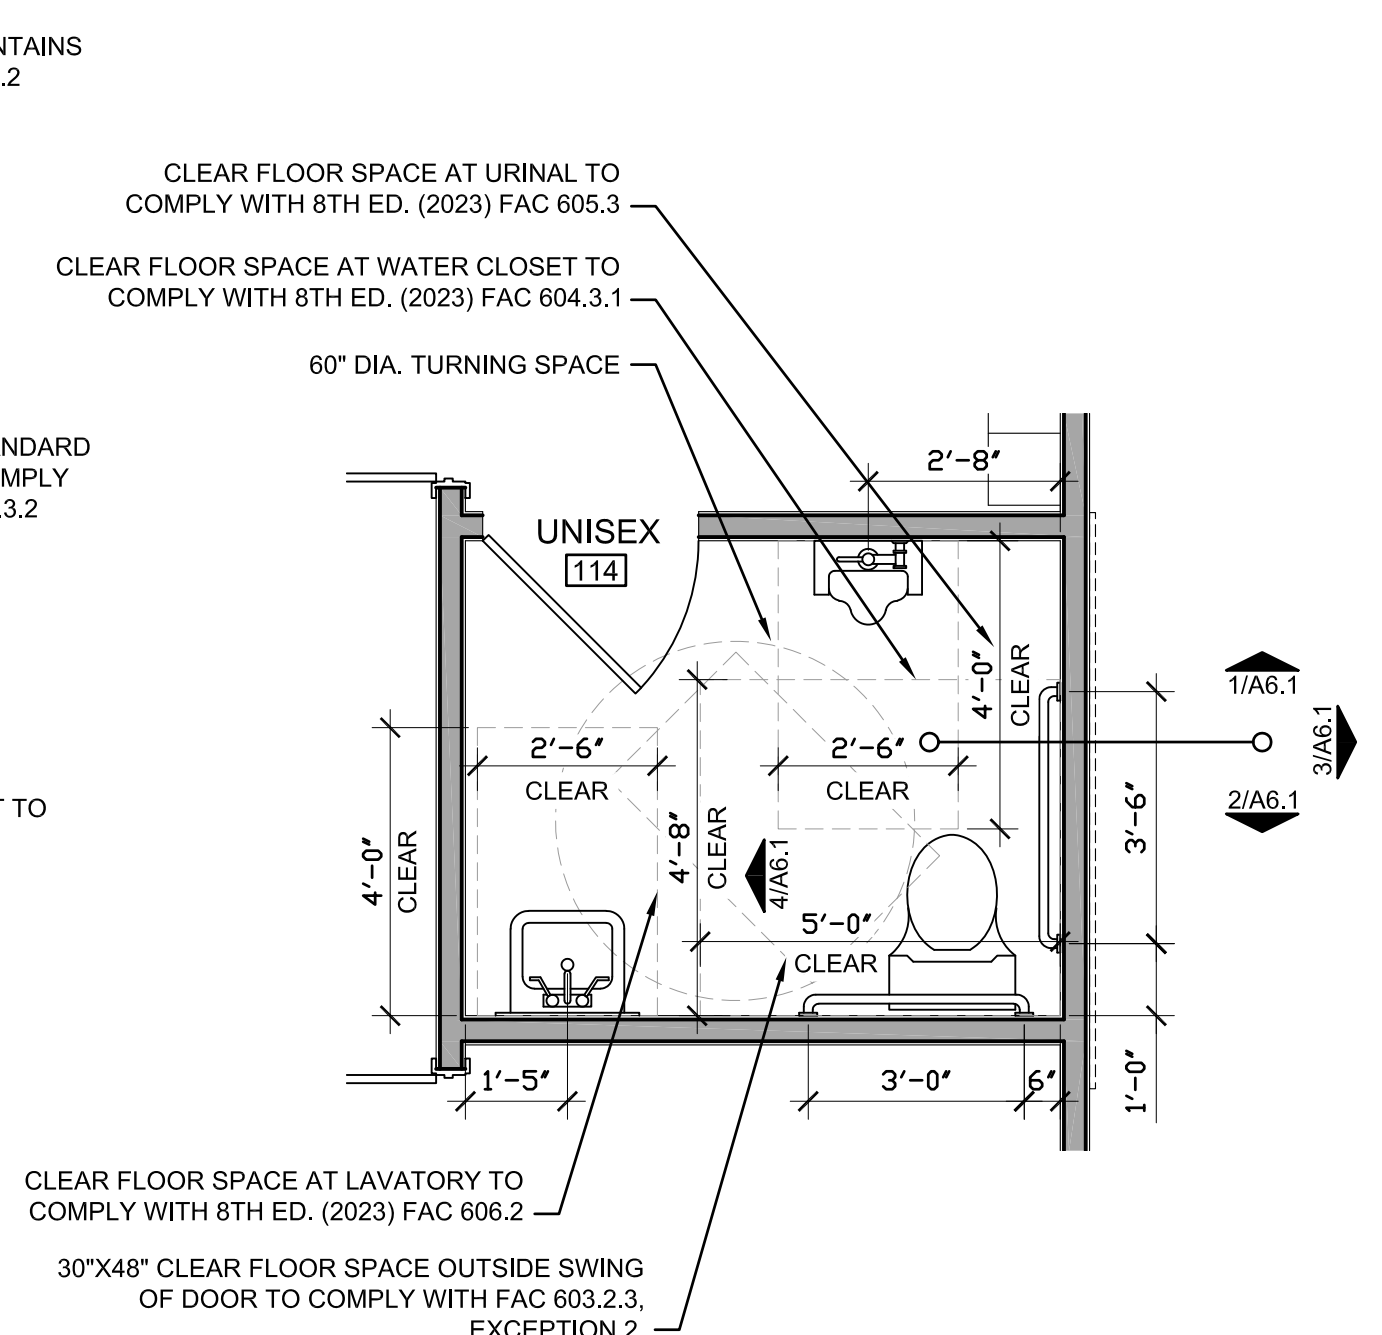


2 ENLARGED RESTROOM PLAN
A6.0 SCALE 3/8" = 1'-0" UNISEX 114 UNISEX 116 SIM. OPP. HAND

SIGNAGE NOTES

RESTROOM GRAPHICS AND OTHER BUILDING SIGNAGE SHALL COMPLY WITH SECTION 703 OF THE 2023 FBC, ACCESSIBILITY, 8TH EDITION.
 CHARACTER PROPORTION: LETTERS AND NUMBERS ON SIGNS SHALL HAVE A WIDTH-TO-HEIGHT RATIO PER 2023 FBC, ACCESSIBILITY, 8TH EDITION, SECTION 703.2.5 AND A STROKE WIDTH-TO-HEIGHT RATIO PER 2017 ICC A117.1 SECTION 703.2.6.
 CHARACTER HEIGHT: CHARACTERS AND NUMBERS ON SIGNS SHALL BE SIZED ACCORDING TO THE VIEWING DISTANCE FROM WHICH THEY ARE TO BE READ. THE MINIMUM HEIGHT IS MEASURED USING AN UPPER CASE "I". LOWER CASE CHARACTERS ARE PERMITTED.
 MINIMUM CHARACTER HEIGHT SHALL BE PER 2023 FBC, ACCESSIBILITY, 8TH EDITION, TABLE 703.2.4.
 RAISED AND BRAILLE CHARACTERS AND PICTORIAL SYMBOL SIGNS (PICTOGRAMS), LETTERS AND NUMERALS SHALL BE RAISED 1/32 INCHES (.8 MM), UPPER CASE, SANS SERIF OR SIMPLE SERIF TYPE AND SHALL BE ACCOMPANIED WITH GRADE 2 BRAILLE. RAISED CHARACTERS SHALL BE AT LEAST 5/8 INCHES (16 MM) HIGH, BUT NO HIGHER THAN 2 INCHES (51 MM). PICTOGRAMS SHALL BE ACCOMPANIED BY THE EQUIVALENT VERBAL DESCRIPTION PLACED DIRECTLY BELOW THE PICTOGRAM. THE BORDER DIMENSION OF THE PICTOGRAM SHALL BE 6 INCHES (152 MM) MINIMUM IN HEIGHT, FINISH AND CONTRAST. THE CHARACTERS AND BACKGROUND OF SIGNS SHALL BE EGGSHELL, MATTE, OR OTHER NON-GLARE FINISH. CHARACTERS AND SYMBOLS SHALL CONTRAST WITH THEIR BACKGROUND-EITHER LIGHT CHARACTERS ON A DARK BACKGROUND OR DARK CHARACTERS ON A LIGHT BACKGROUND.
 MOUNTING LOCATION AND HEIGHT, WHERE PERMANENT IDENTIFICATION IS PROVIDED FOR ROOMS AND SPACES, SIGNS SHALL BE INSTALLED ON THE WALL ADJACENT TO THE LATCH SIDE OF THE DOOR, WHERE THERE IS NO WALL SPACE TO THE LATCH SIDE OF THE DOOR, INCLUDING AT DOUBLE LEAF DOORS, SIGNS SHALL BE PLACED ON THE NEAREST ADJACENT WALL. MOUNTING HEIGHT SHALL BE 60 INCHES (1525 MM) ABOVE THE FINISH FLOOR TO THE CENTERLINE OF THE SIGN. MOUNTING LOCATION FOR SUCH SIGNAGE SHALL BE SO THAT A PERSON MAY APPROACH WITHIN 3 INCHES (76 MM) OF SIGNAGE WITHOUT ENCOUNTERING PROTRUDING OBJECTS OR STANDING WITHIN THE SWING OF A DOOR.

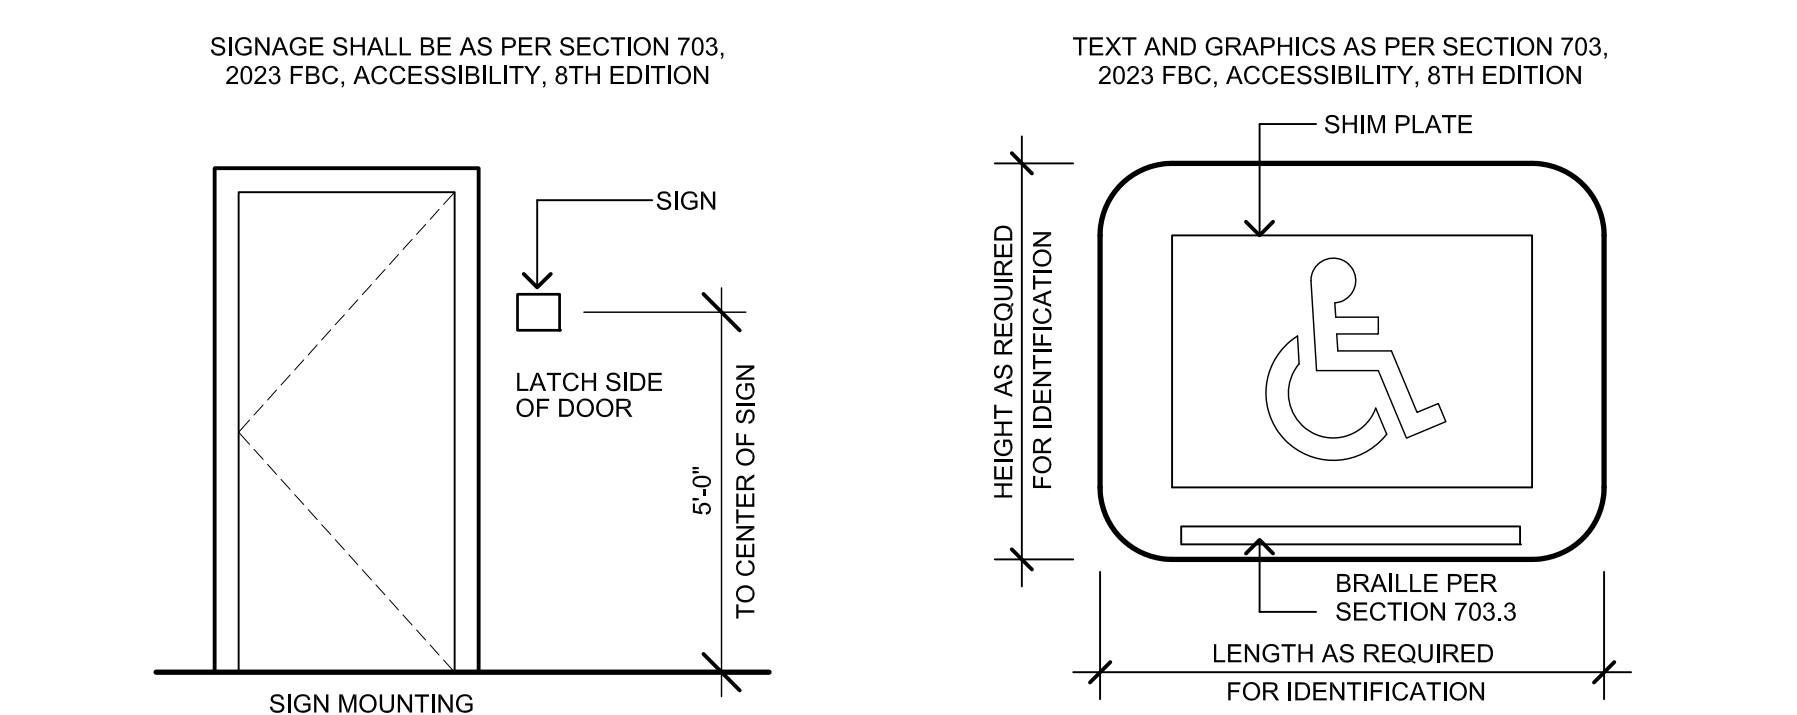


ACCESSIBLE RESTROOM DETAILS & MISCELLANEOUS MOUNTING HEIGHTS

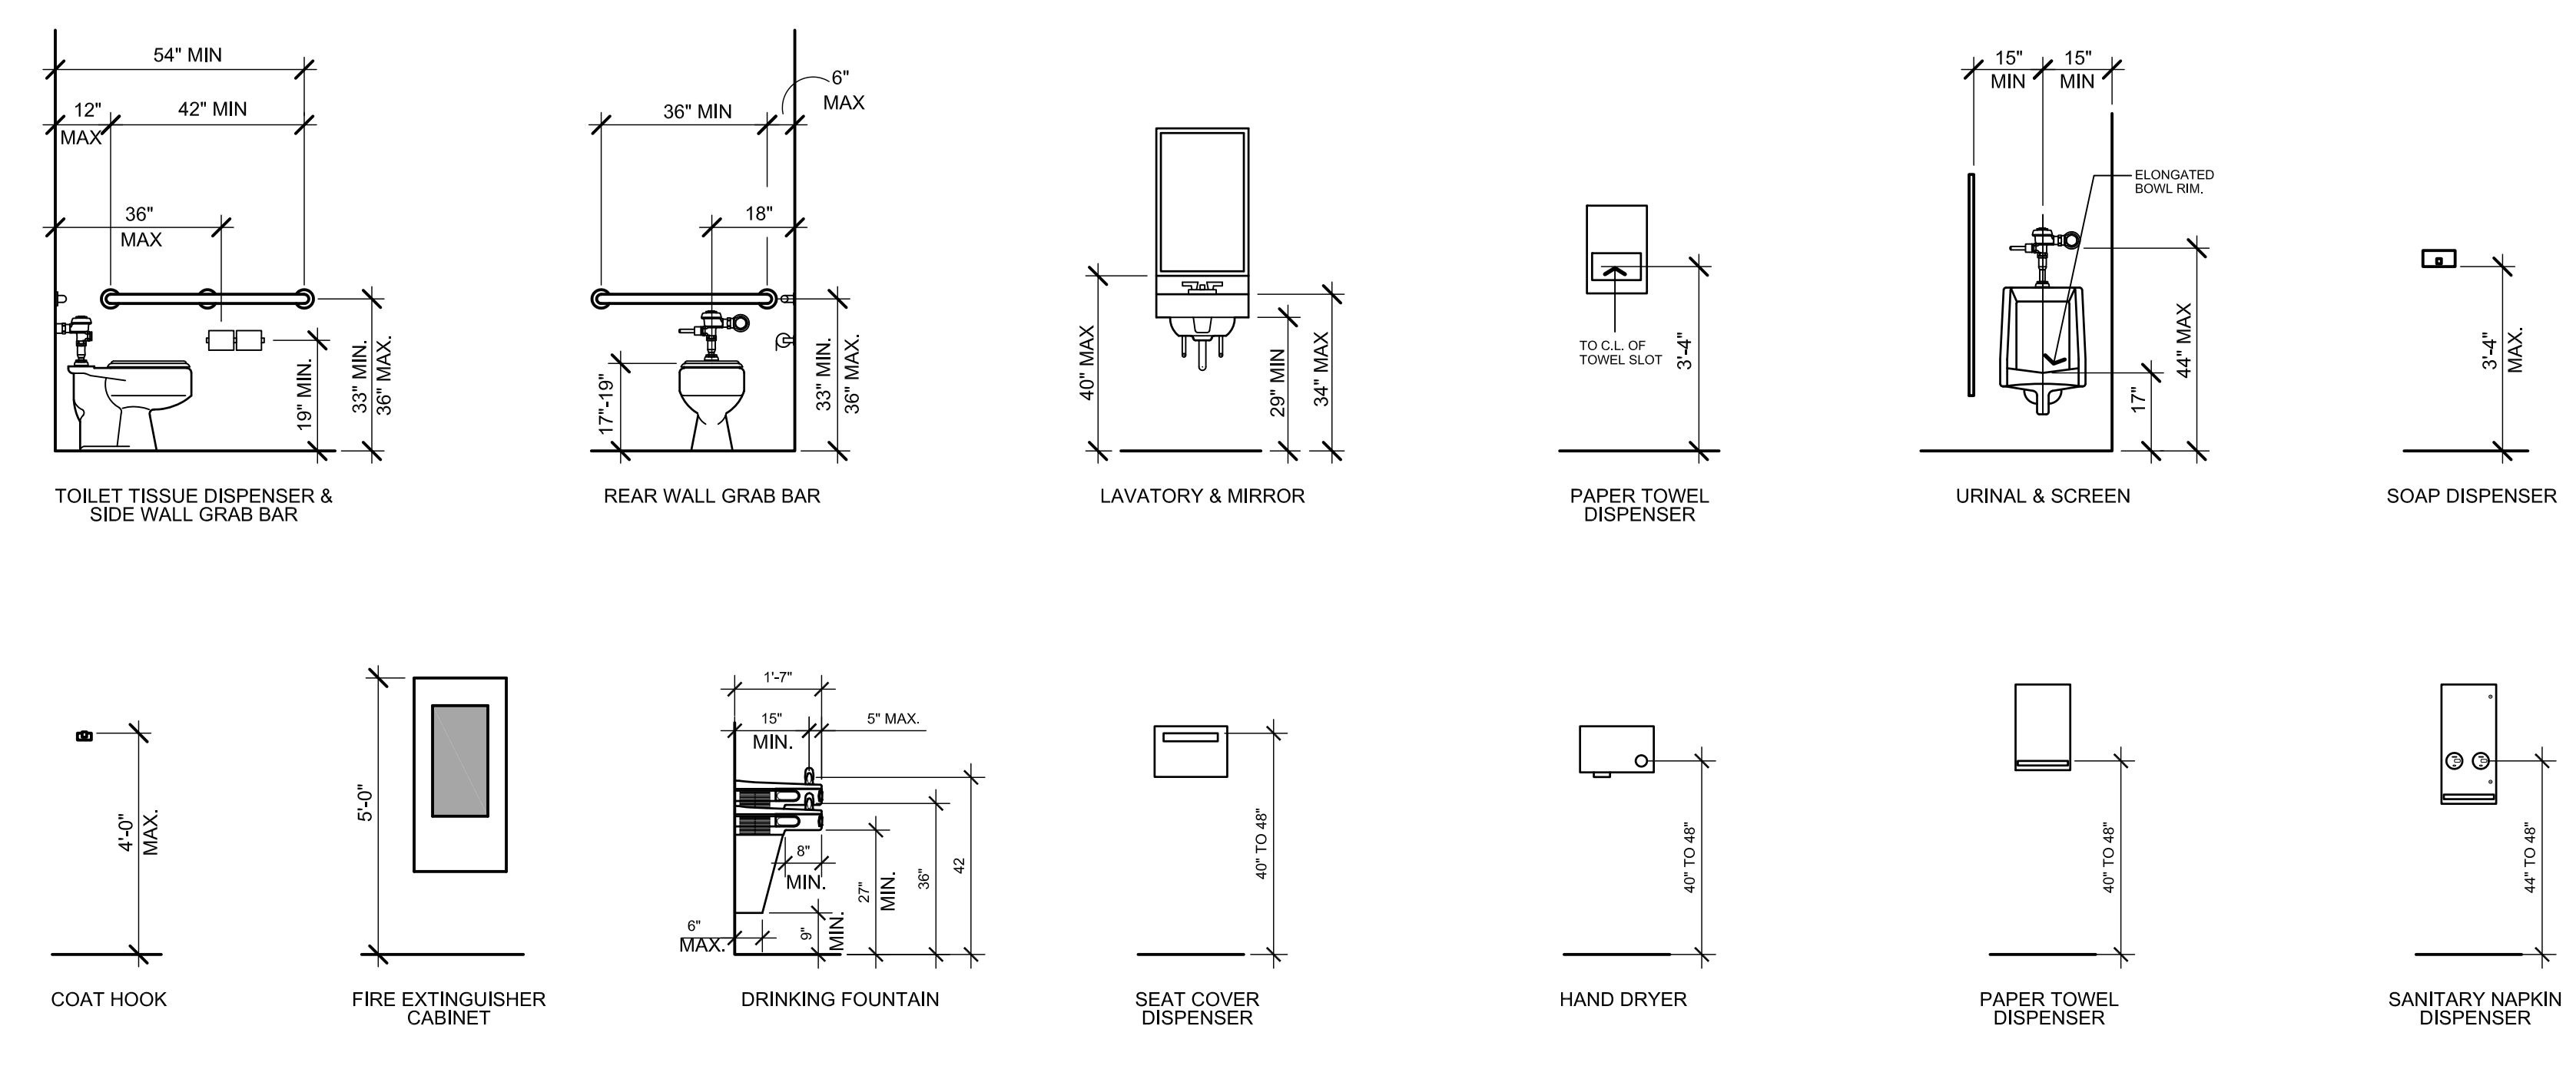


CONN + ARCHITECTS
Tallahassee, Florida 32308 | 850-878-9784
1960-C Buford Boulevard | Lic. No. AA-C001662

DATE: 07-21-24
DRAWN BY: DBC
REVISIONS:
JOB NO.: 23-208
DATE: SHEET NUMBER: A6.0


PRICING SET - NOT FOR CONSTRUCTION

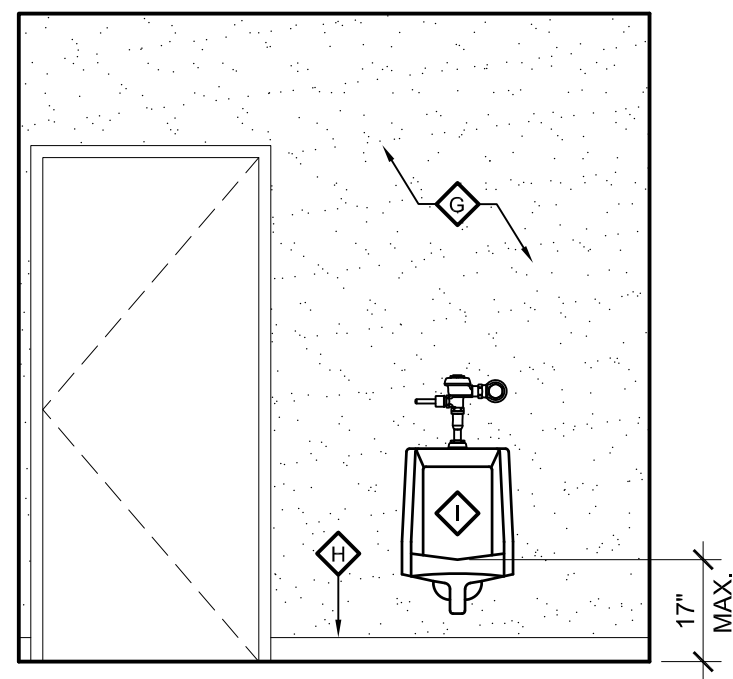


1 ELEVATION: UNISEX 114
 A6.1 SCALE 3/8" = 1'-0"
 UNISEX 116 SIM. OPP. HAND

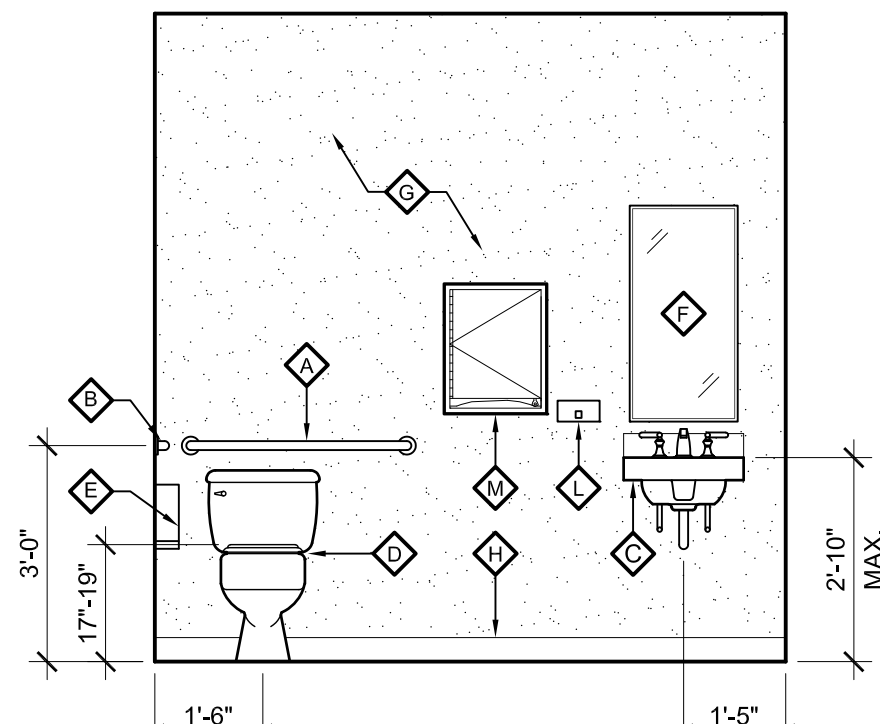


2 ELEVATION: UNISEX 114
 A6.1 SCALE 3/8" = 1'-0"
 UNISEX 116 SIM. OPP. HAND

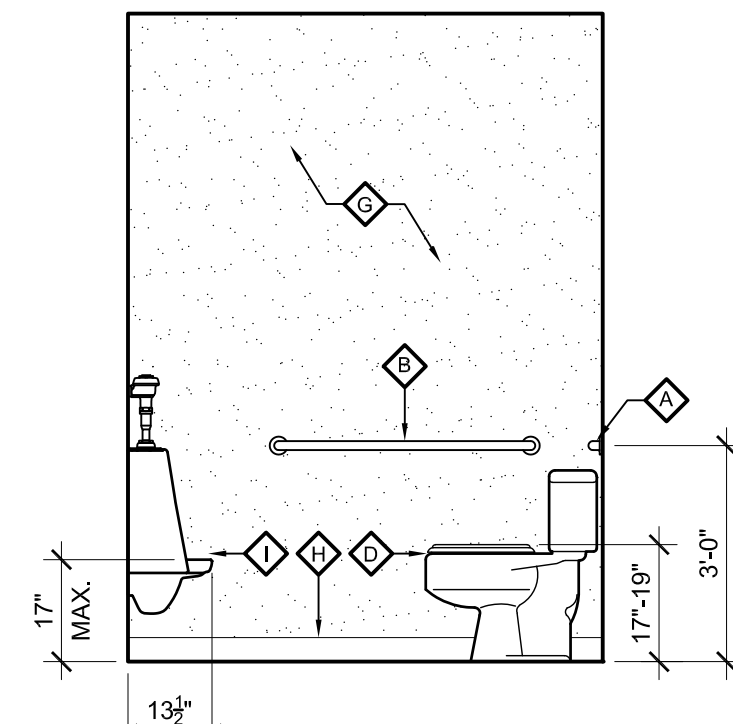


3 ELEVATION: UNISEX 114
 A6.1 SCALE 3/8" = 1'-0"
 UNISEX 116 SIM. OPP. HAND

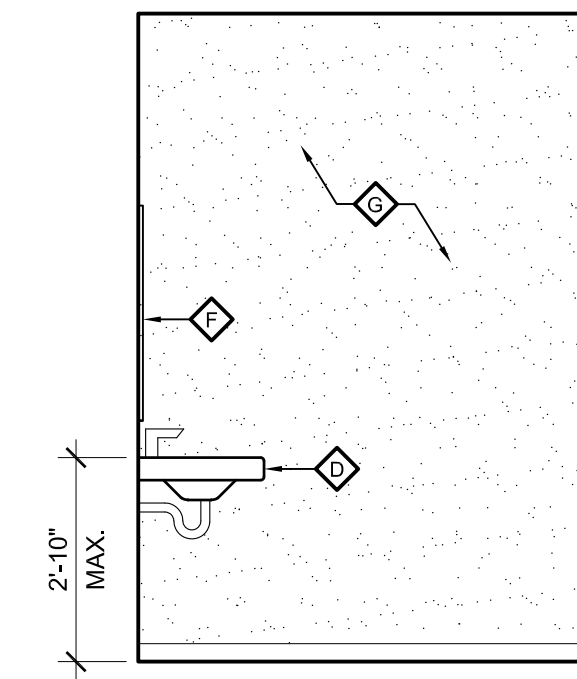


4 ELEVATION: UNISEX 114
 A6.1 SCALE 3/8" = 1'-0"
 UNISEX 116 SIM. OPP. HAND

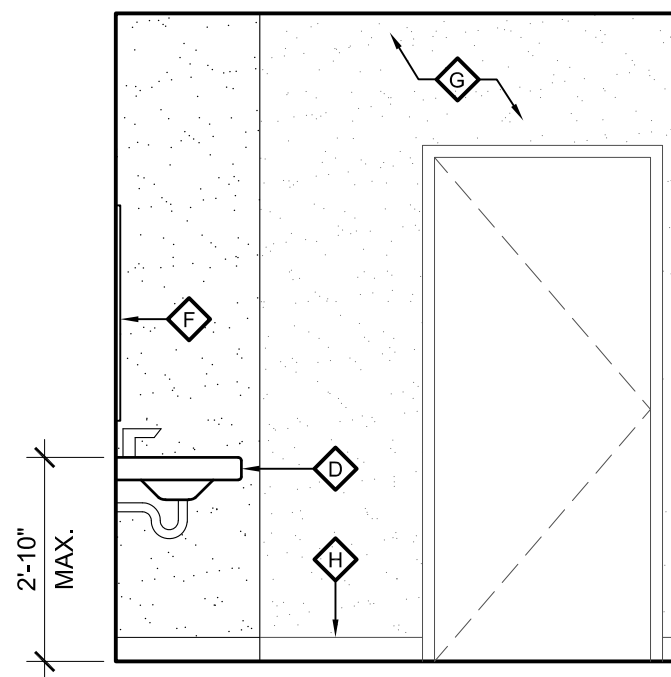


5 ELEVATION: WOMEN 107
 A6.1 SCALE 3/8" = 1'-0"

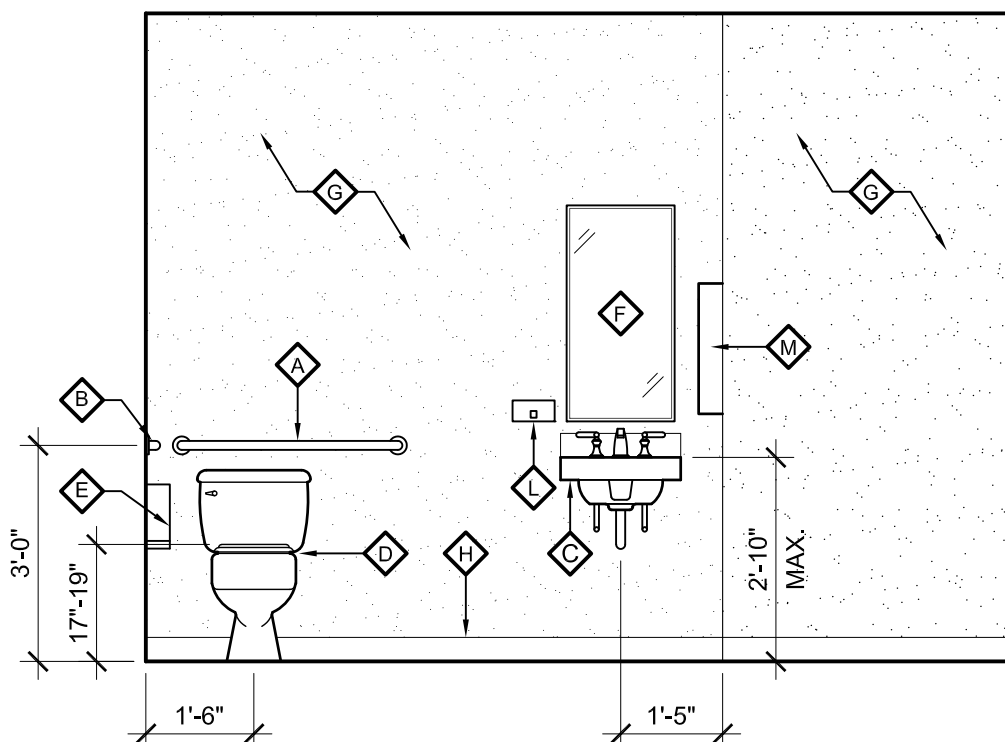


6 ELEVATION: WOMEN 107
 A6.1 SCALE 3/8" = 1'-0"

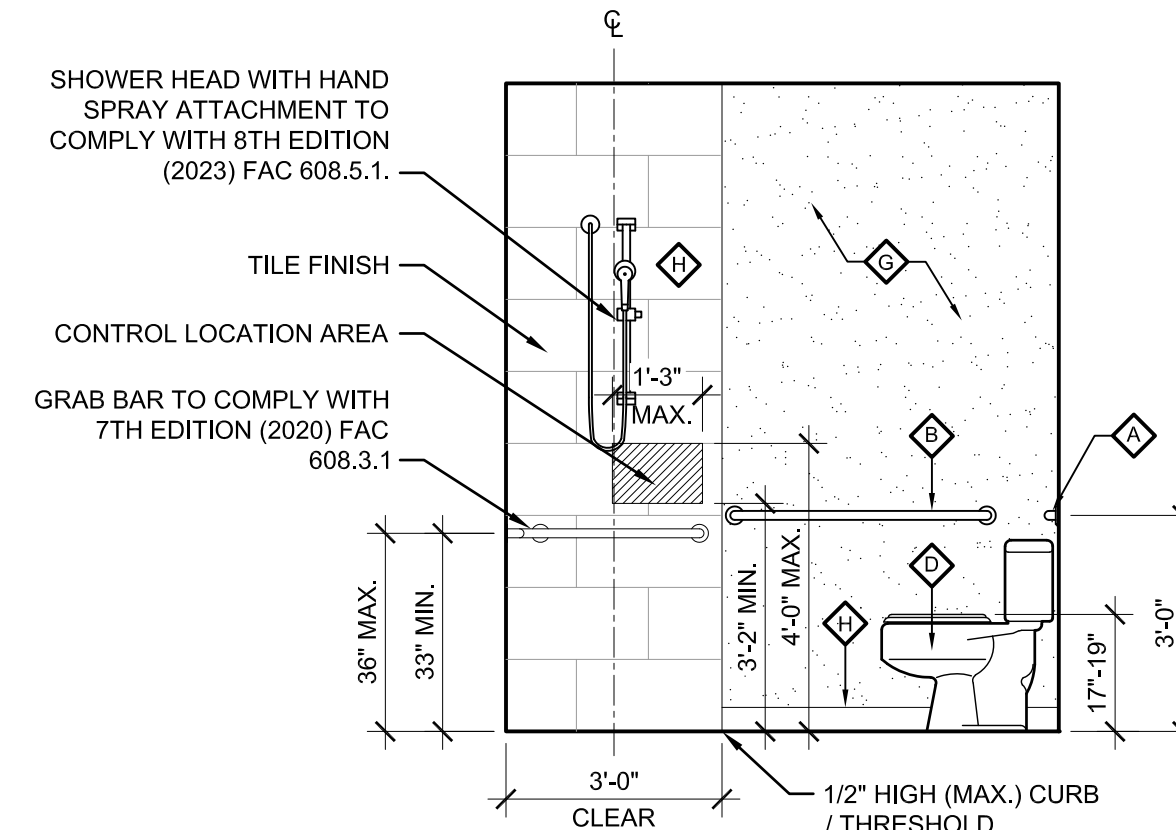


7 ELEVATION: WOMEN 107
 A6.1 SCALE 3/8" = 1'-0"

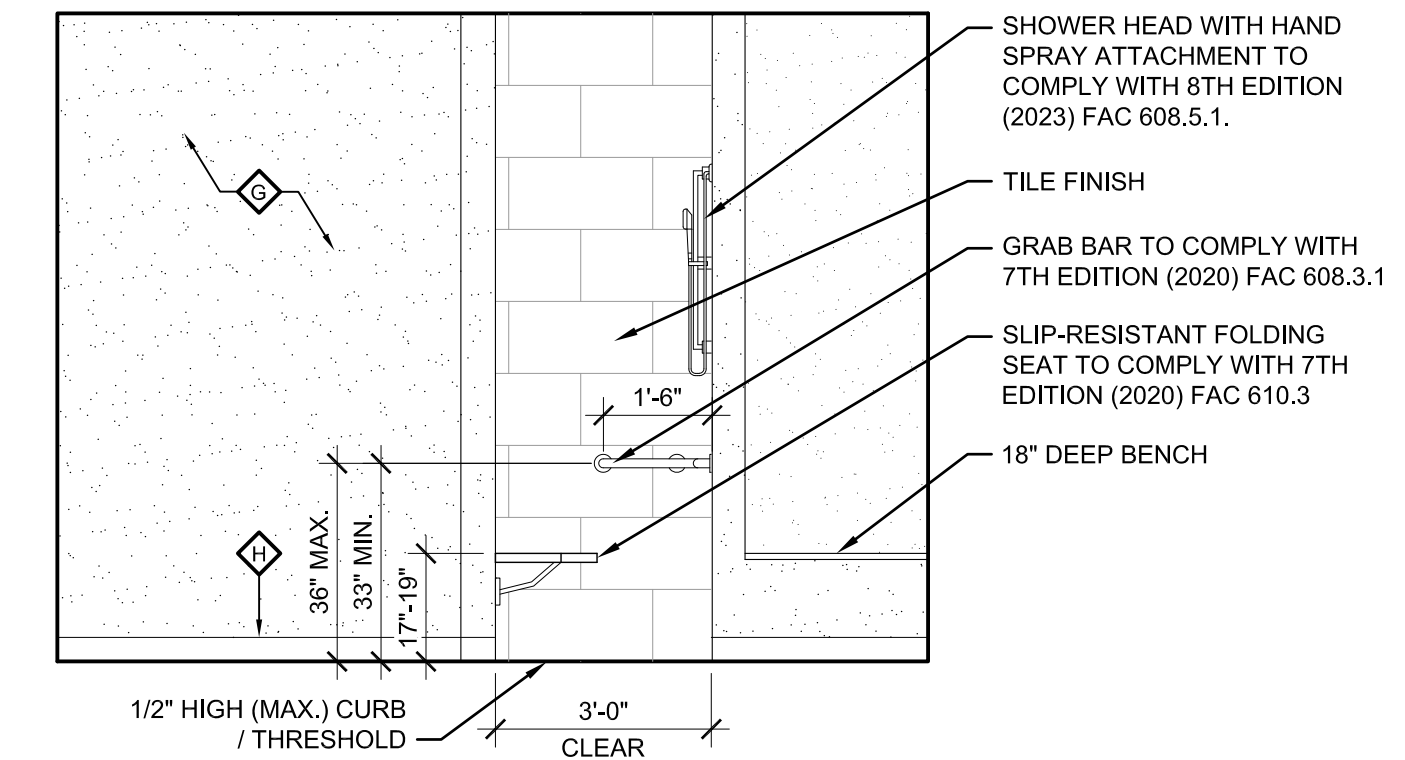


8 ELEVATION: WOMEN 107
 A6.1 SCALE 3/8" = 1'-0"

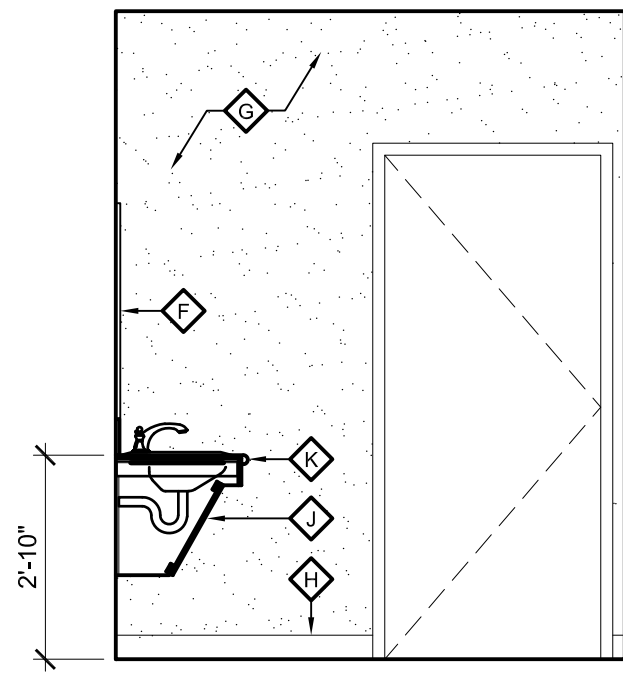


9 ELEVATION: MEN 106
 A6.1 SCALE 3/8" = 1'-0"

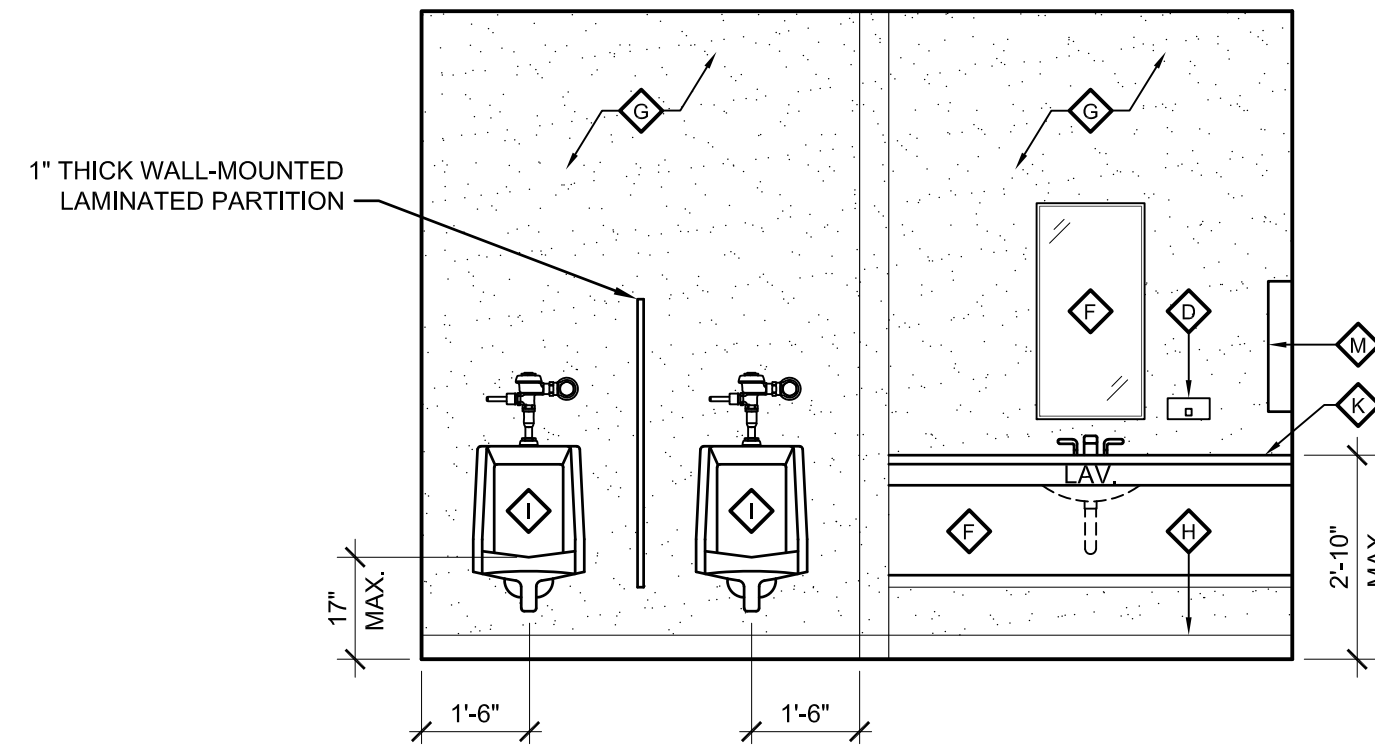


10 ELEVATION: MEN 106
 A6.1 SCALE 3/8" = 1'-0"

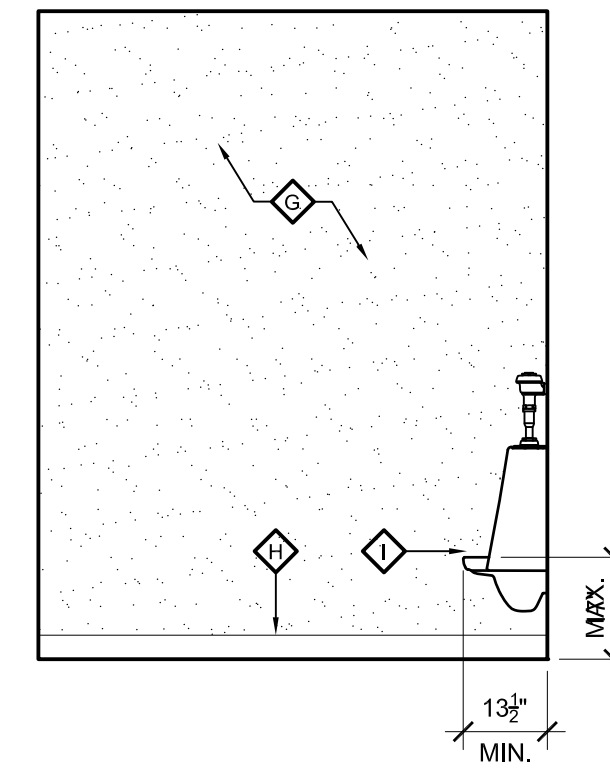


11 ELEVATION: MEN 106
 A6.1 SCALE 3/8" = 1'-0"

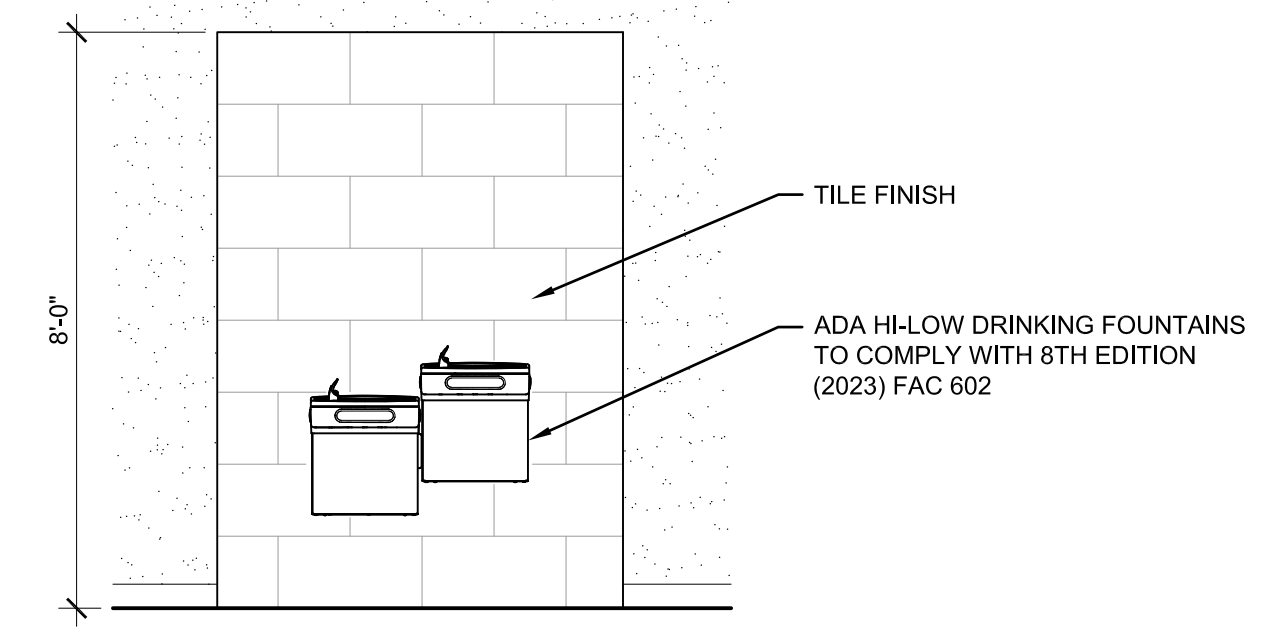


12 ELEVATION: DRINKING FOUNTAINS
 A6.1 SCALE 3/8" = 1'-0"

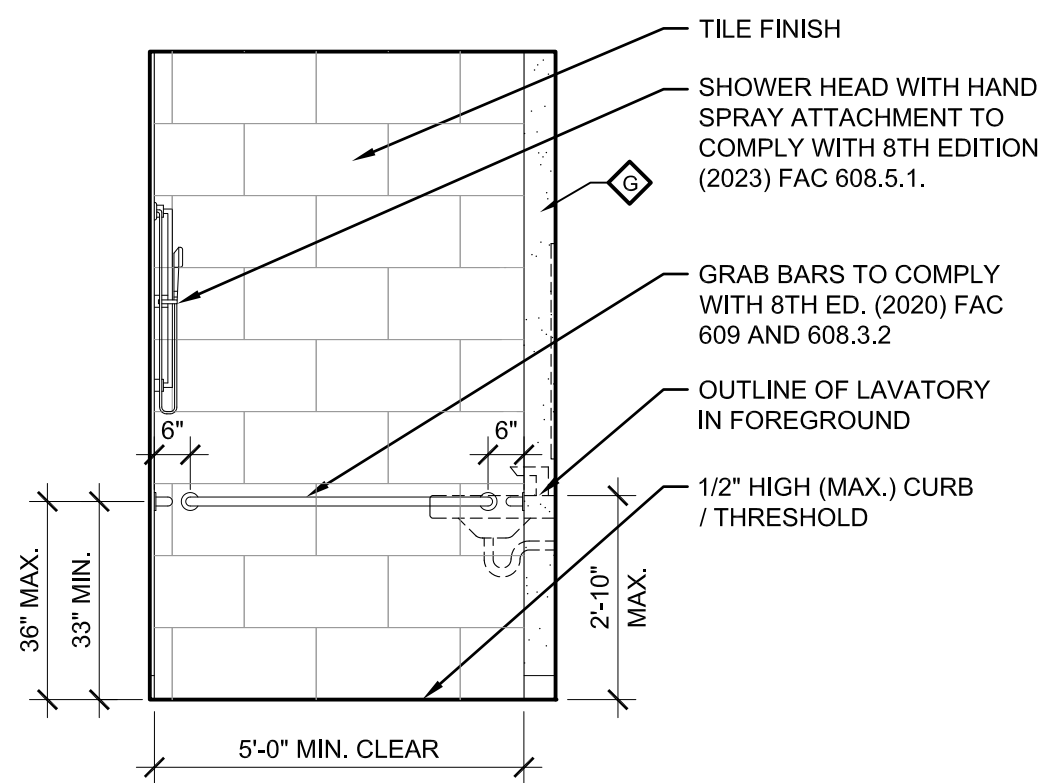


13 ELEVATION: MEN 106
 A6.1 SCALE 3/8" = 1'-0"

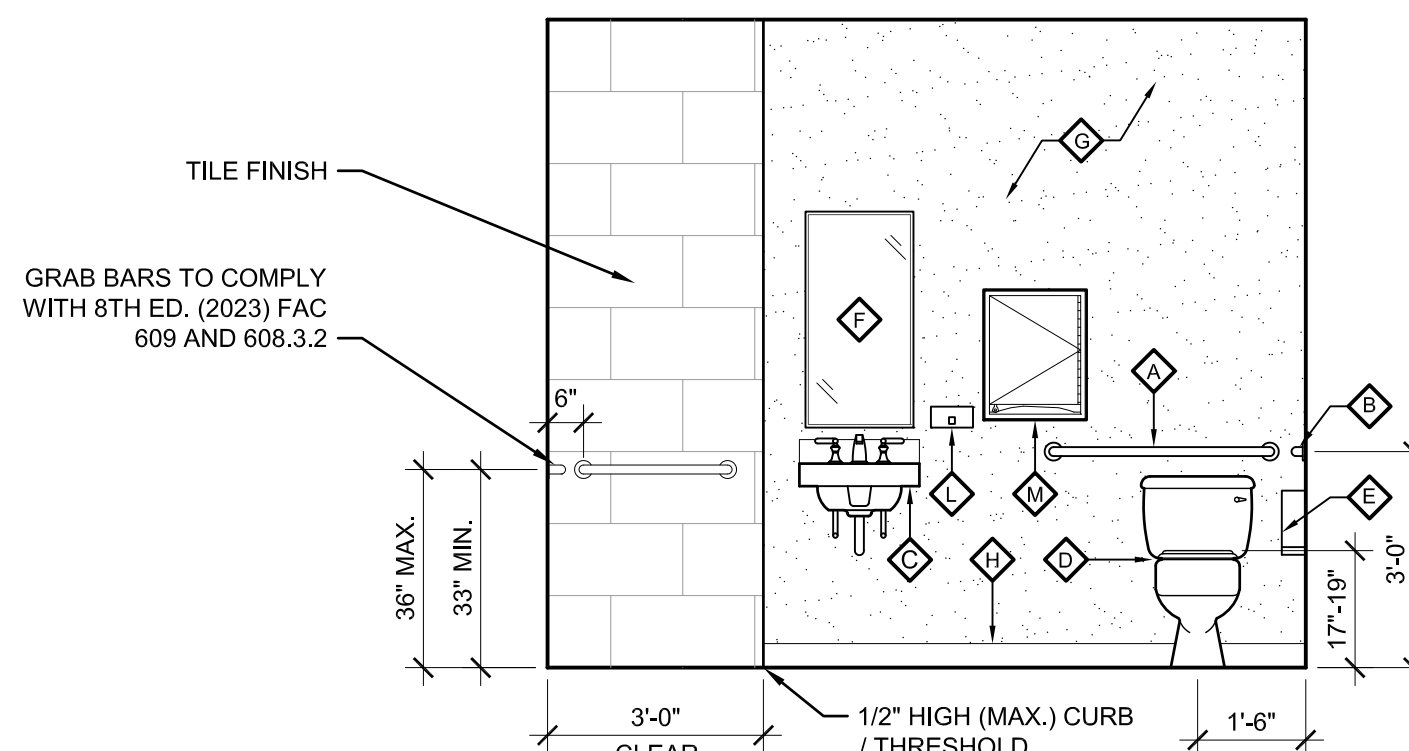

14 ELEVATION: MEN 106
 A6.1 SCALE 3/8" = 1'-0"

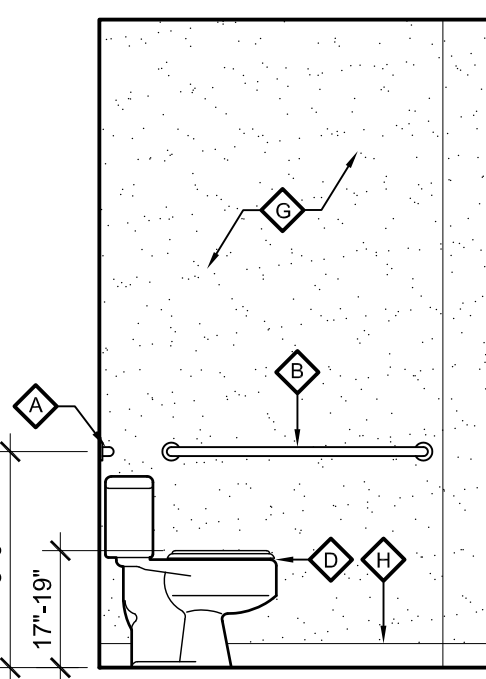

15 ELEVATION: MEN 106
 A6.1 SCALE 3/8" = 1'-0"

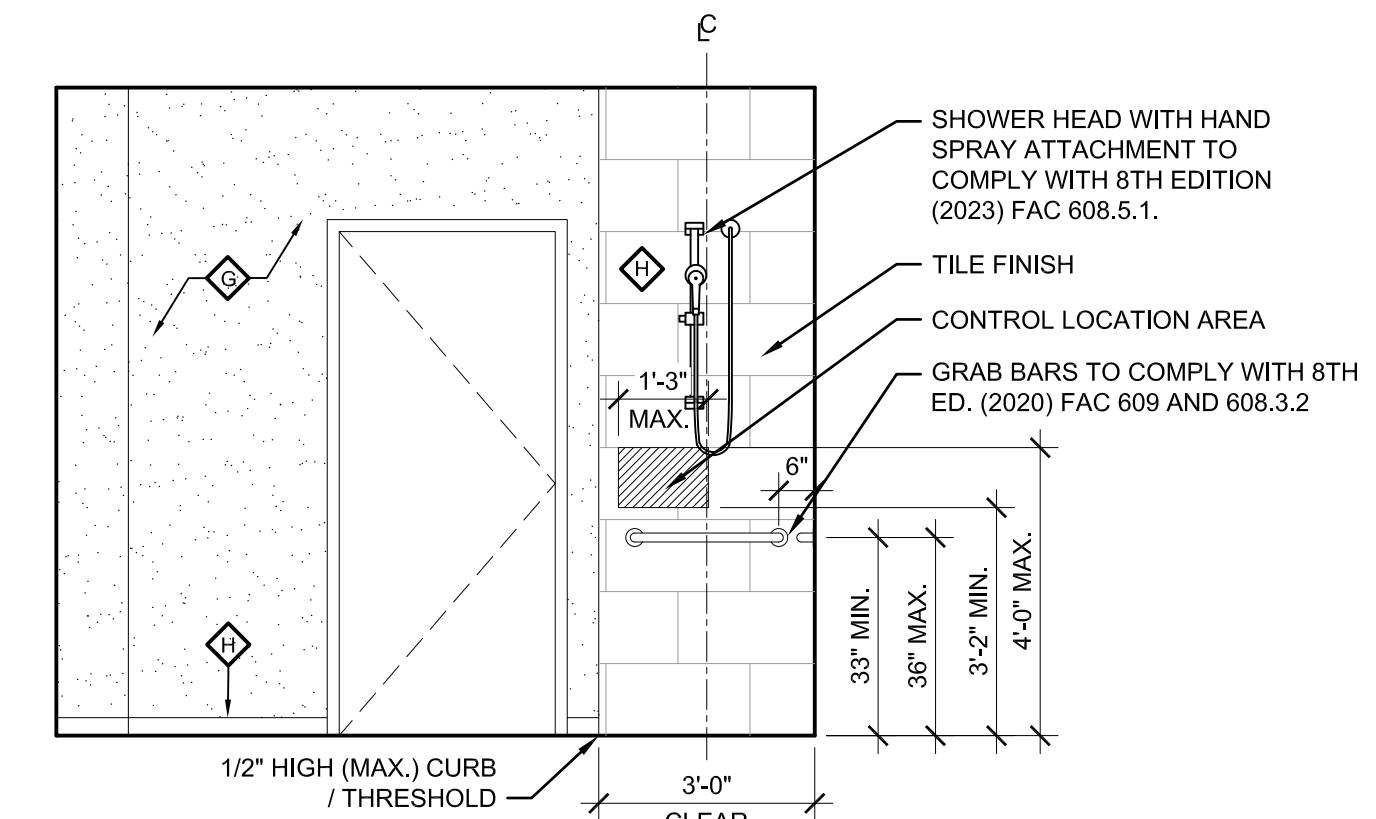


16 ELEVATION: MEN 106
 A6.1 SCALE 3/8" = 1'-0"


DATE	07-21-24
DRAWN BY	DBC
REVISED	
JOB NO.	23-208
DATE	
SHEET NUMBER	A6.1

PRICING SET - NOT FOR CONSTRUCTION


CONNECTION: THIS DOCUMENT IS THE PROPERTY OF CONN + ARCHITECTS. IT IS TO BE USED ONLY FOR THE PROJECT AND SITE SPECIFICALLY IDENTIFIED. ANY REUSE, REPRODUCTION, OR TRANSMISSION OF THIS DOCUMENT IN ANY FORM OR BY ANY MEANS, ELECTRONIC, MECHANICAL, PHOTOCOPIING, RECORDING, OR OTHERWISE, WITHOUT THE PRIOR WRITTEN PERMISSION OF CONN + ARCHITECTS, IS PROHIBITED.

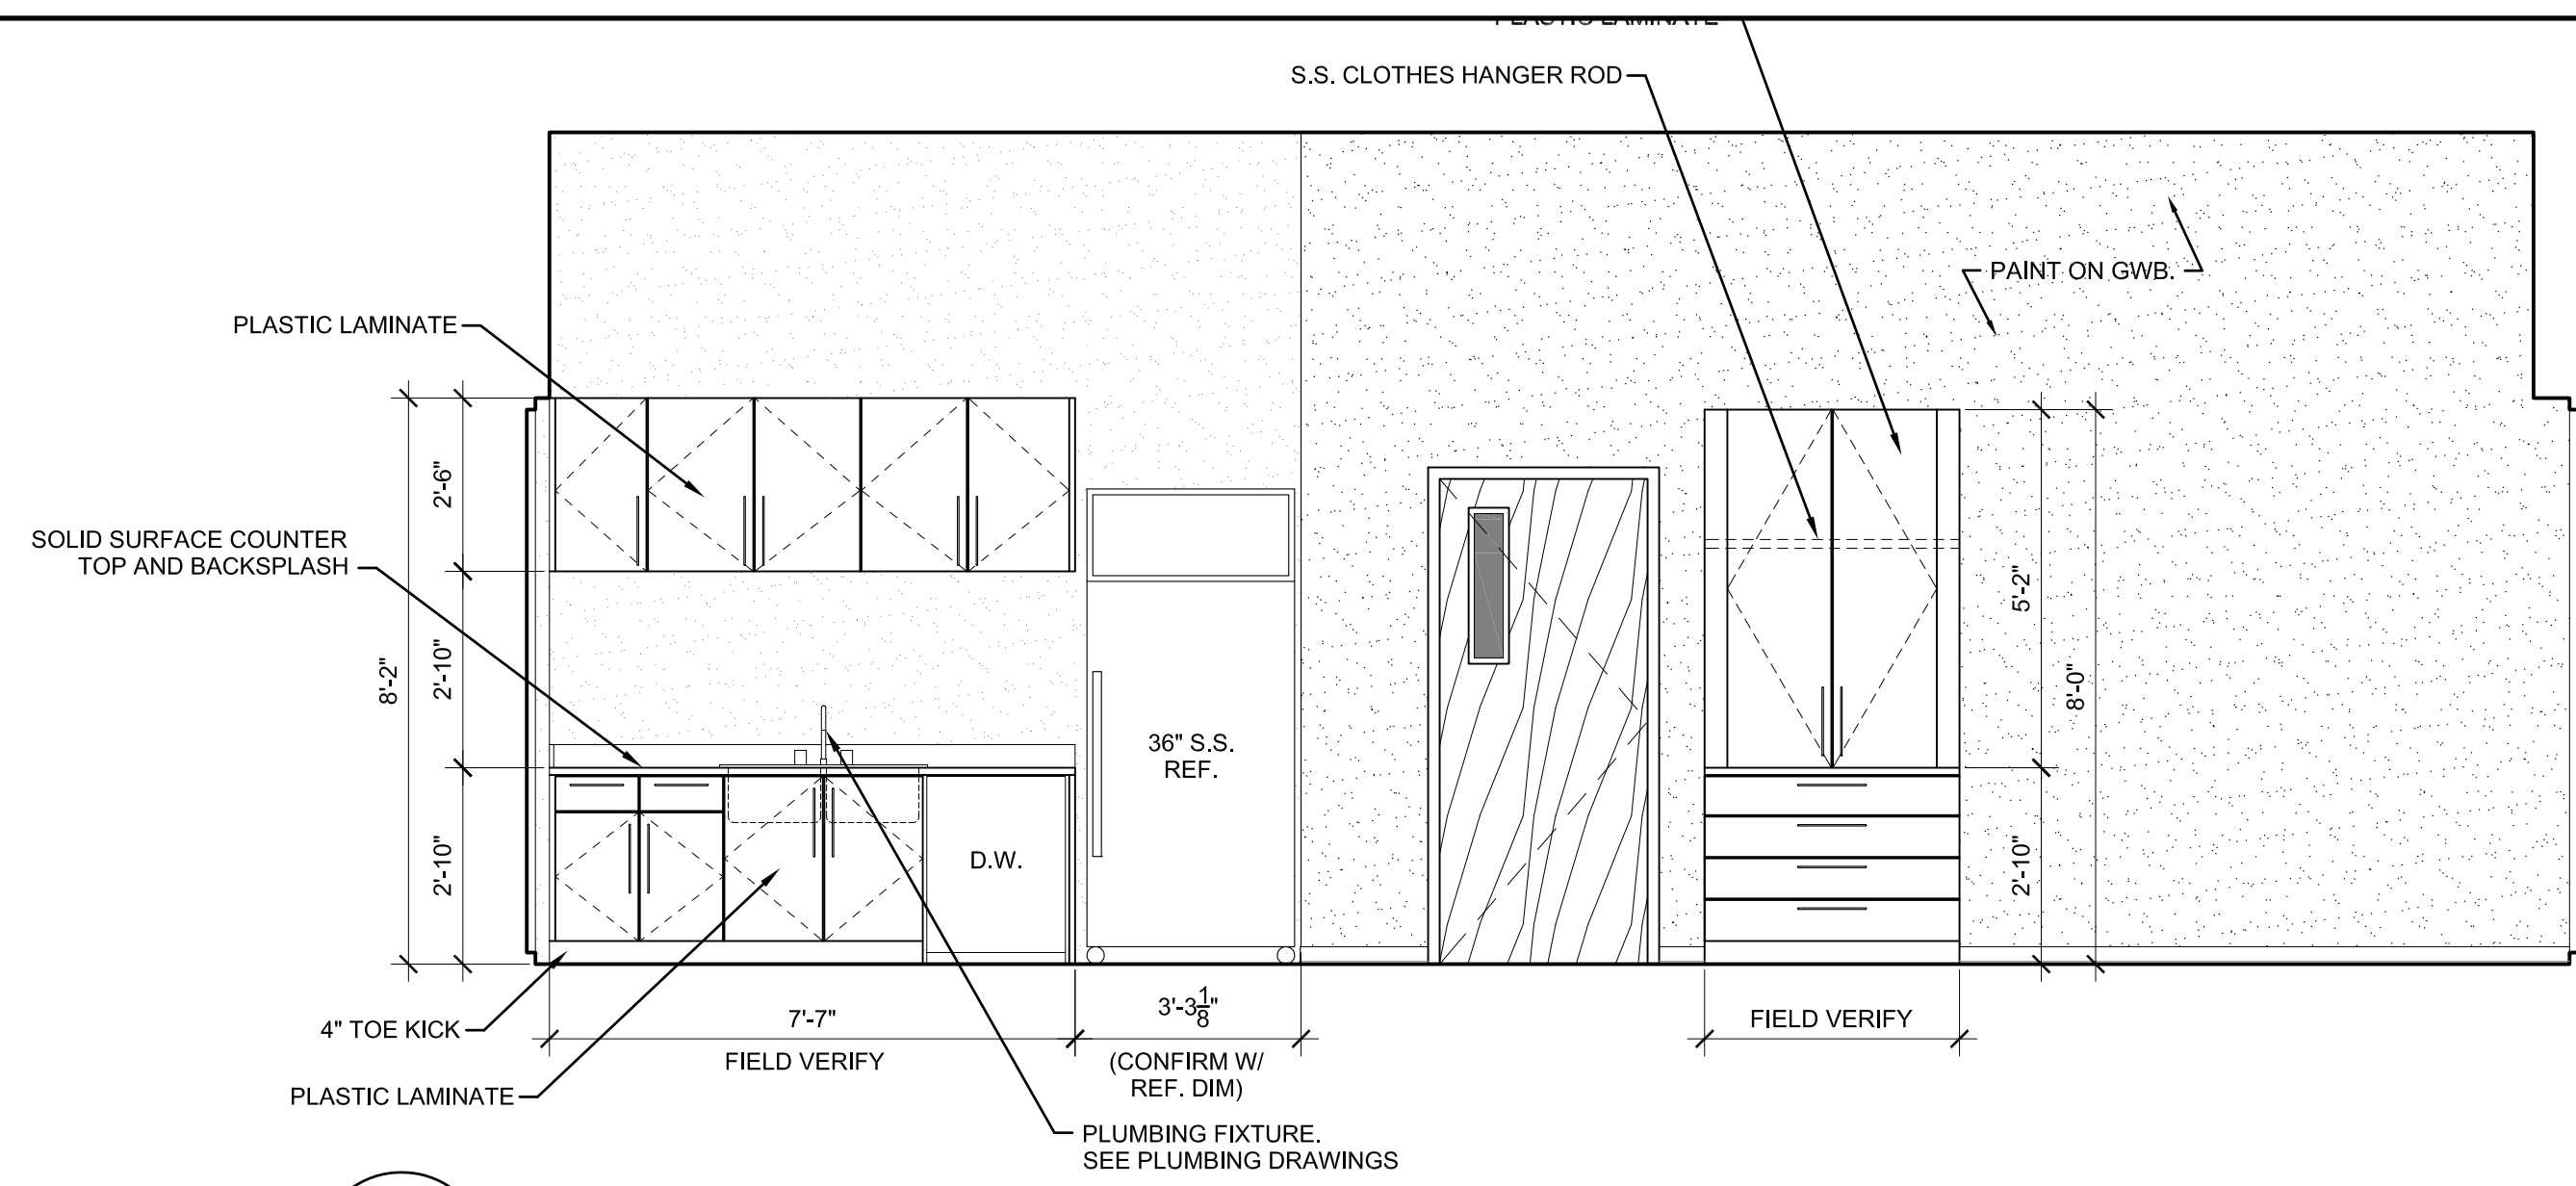


1 INTERIOR ELEVATION
A7.0 SCALE 3/8" = 1'-0" BREAK ROOM 112

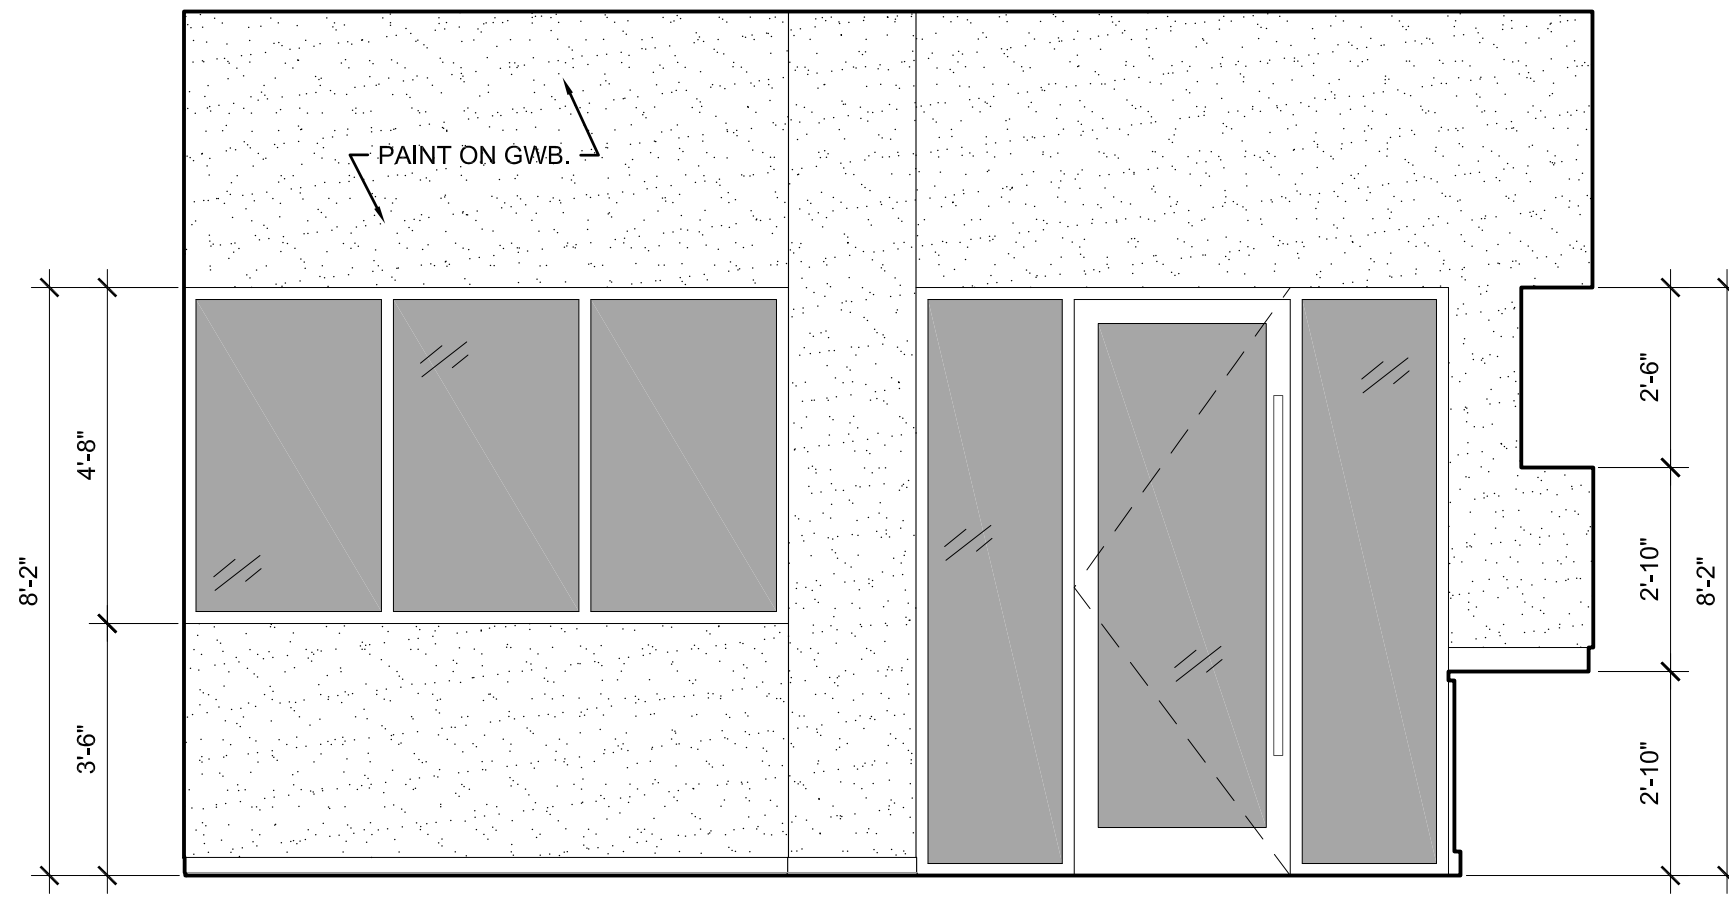


2 INTERIOR ELEVATION
A7.0 SCALE 3/8" = 1'-0" BREAK ROOM 112

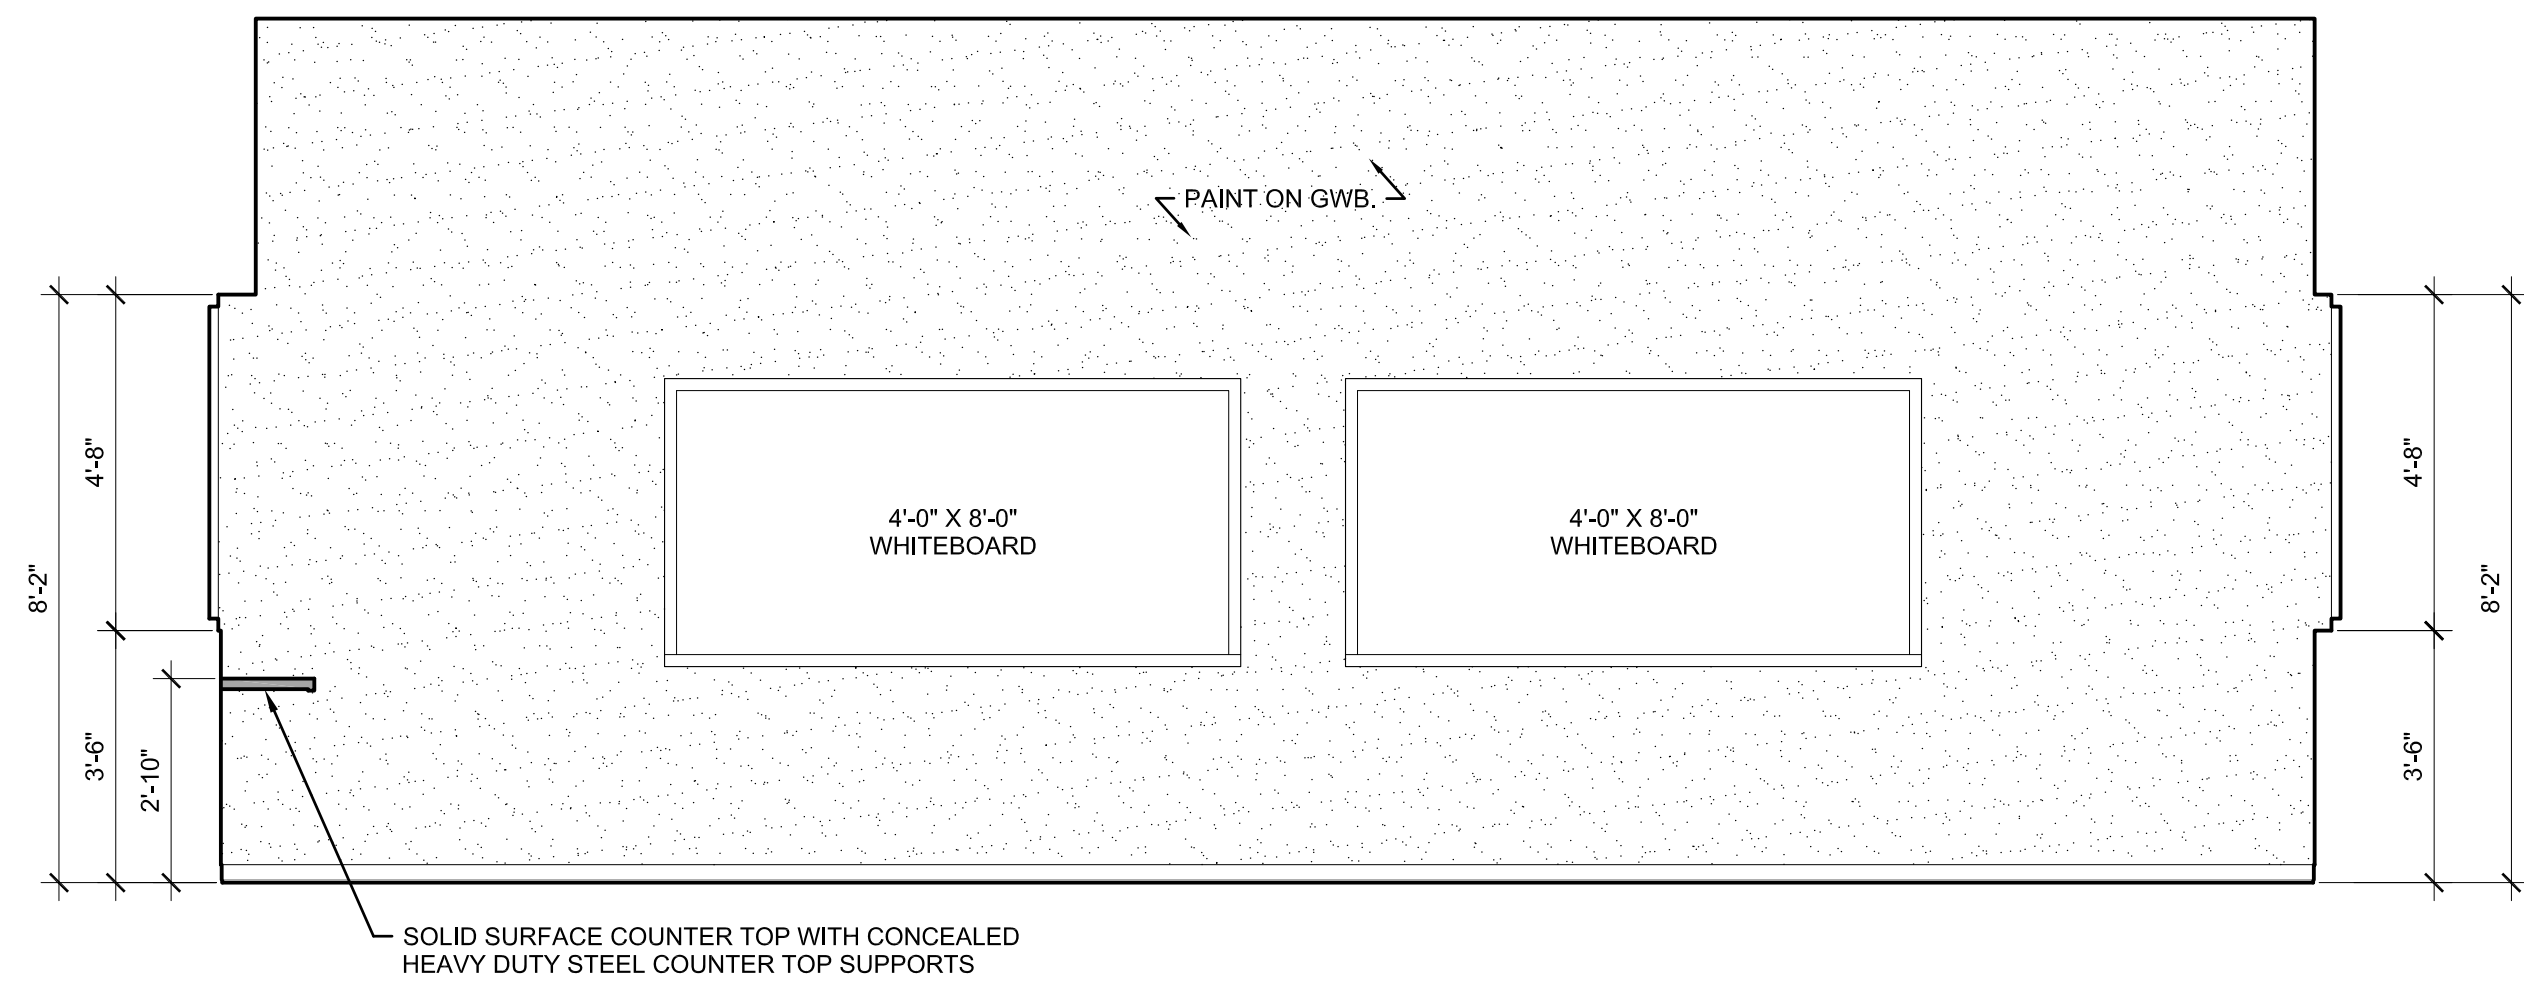


3 INTERIOR ELEVATION
A7.0 SCALE 3/8" = 1'-0" BREAK ROOM 112

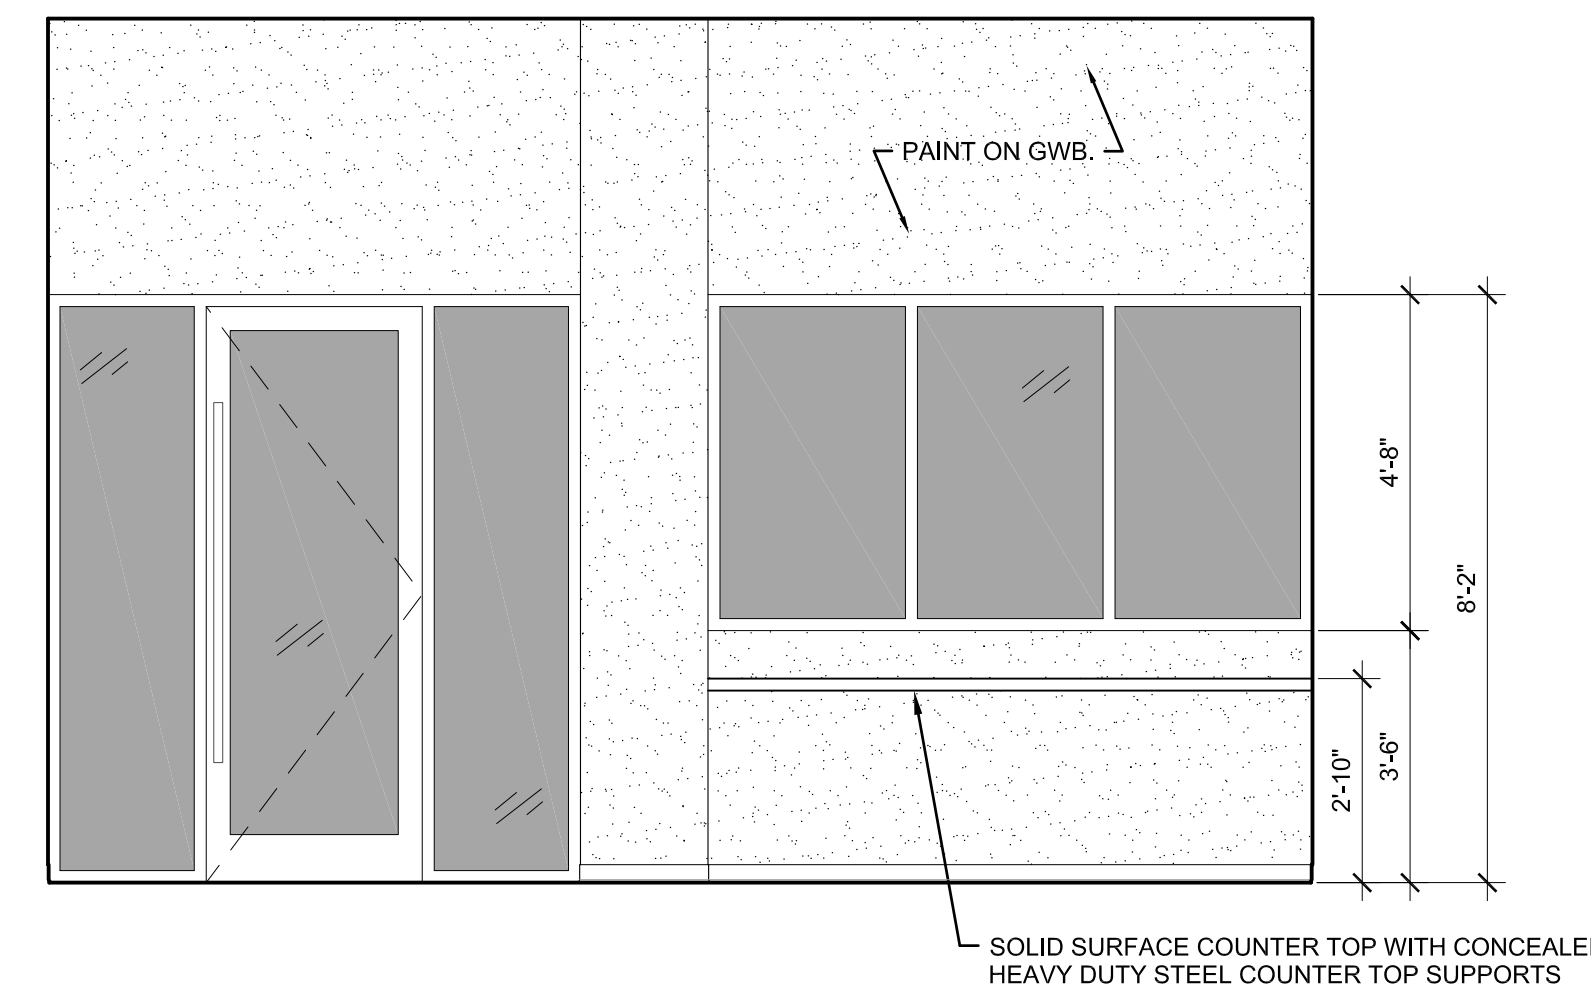


4 INTERIOR ELEVATION
A7.0 SCALE 3/8" = 1'-0" BREAK ROOM 112

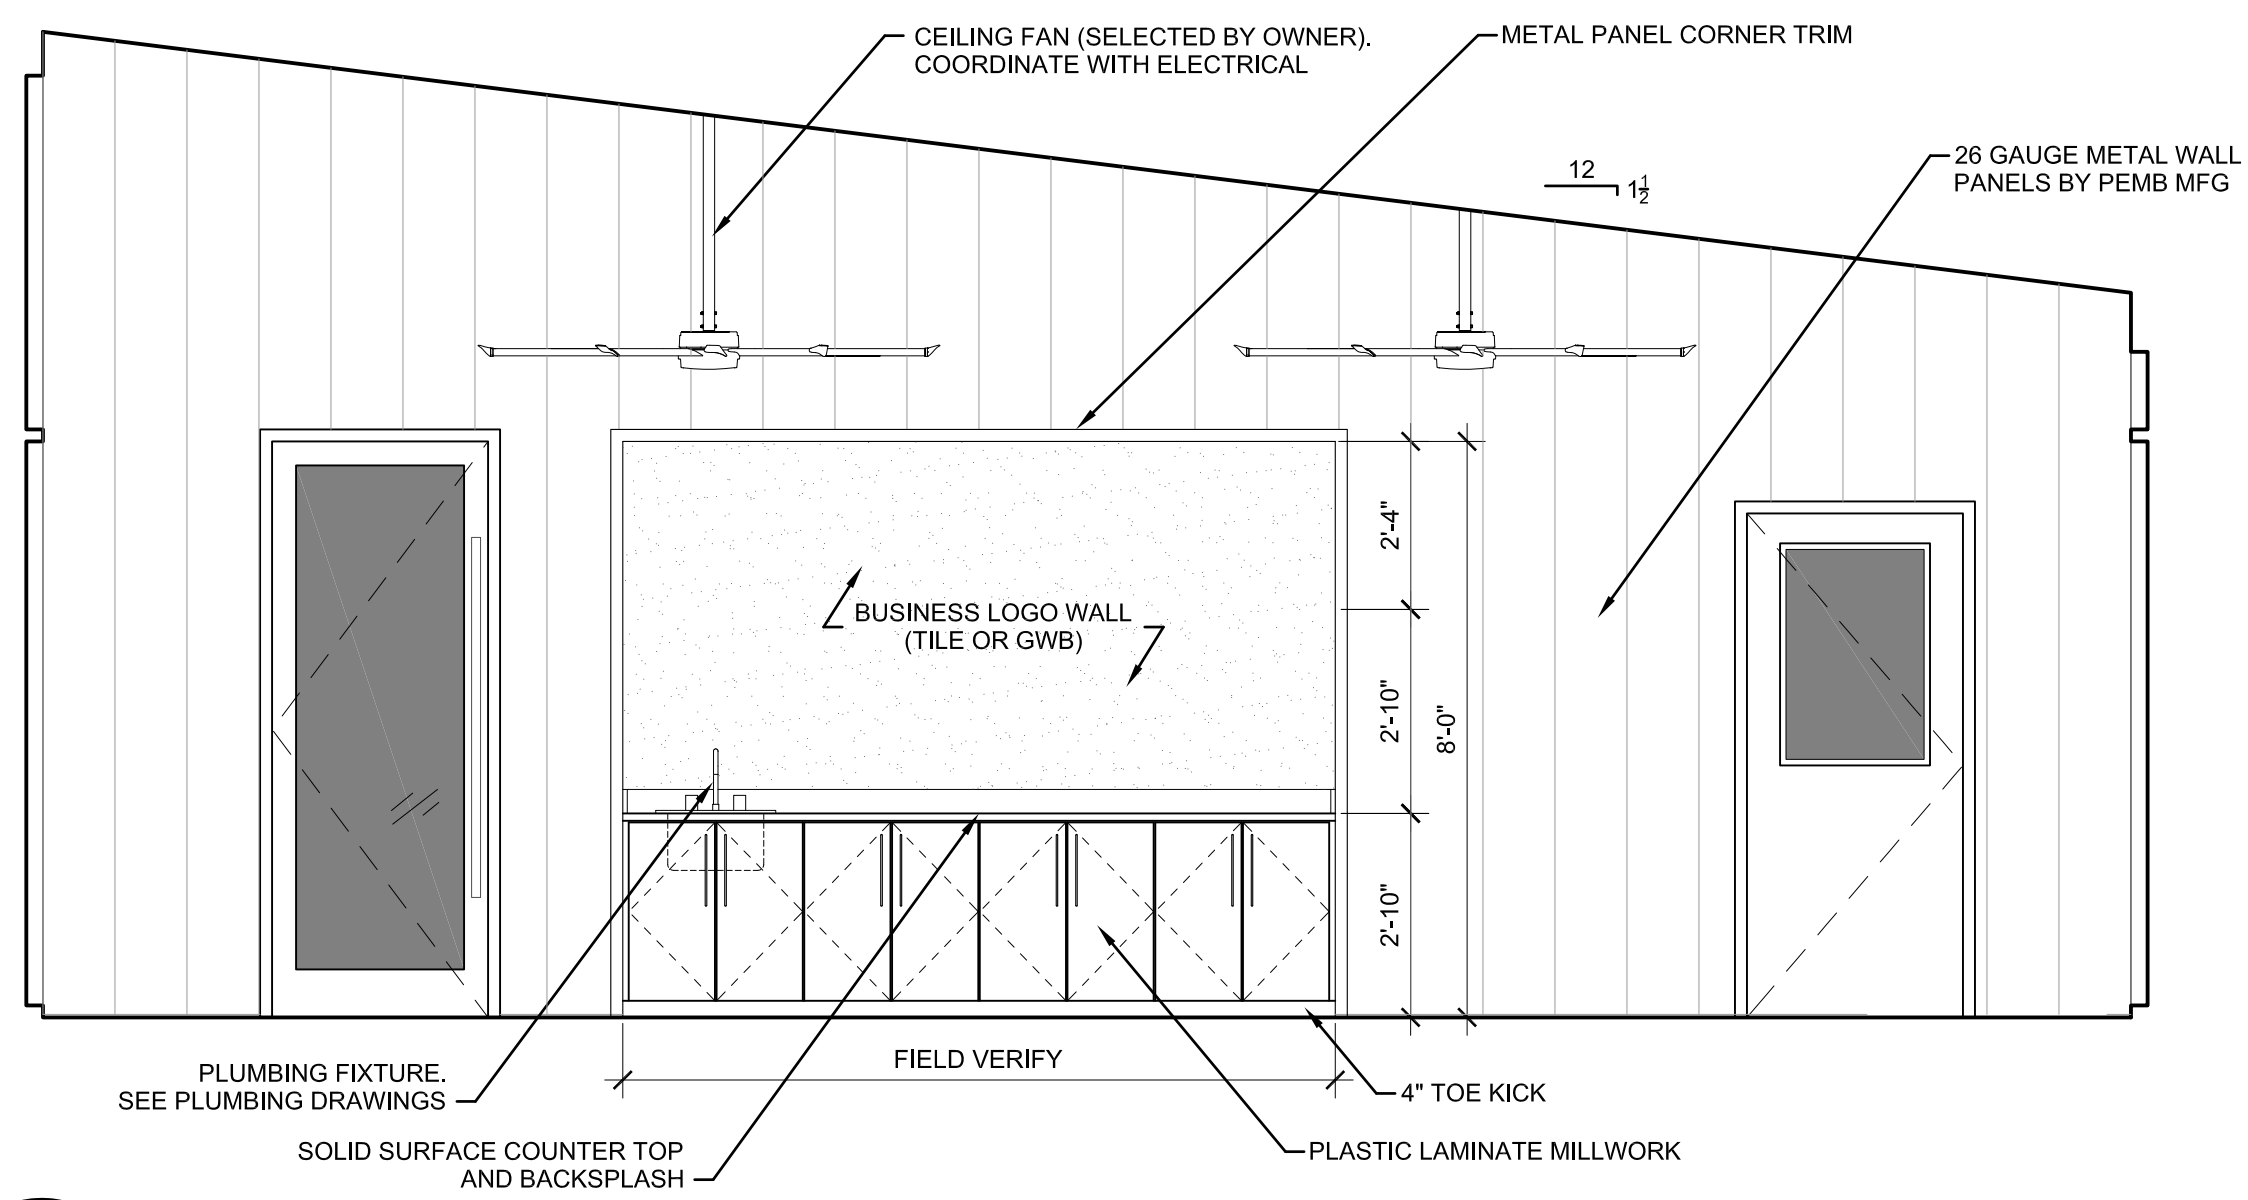

5 INTERIOR ELEVATION
A7.0 SCALE 3/8" = 1'-0" RETAIL 100

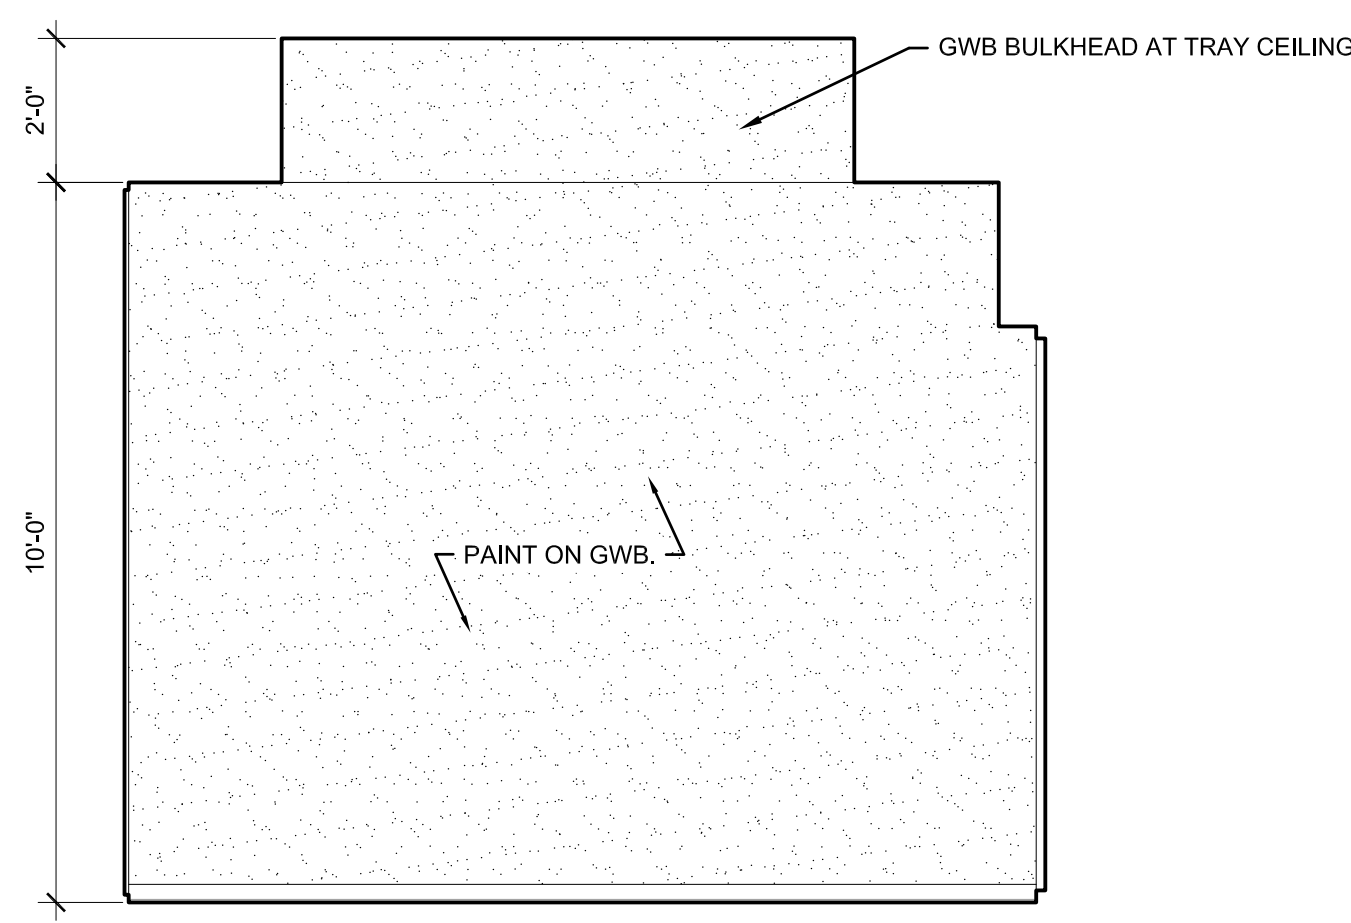

6 INTERIOR ELEVATION
A7.0 SCALE 3/8" = 1'-0" CONFERENCE 103

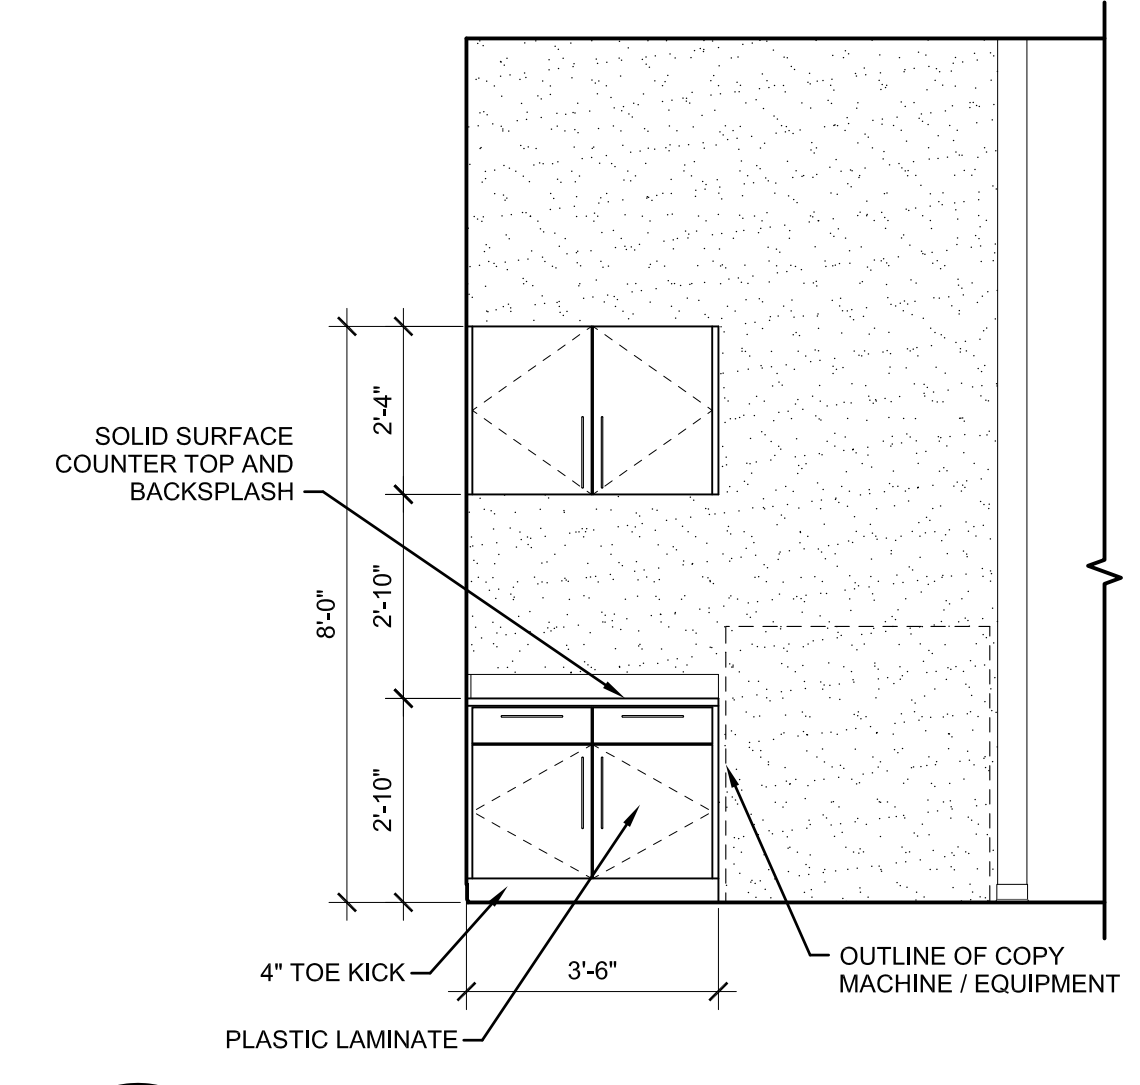

7 INTERIOR ELEVATION
A7.0 SCALE 3/8" = 1'-0" COPY ROOM 104

METAL FABRICATIONS NEW FACILITY
4323 AVIATION AVENUE, TALLAHASSEE, FL 32310

INTERIOR ELEVATIONS

CONN + ARCHITECTS
1960-C Buford Boulevard Tallahassee, Florida 32308 | 850-878-9784
www.CONNarchitects.com | Lic. No. AA-C001662

DATE	07-21-24
DRAWN BY	DBC
REVISED	
JOB NO.	23-208

PRICING SET - NOT FOR CONSTRUCTION

DATE SHEET NUMBER
A7.0

CONNECTIONS ARCHITECTS, INC. IS AN EQUAL OPPORTUNITY AFFIRMATIVE ACTION EMPLOYER. ANY DISCRIMINATION IN EMPLOYMENT PRACTICES WILL BE PROSECUTED. THIS DOCUMENT IS THE PROPERTY OF CONNECTIONS ARCHITECTS, INC. AND IS TO BE USED ONLY FOR THE PROJECT AND SITE SPECIFICALLY IDENTIFIED HEREIN. IT IS NOT TO BE REPRODUCED, COPIED, OR TRANSMITTED IN ANY FORM OR BY ANY MEANS, ELECTRONIC, MECHANICAL, PHOTOCOPIING, RECORDING, OR OTHERWISE, WITHOUT THE PRIOR WRITTEN PERMISSION OF CONNECTIONS ARCHITECTS, INC.

UL Product iQ®



BXUV.U465 - Fire-resistance Ratings - ANSI/UL 263

Design/System/Construction/Assembly Usage Disclaimer

- Authorities Having Jurisdiction should be consulted in all cases as to the particular requirements covering the installation and use of UL Certified products, equipment, system, devices, and materials.
Authorities Having Jurisdiction should be consulted before construction.
Fire resistance assemblies and products are developed by the design submitter and have been investigated by UL for compliance with applicable requirements. The published information cannot always address every construction nuance encountered in the field.
When field issues arise, it is recommended the first contact for assistance be the technical service staff provided by the product manufacturer noted for the design. Users of fire resistance assemblies are advised to consult the general Guide Information for each product category and each group of assemblies. The Guide Information includes specific concerning alternate materials and alternate methods of construction.
Only products which bear UL's Mark are considered Certified.

Fire-resistance Ratings - ANSI/UL 263

BXUV - Fire Resistance Ratings - ANSI/UL 263 Certified for United States
BXUV7 - Fire Resistance Ratings - CAN/ULC-S101 Certified for Canada

See General Information for Fire-resistance Ratings - ANSI/UL 263 Certified for United States
Design Criteria and Allowable Variance


See General Information for Fire-resistance Ratings - CAN/ULC-S101 Certified for Canada
Design Criteria and Allowable Variance

Design No. U465

May 25, 2022

Nonbearing Wall Rating - 1 HR.

* Indicates such products shall bear the UL or cUL Certification Mark for jurisdictions employing the UL or cUL Certification (such as Canada), respectively.

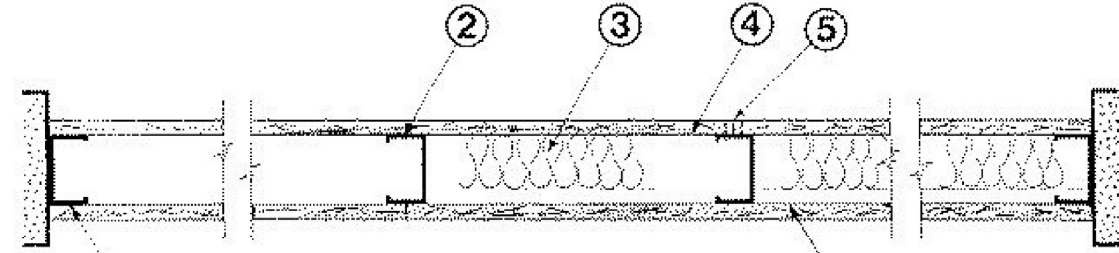

1. Floor and Ceiling Runners - (Not Shown) - Channel shaped runners, 3-5/8 in. deep (min), 1-1/4 in. legs, formed from min No. 25 MSG galv steel, attached to floor and ceiling with fasteners spaced 24 in. OC max.

1A. Framing Members* - Floor and Ceiling Runners - (Not Shown) - As an alternate to Item 1 - Channel shaped, min 3-5/8 in. deep, attached to floor and ceiling with fasteners 24 in. OC max.

ALLSTEEL & GYPSUM PRODUCTS INC - Type SUPREME D24/30EQD and Type SUPREME D20

CONSOLIDATED FABRICATORS CORP. BUILDING PRODUCTS DIV - Type SUPREME D24/30EQD and Type SUPREME D20

QUAIL RUN BUILDING MATERIALS INC - Type SUPREME D24/30EQD and Type SUPREME D20

SCAFCO STEEL STUD MANUFACTURING CO - Type SUPREME D24/30EQD and Type SUPREME D20

STEEL CONSTRUCTION SYSTEMS INC - Type SUPREME D24/30EQD and Type SUPREME D20

TELLING INDUSTRIES L L C - Type SUPREME D24/30EQD and Type SUPREME D20

UNITED METAL PRODUCTS INC - Type SUPREME D24/30EQD and Type SUPREME D20

1B. Framing Members* - Floor and Ceiling Runners - (Not Shown) - In lieu of Item 1 - For use with Item 2B, proprietary channel shaped runners, 1-1/4 in. wide by min 3-5/8 in. deep fabricated from min 0.020 in. thick galv steel, attached to floor and ceiling with fasteners spaced 24 in. OC max.

CALIFORNIA EXPANDED METAL PRODUCTS CO - Viper20™ Track

MARINO/WARE, DIV OF WARE INDUSTRIES INC - Viper20™ Track

IMPERIAL MANUFACTURING GROUP INC - Viper20™ Track

1C. Floor and Ceiling Runners - (Not Shown) - For use with Item 2C - Channel shaped, fabricated from min 20 MSG corrosion-protected or galv steel, min depth to accommodate stud size, with min 1 in. long legs, attached to floor and ceiling with fasteners spaced max 24 in. OC.

1D. Framing Members* - Floor and Ceiling Runners - (Not Shown) - In lieu of Items 1 through 1C - For use with Item 2D and 4C only, proprietary channel shaped runners, 1-1/4 in. deep by min 3-5/8 in. wide fabricated from min 0.018 in. thick galv steel, attached to floor and ceiling with fasteners spaced 24 in. OC max.

CLARKDIETRICH BUILDING SYSTEMS - CD ProTRAK

MDFCWBS L L C - ProTRAK

MBA METAL FRAMING - ProTRAK

RAM SALES L L C - Ram ProTRAK

STEEL STRUCTURAL PRODUCTS L L C - Tri-5 ProTRAK

1E. Framing Members* - Floor and Ceiling Runners - (Not Shown) - In lieu of Items 1 through 1D - For use with Item 2E and 4I only, proprietary channel shaped runners, 1-1/4 in. deep by min 3-5/8 in. wide fabricated from min 0.018 in. thick galv steel, attached to floor and ceiling with fasteners spaced 24 in. OC max.

TELLING INDUSTRIES L L C - TRUE-TRACK™

1F. Framing Members* - Floor and Ceiling Runners - (Not Shown) - In lieu of Items 1 through 1E - For use with Item 2, channel shaped runners, 1-1/4 in. deep by min 3-5/8 in. wide fabricated from min 25 MSG steel, attached to floor and ceiling with fasteners spaced 24 in. OC max.

KIRII (HONG KONG) LTD - Type KIRII

1G. Framing Members* - Floor and Ceiling Runners - (Not Shown) - In lieu of Items 1 through 1F - For use with Item 2, channel shaped runners, 1-1/4 in. deep by min 3-5/8 in. wide, attached to floor and ceiling with fasteners spaced 24 in. OC max.

STUDCO BUILDING SYSTEMS - CROSTUD Track

1H. Floor and Ceiling Runners - (Not Shown) - Channel shaped, fabricated from min 0.02 in. galv steel, min width to accommodate stud size, with min 1 in. long legs, for use with studs specified below and fabricated from min 0.02 in. galv steel or thicker, attached to floor and ceiling with fasteners spaced max 24 in. OC.

MARINO/WARE, DIV OF WARE INDUSTRIES INC - Viper20™ Track VT100

IMPERIAL MANUFACTURING GROUP INC - Viper20™ Track VT100

1I. Framing Members* - Floor and Ceiling Runners - (Not Shown) - In lieu of Item 1 - For use with Item 2H, proprietary channel shaped runners, 1-1/4 in. wide by min 3-5/8 in. deep fabricated from min 0.020 in. thick galv steel, attached to floor

and ceiling with fasteners spaced 24 in. OC max.
MARINO/WARE, DIV OF WARE INDUSTRIES INC - Viper20™ Track

1J. Framing Members* - Floor and Ceiling Runners - (Not Shown) - In lieu of Items 1 - For use with Item 2 L, proprietary channel shaped runners, 1-1/4 in. deep by min 3-5/8 in. wide fabricated from min 0.018 in. thick galv steel, attached to floor and ceiling with fasteners spaced 24 in. OC max.

RESCUE METAL FRAMING, L L C - AlphaTRAK

1K. Framing Members* - Floor and Ceiling Runners - (Not Shown) - In lieu of Item 1 - For use with Item 2M, proprietary channel shaped runners, 1-1/4 in. wide by min 3-5/8 in. deep, fabricated from min 25 MSG (0.018 in. min. bare metal thickness), attached to floor and ceiling with fasteners spaced 24 in. OC max.

CALIFORNIA EXPANDED METAL PRODUCTS CO - Viper X Track

1L. Framing Members* - Floor and Ceiling Runners - (Not Shown) - In lieu of Item 1 - For use with Item 2N, proprietary channel shaped runners, 1-1/4 in. wide by min 3-5/8 in. deep fabricated from min 0.020 in. thick galv steel, attached to floor and ceiling with fasteners spaced 24 in. OC max.

CRACO MFG INC - SmartStud20™

2. Steel Studs - Channel shaped, 3-5/8 in. deep (min), formed from min No. 25 MSG galv steel spaced 24 in. OC max. Studs to be cut 3/4 in. less than assembly height.

2A. Framing Members* - Steel Studs - As an alternate to Item 2 - Channel shaped studs, min 3-5/8 in. deep, spaced a max of 24 in. OC. Studs to be cut 3/4 in. less than assembly height.

ALLSTEEL & GYPSUM PRODUCTS INC - Type SUPREME D24/30EQD and Type SUPREME D20

CONSOLIDATED FABRICATORS CORP. BUILDING PRODUCTS DIV - Type SUPREME D24/30EQD and Type SUPREME D20

QUAIL RUN BUILDING MATERIALS INC - Type SUPREME D24/30EQD and Type SUPREME D20

SCAFCO STEEL STUD MANUFACTURING CO - Type SUPREME D24/30EQD and Type SUPREME D20

STEEL CONSTRUCTION SYSTEMS INC - Type SUPREME D24/30EQD and Type SUPREME D20

TELLING INDUSTRIES L L C - Type SUPREME D24/30EQD and Type SUPREME D20

UNITED METAL PRODUCTS INC - Type SUPREME D24/30EQD and Type SUPREME D20

2B. Framing Members* - Steel Studs - (Not Shown) - In lieu of Item 2 - For use with Item 1B, proprietary channel shaped studs, 1-1/4 in. wide by min 3-5/8 in. deep fabricated from min 0.020 in. thick galv steel. Studs cut 3/4 in. less in length than assembly height.

CALIFORNIA EXPANDED METAL PRODUCTS CO - Viper20™

CRACO MFG INC - SmartStud20™

MARINO/WARE, DIV OF WARE INDUSTRIES INC - Viper20™

IMPERIAL MANUFACTURING GROUP INC - Viper20™

2C. Steel Studs - (As an alternate to Item 2, For use with Item 1C) - Channel shaped, fabricated from min 20 MSG corrosion-protected or galv steel, 3-1/2 in. min depth, spaced a max of 16 in. OC. Studs friction-fit into floor and ceiling runners. Studs to be cut 5/8 to 3/4 in. less than assembly height. See materials in Item(s) 4 that require Item 2C studs.

2D. Framing Members* - Steel Studs - As an alternate to Items 2 through 2C - For use with Item 1D and 4G only, channel shaped studs, min 3-5/8 in. wide fabricated from min 0.018 in. thick galv steel, spaced a max of 24 in. OC. Studs to be cut 1/2 in. less than assembly height.

CLARKDIETRICH BUILDING SYSTEMS - CD ProSTUD

DPMFCWBS L L C - ProSTUD

MBA METAL FRAMING - ProSTUD

RAM SALES L L C - Ram ProSTUD

STEEL STRUCTURAL PRODUCTS L L C - Tri-5 ProSTUD

2E. Framing Members* - Steel Studs - As an alternate to Items 2 through 2D - For use with Item 1E and 4I only, channel shaped studs, min 3-5/8 in. wide fabricated from min 0.018 in. thick galv steel, spaced a max of 24 in. OC. Studs to be cut 1/2 in. less than assembly height.

TELLING INDUSTRIES L L C - TRUE-STUD™

2F. Framing Members* - Steel Studs - As an alternate to Items 2 through 2E - For use with Item 1F, channel shaped studs, min 3-5/8 in. wide fabricated from min 25 MSG steel, spaced a max of 24 in. OC. Studs to be cut 1/2 in. less than assembly height.

KIRII (HONG KONG) LTD - Type KIRII

2G. Framing Members* - Steel Studs - (Not Shown) - In lieu of Item 2 through 2F - For use with Item 1G. Proprietary channel shaped studs, minimum 3-5/8 in. wide, Studs to be cut 1/2 in. less than the assembly height.

STUDCO BUILDING SYSTEMS - CROSTUD

2H. Framing Members* - Steel Studs - (Not Shown) - In lieu of Item 2 - For use with Item 1I, proprietary channel shaped studs, 1-1/4 in. wide by min 3-5/8 in. deep fabricated from min 0.020 in. thick galv steel. Studs cut 3/4 in. less in length than assembly height.

MARINO/WARE, DIV OF WARE INDUSTRIES INC - Viper20™

2I. Framing Members* - Steel Studs - In lieu of Item 2 - For use with Item 1, channel shaped studs, fabricated from min 25 MSG corrosion-protected steel, 3-5/8 in. deep (min), spaced 24 in. OC max. Studs to be cut 3/4 in. less than assembly height.

EB METAL INC - NITROSTUD

2J. Framing Members* - Steel Studs - In lieu of Item 2 - For use with Item 1, channel shaped studs, fabricated from min 25 MSG corrosion-protected steel, 3-5/8 in. deep (min), spaced 24 in. OC max. Studs to be cut 3/4 in. less than assembly height.

OLMAR SUPPLY INC - PRIMESTUD

2K. Framing Members* - Steel Studs - As an alternate to Item 2 - For use with Item 1B (3-5/8 in. wide track), channel shaped studs, fabricated from min 25 MSG corrosion-protected steel, 1-1/4 in. wide by 3-5/8 in. deep, spaced a max of 24 in. OC. Studs to be cut 3/8 to 3/4 in. less than assembly height.

MARINO/WARE, DIV OF WARE INDUSTRIES INC - StudRite™

2L. Framing Members* - Steel Studs - As an alternate to Items 2 - For use with Item 1J, channel shaped studs, min 3-5/8 in. wide fabricated from min 0.018 in. thick galv steel, spaced a max of 24 in. OC. Studs to be cut 3/4 in. less than assembly height.

RESCUE METAL FRAMING, L L C - AlphaSTUD

2M. Framing Members* - Steel Studs - (Not Shown) - In lieu of Item 2 - For use with Item 1K, proprietary channel shaped studs, min 1-1/4 in. wide by min 3-5/8 in. deep, fabricated from min 25 MSG (0.018 in. min. bare metal thickness). Studs cut 3/4 in. less in length than assembly height.

CALIFORNIA EXPANDED METAL PRODUCTS CO - Viper X

2N. Framing Members* - Steel Studs - (Not Shown) - In lieu of Item 2 - For use with Item 1L, proprietary channel shaped studs, 1-1/4 in. wide by min 3-5/8 in. deep fabricated from min 0.020 in. thick galv steel. Studs cut 3/4 in. less in length than assembly height.

CRACO MFG INC - SmartStud20™

3. Batts and Blankets* - (Optional) - Mineral wool or glass fiber batts partially or completely filling stud cavity. See Batts and Blankets (BZJZ) category for names of Classified companies.

ROCKWOOL - Type AFB, min. density 1.69 pcf / 27.0 kg/m³

ROCKWOOL MALAYSIA SDN BHD - Type Acoustical Fire Batts

3A. Fiber, Sprayed* - As an alternate to Batts and Blankets (Item 3) - (100% Borate Formulation) - Spray applied cellulose material. The fiber is applied with water to completely fill the enclosed cavity in accordance with the application instructions supplied with the product with a nominal dry density of 2.7 lb/ft³. Alternate Application Method: The fiber is applied without water or adhesive at a nominal dry density of 3.5 lb/ft³, in accordance with the application instructions supplied with the product.

U S GREENBRIE L L C - INS735, INS745, INS750/D for use with wet or dry application. INS765/D and INS773/D are to be used for dry application only

3B. Fiber, Sprayed* - As an alternate to Batts and Blankets (Item 3) - Spray applied cellulose insulation material. The fiber is applied with water to interior surfaces in accordance with the application instructions supplied with the product. Applied to completely fill the enclosed cavity. Minimum dry density of 4.3 pounds per cubic ft.

NU-WOOL CO INC - Cellulose Insulation

3C. Fiber, Sprayed* - As an alternate to Batts and Blankets (Item 3) - Spray applied cellulose fiber. The fiber is applied with water to completely fill the enclosed cavity in accordance with the application instructions supplied with the product. The minimum dry density shall be 4.30 lb/ft³.

INTERNATIONAL CELLULOSE CORP - Caber-RL

3D. Batts and Blankets* - For use with Item 8, Nom 3 in. thick, minimum 3.4 pcf mineral wool batts, friction fit between the studs and floor and ceiling runners.

See Batts and Blankets (BZJZ) category for names of manufacturers.

3E. Batts and Blankets* - For use with Item 4R and 4S. Placed in stud cavities, any min. 3-1/2 in. thick glass fiber insulation bearing the UL Classification Marking as to Surface Burning Characteristics and/or Fire Resistance.

See Batts and Blankets (BKNV or BZJZ) Categories for names of Classified companies.

3F. Fiber, Sprayed* - As an alternate to Batts and Blankets (Item 3) - Spray applied cellulose material. The fiber is applied with water to completely fill the enclosed cavity in accordance with the application instructions supplied with the product. To facilitate the installation of the material, any thin, woven or non-woven netting may be attached by any means possible to the outer face of the studs. The material shall reach equilibrium moisture content before the installation of materials on either face of the studs. The minimum dry density shall be 5.79 lb/ft³.

APPLIGATE HOLDINGS L L C - Appligate Advanced Stabilized Cellulose Insulation

3G. Foamed Plastic* - As an alternate to Batts and Blankets (Item 3), for use with Item 4U - Spray applied, foamed plastic insulation, at any thickness from partial fill to completely filling stud cavity. When foamed plastic is used, minimum stud depth shall be 3-1/2 in.

CARLISLE SPRAY FOAM INSULATION - Types SealTite Pro Closed Cell (CC), SealTite Pro Open Cell (OC), SealTite Pro OCK, SealTite Pro No Trim 21, SealTite Pro One Zero, Foamulate Closed Cell, Foamulate OCK, Foamulate FO, and Foamulate HFO.

4. Gypsum Board* - 5/8 in. thick, 4 ft wide, attached to steel studs and floor and ceiling track with 1 in. long, Type 5 steel screws spaced 8 in. OC, along edges of board and 12 in. OC in the field of the board. Joints oriented vertically and staggered on opposite sides of the assembly. When Steel Framing Members* (Item 6 or any alternate clips) are used, gypsum board is screw attached to furring channels with 1 in. long, Type 5 steel screws spaced 12 in. OC.

AMERICAN GYPSUM CO - Types AG-C, AGX-1, M-Glass, LightRoc

BEIJING NEW BUILDING MATERIALS PUBLIC LTD CO - Type DBX-1

CABOT MANUFACTURING ULC - Type X, 5/8 Type X, Type Blueglas Exterior Sheathing

CGC INC - Types AR, C, IP-AR, IP-X1, IP-X2, IPC-AR, SCX, SHX, ULIX, USGX, WRC or WRX (Joint tape and compound, Item 5, optional for use with Type USGX)

CERTAINTED GYPSUM INC - Types EGRG, GlasRoc, Type X-1, Type C, 5/8" East- Lite Type X, East- Lite Type X-2

CERTAINTED GYPSUM INC - Types LGFC2A, LGFC6A, LGFC-C/A, LGFC-WD, LGLLX

GEORGIA-PACIFIC GYPSUM L L C - Types 5, 6, 9, C, DAP, DD, DA, DAPC, DGG, DS, GPF56, LS, Type X, Veneer Plaster Base - Type X, Water Rated - Type X, Sheathing - Type X, Soffit - Type X, TG-C, GreenGlass Type X, Type X ComfortGuard Sound Deadening Gypsum Board, Type LWX, Veneer Plaster Base-Type LWX, Water Rated-Type LWX, Sheathing-Type LWX, Soffit-Type LWX, Type DGLW, Water Rated-Type DGLW, Sheathing-Type DGLW, Type DGLWZ, Water Rated-Type DGLWZ, Sheathing-Type DGLWZ, Water Rated-Type DGLWZ, Sheathing-Type DGLWZ

NATIONAL GYPSUM CO - Types eXP-C, FSK, FSK-C, FSK-G, FSKR-C, FSKW-C, FSKW-G, FSKW-3, FSKW-6, FSKW-8, FSKL, FSKL, FSKL, FSKL

NATIONAL GYPSUM CO - Riyadh, Saudi Arabia - Type FR, or WR

PABCO BUILDING PRODUCTS L L C, DBA PABCO GYPSUM - Types PG-C, PG-8, PG-11, PGS-WRS, PGI

PANEL REY S A - Types GRED, GRIX, PRC, PR2, PRX, RIX, MDX, ETX, PRX2

SAINT-GOBAIN GYPROC MIDDLE EAST FZE - Type Gyproc FireStop, Gyproc FireStop MR, Gyproc FireStop MZTECH, Gyproc FireStop ACTIV'Air, Gyproc FireStop MR ACTIV'Air, Gyproc FireStop MZTECH ACTIV'Air, Gyproc DuraLine, Gyproc DuraLine MR, Gyproc DuraLine MZTECH, Gyproc DuraLine ACTIV'Air, Gyproc DuraLine MR ACTIV'Air, Gyproc DuraLine MZTECH ACTIV'Air

SIAM GYPSUM INDUSTRY (SARABURI) CO LTD - Type EX-1

THAI GYPSUM PRODUCTS PCL - Type X, Type C

UNITED STATES GYPSUM CO - Type AR, C, FRX-G, IP-AR, IP-X1, IP-X2, IPC-AR, SCX, SHX, ULIX, USGX, WRC, WRX (Joint tape and compound, Item 5, optional for use with Type USGX)

USG BORAL DRYWALL SFZ LLC - Types C, SCX, USGX (Joint tape and compound, Item 5, optional for use with Type USGX)

USG MEXICO S A DE C V - Type AR, C, IP-AR, IP-X1, IP-X2, IPC-AR, SCX, SHX, USGX, WRC or WRX (Joint tape and compound, Item 5, optional for use with Type USGX)

4A. Gypsum Board* - (As alternate to Item 4) - Nom 5/8 in. thick gypsum panels with beveled, square or tapered edges, applied vertically or horizontally. Vertical joints centered over studs and staggered one stud cavity on opposite sides of studs.

Horizontal edge joints and horizontal butt joints on opposite sides of studs need not be staggered or backed by steel framing. Panels attached to steel studs and floor runner with 1 in. long Type 5 steel screws spaced 8 in. OC when applied horizontally, or 8 in. OC along vertical and bottom edges and 12 in. OC in the field when panels are applied vertically. When used in widths other than 48 in., gypsum panels to be installed horizontally. When using ULIX, panels need not be staggered in horizontal applications and screw spacing can be increased to 12 in. OC in field and perimeter.

CERTAINTED GYPSUM INC - Type X-1, Type C, Type EGRG/GlasRoc, GlasRoc-2, Type SentiX, East-Lite Type X-2

CGC INC - Types AR, C, IP-AR, IP-X1, IP-X2, IPC-AR, SCX, SHX, ULIX, USGX, WRC or WRX (Joint tape and compound, Item 5, optional for use with Type USGX)

CERTAINTED GYPSUM INC - Types LGFC2A, LGFC6A, LGFC-C/A, LGFC-WD

GEORGIA-PACIFIC GYPSUM L L C - Types DAP, DAPC, DGG, DS

SAINT-GOBAIN GYPROC MIDDLE EAST FZE - Type Gyproc FireStop, Gyproc FireStop MR, Gyproc FireStop MZTECH, Gyproc FireStop ACTIV'Air, Gyproc FireStop MR ACTIV'Air, Gyproc FireStop MZTECH ACTIV'Air, Gyproc DuraLine, Gyproc DuraLine MR, Gyproc DuraLine MZTECH, Gyproc DuraLine ACTIV'Air, Gyproc DuraLine MR ACTIV'Air, Gyproc DuraLine MZTECH ACTIV'Air

THAI GYPSUM PRODUCTS PCL - Type X, Type C

UNITED STATES GYPSUM CO - Types AR, C, FRX-G, IP-AR, IP-X1, IP-X2, IPC-AR, SCX, SHX, ULIX, USGX, WRC, WRX (Joint tape and compound, Item 5, optional for use with Type USGX)

USG BORAL DRYWALL SFZ LLC - Types C, SCX, USGX (Joint tape and compound, Item 5, optional for use with Type USGX)

USG MEXICO S A DE C V - Type AR, C, IP-AR, IP-X1, IP-X2, IPC-AR, SCX, SHX, USGX, WRC or WRX (Joint tape and compound, Item 5, optional for use with Type USGX)

4B. Gypsum Board* - (As an alternate to Items 4 or 4A) - Nom 3/4 in. thick, 4 ft wide, installed as described in Item 4A with screw length increased to 1-1/4 in.

CGC INC - Types AR, IP-AR

UNITED STATES GYPSUM CO - Types AR, IP-AR

USG MEXICO S A DE C V - Types AR, IP-AR

4C. Gypsum Board* - As an alternate to Items 4, 4A, and 4B - Nom. 5/8 in. thick gypsum panels, with square edges, applied horizontally. Gypsum panels fastened to framing with 1 in. long bugle head steel screws spaced a max 8 in. OC, with last 2 screws 3/4 in. and 4 in. from each edge of board. Horizontal joints need not be backed by steel framing. Horizontal edge joints and horizontal butt joints on opposite sides of studs on interior walls need not be staggered or backed by steel framing.

GEORGIA-PACIFIC GYPSUM L L C - Type DGG, GreenGlass Type X

4D. Gypsum Board* - As an alternate to Items 4, 4A, 4B, and 4C - Nom. 5/8 in. thick gypsum panels applied vertically or horizontally. Vertical joints centered over studs and staggered one stud cavity on opposite sides of studs. Horizontal edge joints and horizontal butt joints on opposite sides of studs need not be staggered or backed by steel framing. Gypsum panels fastened to framing with 1 in. long Type 5 steel screws 12 in. OC along vertical edges and in the field. Screws spaced a max 12 in. along the top and bottom edges of the wall for both vertical and horizontal applications. When used in widths other than 48 in., gypsum panels to be installed horizontally.

NATIONAL GYPSUM CO - Types eXP-C, FSK, FSK-C, FSK-G, FSL, FSW-C, FSW-G, FSW-3, FSW-5, FSW-6, FSKR-C

4E. Gypsum Board* - (As an alternate to Items 4 through 4D) - Installed as described in Item 4, 5/8 in. thick, 4 ft wide, applied vertically only and fastened to the studs and plates with 1 in. long, Type 5 steel screws spaced, 12 in. OC.

NATIONAL GYPSUM CO - Type S8W6

4F. Gypsum Board* - (Not Shown) - (As an alternate to Item 4 when used as the base layer on one or both sides of wall. For direct attachment only to steel studs Item 2C) - Nom 5/8 in. thick lead backed gypsum panels with beveled, square or tapered edges, applied vertically. Vertical joints centered over studs and staggered min 1 stud cavity on opposite sides of studs. Gypsum board secured to studs with 1-1/4 in. long Type 5-12 steel screws spaced 8 in. OC at perimeter and 12 in. OC in the field.

RAY-BAR ENGINEERING CORP - Type RB-LB6

4G. Gypsum Board* - (As an alternate to Items 4 through 4F) - For use with Items 1D and 2D only, 5/8 in. thick, 4 ft wide, bearing the UL Classification Marking as to Surface Burning Characteristics and/or Fire Resistance.

See Batts and Blankets (BZJZ) category for names of manufacturers.

4H. Gypsum Board* - (As an alternate to Items 4 through 4G) - Nominal 5/8 in. thick, 4 ft wide panels, applied vertically and secured as described in Item 4.

CGC INC - Type SCX, ULIX

CERTAINTED GYPSUM INC - Type LGFC6A, LGFC-C/A

NATIONAL GYPSUM CO - Types FSW

UNITED STATES GYPSUM CO - Type SCX, ULIX

4N. **Wall and Partition Facings and Accessories*** — (As an alternate to Item 4) — Nominal 5/8 in. thick, 4 ft wide panels, applied vertically and secured as described in Item 4.
PABCO BUILDING PRODUCTS L L C, DBA PABCO GYPSUM — Type QuietRock S27

4Q. **Gypsum Board*** — As an alternate to Items 4, 4A, 4B, and 4C — Two layers Nom. 5/16 in. thick gypsum panels applied vertically or horizontally. Horizontal edge joints and horizontal butt joints on opposite sides of studs need not be staggered or backed by steel framing. Horizontal joints on the same side need not be staggered. When applied horizontally, both layers of gypsum board fastened to each side of framing with 1 in. long Type 5 steel screws spaced 8 in. OC and staggered 4 in. OC between layers. When applied vertically, both layers of gypsum board fastened to each side of framing with 1 in. long Type 5 steel screws spaced 8 in. OC along vertical edges and 12 in. OC in the field, staggered 4 in. OC between layers. Screws spaced a max 12 in. along the top and bottom edges of the wall.
NATIONAL GYPSUM CO — Type FSW

4P. **Gypsum Board*** — As an alternate to Item 4. Nom 5/8 in. thick, 4 ft wide, Nom 5/8 in. thick gypsum panels with beveled, square or tapered edges, applied vertically or horizontally. Vertical joints centered over studs and staggered one stud cavity on opposite sides of studs. Horizontal edge joints and horizontal butt joints on opposite sides of studs need not be staggered or backed by steel framing. Panels attached to steel studs and runners with 1 in. long Type 5 steel screws spaced 12 in. OC when applied horizontally or vertically. When used in widths other than 48 in., gypsum panels to be installed horizontally.
CGC INC — Type ULIX
UNITED STATES GYPSUM CO — Types ULX

4Q. **Gypsum Board*** — 3/4 in. thick, 4 ft wide, attached to steel studs and floor and ceiling track as described in Item 4 with screw length increased to min. 1-1/8 in.
PABCO BUILDING PRODUCTS L L C, DBA PABCO GYPSUM — Type PG-13

4R. **Gypsum Board*** — As an alternate to Item 4D. For use with Item 3E, **Batts and Blankets*** — 5/8 in. thick, 4 ft wide, installed as described in Item 4.
NATIONAL GYPSUM CO — Type FSXL

4S. **Gypsum Board*** — As an alternate to Item 4. For use with Item 3E, **Batts and Blankets*** — 5/8 in. thick, 4 ft wide, installed as described in Item 4A.
CERTAINTEEED GYPSUM INC — Type CLIX

4T. **Wall and Partition Facings and Accessories*** — (As an alternate to 5/8 in. thick board as outlined in Item 4) — Nominal 1-3/8 in. thick, 4 ft wide panels, applied vertically or horizontally. Fastened with #6 x 2 in. long drywall screws spaced 8 in. OC along the perimeter and 12 in. OC in the field.
PABCO BUILDING PRODUCTS L L C, DBA PABCO GYPSUM — Type QuietRock S45

4U. **Gypsum Board*** — (As an alternate to Item 4 when Foam Plastic Insulation Item 3G is used) — Any 5/8 in. thick, 4 ft wide, Gypsum Board listed in Item 4 above. Applied vertically with vertical joints centered over studs and staggered one stud cavity on opposite sides of studs. Gypsum panels secured to studs with 1 in. long Type 5 steel screws spaced 8 in. OC at perimeter and in the field. For 2 layer assemblies outer layer will be attached to studs over inner layer with the 1-5/8 in. long steel screws spaced 8 in. OC.

4V. **Gypsum Board*** — (As an alternate to Item 4, for 1 hr. rating) — Nom. 5/8 in. thick gypsum panels applied vertically or horizontally. Horizontal edge joints and horizontal butt joints on opposite sides of studs need not be staggered or backed by steel framing. Gypsum panels fastened to framing with 1 in. long Type 5 steel screws 12 in. OC along vertical edges and in the field. Screws spaced a max 12 in. along the top and bottom edges of the wall for both vertical and horizontal applications.
CERTAINTEEED GYPSUM INC — Type X-1, SilentFX, GlasRock, Type C

5. **Joint Tape and Compound** — Vinyl, dry or premixed joint compound, applied in two coats to joints and screw heads; paper tape, 2 in. wide, embedded in first layer of compound over all joints. As an alternate, nominal 3/32 in. thick gypsum veneer plaster may be applied to the entire surface of Classified veneer baseboard. Joints reinforced. Paper tape and joint compound may be omitted when gypsum boards are supplied with square edges.

6. **Resilient Channel** — (Optional — Not Shown) — 25 MSG galv steel resilient channels spaced vertically max 24 in. OC, flange portion attached to each intersecting stud with 1/2 in. long Type 5-12 pan head steel screws. May not be used with Item 4F, 4J or 4L.

6A. **Steel Framing Members*** — (Optional, Not Shown, As an alternate to Item 6) — Furring channels and Steel Framing Members as described below:

a. **Furring Channels** — Formed of No. 25 MSG galv steel, 2-9/16 in. or 2-23/32 in. wide by 7/8 in. deep, spaced 24 in. OC perpendicular to studs. Channels secured to studs as described in Item b. Ends of adjoining channels are overlapped 6 in. and tied together with double strand of No. 18 SWG galv steel wire near each end of overlap. As an alternate, ends of adjoining channels may be overlapped 6 in. and secured together with two self-tapping No. 6 framing screws, min 7/16 in. long at the midpoint of the overlap, with one screw on each flange of the channel. Not for use with Items 4F, 4J, or 4L.

b. **Framing Members*** — Used to attach furring channels (Item 6A) to studs (Item 2). Clips spaced 48 in. OC, and secured to studs with 1-5/8 in. wafer or hex head Type 5 steel screw through the center grommet. Furring channels are friction fitted into clips. RSK-1 clip for use with 2-9/16 in. wide furring channels. RSK-1 (2.75) clip for use with 2-23/32 in. wide furring channels.
PAC INTERNATIONAL L L C — Types RSK-1, RSK-1 (2.75)

6B. **Framing Members*** — (Optional on one or both sides, Not Shown, As an alternate to Item 6) — Furring channel and Steel Framing Members as described below:

a. **Furring Channels** — Formed of No. 25 MSG galv steel, 2-3/8 in. wide by 7/8 in. deep, spaced max. 24 in. OC perpendicular to studs. Channels secured to studs as described in Item b. Gypsum board attached to furring channels as described in Item 4. Not for use with Items 4F, 4J, or 4L.

b. **Steel Framing Members*** — Used to attach furring channels (Item 6Ba) to studs (Item 2). Clips spaced max. 48 in. OC. GENIECLIPS secured to studs with No. 8 x 1-1/2 in. minimum self-drilling, 5-12 steel screw through the center grommet. Furring channels are friction fitted into clips.
PLITEQ INC — Type Genie Clip

6C. **Steel Framing Members*** — (Optional, Not Shown, As an alternate to Item 6) — Furring channels and Steel Framing Members as described below:

a. **Furring Channels** — Formed of No. 25 MSG galv steel, Spaced 24 in. OC perpendicular to studs. Channels secured to studs as described in Item b. Ends of adjoining channels overlapped 6 in. and tied together with double strand of No. 18 AWG galvanized steel wire. Gypsum board attached to furring channels as described in Item 4. Not for use with Items 4F, 4J, or 4L.

b. **Steel Framing Members*** — Used to attach furring channels (Item 6Ca) to studs. Clips spaced 48 in. OC, and secured to studs with 2 in. coarse drywall screw with 1 in. diam washer through the center hole. Furring channels are friction fitted into clips.
STUDCO BUILDING SYSTEMS — RESILMOUNT Sound Isolation Clips - Type A237R

6D. **Steel Framing Members*** — (Optional, Not Shown As an alternate to Item 6) — Furring channels and Steel Framing Members as described below:

a. **Furring Channels** — Formed of No. 25 MSG galv steel, Spaced 24 in. OC perpendicular to studs. Channels secured to studs as described in Item 6D. Ends of adjoining channels overlapped 6 in. and tied together with double strand of No. 18 AWG galvanized steel wire. Gypsum board attached to furring channels as described in Item 4. Not for use with Items 4F, 4J, or 4L.

b. **Steel Framing Members*** — Used to attach furring channels (Item 6Da) to studs. Clips spaced 48 in. OC, and secured to studs with No. 8 x 2-1/2 in. coarse drywall screw through the center hole. Furring channels are friction fitted into clips.
REGUPOUL AMERICA — Type SonoClip

6E. **Steel Framing Members*** — (Optional, Not Shown As an alternate to Item 6) — Resilient channels and Steel Framing Members as described below:

a. **Resilient Channels** — Formed of No. 25 MSG galv steel, spaced 24 in. OC, and perpendicular to studs. Channels secured to studs as described in Item b. Ends of adjoining channels overlapped 6 in. and secured in place with two No. 8 15 x 1/2 in. Philips Modified Truss screws spaced 2-1/2 in. from the center of the overlap. Gypsum board attached to resilient channels as described in Item 4. Not for use with Items 4F, 4J, or 4L.

b. **Steel Framing Members*** — Used to attach resilient channels (Item 6Ea) to studs. Clips spaced 48 in. OC, and secured to studs with No. 8 x 2-1/2 in. coarse drywall screw through the center hole. Resilient channels are secured to clips with one No. 10 x 1/2 in. pan-head self-drilling screw.
KEENE BUILDING PRODUCTS CO INC — Type RC+ Assurance Clip

6F. **Steel Framing Members*** — (Optional, Not Shown, As an alternate to Item 6) — Furring channels and Steel Framing Members as described below:

a. **Furring Channels** — Formed of No. 25 MSG galv steel, 2-23/32 in. wide by 7/8 in. deep, spaced 24 in. OC perpendicular to studs. Channels secured to studs as described in Item b. Ends of adjoining channels are overlapped 6 in. and tied together with double strand of No. 18 SWG galv steel wire near each end of overlap. As an alternate, ends of adjoining channels may be overlapped 6 in. and secured together with two self-tapping #6 framing screws, min. 7/16 in. long at the midpoint of the overlap, with one screw on each flange of the channel. Gypsum board attached to furring channels as described in Item 4.

b. **Steel Framing Members*** — Used to attach furring channels (Item 6Fa) to studs. Clips spaced maximum 48 in. OC. Clips secured to studs with No. 8 x 2-1/2 in. coarse drywall screw through the center grommet. Furring channels are friction fitted into clips.

CLARKDIETRICH BUILDING SYSTEMS — Type ClarkDietrich Sound Clip

6F. **Steel Framing Members*** — (Optional, Not Shown) — Furring channels and Steel Framing Members as described below:

a. **Furring Channels** — Formed of No. 25 MSG galv steel, Spaced 24 in. OC perpendicular to studs. Channels secured to studs as described in Item b. Ends of adjoining channels overlapped 6 in. and tied together with double strand of No. 18 AWG galvanized steel wire. Gypsum board attached to furring channels as described in Item 4. Not for use with Items 4F, 4J, or 4L.

b. **Steel Framing Members*** — Used to attach furring channels (Item 6Fa) to studs. Clips spaced 48 in. OC, and secured to studs with No. 10 x 2 in. screw through the center hole. Furring channels are friction fit into clips.
MASON INDUSTRIES INC — Type CWC-50

7. **Wall and Partition Facings and Accessories*** — (Optional, Not Shown) — Nominal 1/2 in. thick, 4 ft wide panels, for optional use as an additional layer on one or both sides of the assembly. Panels attached in accordance with manufacturer's recommendations. When the QR-500 or QR-510 panel is installed between the steel framing and the UL Classified gypsum board, the required UL Classified gypsum board layer(s) is/are to be installed as indicated as to fastener type and spacing, except that the required fastener length shall be increased by a minimum of 1/2 in. Not evaluated or intended as a substitute for the required layer(s) of UL Classified Gypsum Board.
PABCO BUILDING PRODUCTS L L C, DBA PABCO GYPSUM — Type QuietRock QR-500 and QR-510

8. **Mineral and Fiber Board*** — (Optional, Not Shown) — For optional use as an additional layer on one side of wall. Nom 1/2 in. thick, 4 ft wide with long dimension parallel and centered over studs. Attached to studs and floor and ceiling runners with 1-5/8 in. long Type 5 steel screws, spaced 12 in. OC and 24 in. OC along all intermediate framing. The required UL Classified gypsum board layer (Item 4M) is to be installed over the Mineral and Fiber Boards, Batts and Blankets, Item 3D, and Adhesive, Item 11, as required.
HOMASOTE CO — Homasote Type 440-32

8A. **Mineral and Fiber Board** — (Optional, Not Shown) — For optional use as an additional layer on one side of wall - Nom 1/2 in. thick, 4 ft wide square edge fiber boards applied vertically to studs on one side of the wall in between the wood studs and the UL Classified Gypsum Board (Item 4). Fiber boards installed with 1-1/4 in. long, Type 5 steel screws spaced 12 in. OC max, with the last screws spaced 2 in. and 6 in. from edge of board. Gypsum Board (Item 4) installed as indicated as to fastener type and spacing, except that the required fastener length shall be increased by a minimum of 1/2 in. Not evaluated or intended as a substitute for the required layer(s) of UL Classified Gypsum Board. Not evaluated for use with Item 4M.
BLUE RIDGE FIBERBOARD INC — SoundStop

8B. **Mineral and Fiber Board*** — (Optional, Not Shown) — For optional use as an additional layer on one side of wall. Nom 1/2 in. thick, 4 ft wide with long dimension parallel and centered over studs. Attached to studs and floor and ceiling runners with 1-5/8 in. long Type 5 steel screws, spaced 12 in. OC and 24 in. OC along all intermediate framing. The required UL Classified gypsum board layer is to be installed over the Mineral and Fiber Boards and secured to studs with length of fasteners increased by 1/2 in. over the length specified for installation of the gypsum boards, Batts and Blankets, Item 3, are optional unless otherwise required. Not for use with Items 4F, 4J, 4L, and 4M.
HOMASOTE CO — Homasote Type 440-32

9. **Lead Batten Strips** — (Not Shown, For Use With Item 4E) — Lead batten strips, min 1-1/2 in. wide, max 10 ft long with a max thickness of 0.125 in. Strips placed on the interior face of studs and attached from the exterior face of the stud with two 1 in. long Type 5-12 pan head steel screws, one at the top of the strip and one at the bottom of the strip. Lead batten strips to have a purity of 99.9% meeting the Federal specification QQ-L-2011, Grade "C". Lead batten strips required behind vertical joints of lead backed gypsum board (Item 4E) and optional at remaining stud locations. Required behind vertical joints.

9A. **Lead Batten Strips** — (Not Shown, for use with Item 4J) — Lead batten strips, 2 in. wide, max 10 ft long with a max thickness of 0.140 in. Strips placed on the face of studs and attached to the stud with two min. 1 in. long min. Type 5-8 pan head steel screws, one at the top of the strip and one at the bottom of the strip or with one min. 1 in. long min. Type 5-8 pan head steel screw at the top of the strip. Lead batten strips to have a purity of 99.5% meeting the Federal specification QQ-L-2011, Grades "B, C or D". Lead batten strips required behind vertical joints of lead backed gypsum wallboard (Item 4J) and optional at remaining stud locations.

10. **Lead Discs or Tabs** — (Not Shown, For Use With Item 4E) — Used in lieu of or in addition to the lead batten strips (Item 8) or optional at other locations - Max 3/4 in. diam by max 0.125 in. thick lead discs compression fitted or adhered over steel screw heads or max 1/2 in. by 1-1/4 in. by max 0.125 in. thick lead tabs placed on gypsum boards (Item 4E) underneath screw locations prior to the installation of the screws. Lead discs or tabs to have a purity of 99.9% meeting the Federal specification QQ-L-2011, Grade "C".

10A. **Lead Discs** — (Not Shown, for use with Item 4J) — Max 5/16 in. diam by max 0.140 in. thick lead discs compression fitted or adhered over steel screw heads. Lead discs to have a purity of 99.5% meeting the Federal Specification QQ-L-2011, Grades "B, C or D".

11. **Adhesive** — Not Shown — (For use with Item 8) — Construction grade adhesive applied in vertical, serpentine, nominal 3/8 in. wide beads down the length of both vertical edges of Mineral and Fiber Board (Item 8).

12. **Wall and Partition Facings and Accessories*** — (CLBV) (Optional, Not Shown) — For use with Items 1 to 11, Items 2 to 2J, Item 3, Items 4 to 4I, Item 5 and Item 6. For maximum fire rating of 1 hour. On one side of the wall, over the first layer of Gypsum Board (Item 4 to Item 4I), install Reflexor membrane with the gold side facing outwards. Membrane installed with 150 staples spaced 12 inches on center in both directions as per manufacturer's instructions, seams in membrane to be overlapped by 2 inches. When Reflexor membrane is used an additional layer of Gypsum Board that is identical to the one used in the first layer and as specified in Item 4 to Item 4I shall be installed over the membrane. The additional layer of Gypsum Board to be installed through the membrane to the stud as specified in Item 4 to Item 4I except the fastener length shall be increased by a minimum of 5/8 inch. Install Batts and Blankets in the stud cavity as per Item 3.

On the other side of the wall, prior to the installation of the Gypsum Board, install Resilient Channels as per Item 6. Over the Resilient Channels install 3/4 inch thick SONOpan panel secured to the Resilient Channels with min. 1-1/4 in. long drywall screws and washers spaced at 16 in. OC on the perimeter of the panel and 8 in. OC in the field of the panel. Over the SONOpan panel install the same Gypsum Board as specified in Item 4 to Item 4I with the fastener length increased by minimum 3/4 inch. Not evaluated or intended as a substitute for the required layer(s) of UL Classified Gypsum Board.

Alternatively, on the other side of the wall prior to the installation of the Gypsum Board, install 3/4 in. thick SONOpan panels, secured to one side of studs either horizontally or vertically. Panels secured to each stud with min. 1-1/4 in. long drywall screws spaced 12 in. OC. Over the SONOpan, install 25 MSG galv steel, Resilient Channels, spaced vertically 24 in. OC. Resilient Channels fastened through panels to each stud with min. 2 in. long drywall screws or self-tapping screws. Over the Resilient Channels install Gypsum Board as specified in Item 4 to Item 4I with the specified drywall screws. Panels not evaluated or intended as a substitute for the required layer(s) of UL Classified Gypsum Board.

MSL — Reflexor membrane, SONOpan panel

13. **Barrier Mesh** — (Optional, Not Shown) — Attached to steel studs on one or both sides of the wall using Barrier Mesh Clips spaced at maximum 12 inches on center vertically, using a flat head type screw penetrating through the steel at least 3/8 of an inch. For Steel Studs less than 0.033 inches in thickness, use self-piercing screws. For Steel Studs equal to or greater than 0.033 inches in thickness, use steel drill screws (self-tapping). Gypsum Board (Item 4) to be installed directly over the Barrier Mesh using prescribed screw patterns with lengths increased by a minimum 1/8 in. Barrier Mesh may be installed with the long dimension of the diamond pattern positioned vertically or horizontally. Barrier Mesh joints may occur as butt joints at the framing members and secured using the Barrier Mesh Clips or occur in between framing members as overlapping joints secured using 18 SWG wire ties spaced a maximum 12 in. on center.
CLARKDIETRICH BUILDING SYSTEMS — Barrier Mesh, Barrier Mesh Clips

* Indicates such products shall bear the UL or cUL Certification Mark for jurisdictions employing the UL or cUL Certification (such as Canada), respectively.

Last Updated on 2022-05-25

The appearance of a company's name or product in this database does not in itself assure that products so identified have been manufactured under UL's Follow-Up Service. Only those products bearing the UL Mark should be considered to be Certified and covered under UL's Follow-Up Service. Always look for the Mark on the product.

UL permits the reproduction of the material contained in the Online Certification Directory subject to the following conditions: 1. The Guide Information, Assemblies, Constructions, Designs, Systems, and/or Certifications (files) must be presented in their entirety and in a non-misleading manner, without any manipulation of the data (or drawings). 2. The statement "Reprinted from the Online Certifications Directory with permission from UL" must appear adjacent to the extracted material. In addition, the reprinted material must include a copyright notice in the following format: "© 2022 UL LLC"

METAL FABRICATIONS NEW FACILITY
4323 AVIATION AVENUE, TALLAHASSEE, FL 32310

U.L. RATED ASSEMBLIES

CONN + ARCHITECTS
Tallahassee, Florida 32308 | 850-878-9784
1960-C Buford Boulevard | Tallahassee, Florida 32308
www.CONNarchitects.com | L.C. No. AA-C001662

DATE 07-21-24

DRAWN BY DBC

REVISED

JOB NO. 23-208

DATE SHEET NUMBER

A8.1

1 UL DESIGN NO. U465 (CONTINUED)
A8.1 1-HOUR RATED WALL ASSEMBLY

METAL FABRICATIONS NEW FACILITY

4323 AVIATION AVENUE, TALLAHASSEE, FL 32310

METAL FABRICATIONS NEW FACILITY
4323 AVIATION AVENUE, TALLAHASSEE, FL 32310

COVER SHEET / INDEX OF DRAWINGS

INDEX OF DRAWINGS

ARCHITECTURAL	MECHANICAL
G1.0 COVER SHEET	M1.0 OVERALL MECHANICAL PLAN
LS1.0 LIFE SAFETY PLAN	M2.0 ENLARGED MECHANICAL PLAN
A1.0 OVERALL FLOOR PLAN	M3.0 HVAC SCHEDULES & DETAILS
A1.1 ROOF PLAN	
A1.2 ENLARGED OFFICE PLAN	ELECTRICAL
A1.3 OVERALL REFLECTED CEILING PLAN	E1.0 ELECTRICAL SITE PLAN
A1.4 OFFICE REFLECTED CEILING PLAN AND DETAILS	E1.1 LIGHTING PLAN
A1.5 WAREHOUSE EQUIPMENT PLAN	E1.2 POWER PLAN
A2.0 EXTERIOR ELEVATIONS	E1.3 ENLARGED LIGHTING PLAN
A3.0 BUILDING SECTIONS	E1.4 ENLARGED POWER PLAN
A4.0 WALL SECTIONS	E1.5 ELECTRICAL SCHEDULES & DETAILS
A4.1 WALL SECTIONS	E1.6 ELECTRICAL SCHEDULES & DETAILS
A4.2 WALL SECTIONS	
A4.3 WALL SECTIONS	
A4.4 WALL SECTIONS	
A4.5 WALL SECTIONS	
A4.6 WALL SECTIONS	
A4.7 WALL SECTIONS	
A4.8 WALL SECTIONS	
A5.0 SCHEDULES AND DOOR ELEVATIONS	
A5.1 STOREFRONT WINDOW / GLASS WALL ELEVATIONS	
A6.0 ENLARGED RESTROOM PLANS AND ELEVATIONS	
A6.1 RESTROOM INTERIOR ELEVATIONS	
A7.0 INTERIOR ELEVATIONS	
A8.0 U.L. RATED ASSEMBLIES	
A8.1 U.L. RATED ASSEMBLIES	
STRUCTURAL	
S0.1 STRUCTURAL NOTES	
S1.1 FOUNDATION PLAN	
S2.1 ROOF FRAMING PLAN	
S3.1 WALL SECTIONS	
S3.2 WALL SECTIONS	
S3.3 WALL SECTIONS	
S4.1 TYPICAL DETAILS	
PLUMBING	
P1.0 OVERALL GROUND FLOOR UNDERSLAB SANITARY PLAN	
P2.0 ENLARGED UNDERSLAB SANITARY PLAN	
P2.1 ENLARGED PLUMBING PLAN	
P3.0 PLUMBING SCHEDULES & DETAILS	

SYMBOLS LEGEND

	ROOM NAME
	ROOM TAG: SEE WALL TYPE LEGEND SCHEDULE.
	WALL / PARTITION TAG: SEE WALL TYPE LEGEND SCHEDULE.
	WINDOW / STOREFRONT SYSTEM TAG: SEE WINDOW / STOREFRONT SYSTEM SCHEDULE.
	DOOR TAG: SEE DOOR SCHEDULE.
	INTERIOR ELEVATION REFERENCE: SEE INTERIOR ELEVATION AS INDICATED ON TAG.
	EXTERIOR ELEVATION REFERENCE: SEE ELEVATION AS INDICATED ON TAG.
	SECTION REFERENCE: SEE WALL OR BUILDING SECTION AS INDICATED IN SECTION MARKER.
	DETAIL REFERENCE: SEE ENLARGED DETAIL AS INDICATED IN DETAIL MARKER.
	KEY NOTE TAG: REFER TO KEY NOTE (ON SAME SHEET) AS INDICATED ON KEY NOTE TAG.
	EQUIPMENT IDENTIFICATION TAG: REFER TO EQUIPMENT PLAN AND EQUIPMENT SCHEDULE.


ABBREVIATION LEGEND

GENERAL ABBREVIATIONS	
ACM	ALUMINUM COMPOSITE MATERIAL
ACT	ACOUSTICAL CEILING TILE
AFF	ABOVE FINISHED FLOOR
ARCH.	ARCHITECT
B.O.	BOTTOM OF
BRG.	BEARING
CJ	CONTROL JOINT
CL	CENTER LINE
CLR	CLEAR
CMU	CONCRETE MASONRY UNIT
COL.	COLUMN
CONC.	CONCRETE
CONST.	CONSTRUCTION
CONT.	CONTINUOUS
COORD.	COORDINATE
CPT	CARPET
CT	CERAMIC TILE
DIA.	DIAMETER
DTL.	DETAIL
EDC.	ELECTRICAL DISTRIBUTION CENTER
EIFS	EXTERIOR INSULATION FINISH SYSTEM
EJ	EXPANSION JOINT
ELEC.	ELECTRICAL
ELEV.	ELEVATION
EP	EPOXY PAINT
EPS	EXPANDED POLYSTYRENE
EQ.	EQUAL
FDN	FOUNDATION
F.E.	FIRE EXTINGUISHER
FRP	FIBER REINFORCED PLASTIC
FTG.	FOOTING
F.V.	FIELD VERIFY
GA.	GAUGE
GC.	GENERAL CONTRACTOR
GSF	GROSS SQUARE FOOTAGE
GWB	GYP-SUM WALL BOARD
GWH	GAS WATER HEATER
HT.	HEIGHT
HORIZ.	HORIZONTAL
INFO.	INFORMATION
ISO.	ISOLATION
JNT.	JOINT
JST.	JOIST
LB.	POUNDS
LONG.	LONGITUDINAL
LVT.	LUXURY VINYL TILE
MAX.	MAXIMUM
MECH.	MECHANICAL
MFG. / MFR.	MANUFACTURER
MIN.	MINIMUM
MISC.	MISCELLANEOUS
M.O.	MASONRY OPENING
MTL.	METAL
M.R.	MOISTURE RESISTANT
N.I.C.	NOT IN CONTRACT
N.T.S.	NOT TO SCALE
NO.	NUMBER
O.C.	ON CENTER
O.D.	OUTSIDE DIAMETER
O.H.	OPPOSITE HAND
P.A.F.	POWDER ACTUATED FASTENER
P.L. / P. LAM.	PLASTIC LAMINATE
PLF	POUNDS PER LINEAR FOOT
PNT	PAINT
PSF	POUNDS PER SQUARE FOOT
PSI	POUNDS PER SQUARE INCH
P.T.	PRESSURE TREATED
QTY	QUANTITY
REF.	REFER
REQD	REQUIRED
REV.	REVERSE
R.O.	ROUGH OPENING
RTU	ROOF TOP UNIT
SCHED.	SCHEDULE
S.F.	SUB-FLOOR
SF	SQUARE FEET
SIM.	SIMILAR
SPECS.	SPECIFICATIONS
SQ. FT.	SQUARE FOOT (FEET)
STRUC.	STRUCTURAL
S.V.	SHEET VINYL
TYP.	TYPICAL
T&B.	TOP AND BOTTOM
T&G.	TONGUE AND GROOVE
T.O.	TOP OF
TRANS.	TRANSVERSE
U.N.O.	UNLESS NOTED OTHERWISE
TYP.	TYPICAL
VCT	VINYL COMPOSITION TILE
VERT.	VERTICAL
W.H.	WATER HEATER

BUILDING CLASSIFICATION AND DATA

APPLICABLE CODES	8TH (2023) EDITION 8TH (2023) EDITION 8TH (2023) EDITION 8TH (2023) EDITION 8TH (2023) EDITION 8TH (2023) EDITION 8TH (2023) EDITION 2020 EDITION
FLORIDA BUILDING CODE (FBC-B)	
FLORIDA ACCESSIBILITY CODE (FBC-A)	
FLORIDA ENERGY CONSERVATION CODE (FBC-EC)	
FLORIDA MECHANICAL CODE (FBC-M)	
FLORIDA PLUMBING CODE (FBC-P)	
FLORIDA FUEL GAS CODE (FBC-FG)	
FLORIDA FIRE PREVENTION CODE (FFPC)	
NATIONAL ELECTRICAL CODE (NEC)	
OCCUPANCY GROUP CLASSIFICATION	
FBC-B: MIXED-USE NONSEPARATED OCCUPANCIES:	
GROUP B - BUSINESS	
GROUP F-2 - LOW-HAZARD FACTORY	
TYPE OF CONSTRUCTION	
NEW CONSTRUCTION: TYPE II-B (UN-SPRINKLERED)	
BUILDING HEIGHT AND AREA	
TOTAL BUILDING AREA (SINGLE STORY):	15,625 S.F.
ALLOWABLE AREA PER TABLE 506.2 (2023 FBC-B):	23,000 S.F.
TOTAL NUMBER OF STORIES:	1 STORY
ALLOWABLE NUMBER OF STORIES PER TABLE 504.4 (2023 FBC-B):	3 STORIES
TOTAL BUILDING HEIGHT:	22'-10"
ALLOWABLE BUILDING HEIGHT PER TABLE 504.3 (2023 FBC-B):	55 FEET
OCCUPANT LOAD	
REFER TO LIFE SAFETY PLAN	
DESIGN LOADS	
REFER TO STRUCTURAL DRAWINGS	
ACCESSIBILITY COMPLIANCE	
ACCESSIBILITY IS INCORPORATED THROUGHOUT, AND IS IN COMPLIANCE WITH THE 8TH EDITION (2023) FLORIDA ACCESSIBILITY CODE.	
PRODUCTS APPROVAL	
THE CONTRACTOR SHALL MAKE AVAILABLE TO THE BUILDING INSPECTOR ANY DOCUMENTATION NECESSARY TO VERIFY THAT ALL EXTERIOR ENVELOPE PRODUCTS REQUIRING APPROVAL PER FS 553.842 ARE IN COMPLIANCE WITH PRODUCT APPROVAL INSTALLATION REQUIREMENTS.	
METAL BUILDING MANUFACTURER	
M.B.M - METAL BUILDING MANUFACTURER. ALL STRUCTURAL STEEL, INCLUDING BUT NOT LIMITED TO BEAMS, COLUMNS, BAR JOISTS, PURLINS, GIRTS, DECKING, CLIP ANGLES, ROOFING, ROOF FLASHING, BACK PANELS AND ALL ASSOCIATED CONNECTIONS SHALL BE DESIGNED, ENGINEERED AND SUPPLIED BY THE M.B.M. AND SHALL BE CERTIFIED BY A FLORIDA REGISTERED ENGINEER. SHOP DRAWINGS SHALL BE FORWARDED TO CONN ARCHITECTS.	
METAL BUILDING SHOP DRAWINGS	
THE CONTRACTOR SHALL PROVIDE SIGNED, DATED, AND SEALED METAL BUILDING SHOP DRAWINGS TO THE CITY OF TALLAHASSEE BUILDING INSPECTOR PRIOR TO INSPECTIONS.	
GENERAL REQUIREMENT NOTES	
THE ROOF CONSTRUCTION IS LIGHT-FRAME TRUSS AS REQUIRED BY FS 633.027(1). AS SUCH THE STRUCTURE SHALL BE POSTED WITH SIGNAGE MEETING THE REQUIREMENTS OF THE FLORIDA ADMINISTRATIVE CODE 69A-60.0081.	
FIRE ALARM / FIRE SPRINKLER	
A FIRE ALARM SYSTEM IS NOT REQUIRED FOR THIS BUILDING IN ACCORDANCE WITH 8TH (2023) EDITION FBC-B SECTIONS 907.2.5, 907.2.2 AND FFPC SECTION 38.3.4.1 (LESS THAN 300 OCCUPANTS)	
A FIRE SPRINKLER SYSTEM IS NOT REQUIRED FOR THIS BUILDING IN ACCORDANCE WITH 8TH (2023) EDITION FBC-B SECTION 903 AND 8TH (2023) EDITION FFPC.	

SITE LOCATION MAP

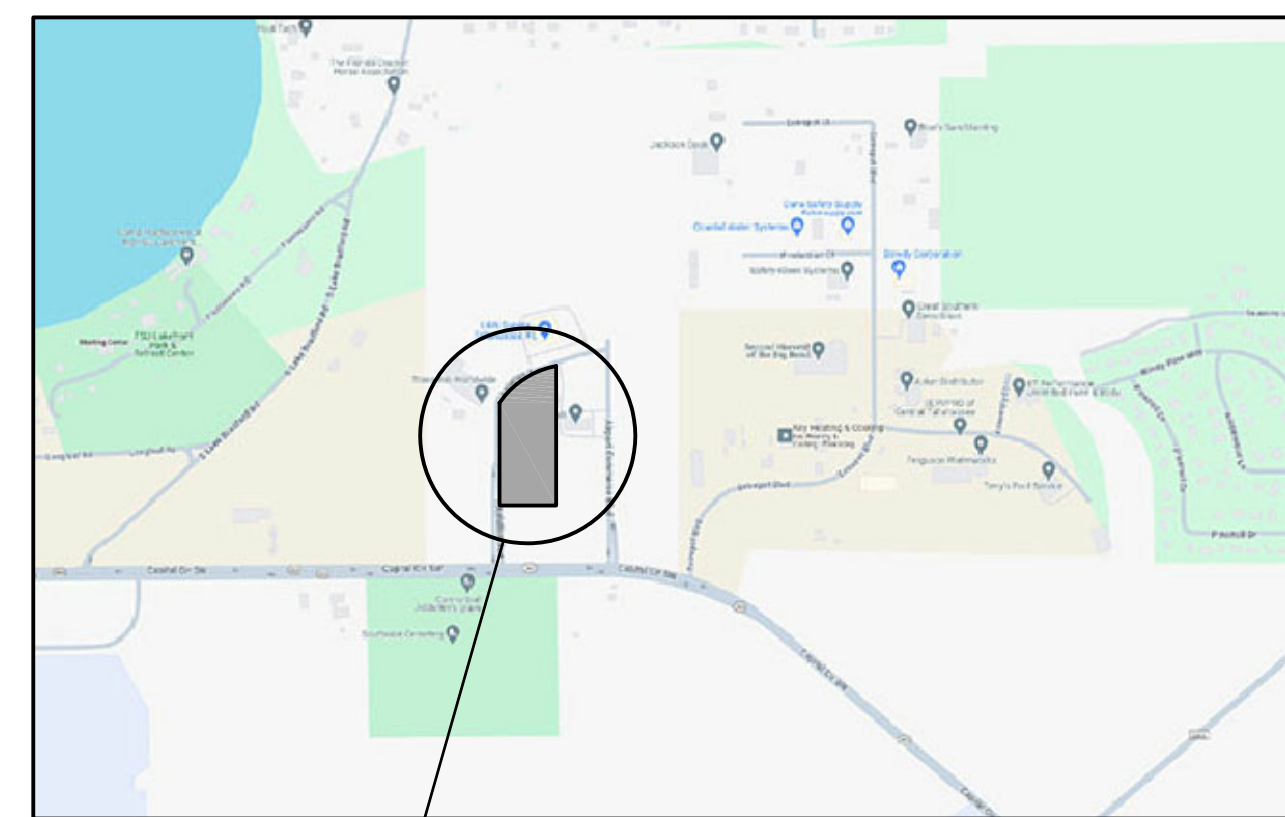

SITE
4323 AVIATION AVENUE, TALLAHASSEE, FL 32310 N.T.S.

PROJECT TEAM


PROJECT OWNER	
METAL FABRICATIONS AND SALES OF TALLAHASSEE 3600-D WEEMS ROAD, TALLAHASSEE, FLORIDA 32317 (850) 205-2300	
ARCHITECT	STRUCTURAL ENGINEER
CONN ARCHITECTS 1960-C BUFORD BLVD. TALLAHASSEE, FLORIDA 32308 (850) 878-8784	KEVER MCKEE ENGINEERING 1624 METROPOLITAN BLVD, STE. A TALLAHASSEE, FLORIDA 32308 (850) 727-5367
ELECTRICAL ENGINEER	CIVIL ENGINEER
C-H ENGINEERING INC. 13313 DOLCETTO CV. FORT WAYNE, INDIANA (260) 450-0501	SOUTHEASTERN CONSULTING SERVICES, LLC 239 PINWOOD DRIVE, TALLAHASSEE, FLORIDA 32303 (850) 544-6771
MECHANICAL / PLUMBING ENGINEER	CONTRACTOR
FUNCTIONS ENGINEERING SERVICES 107 OAK RIDGE PLACE PANAMA CITY BEACH, FLORIDA 32408 (850) 775-7012	

CONN ARCHITECTS, INC. IS AN EQUAL OPPORTUNITY AFFIRMATIVE ACTION EMPLOYER. WE DO NOT DISCRIMINATE ON THE BASIS OF RACE, GENDER, RELIGION, NATIONAL ORIGIN, ANCESTRY, COLOR, SEX, AGE, SEXUAL ORIENTATION, OR DISABILITY. ANY PART OF THESE DOCUMENTS MAY BE REPRODUCED, STORED IN A RETRIEVAL SYSTEM, OR TRANSMITTED IN ANY FORM OR BY ANY MEANS, ELECTRONIC, MECHANICAL, PHOTOCOPIING, RECORDING, OR OTHERWISE, WITHOUT THE PRIOR WRITTEN PERMISSION OF CONN ARCHITECTS, INC.

CONN + ARCHITECTS
1960-C Buford Boulevard Tallahassee, Florida 32308 | 850-878-8784
www.connarchitects.com | Lic. No. AA-C001662

DATE	07-21-24
DRAWN BY	DBC
REVISED	
JOB NO.	23-208
DATE	
SHEET NUMBER	G1.0

PRICING SET - NOT FOR CONSTRUCTION

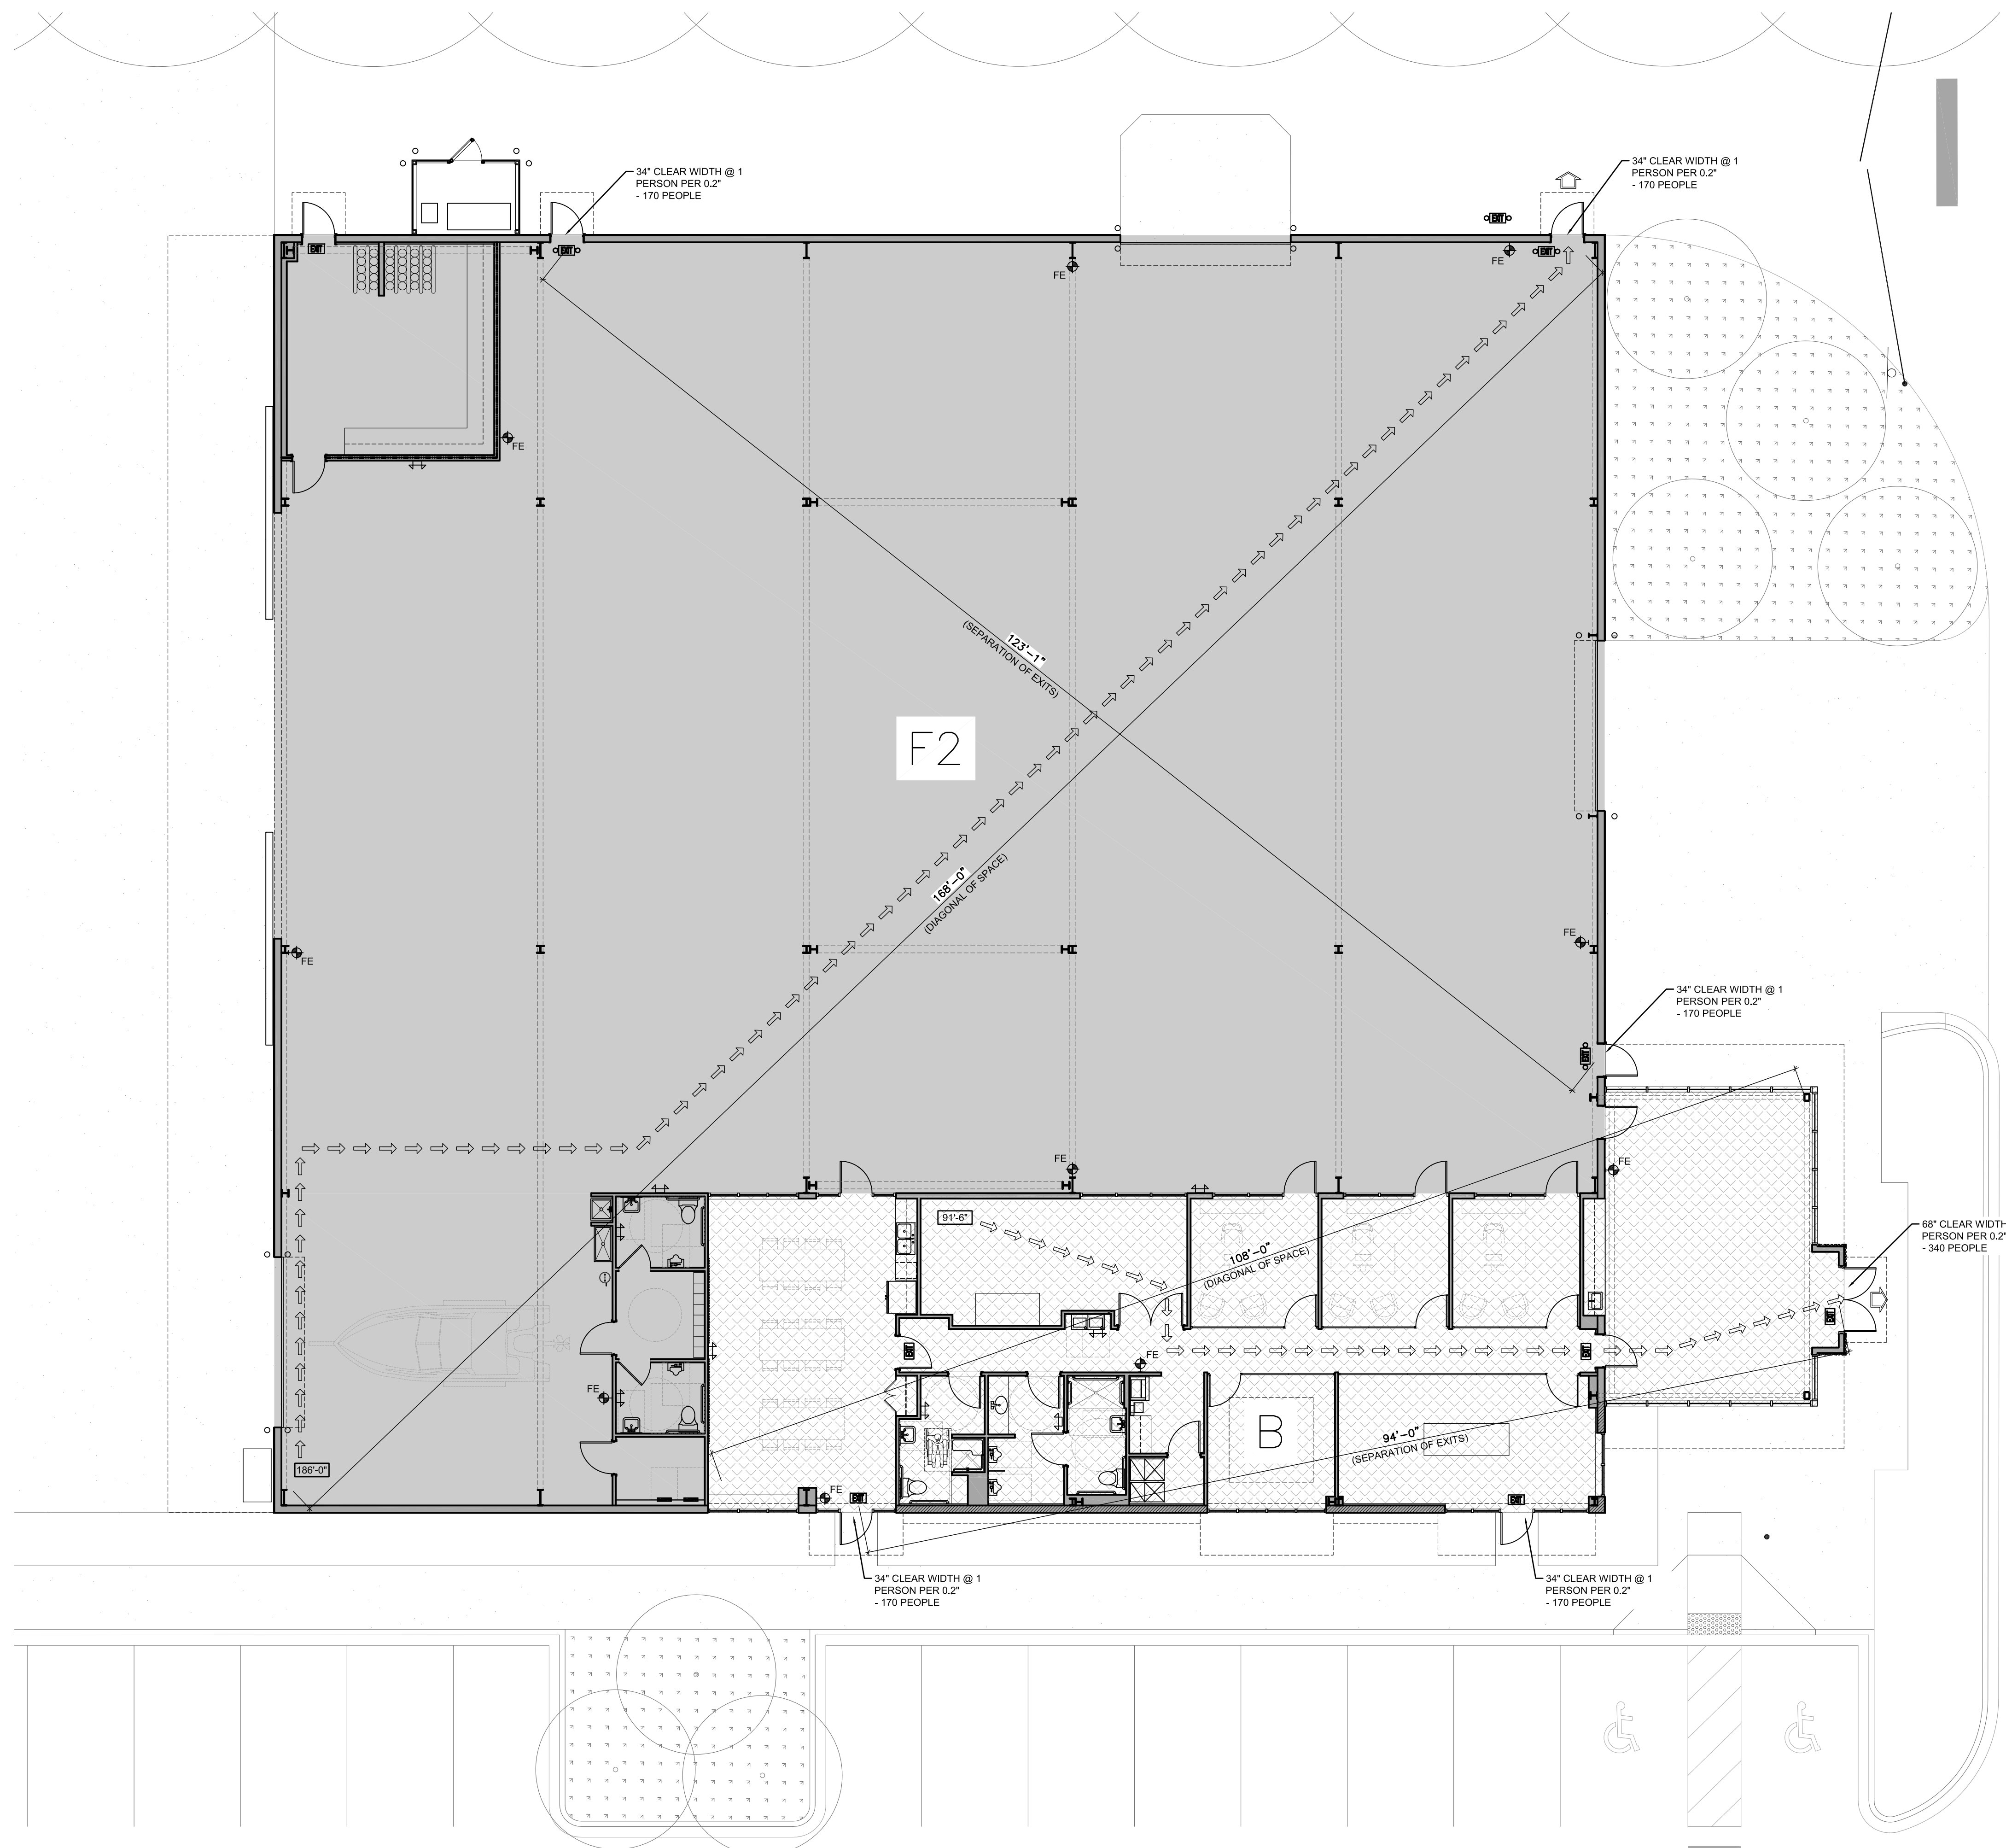

EMERGENCY EGRESS INFORMATION

REQUIRED EMERGENCY EGRESS CAPACITY	
- EGRESS WIDTH PER PERSON (AT DOORS) (NFPA 101 TABLE 7.3.3.1):	0.2 INCHES
- MINIMUM CORRIDOR WIDTH FOR EGRESS: (BUSINESS AND STORAGE S-2 OCCUPANCIES - NFPA 101 TABLE 7.3.3.1 FLORIDA FIRE PREVENTION CODE (2023) 8TH ED.)	44 INCHES
- MINIMUM CLEAR OPENING OF EXIT DOOR:	34 INCHES
- MINIMUM NUMBER OF EXITS PER FLOOR:	2 EXITS
- MINIMUM CLEAR WIDTH FOR HIC ACCESSIBLE EGRESS:	36 INCHES
PROVIDED EMERGENCY EGRESS (GROUP B OCCUPANCY)	
- MINIMUM CLEAR CORRIDOR WIDTH: 4'-0" (48"), 48.0' / 0.2" =	240 PERSON CAPACITY
- SINGLE DOOR OPENING CLEAR WIDTH: (34"), 34.0' / 0.2" = 170 - (2) PROVIDED =	340 PERSON CAPACITY
- DOUBLE DOOR OPENING CLEAR WIDTH: (68"), 68.0' / 0.2" = 340 - (1) PROVIDED =	340 PERSON CAPACITY
PROVIDED EMERGENCY EGRESS (GROUP F-2 OCCUPANCY)	
- SINGLE DOOR OPENING CLEAR WIDTH: (34"), 34.0' / 0.2" = 170 - (3) PROVIDED =	510 PERSON CAPACITY
TRAVEL DISTANCE REQUIREMENTS	
- MAXIMUM TRAVEL DISTANCE TO EXIT: (BUSINESS - NON-SPRINKLERED):	200 FEET
- ACTUAL MAXIMUM TRAVEL DISTANCE TO EXIT:	APPROXIMATELY 91'-6"
- MAXIMUM TRAVEL DISTANCE TO EXIT: (F-2 FACTORY INDUSTRIAL - NON-SPRINKLERED):	300 FEET
- ACTUAL MAXIMUM TRAVEL DISTANCE TO EXIT: (PATH OF TRAVEL DISTANCE SHOWN ON PLANS)	APPROXIMATELY 186'-0"
EXIT ACCESS DOORWAY DISTANCE	
- MAXIMUM DIAGONAL DIMENSION OF GROUP B OCCUPANCY:	108'-0"
- REQUIRED SEPARATION OF EXITS: 1/2 DIAGONAL (NON-SPRINKLERED):	54'-0"
- ACTUAL SEPARATION OF EXITS:	94'-0"
- MAXIMUM DIAGONAL DIMENSION OF GROUP F-2 OCCUPANCY:	168'-0"
- REQUIRED SEPARATION OF EXITS: 1/2 DIAGONAL (NON-SPRINKLERED):	84'-0"
- ACTUAL SEPARATION OF EXITS:	123'-1"

NONSEPARATED OCCUPANCY NOTE

THIS BUILDING SHALL BE CLASSIFIED AS A MIXED-USE NONSEPARATED OCCUPANCY (SECTION 508.3, 2023 (8TH ED.) FBC-B) CONSISTING OF BUSINESS (GROUP B) AND LOW-HAZARD FACTORY INDUSTRIAL (GROUP F-2) AS CLASSIFIED IN ACCORDANCE WITH SECTIONS 304.1 AND 306.3, 2023 (8TH ED.) FBC-B. SECTION 508.3.3 INDICATES THAT NO SEPARATION IS REQUIRED BETWEEN NONSEPARATED OCCUPANCIES. BOTH GROUP B AND F-2 OCCUPANCIES COMPLY WITH THE PROVISIONS SET FORTH IN TABLES 504.3, 504.4 AND 506.2, 2023 (8TH ED.) FBC-B. ADDITIONALLY, THERE ARE NO FIRE-SPRINKLER REQUIREMENTS FOR EITHER OCCUPANCY AS PER CHAPTER 9, 2023 (8TH ED.) FBC-B AND 2024 NFPA 101. THEREFORE, THE BUILDING IS NOT REQUIRED TO BE SPRINKLERED AND THE SEPARATION OF THE TWO OCCUPANCIES IS NOT REQUIRED.

OCCUPANCY LOAD

MIXED-USE OCCUPANCY (BUSINESS: GROUP B AND LOW-HAZARD FACTORY INDUSTRIAL: GROUP F-2)	
GROUP B AREA =	3,428 S.F.
3,428 S.F. / 150 S.F. GROSS PER PERSON =	23 PEOPLE
GROUP F-2 AREA =	12,197 S.F.
12,197 S.F. / 100 S.F. GROSS PER PERSON =	122 PEOPLE
TOTAL OCCUPANT LOAD (GROUP B + GROUP F-2) =	145 PEOPLE

OCCUPANCY TYPE LEGEND

	OCCUPANCY 1 - OCCUPANCY: BUSINESS, GROUP B - AREA: 3,137 S.F. - NON-SPRINKLERED
	OCCUPANCY 2 - OCCUPANCY: LOW-HAZARD FACTORY INDUSTRIAL, GROUP F-2 - AREA: 12,468 S.F. - NON-SPRINKLERED

FIRE PROTECTION NOTES

- SEE COVER SHEET G1.0 FOR PROJECT INFORMATION.
- A FIRE ALARM SYSTEM IS NOT REQUIRED FOR THIS BUILDING IN ACCORDANCE WITH 8TH (2023) EDITION FBC-B SECTIONS 907.2.5, 907.2.2 AND FFPC SECTION 38.3.4.1 (LESS THAN 300 OCCUPANTS)
- A FIRE SPRINKLER SYSTEM IS NOT REQUIRED FOR THIS BUILDING IN ACCORDANCE WITH 8TH (2023) EDITION FBC-B SECTION 903 AND 8TH (2023) EDITION FFPC.
- ALL FIRE EXTINGUISHERS WITHIN THE BUSINESS AREA OF THIS PROJECT TO BE U.L. RATED 2-A:10-B-C FIRE EXTINGUISHERS IN SEMI-RECESSED CABINETS.
- ALL FIRE EXTINGUISHERS WITHIN THE INDUSTRIAL (WAREHOUSE) AREA OF THE PROJECT TO BE U.L. RATED 2-A:10-B-C FIRE EXTINGUISHERS ON WALL-MOUNT BRACKETS.

FIRE EXTINGUISHER INFORMATION

1 FIRE EXTINGUISHER PER 3,000 SQ. FT.
25,007 / 3,000 = 9 FIRE EXTINGUISHER MINIMUM REQUIRED.
SEE OVERALL PLANS FOR LOCATION OF 2A10BC (MIN.).
PLACE AS PLAN INDICATES OR ALONG PATH OF TRAVEL DISPERSED EVENLY ACROSS BUILDING.

FE FIRE EXTINGUISHERS TO BE LOCATED IN SPACE AS SHOWN.
PROVIDE WALL BRACKET AT ALL FIRE EXTINGUISHER LOCATIONS WITHIN GROUP B OCCUPANCY.
PROVIDE SEMI-RECESSED CABINETS AT ALL FIRE EXTINGUISHER LOCATIONS WITHIN GROUP F-2 OCCUPANCY.

FLOOR ELEVATION NOTE

THE ELEVATION OF THE FLOOR SURFACE ON BOTH SIDES OF A DOOR SHALL NOT VARY BY MORE THAN 1/2" FOR A DISTANCE NOT LESS THAN THE WIDTH OF THE WIDEST LEAF. NFPA 101, SECTION 7.2.1.3.1 AND 7.2.1.3.2, FLORIDA 8TH EDITION.

LEGEND

	CEILING MOUNTED ILLUMINATED EXIT SIGN (WITH BATTERY AND CHARGER). OPTIONAL SIDE HOUSED EMERGENCY LIGHTS AS REQUIRED TO ILLUMINATE MEANS OF EGRESS. SEE EMERGENCY LIGHT SYMBOL. WHERE SHOWN, ARROW INDICATES DIRECTION OF TRAVEL (E = EXISTING)
	PATH OF EGRESS TRAVEL
	ROOM NAME / ROOM NUMBER / OCCUPANT LOAD
	REMOTE TRAVEL DISTANCE
	POINT OF EXIT DISCHARGE
	FIRE EXTINGUISHER (E = EXISTING, R = RELOCATED), COORDINATE WITH FLOOR PLANS
	EMERGENCY WALL-PACK WITH INVERTER & BATTERY BACKUP (E = EXISTING), REFER TO ELECTRICAL.

METAL FABRICATIONS NEW FACILITY
 4323 AVIATION AVENUE, TALLAHASSEE, FL 32310
LIFE SAFETY PLAN

CONN + ARCHITECTS
 1960-C Buford Boulevard Tallahassee, Florida 32308 | 850-878-9784
 www.CONNarchitects.com | Lic. No. AA-C011662

DATE	07-21-24
DRAWN BY	DBC
REVISED	
JOB NO.	23-208
DATE	
SHEET NUMBER	LS1.0

1 LIFE SAFETY PLAN
 LS1.0 SCALE 1/8" = 1'-0"

CONN + ARCHITECTS, INC. IS AN EQUAL OPPORTUNITY AFFIRMATIVE ACTION EMPLOYER. WE DO NOT DISCRIMINATE ON THE BASIS OF RACE, GENDER, RELIGION, NATIONAL ORIGIN, ANCESTRY, AGE, SEX, OR DISABILITY. ANY PART OF THESE DOCUMENTS MAY BE REPRODUCED, STORED IN A RETRIEVAL SYSTEM, OR TRANSMITTED IN ANY FORM OR BY ANY MEANS, ELECTRONIC, MECHANICAL, PHOTOCOPIING, RECORDING, OR OTHERWISE, WITHOUT THE PRIOR WRITTEN PERMISSION OF CONN + ARCHITECTS, INC.

PRICING SET - NOT FOR CONSTRUCTION