CALLAWAY COMMUNITY CENTER CITY OF CALLAWAY, FL

PREPARED FOR:

CITY OF CALLAWAY



ADDRESS 6601 EAST HIGHWAY 22 CALLAWAY, FLORIDA 32404

PHONE: (850) 871-6000

CITY OF CALLAWAY OF CITY OFFICIALS:

MS. PAMN HENDERSON, MAYOR

MR. SCOTT DAVIS, WARD I COMMISSIONER

MR. DAVID GRIGGS, WARD II COMMISSIONER


MR. BOB PELLETIER, WARD III COMMISSIONER


MR. KENNETH L. AYERS, JR., WARD IV COMMISSIONER

MR. KEITH "EDDIE" COOK, CITY MANAGER MR. BILL FRYE, PUBLIC WORKS DIRECTOR

MR. TIM LEGARE, LEISURE SERVICES DIRECTOR

ADDRESS: 432 BEULAH AVE ~ (S17-T4S-R13W) LAT ~ 30° 08' 13" LONG ~ 85° 34' 14"

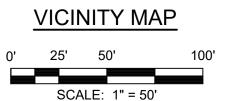

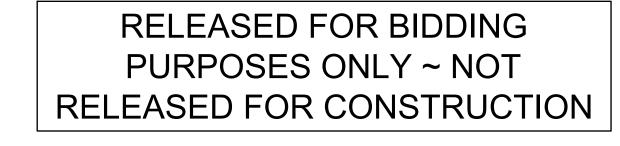

DECEMBER 2024 PROJECT No. 26043

DRAWING INDEX

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WATERS OF CALLAWAY BAYOU

0 - COVER SHEET

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2 - ELECTRICAL DEMOLITION PLAN

3 - HVAC DEMOLITION PLAN

4 - PLUMBING DEMOLITION PLAN

5 - EXISTING AND DEMO. ELEVATION PLAN ~ SOUTH AND EAST VIEWS

6 - EXISTING AND DEMO. ELEVATION PLAN ~ NORTH AND WEST VIEWS

7 - PROPOSED FLOOR PLAN

8 - PROPOSED ELEVATION PLAN ~ SOUTH AND EAST VIEWS

9 - PROPOSED ELEVATION PLAN ~NORTH AND WEST VIEWS

10 - PROPOSED ELECTRICAL PLAN

11 - PROPOSED PLUMBING, HVAC, AND RESTROOM PLANS

12 - PROPOSED REFLECTIVE CEILING PLAN

13 - RESTROOM DETAILS


14 - CONSTRUCTION DETAILS





to have underground utilities located and marked.


Sunshine Com


Always call 811 two full business days before you dig

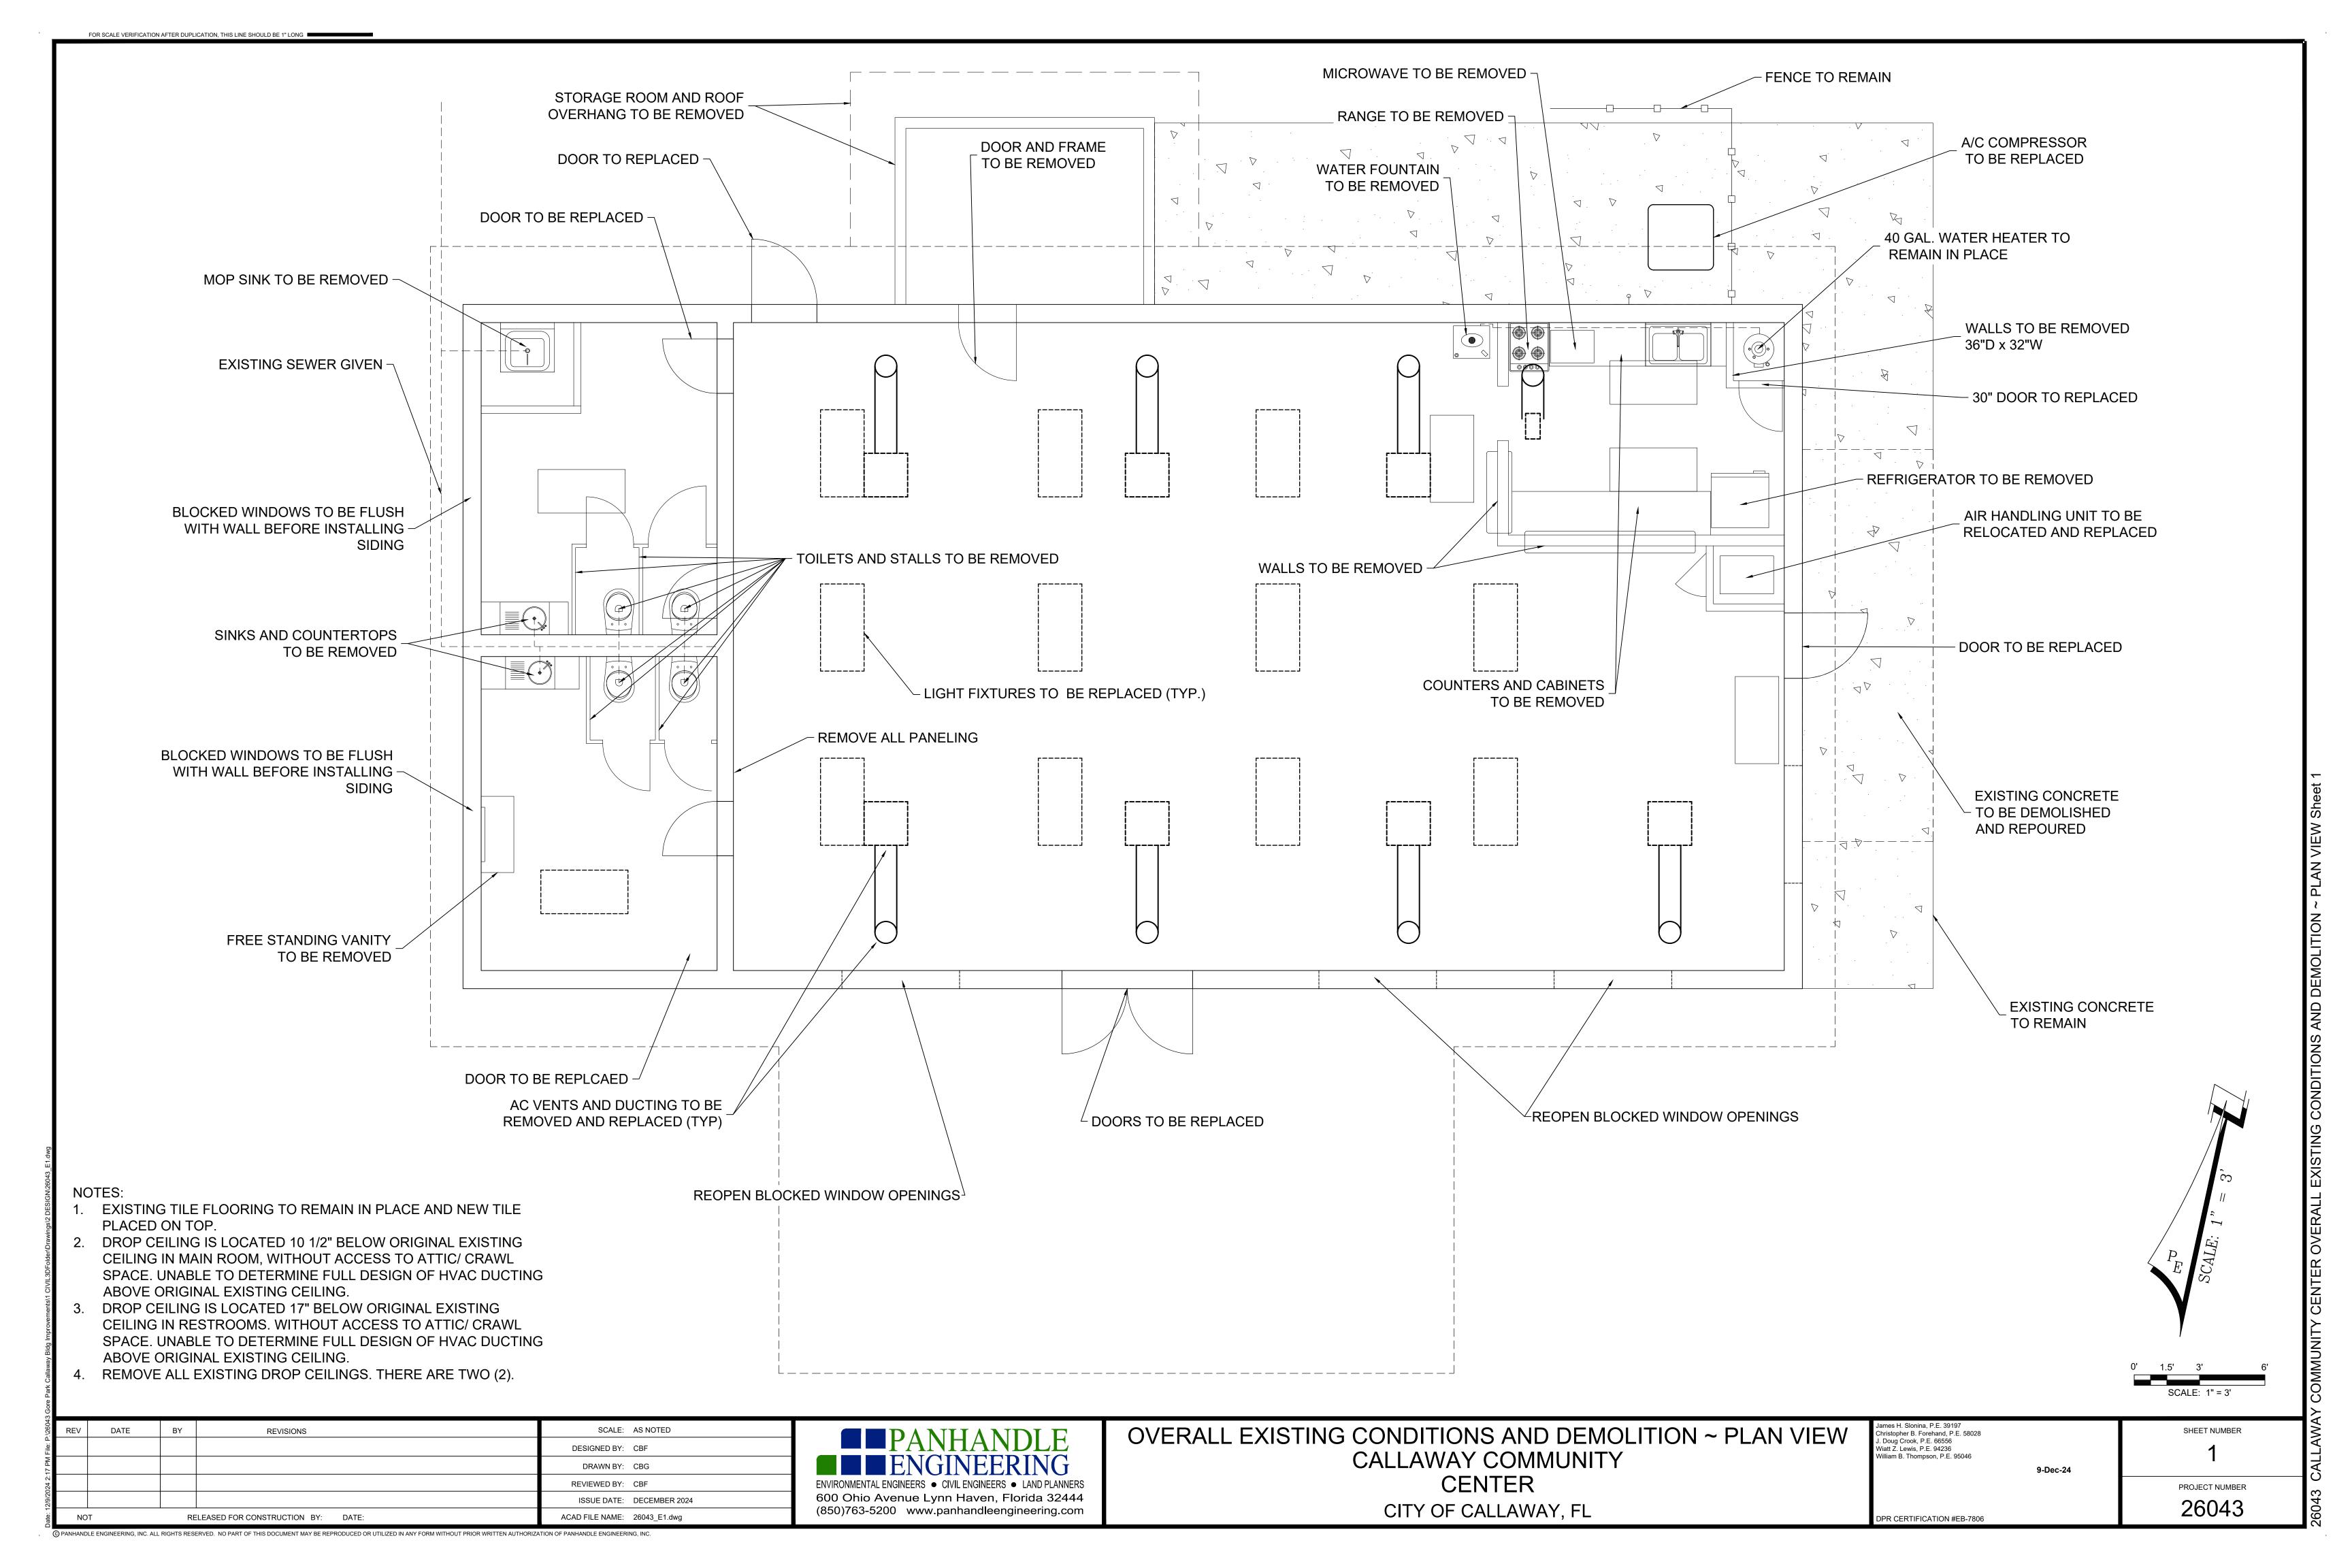


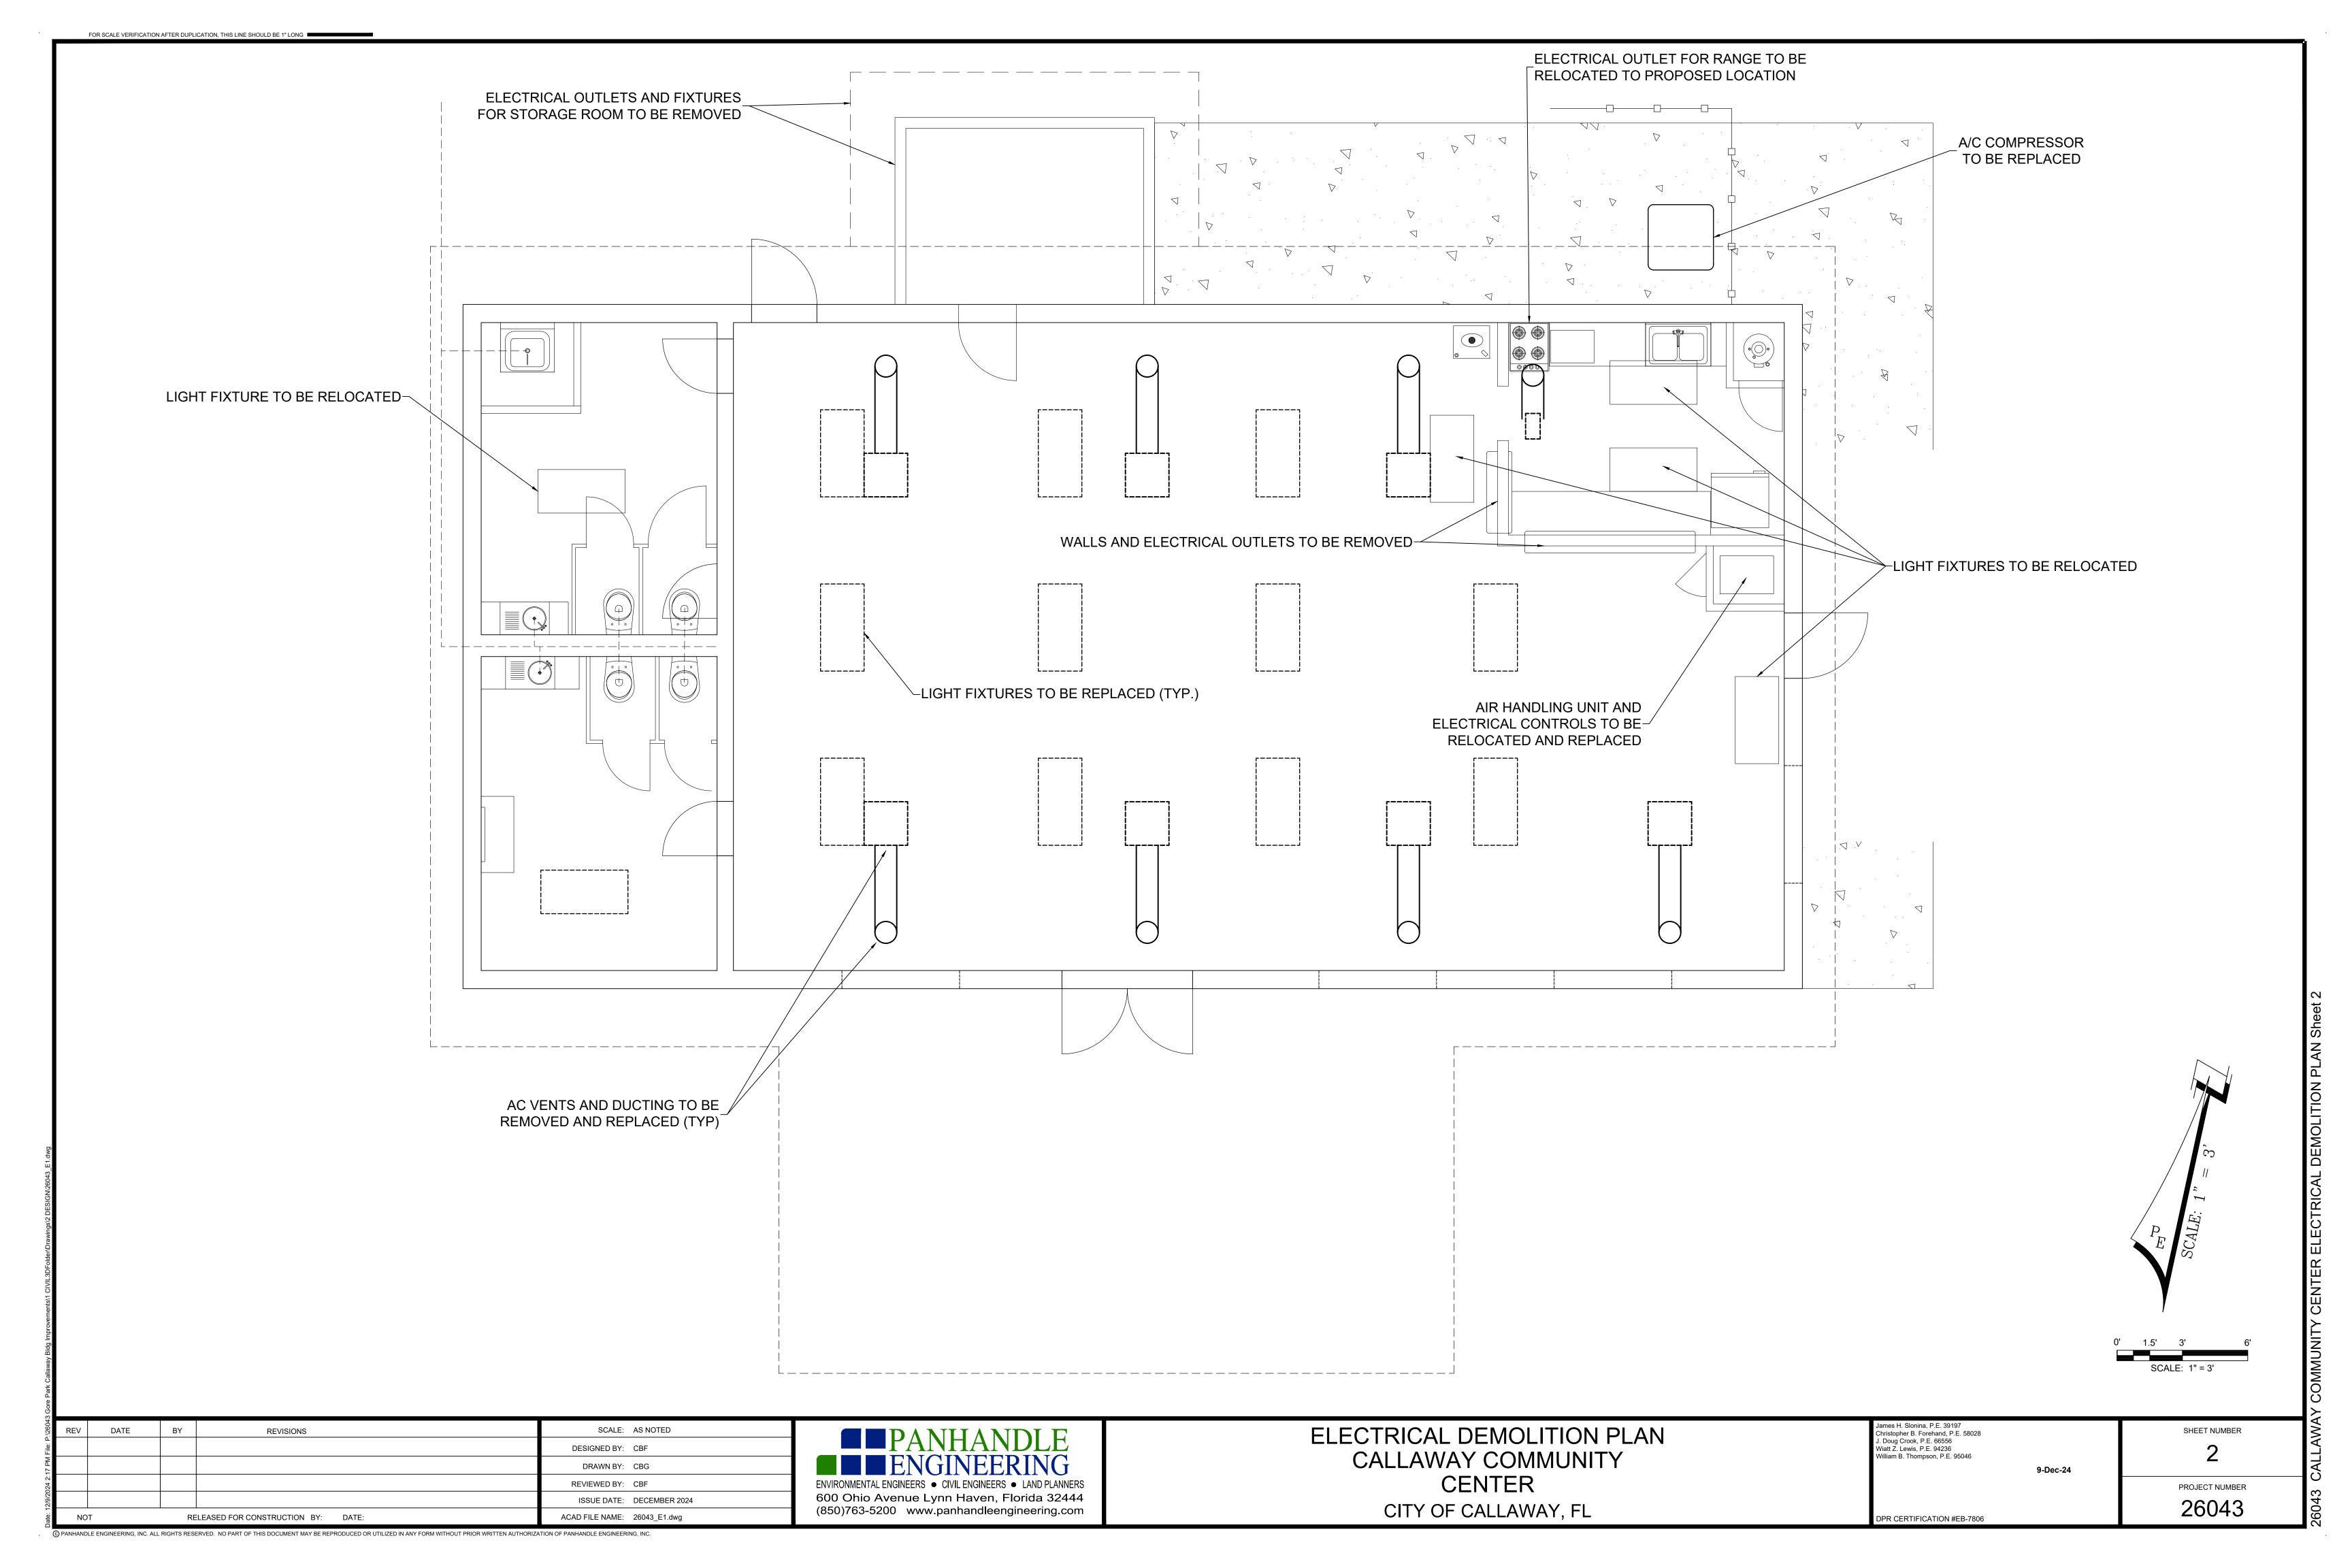


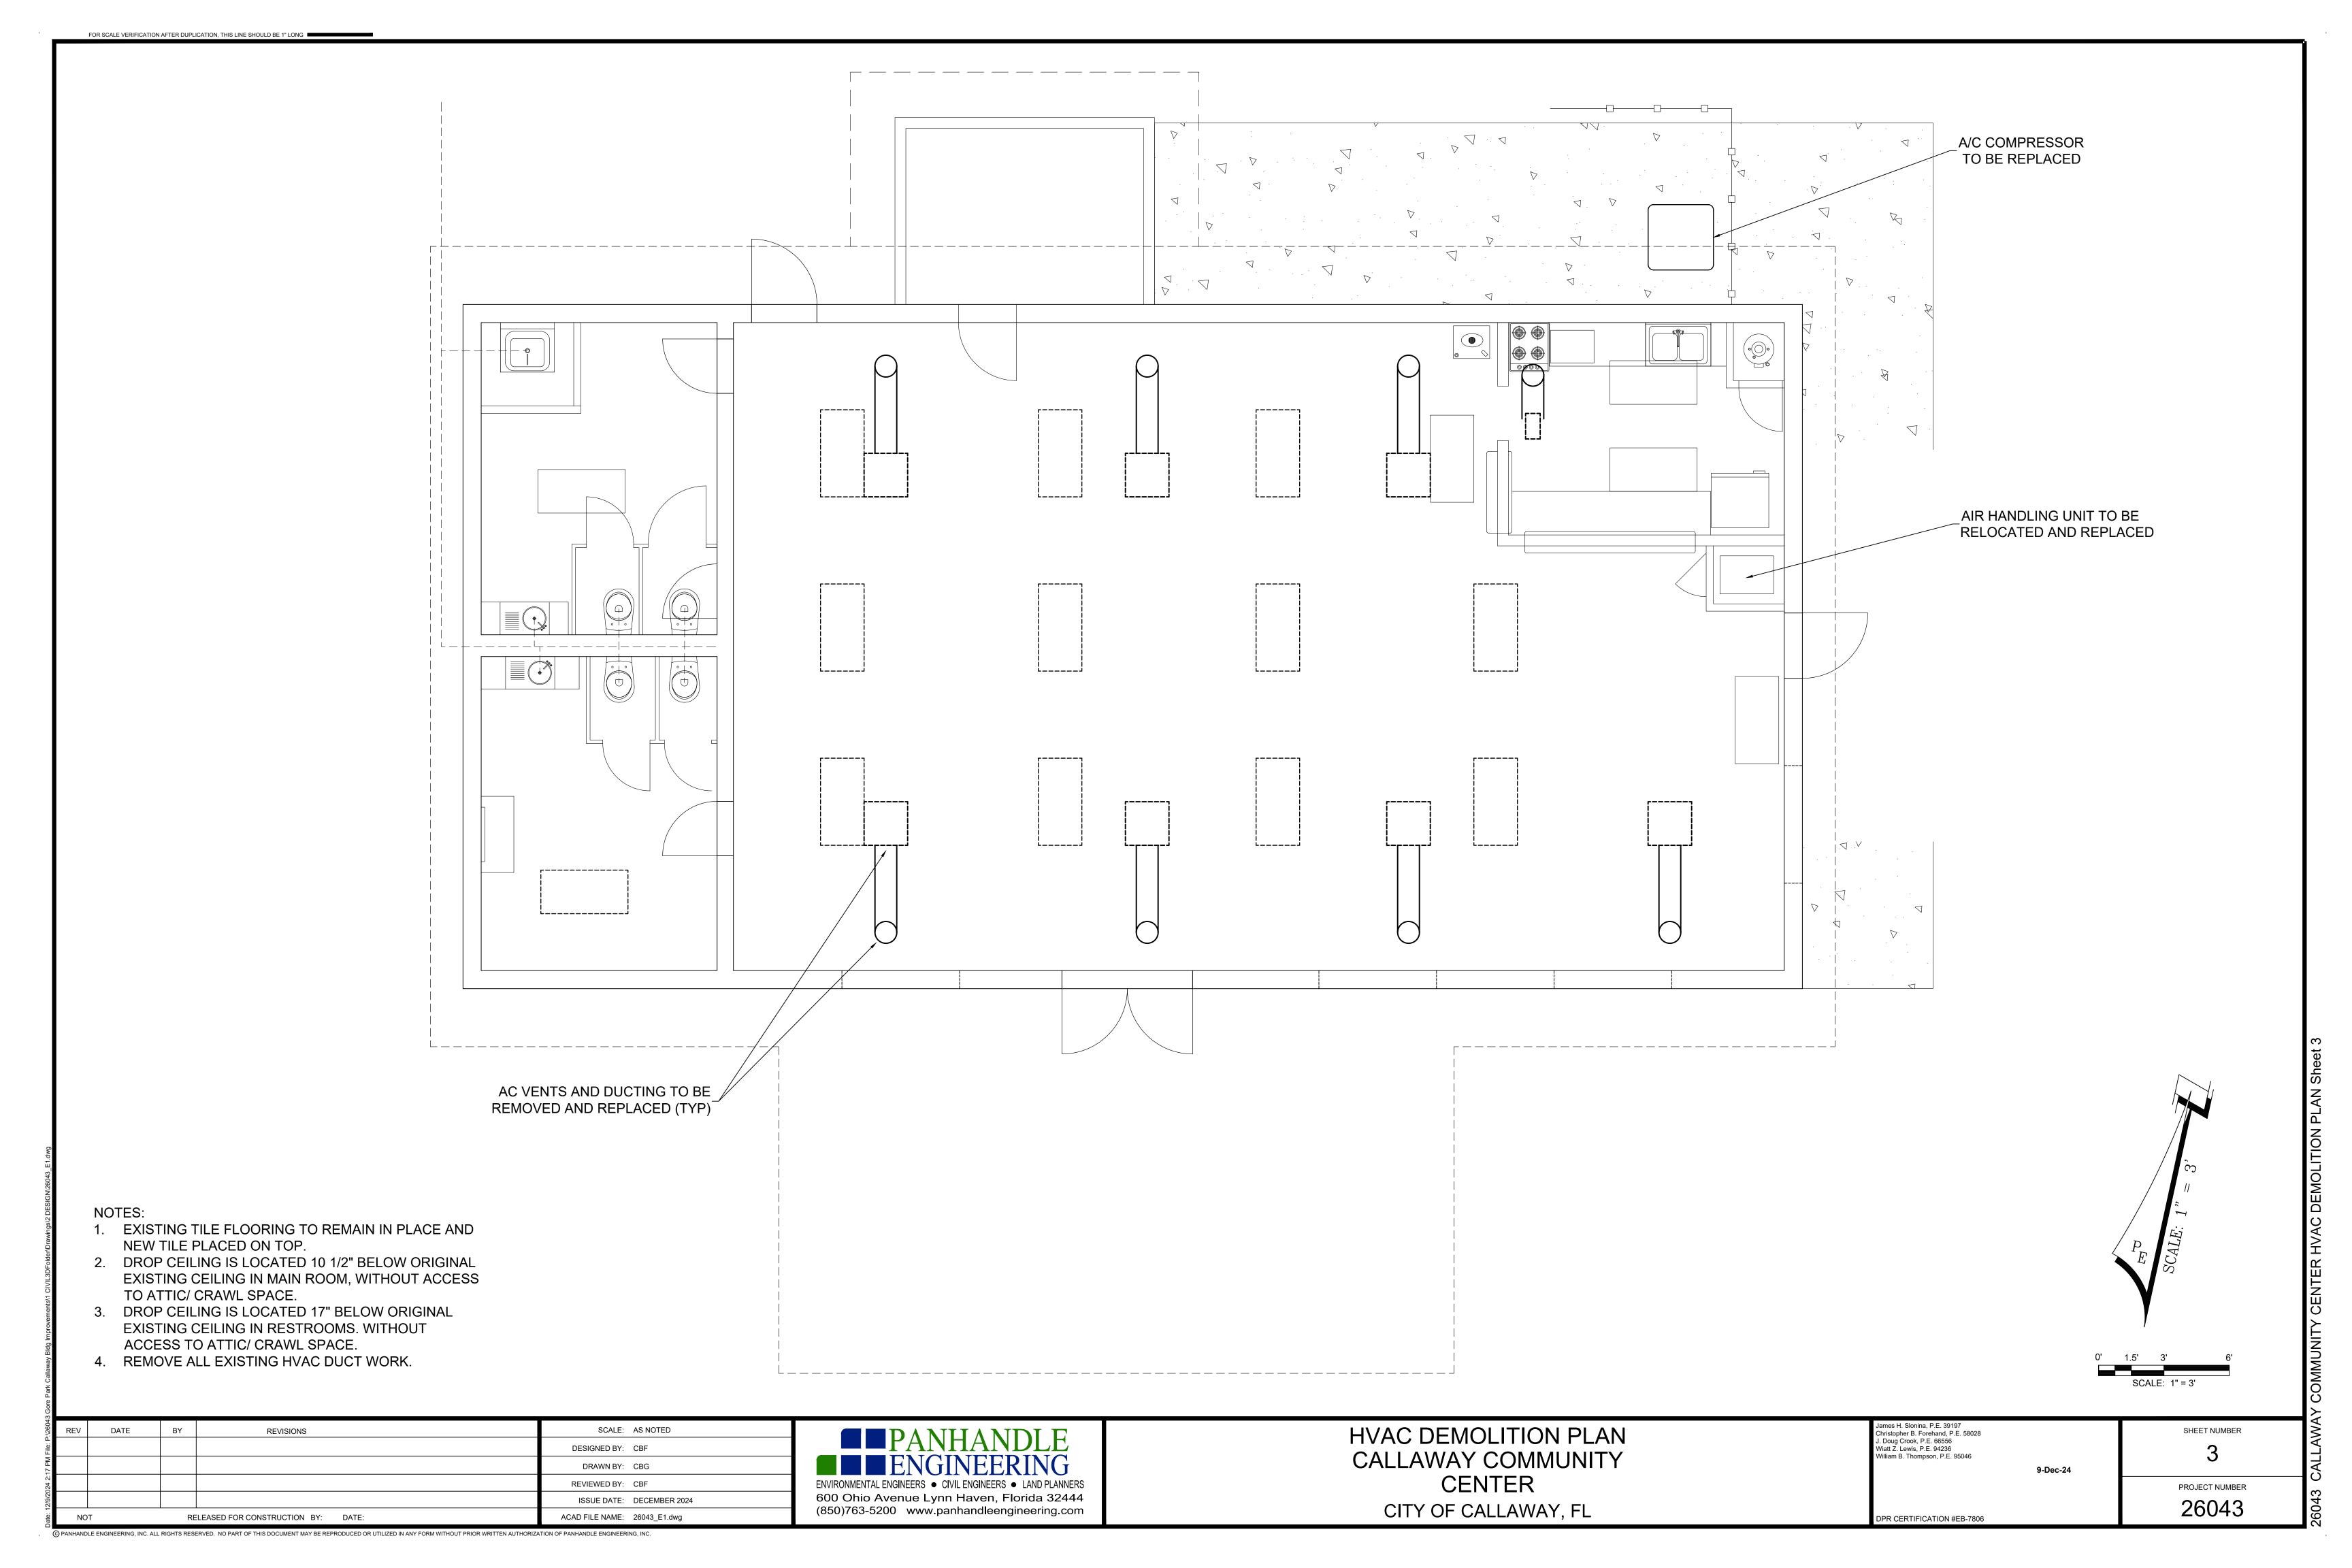

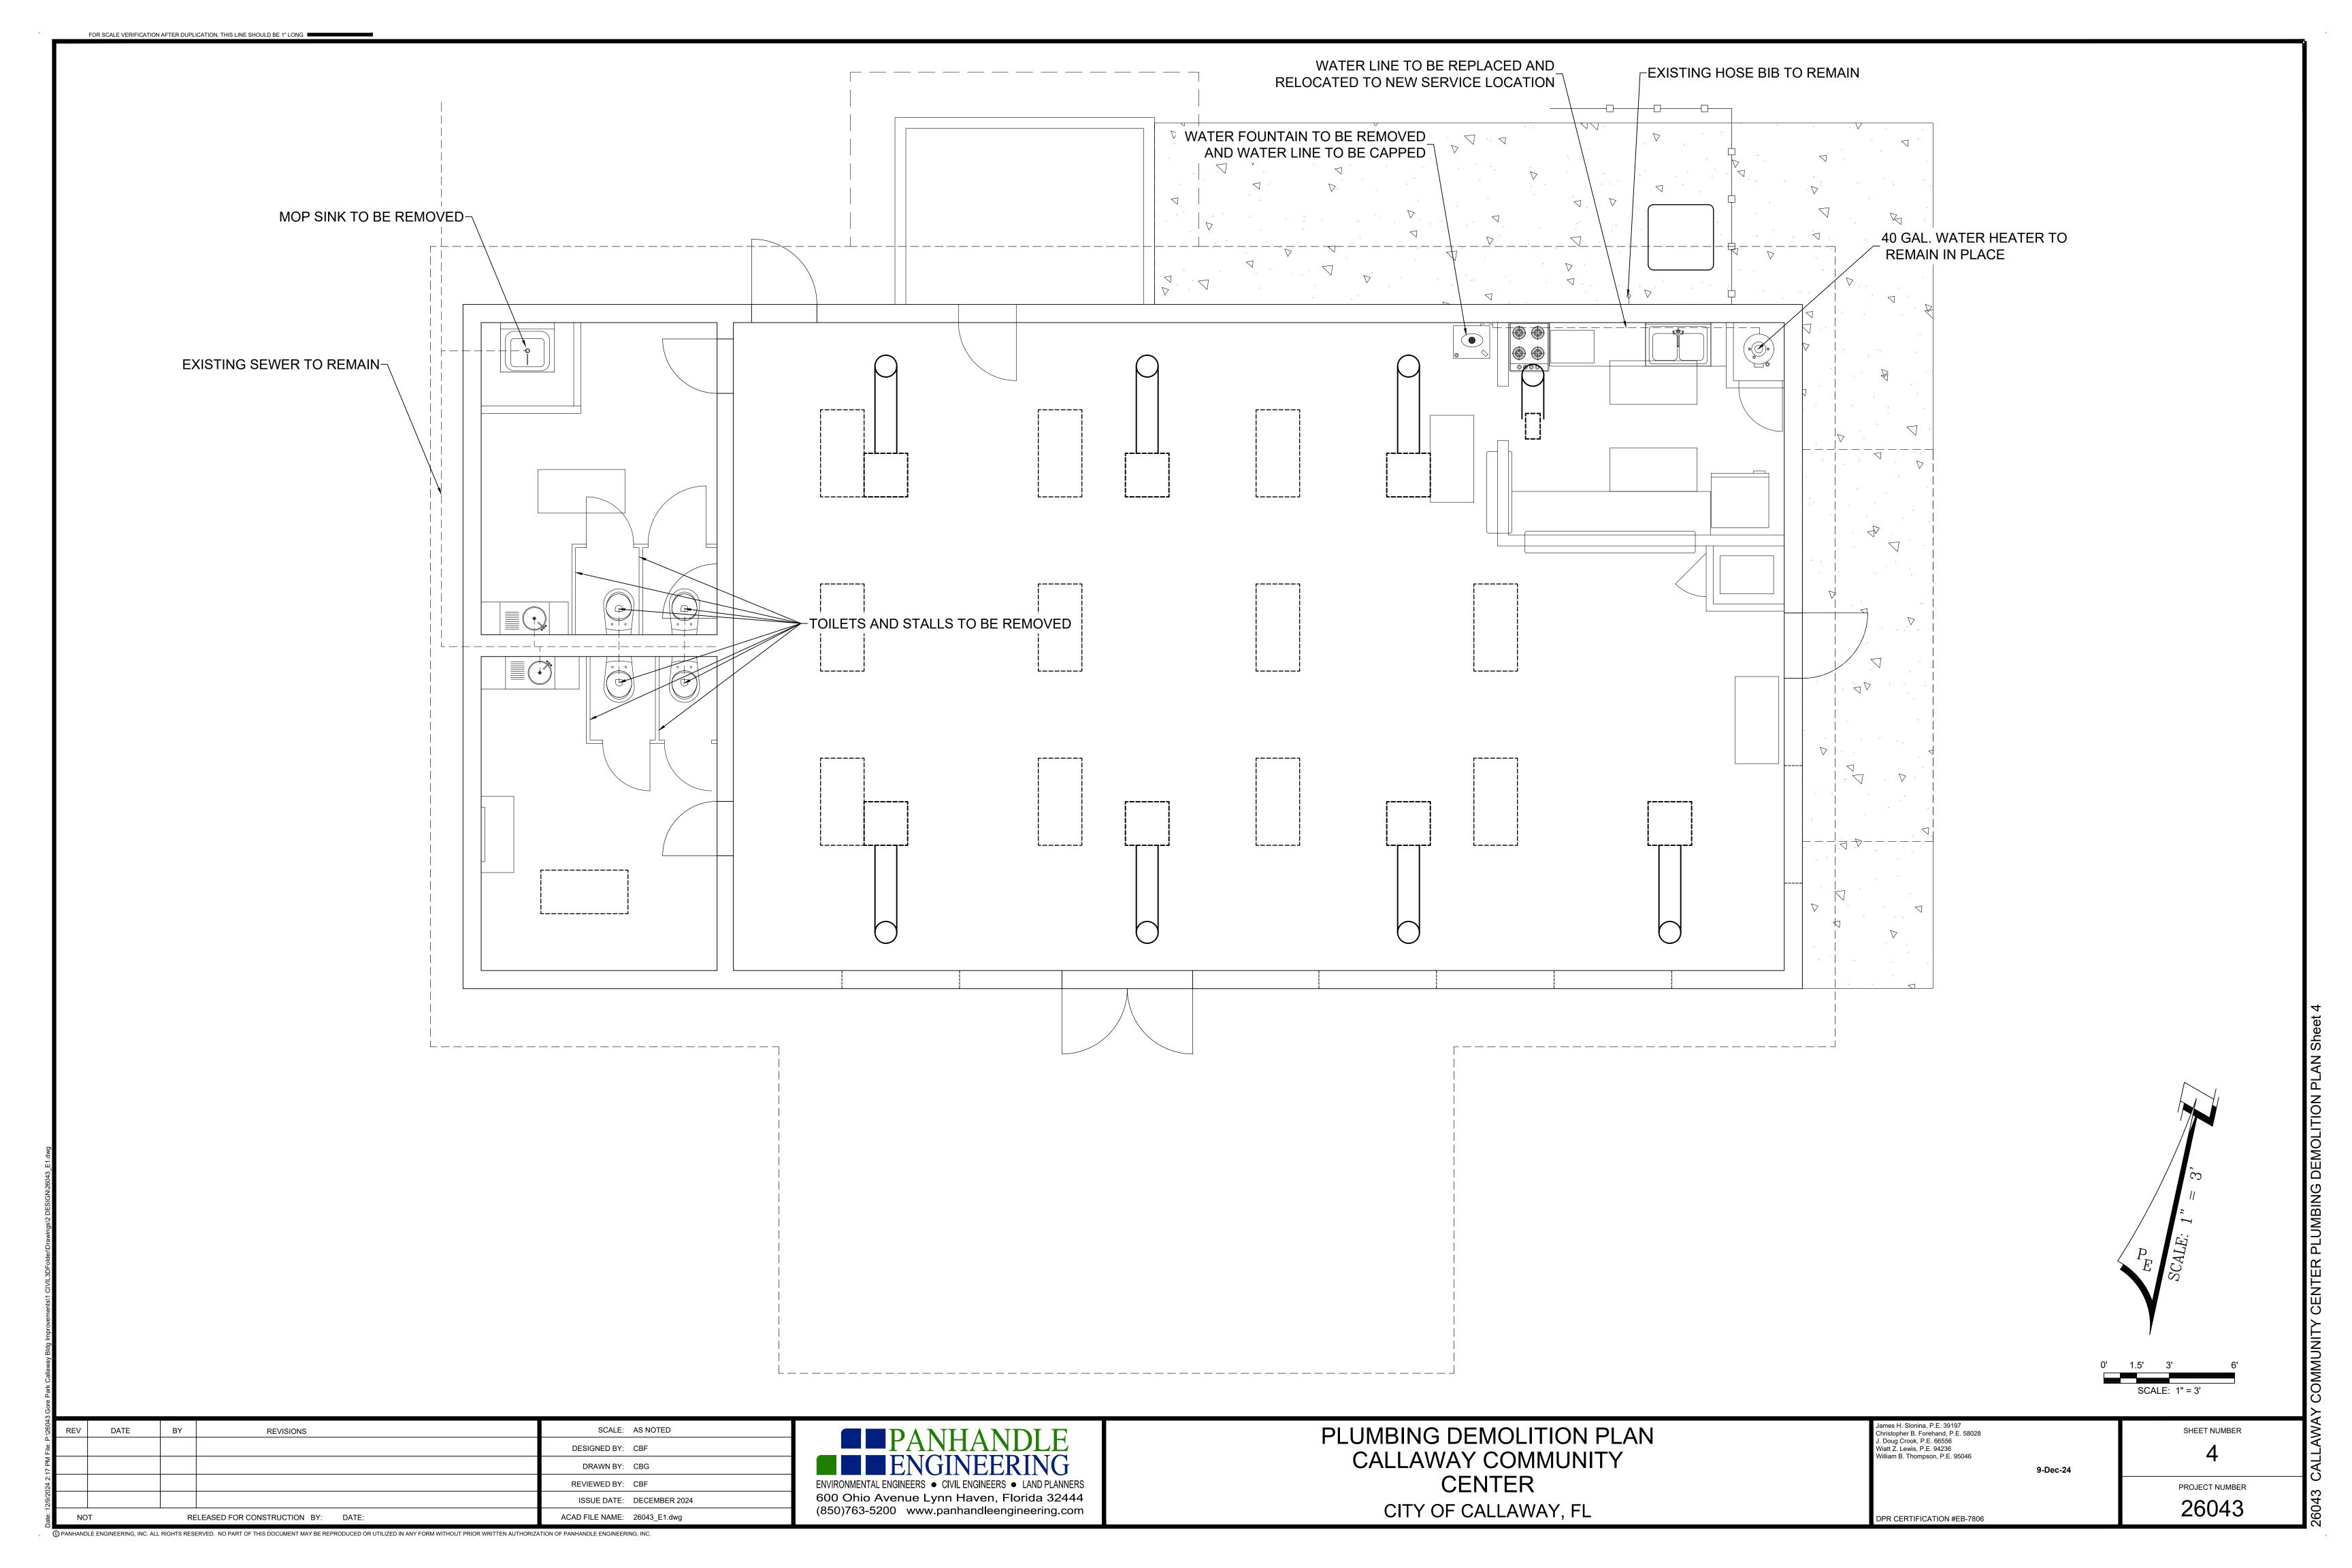

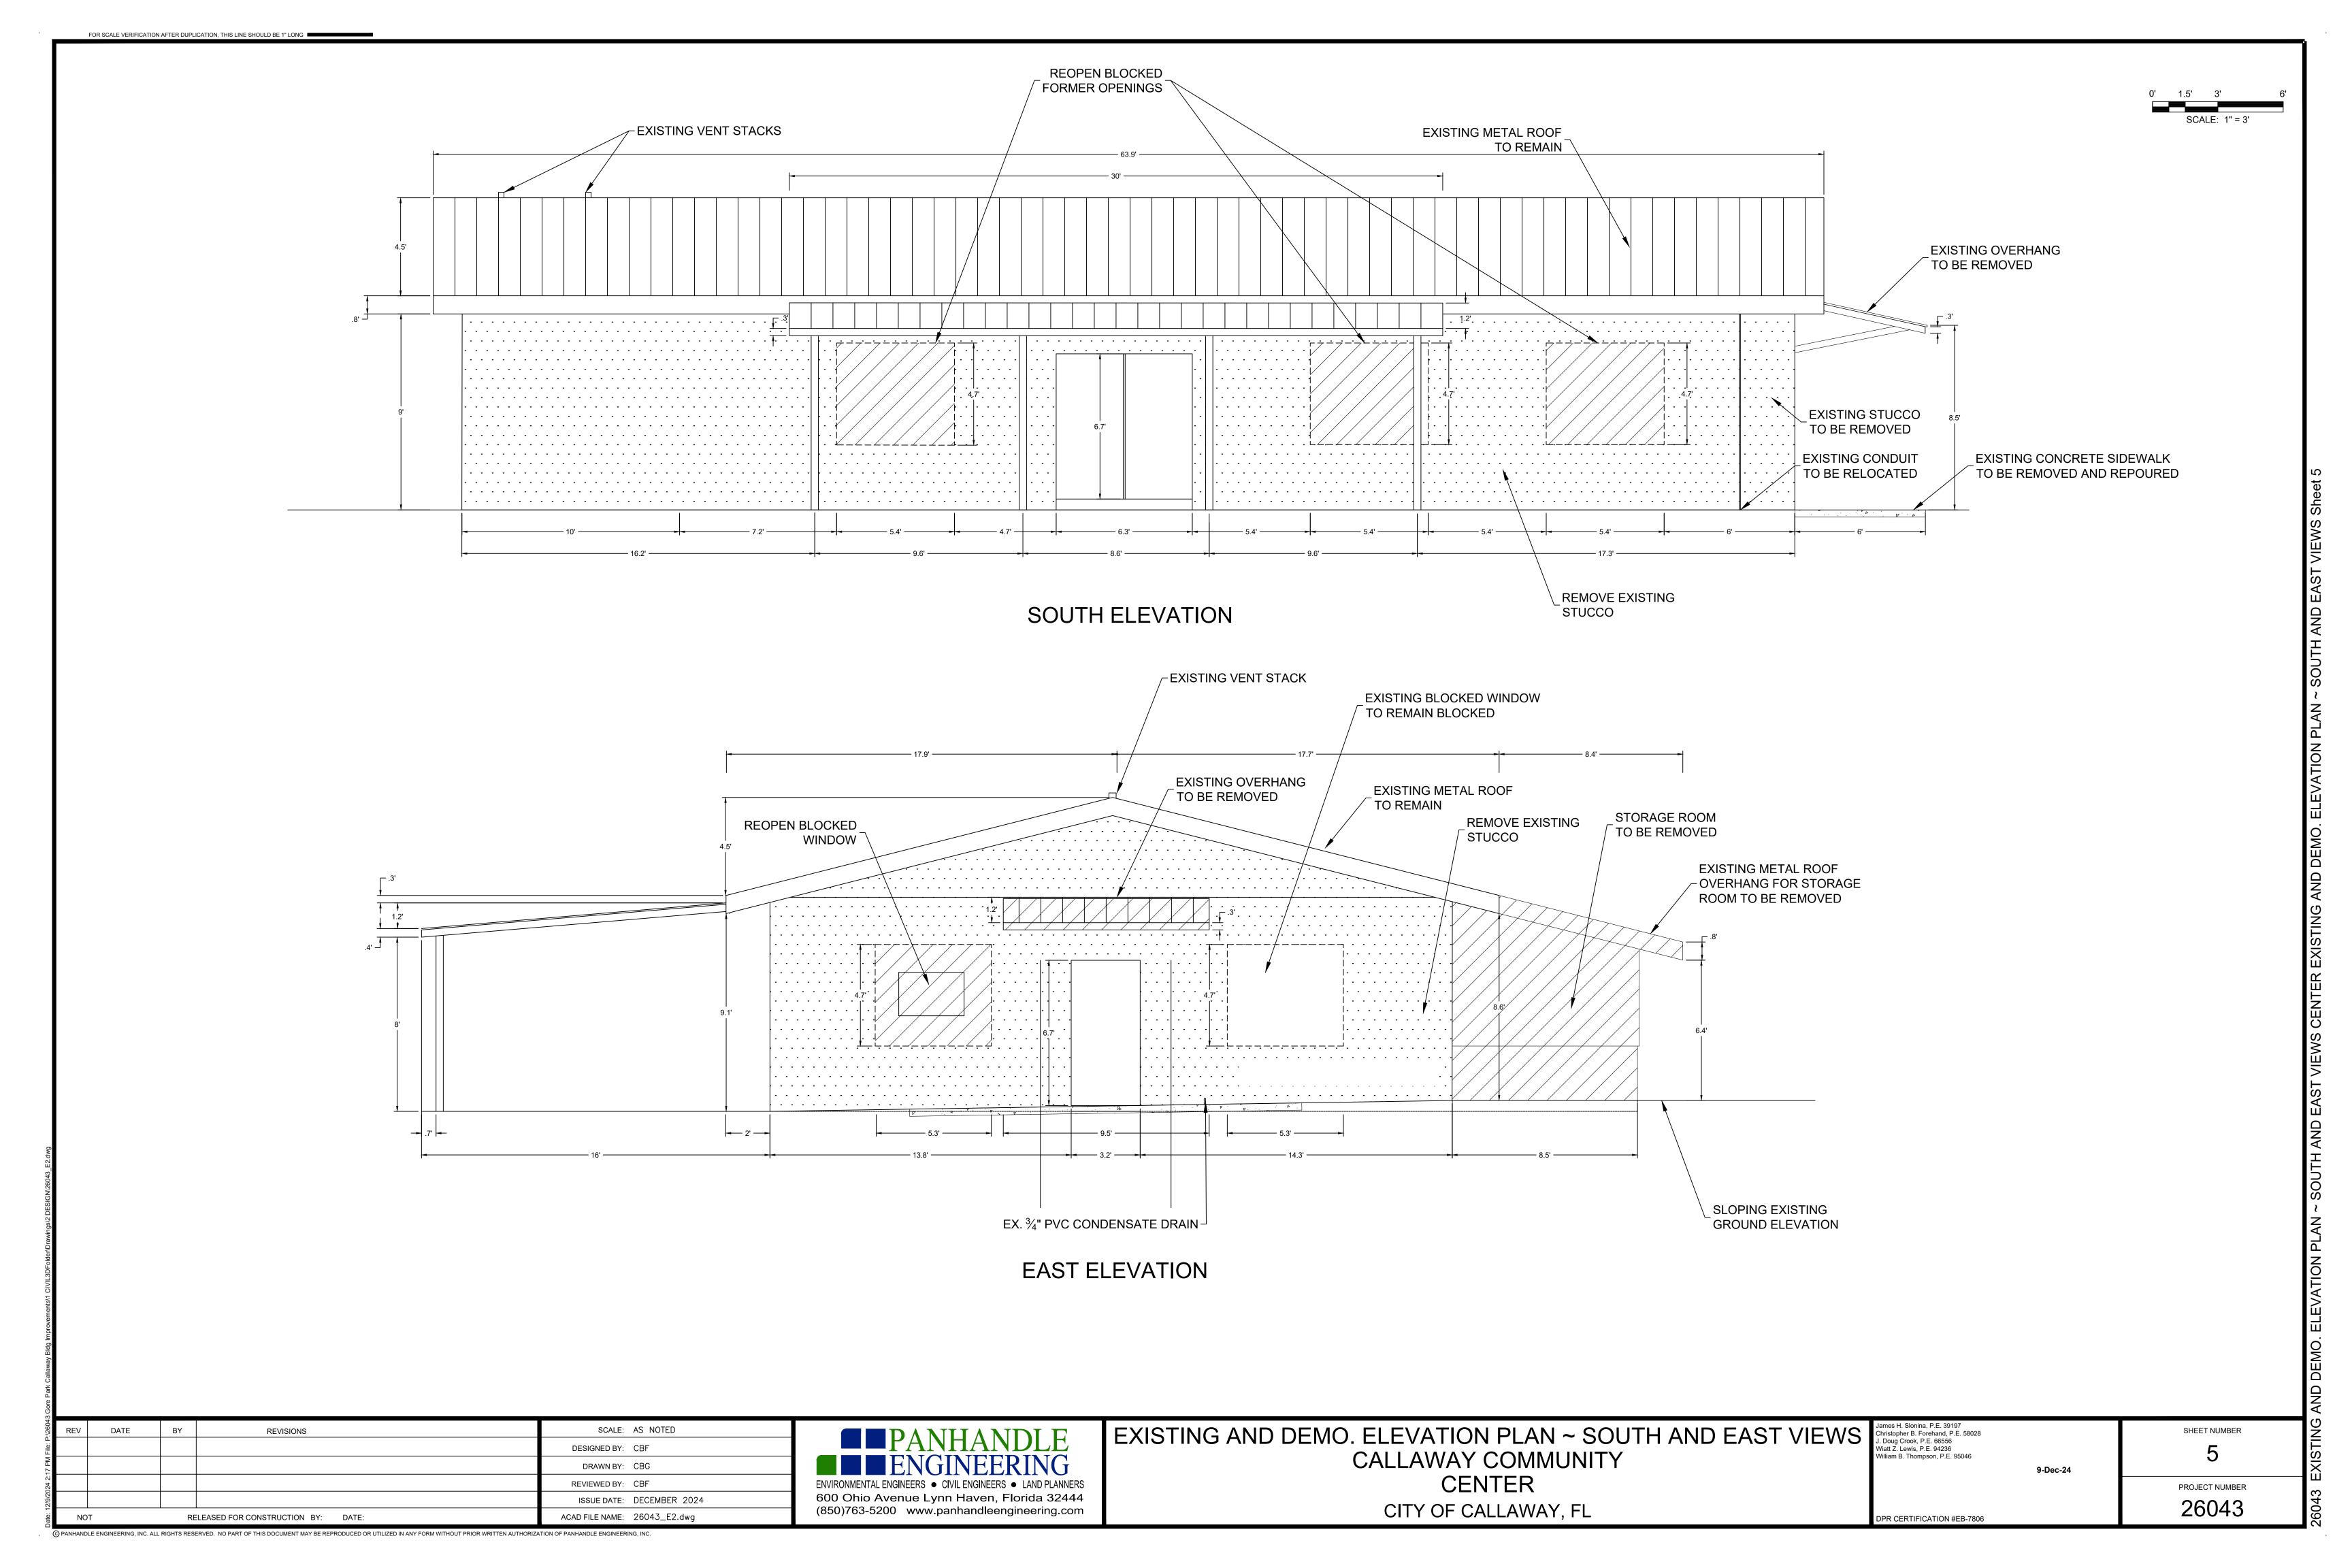

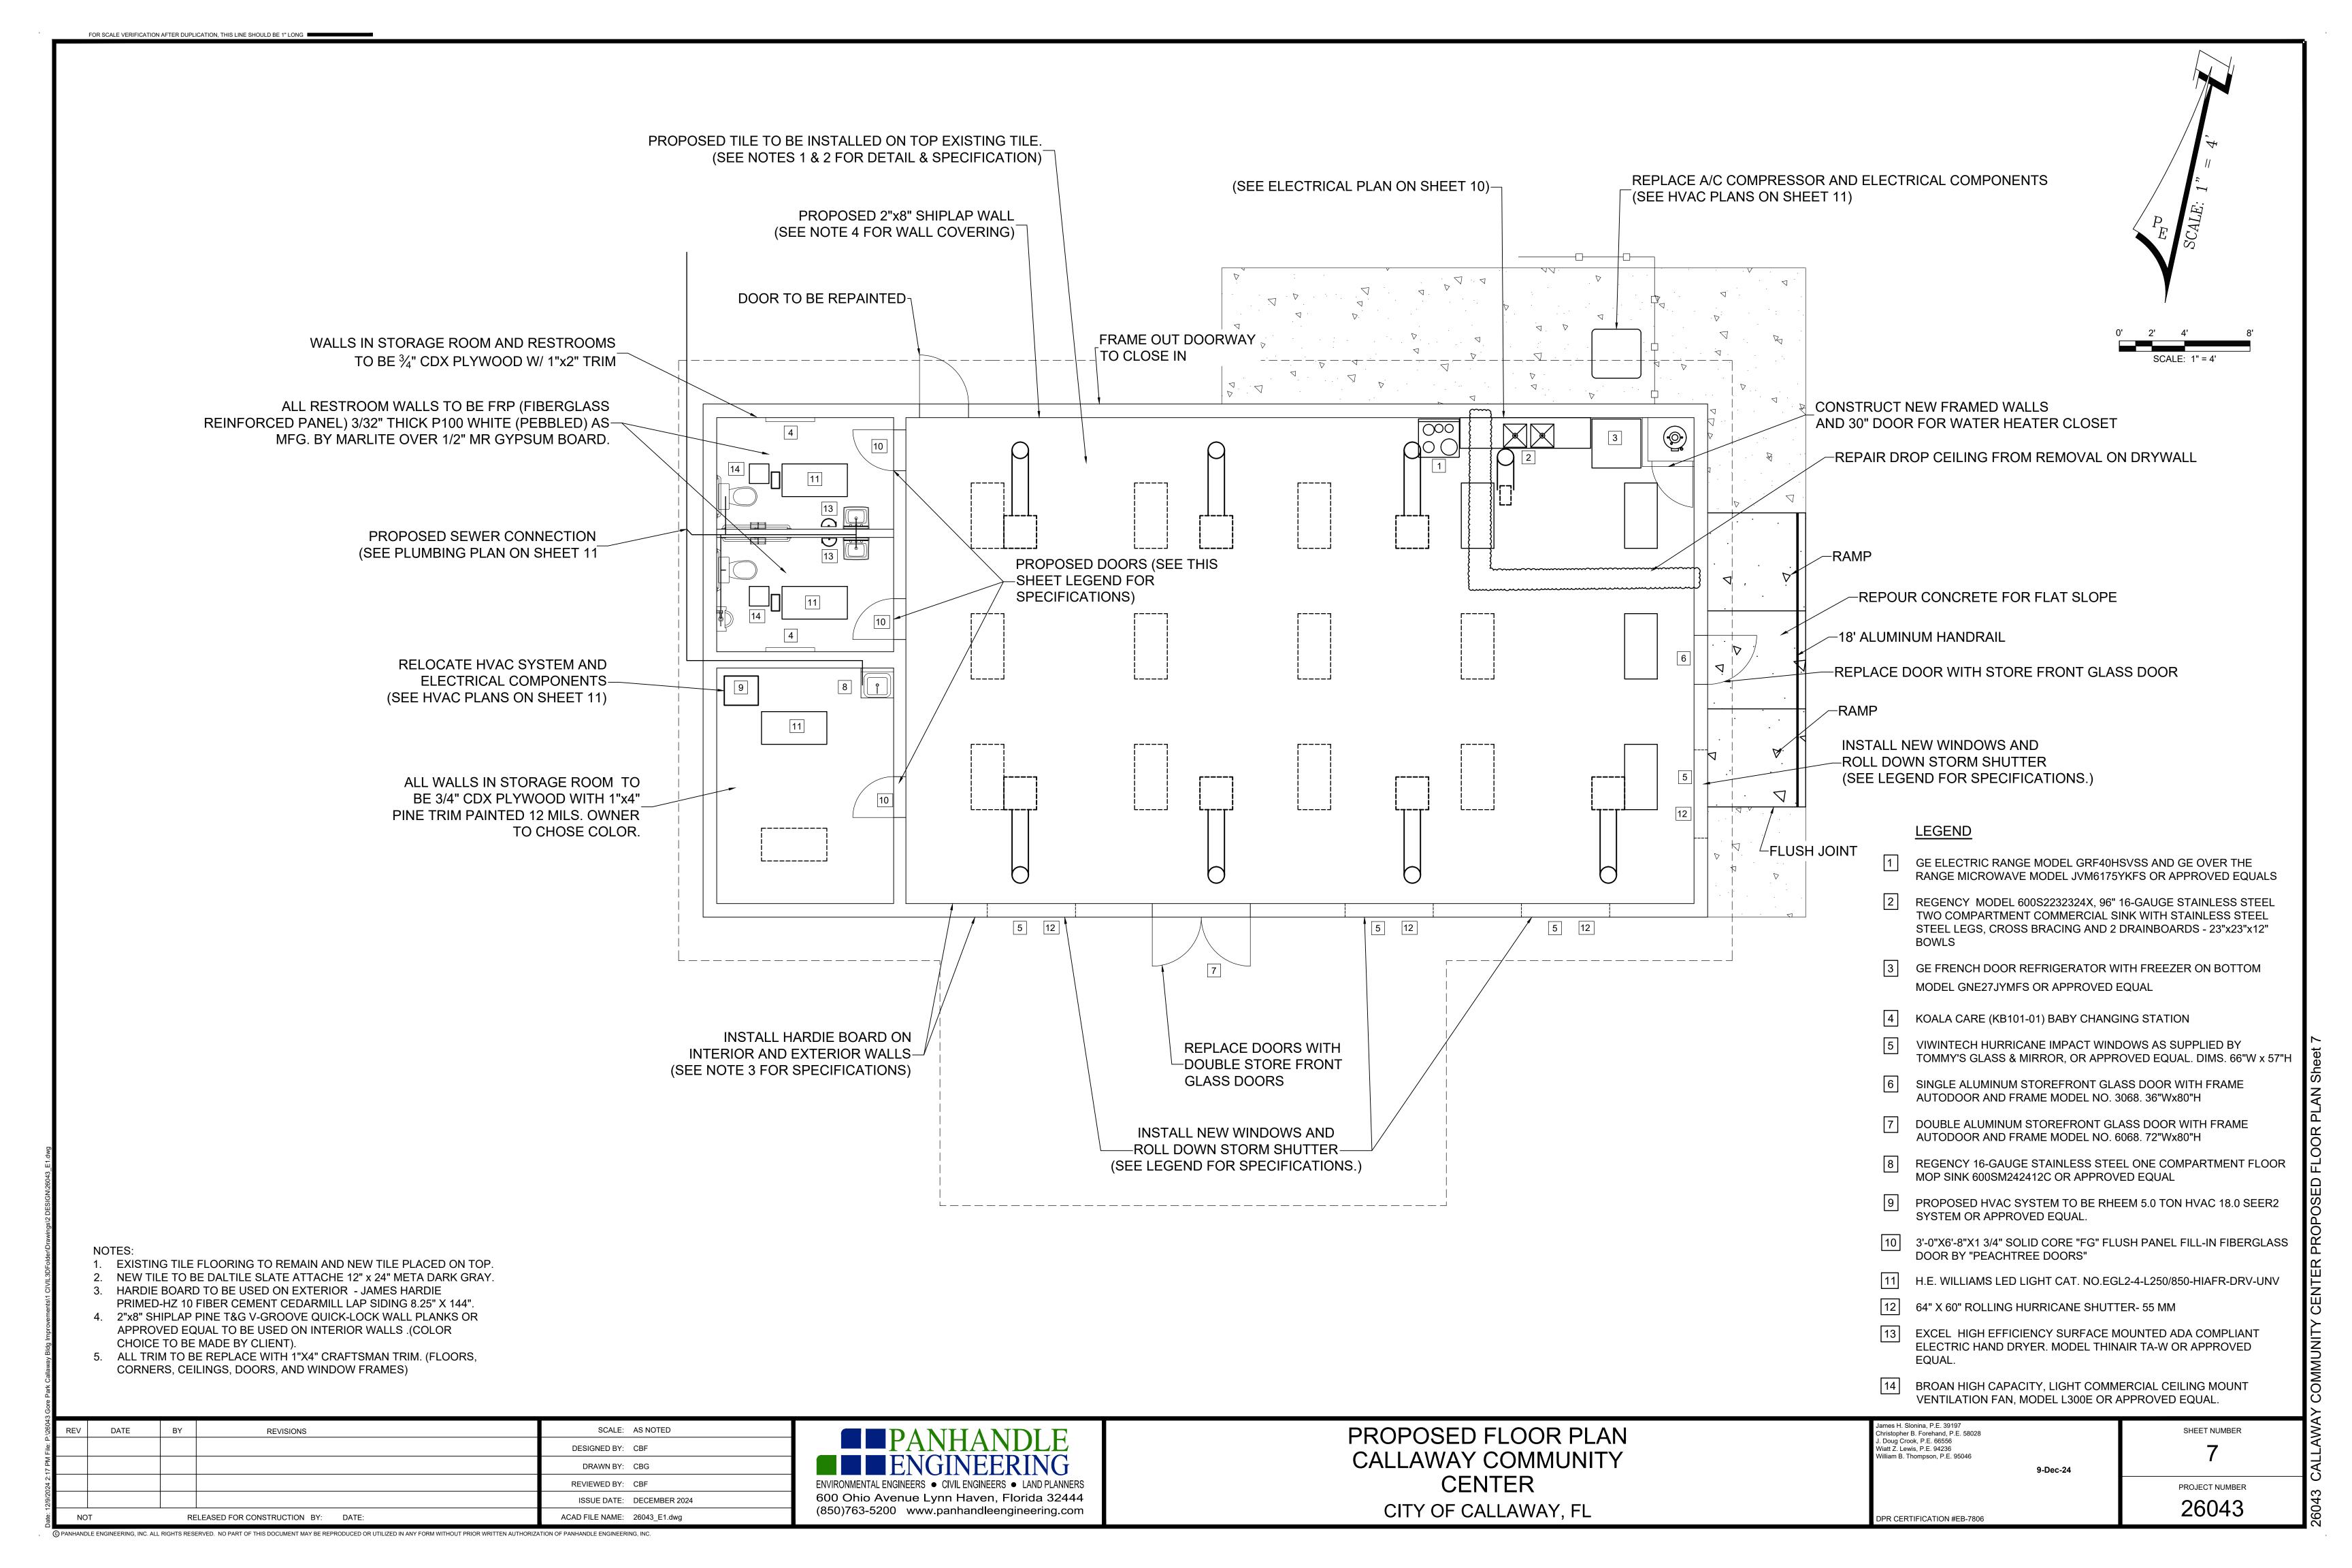

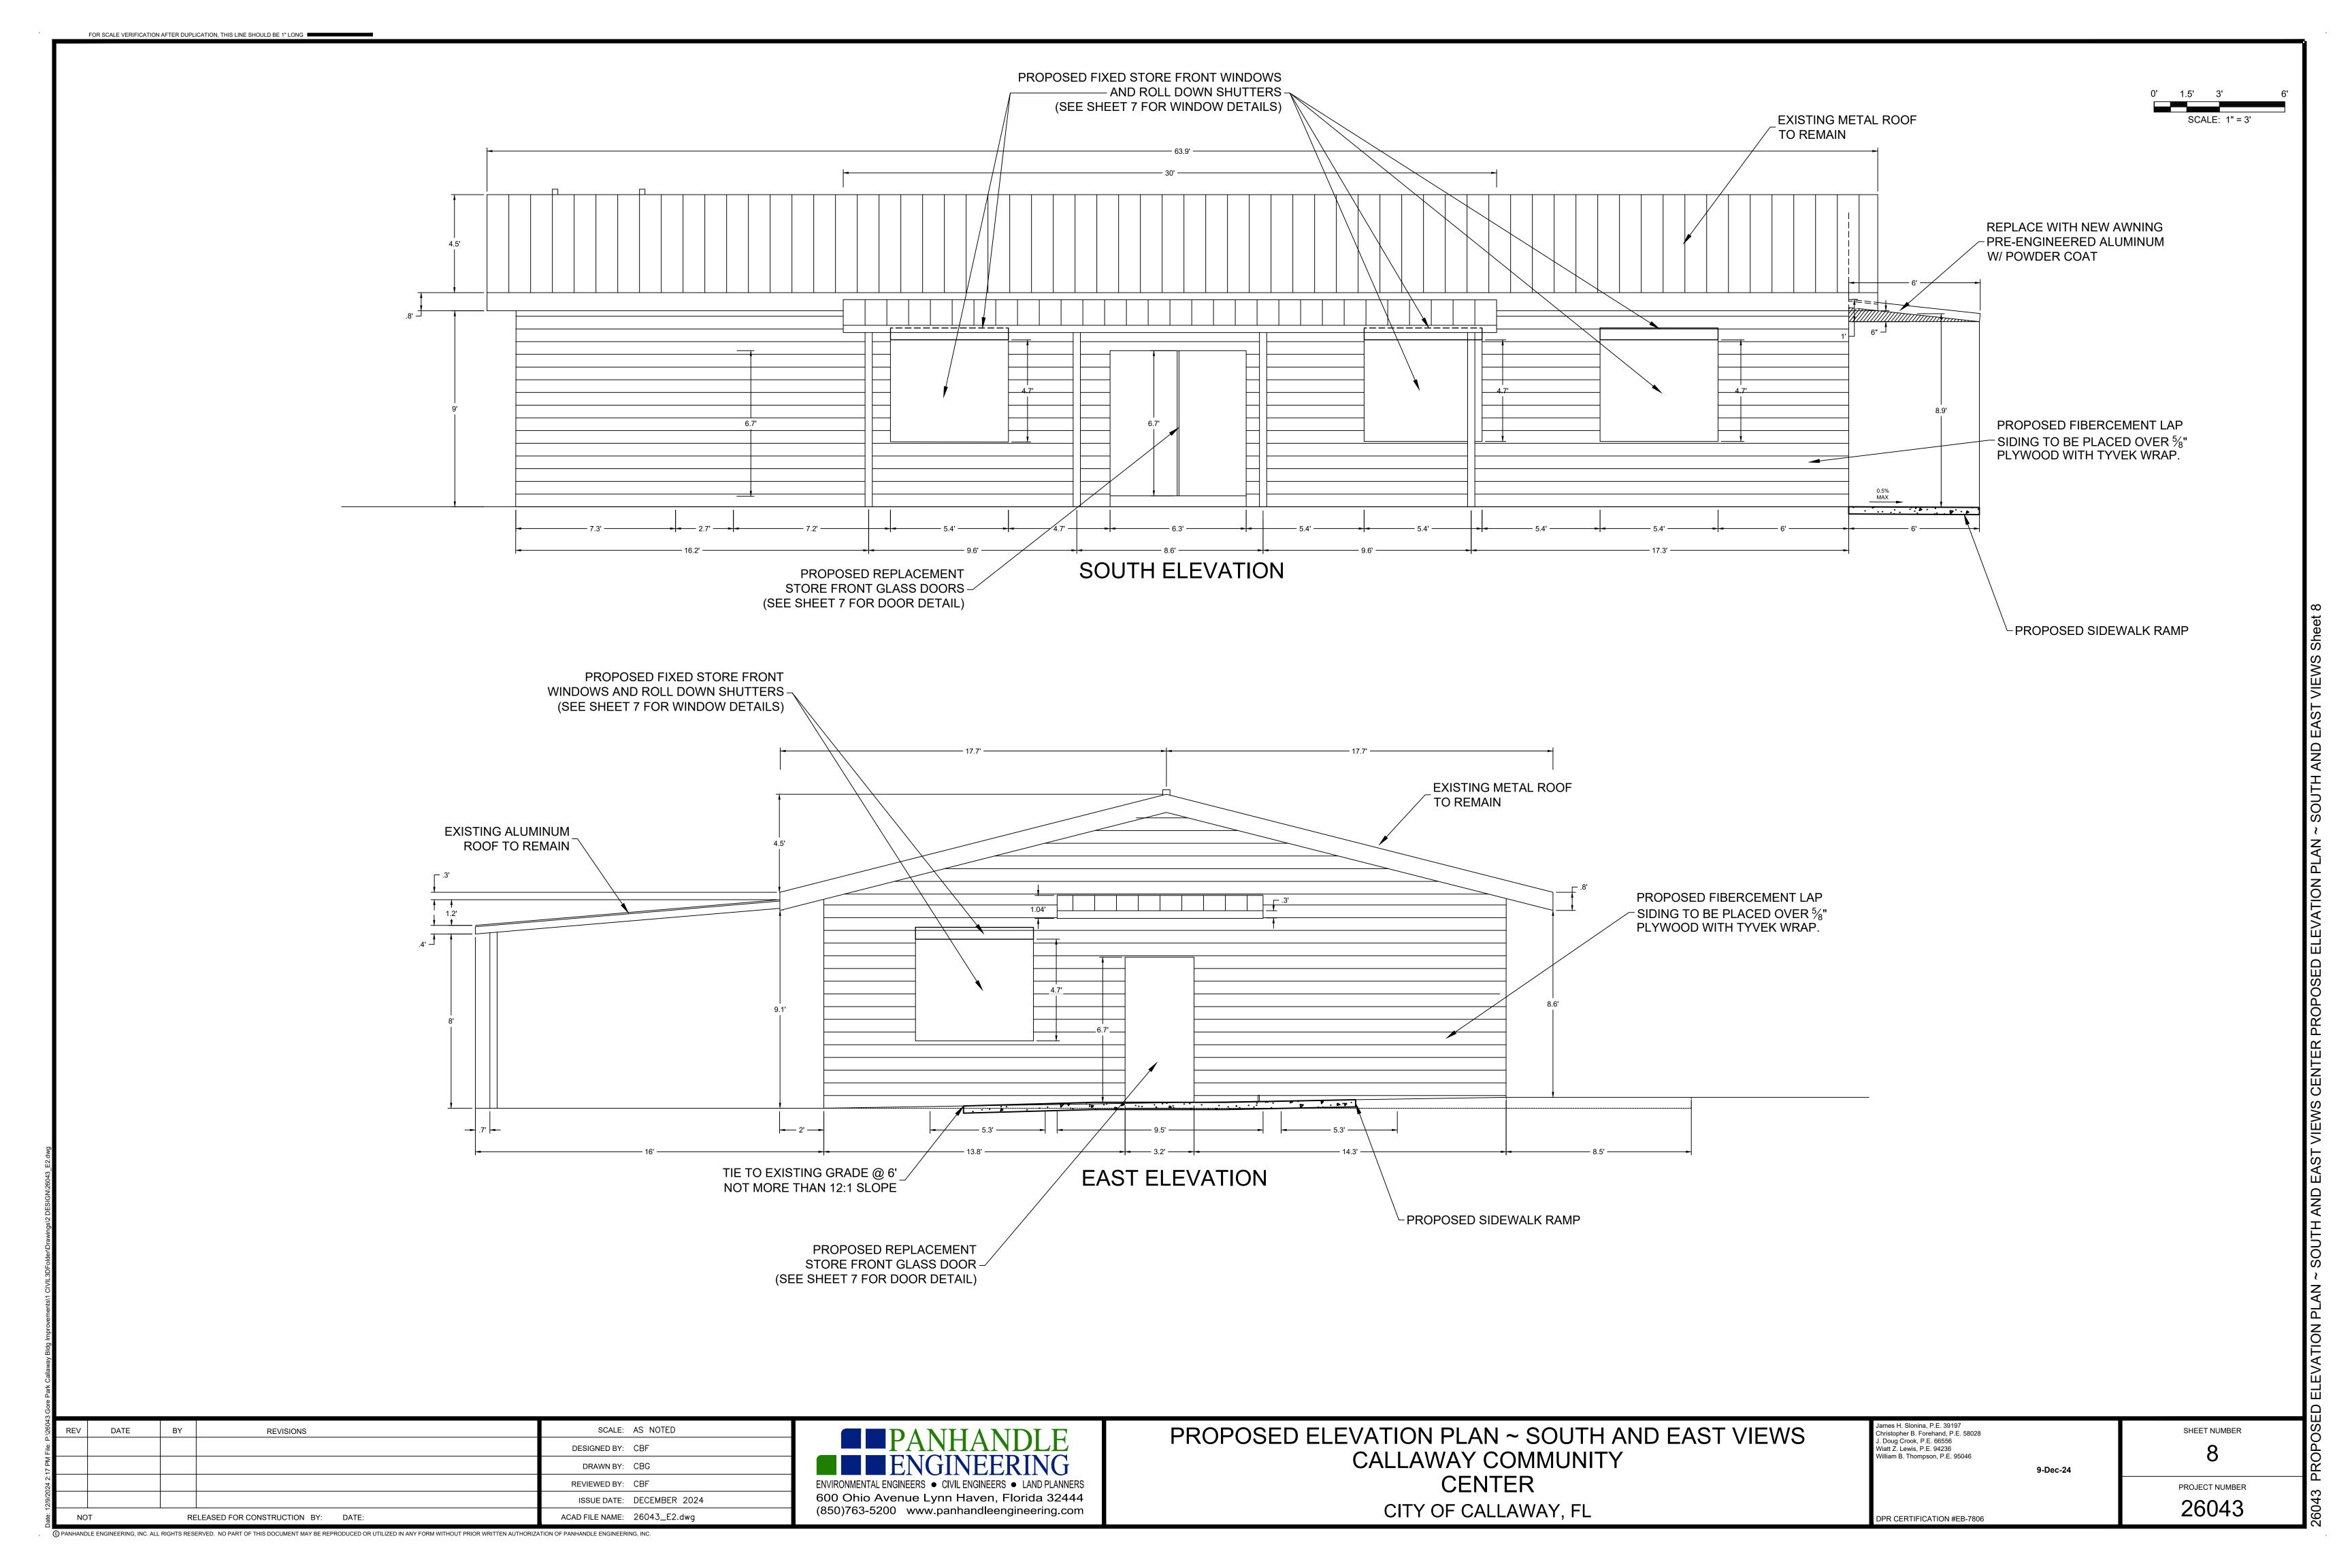

CITY OF CALLAWAY, FL

600 Ohio Avenue Lynn Haven, Florida 32444

(850)763-5200 www.panhandleengineering.com

ISSUE DATE: DECEMBER 2024

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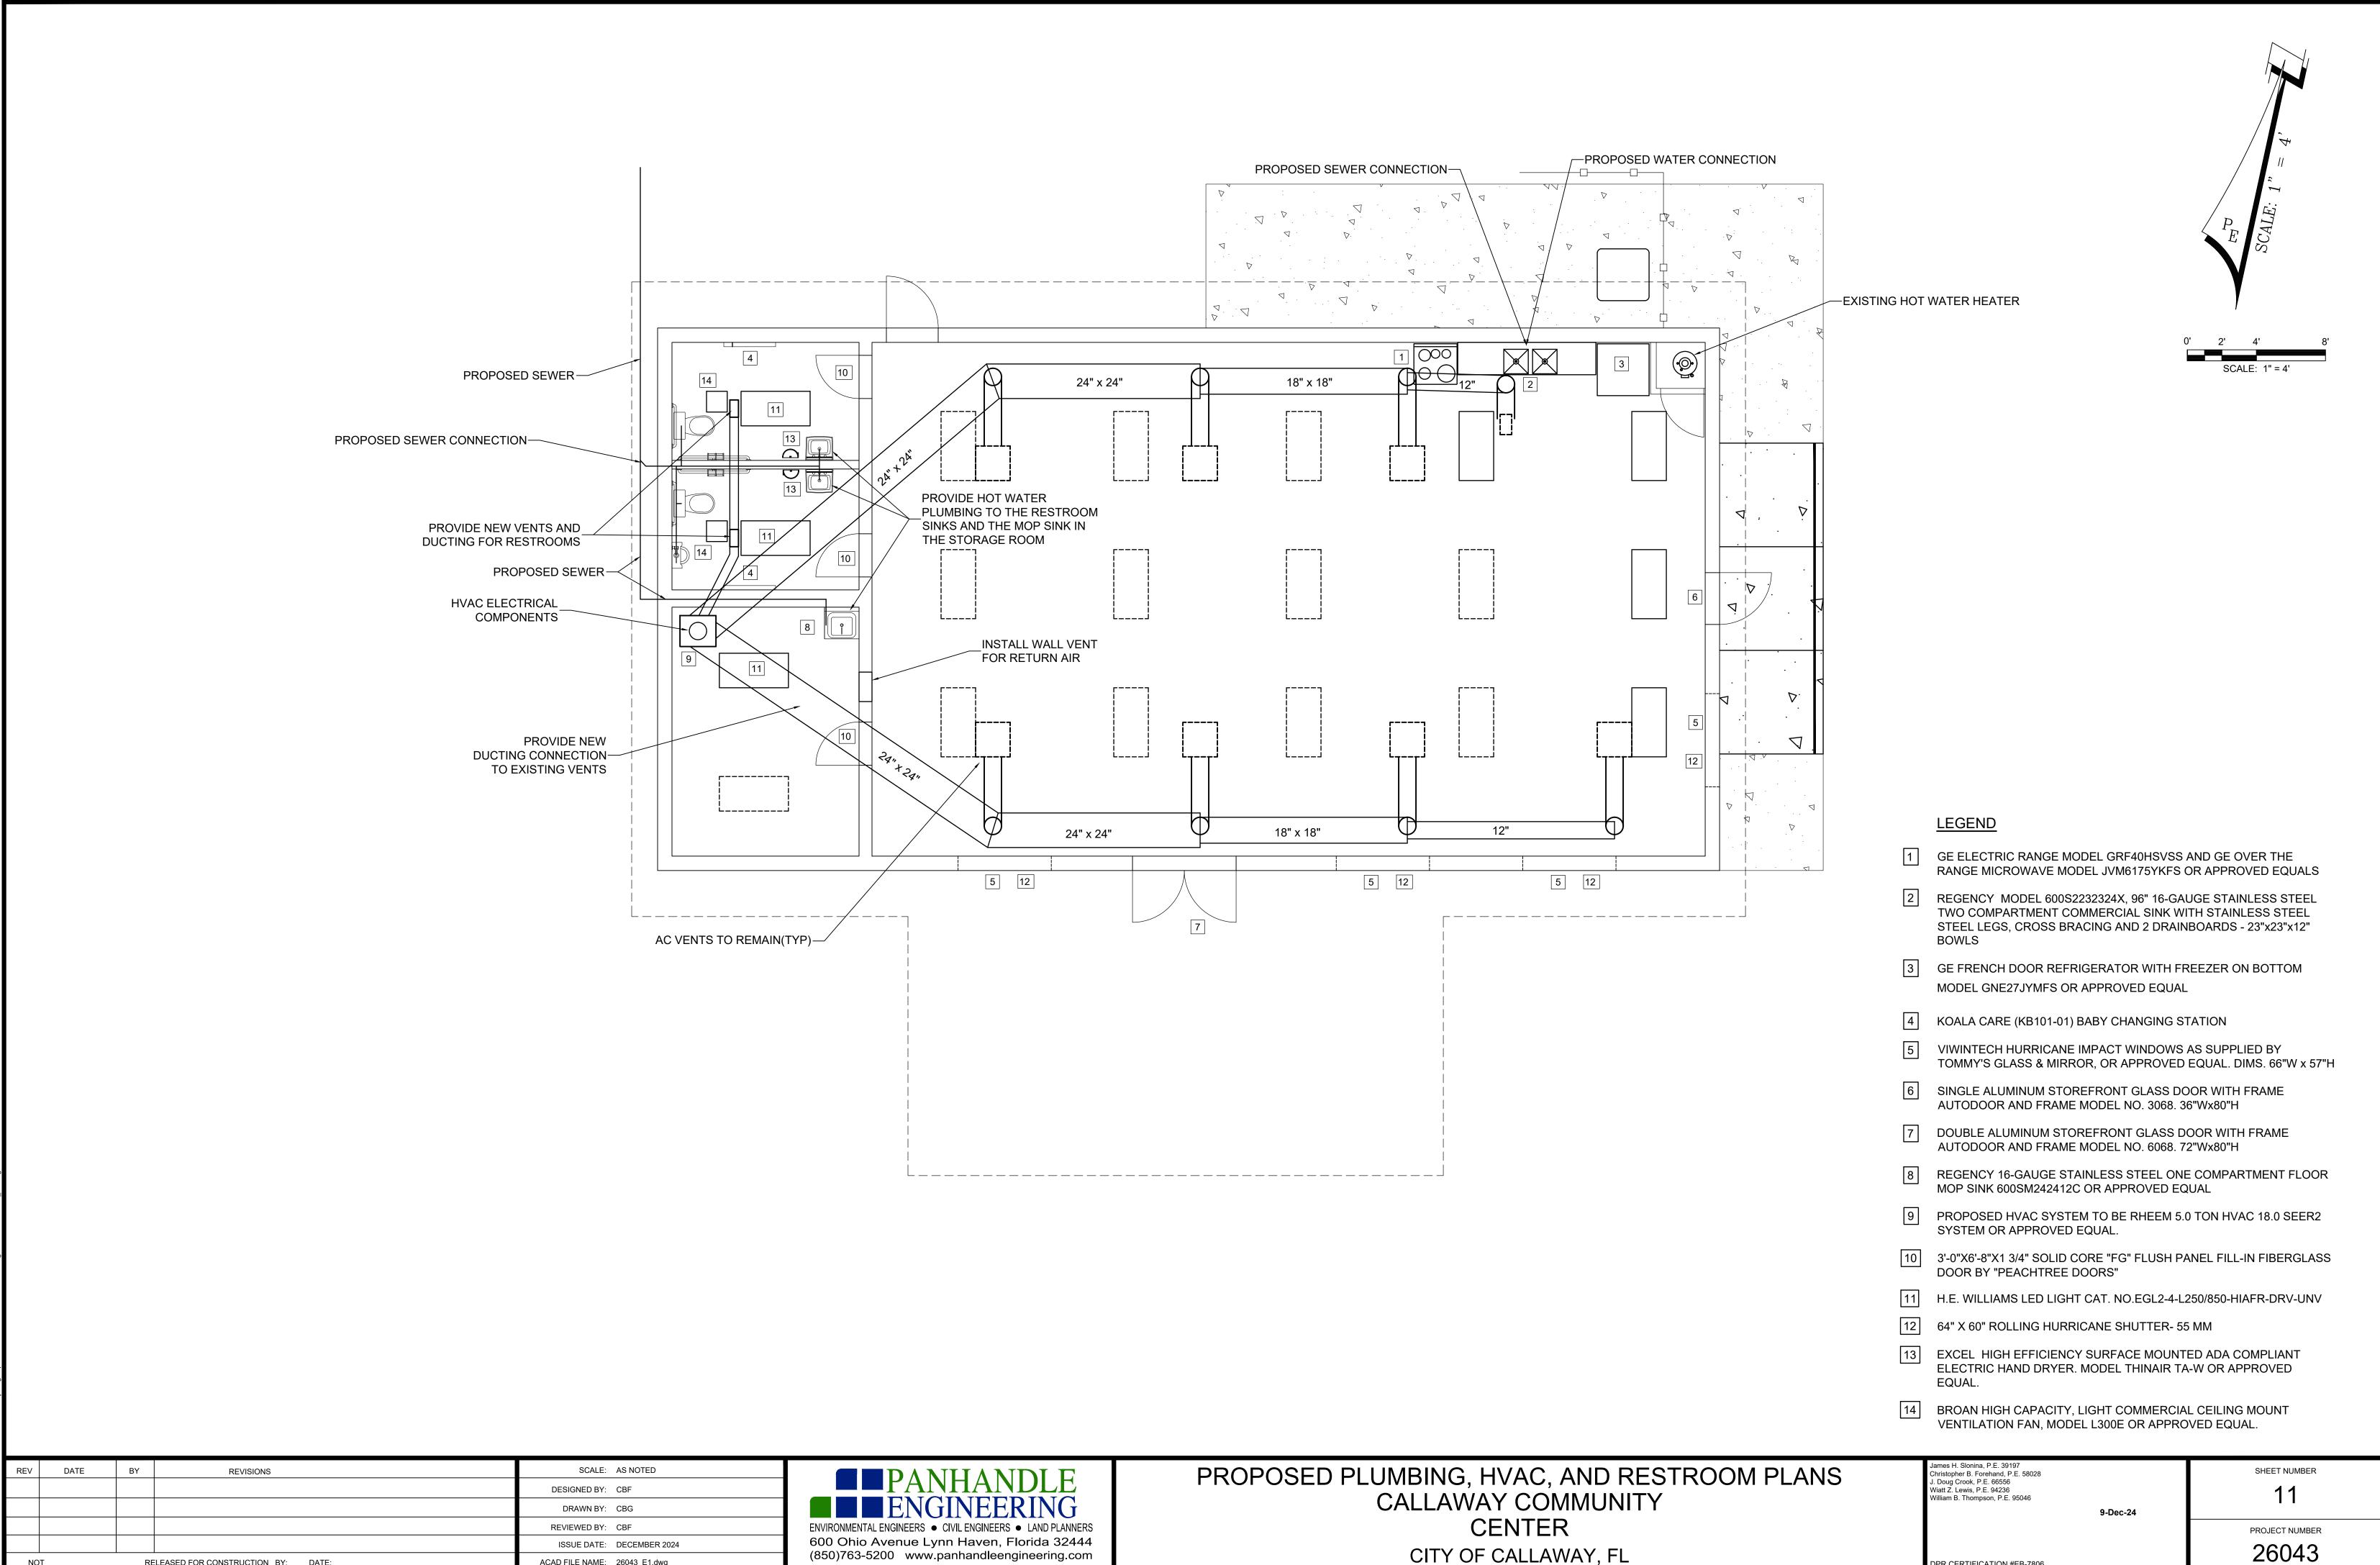
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PROJECT NUMBER

26043

OPR CERTIFICATION #EB-7806




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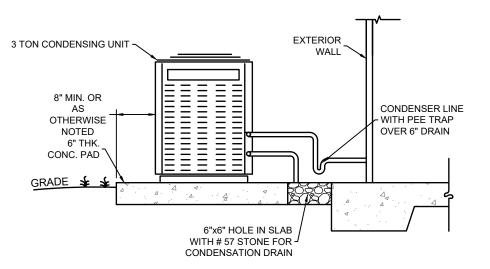
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INSULATE SUCTION LINE.

- 2. PITCH ALL HORIZONTAL SUCTION PIPING A MINIMUM OF 1/2" IN 10' IN DIRECTION OF FLOW.
- 3. EQUIPMENT MANUFACTURER SHALL DETERMINE THE REFRIGERANT PIPE SIZES. PROVIDE SOLENOID VALVE, ACCUMULATOR AND OTHER REFRIGERANT SPECIALTIES AS RECOMMENDED BY THE MANUFACTURER.
- 4. WHERE REFRIGERANT PIPING IS NOT SHOWN, ROUTE AS DIRECTLY AS POSSIBLE FROM OUTDOOR UNIT ABOVE GRADE THRU WALL TO AHU.


REFRIGERANT PIPING SCHEMATIC SPLIT SYSTEM HEAT PUMP





CONDENSING UNIT DETAIL

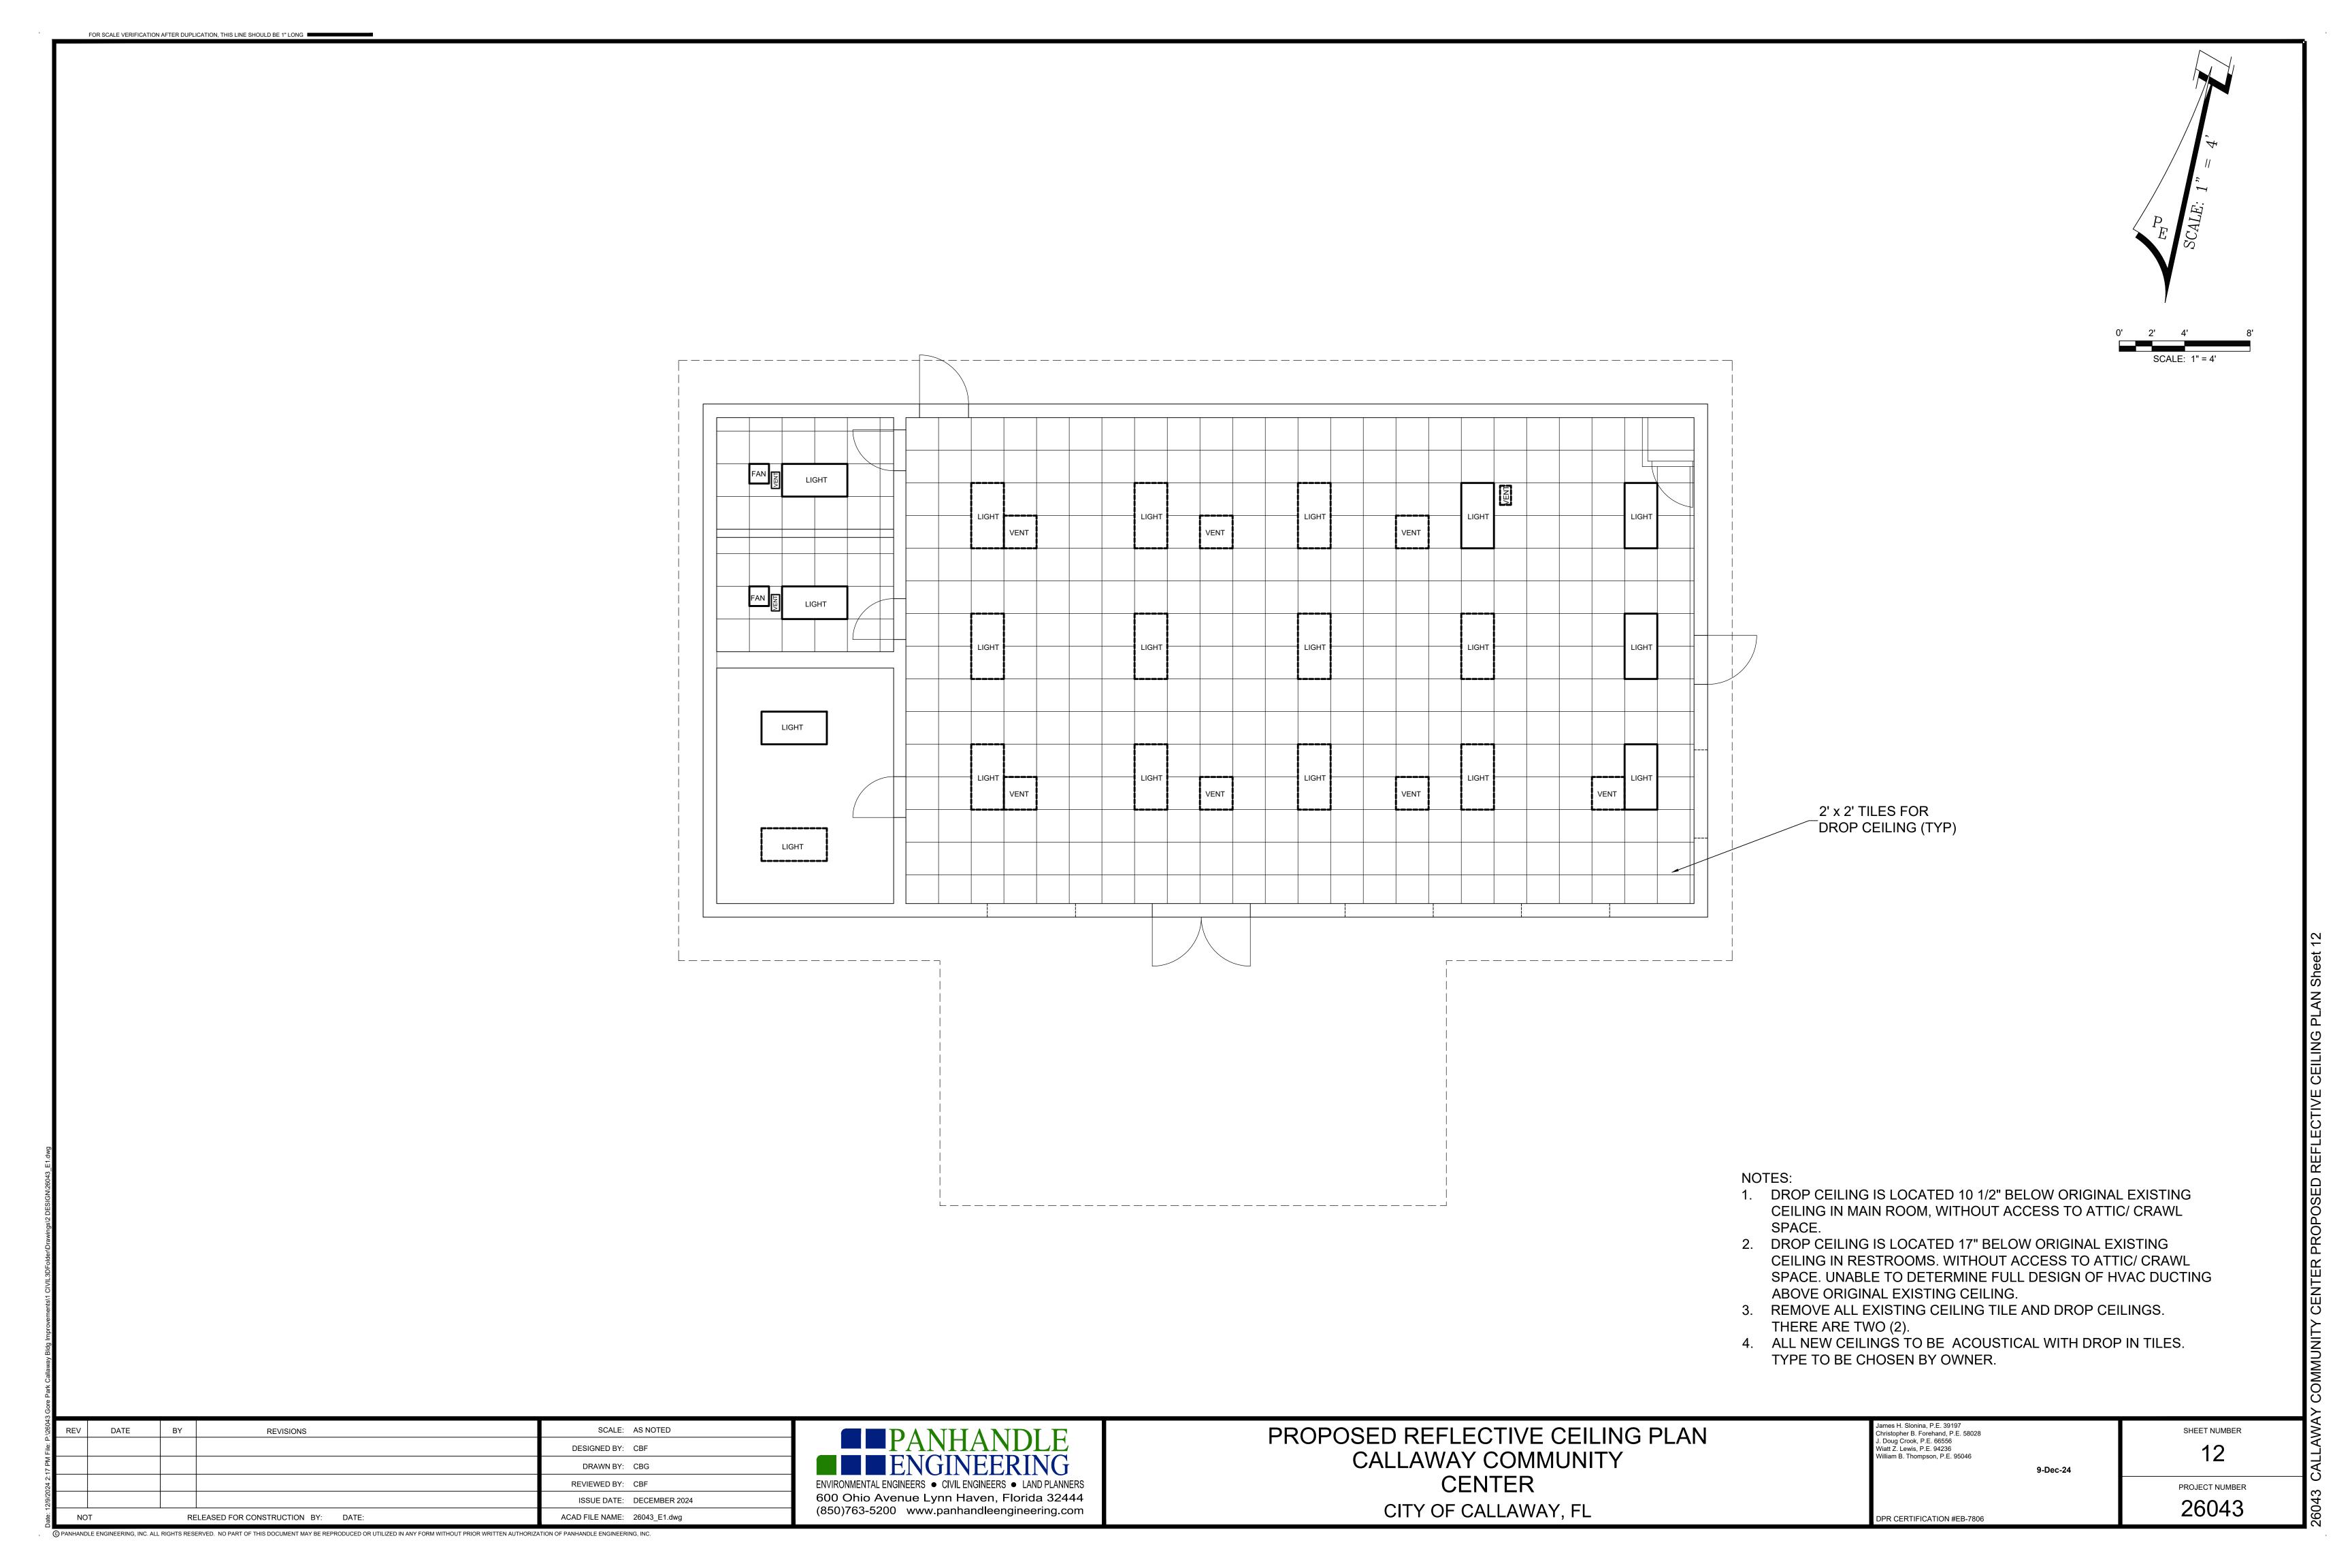HVAC NOTES:

- 1. IT IS THE INTENTION OF THIS HVAC PLAN TO SHOW GENERAL REQUIREMENTS AND LAYOUTS.
- 2. THE WORK CONSISTS OF PROVIDING AND INSTALLING A COMPLETE OPERATING AIR CONDITIONING SYSTEM.
- 3. ALL WORK SHALL BE SUPERVISED BY A LICENSED MECHANICAL CONTRACTOR.
- 4. ALL WORK SHALL COMPLY WITH APPLICABLE CODES INCLUDING THE STANDARD MECHANICAL CODE, NATIONAL ELECTRIC CODE, STATE ENERGY CODE, NFPA REQUIREMENTS, AND OTHER LOCAL CODES.
- 5. THE WORK INDICATED ON THIS PLAN IS GENERALLY DIAGRAMMATIC AND IS INTENDED TO CONVEY THE SCOPE OF WORK AND INDICATE THE GENERAL ARRANGEMENT OF DUCT WORK AND EQUIPMENT, ETC.
- 6. HVAC WORK IS TO BE COORDINATED WITH ELECTRICIANS FOR ELECTRICAL PROVISIONS.
- 7. SYSTEM SHALL BE TRANE OR APPROVED EQUAL.
- # RESTROOM ACCESSORIES SCHEDULE (B-2740) | SEE ELEV 1 SURFACE MOUNTED TOILET PAPER HOLDER 18 gage, STAINLESS STEEL GRAB BARS (36" LONG) (B-6236) SEE ELEV 18 gage, STAINLESS STEEL GRAB BARS (42" LONG) (B-6242) SEE ELEV

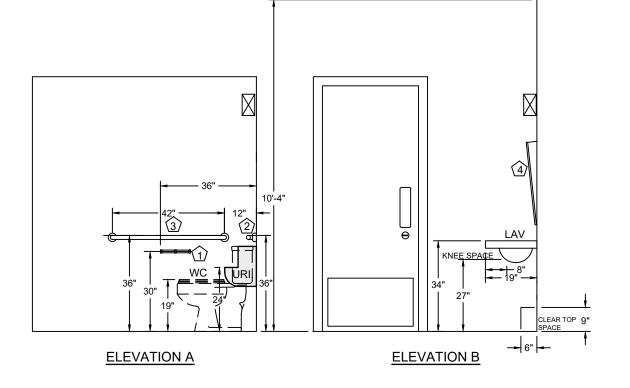

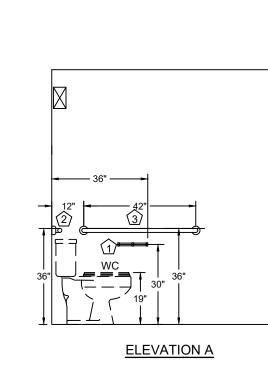

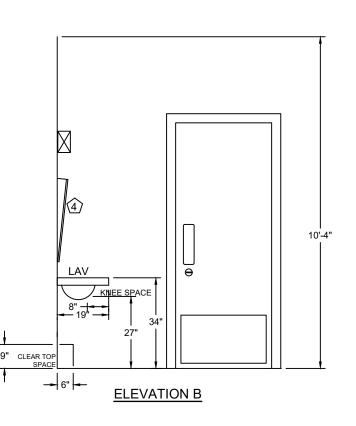

MEN'S RESTROOM


WOMEN'S RESTROOM

- RESTROOM FIXTURE SPECS.


 1. WC = WATER CLOSET AMERICAN STANDARD WHITE, HANDI-CAP,
- 1.6 GAL. FLUSH, OPEN SEAT. 2. LAV = LAVATORY AMERICAN STANDARD, HANDI-CAP, SINGLE LEVER STYLE FAUCET, CW CONNECT, HW CAP.

RELOCATE HVAC SYSTEM TO STORAGE ROOM.

- RELOCATE HVAC SYSTEM ELECTRICAL SYSTEM TO NEW LOCATION.
- PROVIDE ALL NEW DUCT WORK.
- EXISTING PLUMBING AND WATER SYSTEM TO BE UPDATED TO NEW LOCATIONS OF ALL DRAINAGE AND WATER CONNECTIONS.
- USE PEX TUBING FOR ALL RE-ROUTED PLUMBING.
- REMOVE FLOOR FOUNDATION TO INSTALL NEW SEWER.

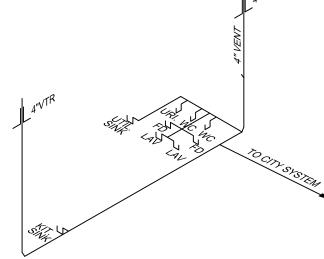

- WC = WATER CLOSET AMERICAN STANDARD WHITE, HANDI-CAP, 1.6 gal. FLUSH, OPEN SEAT.
- LAV = LAVATORY AMERICAN STANDARD, HANDI-CAP,
- URI. = URINAL AMERICAN STANDARD MAYBROOK

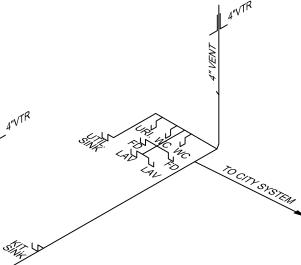

SINGLE LEVER STYLE FAUCET, CW CONNECT, HW CAP.

PLUMBING - WASTE RISER NOT TO SCALE

SYSTEM PUSH PLATE - IVES, HAGER OR STANLEY PULL PLATE - SANITGRASP GERMFREE HANDLE ARMOR PLATE (EACH SIDE) - IVES, HAGER OR STANLEY

THRESHOLD - ALUM. SADDLE - PEMKO MFG. CO.

CLOSER - LCN "CUSH-N-STOP" FINISH - US26D OVER BRASS OR STAINLESS STEEL

HINGES - HAGER - BB - STAINLESS STEEL

DETAILS ON SHEET 11.

LIGHTING SCHEDULE

DOOR SCHEDULE

"PEACHTREE DOORS"

A. H.E. WILLIAMS LED LIGHT CAT. No. EGL2-4-L250/850-HIAFR-DRV-UNV

1. FOR PLUMBING FIXTURE ELEVATIONS AND DIMENSIONS SEE RESTROOM

QUICK-LOCK WALL PLANKS OR APPROVED EQUAL TO BE USED ON

3. FLOOR IN STORAGE TO BE DALTILE SLATE ATTACHE 12"x24" META DARK

4. FLOOR IN RESTROOMS TO BE DALTILE SLATE ATTACHE 12"X24" META

5. HOT WATER PLUMBING IS TO BE PROVIDED TO THE RESTROOM SINKS

3'-0"X6'-8"X1 3/4" SOLID CORE "FG" FLUSH PANEL FILL-IN FIBERGLASS DOOR BY

LOCKSET - SCHLAGE, AD-200 OFFLINE LOCK, PROGRAMMABLE CARD LOCK

2. WALLS IN RESTROOMS TO BE TILTON KNOTTY PINE T&G V-GROOVE

INTERIOR WALLS .(COLOR CHOICE TO BE MADE BY OWNER).

GRAY OVERLAY ON TOP OF EXISTING TILE.

AND THE MOP SINK IN THE STORAGE ROOM.

DARK GRAY OVERLAY ON TOP OF EXISTING TILE.

B. PROVIDE OCCUPANT SENSOR SWITCH w/ 15 MIN. AUTO SHUTOFF



SPECIFICATIONS: AMERICAN STANDARD MAYBROOK 1.0 GPF URINAL IN WHITE OR APPROVED EQUAL. CONTRACTOR TO SUBMIT SHOP DRAWING FOR CITY APPROVAL

URINAL DETAIL
NOT TO SCALE

RESTROOM DOOR SIGN DETAIL

NOTE: SIGN "A" TO BE INSTALLED

ON RESTROOM DOOR

UNIVERS 65 TYPE

DOT DIA. 0.059" \int DOT HEIGHT = 1/32"

RED GRAPHICS ~

RED GRAPHICS -

2.25"

2.25"

GRADE 2 BRAILLE DETAIL

20.25"

EGG SHELL

SIGN "B" N.T.S.

20.25"

EGG SHELL

WHITE MATTE FIELD

GRADE 2
BRAILLE

SIGN "B" TO BE INSTALLED ON RESTROOM DOOR

STOLE RAISED 1/32"

RESTROOM INTERIOR ELEVATIONS
SCALE: 1" = 3'

REV	DATE	BY	REVISIONS	SCALE:	AS NOTED
				DESIGNED BY:	CBF
				DRAWN BY:	CBG
				REVIEWED BY:	CBF
				ISSUE DATE:	DECEMBER 2024
NO	Т	RE	LEASED FOR CONSTRUCTION BY: DATE:	ACAD FILE NAME:	26043_E1.dwg

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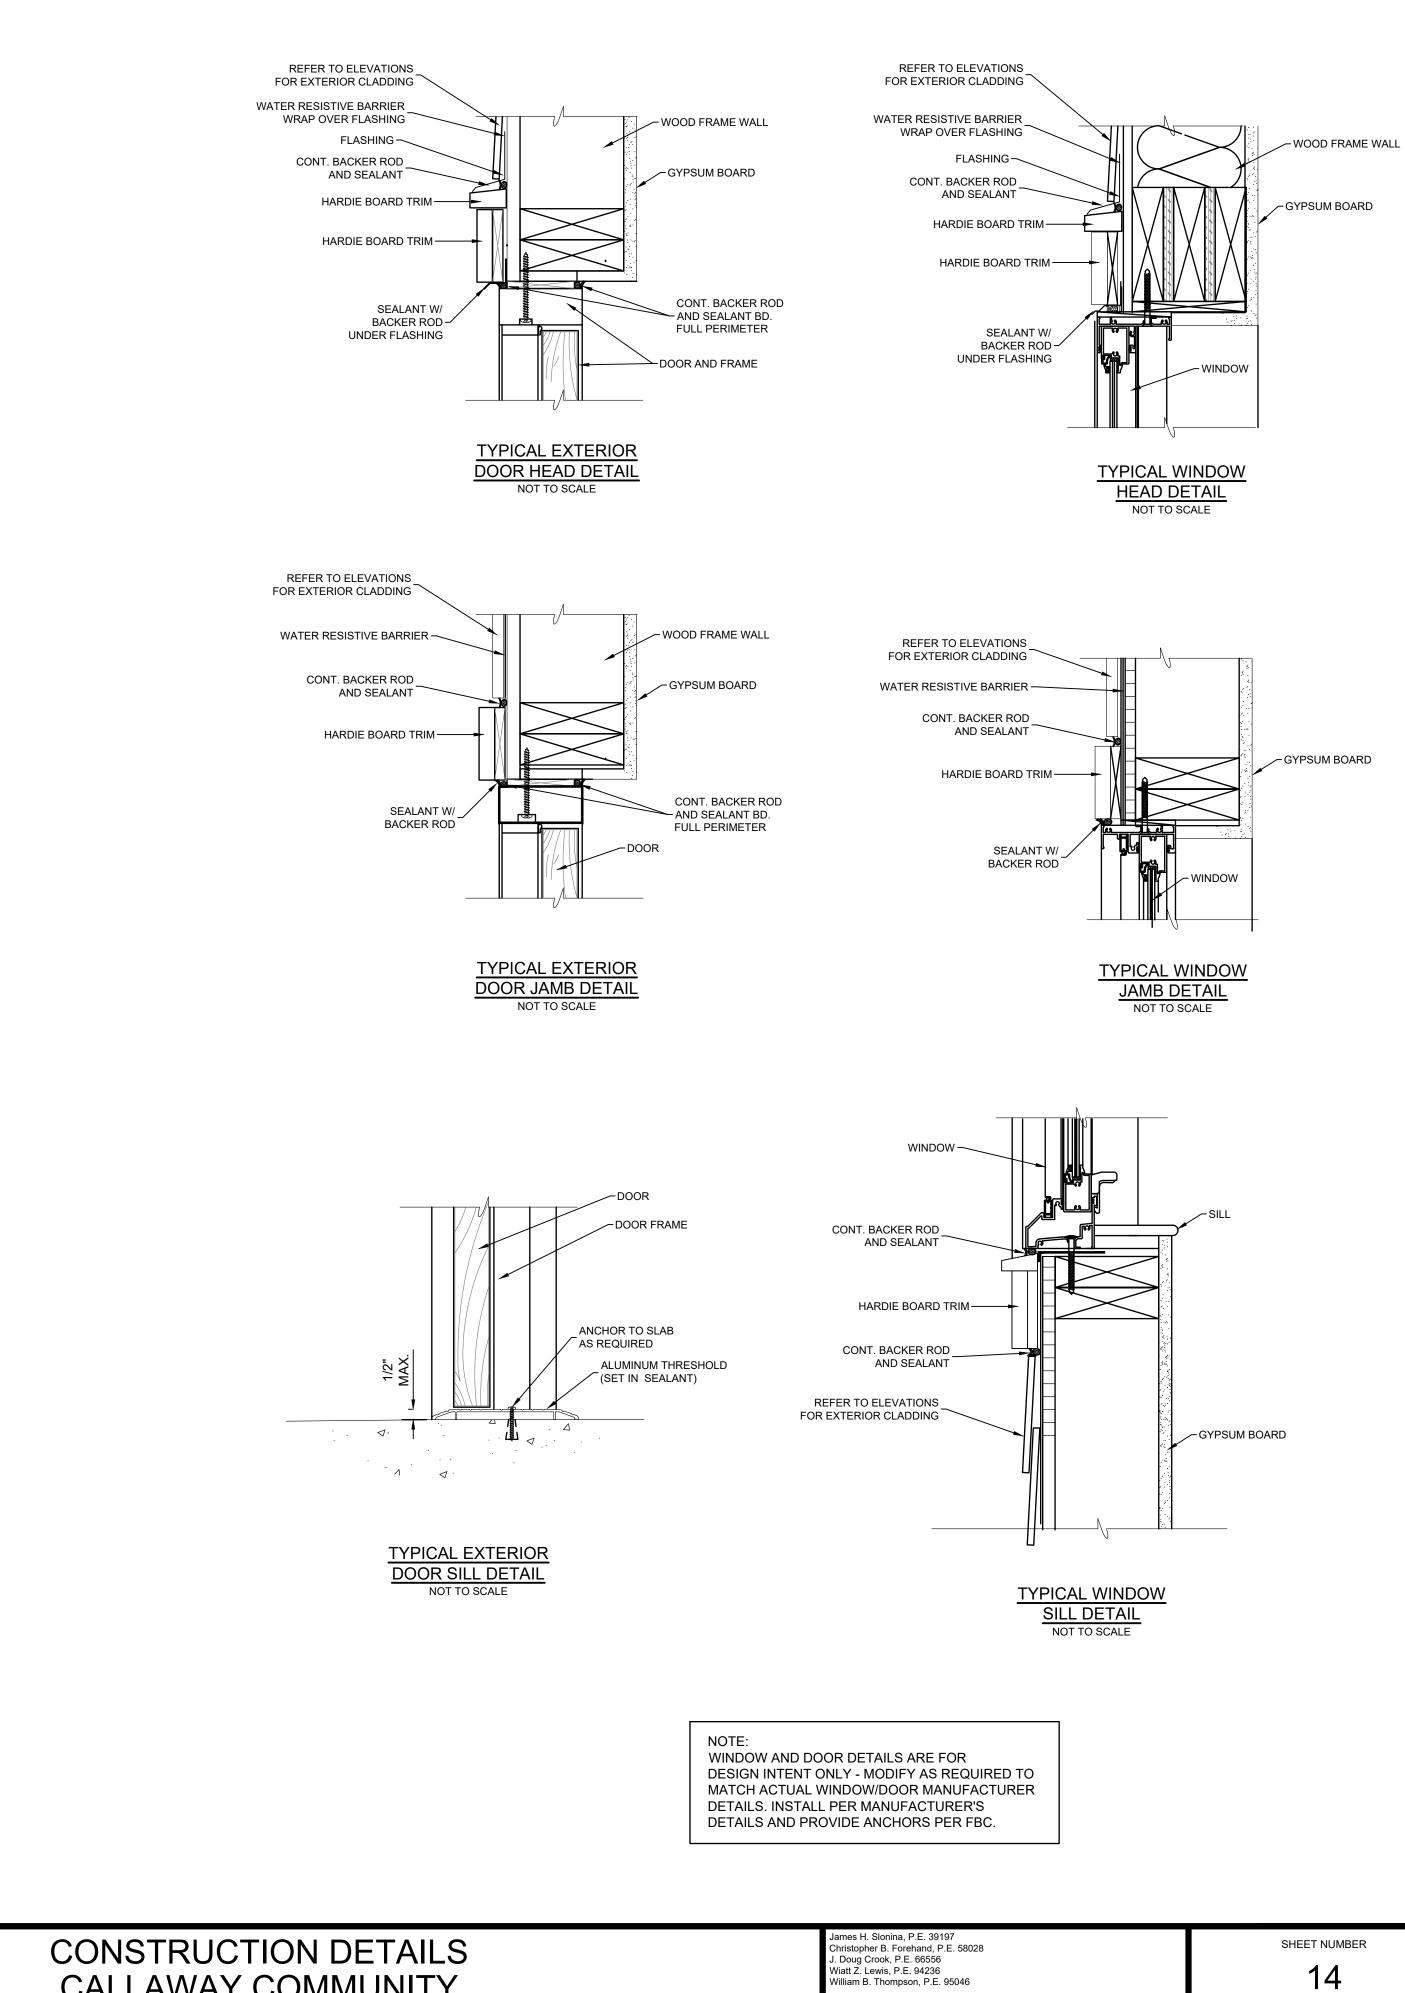
RESTROOM DETAILS CALLAWAY COMMUNITY CENTER CITY OF CALLAWAY, FL

James H. Slonina, P.E. 39197	1
Christopher B. Forehand, P.E. 58028	1
J. Doug Crook, P.E. 66556	
Niatt Z. Lewis, P.E. 94236	1
Villiam B. Thompson, P.E. 95046	ı
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9-Dec-24	
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13 PROJECT NUMBER 26043

SHEET NUMBER

OPR CERTIFICATION #EB-7806



REV DATE BY REVISIONS SCALE: AS NOTED

DESIGNED BY: CBF

DRAWN BY: CBG

DRAWN BY: CBF

REVIEWED BY: CBF

SSUE DATE: DECEMBER 2024

NOT RELEASED FOR CONSTRUCTION BY: DATE: ACAD FILE NAME: 26043_E1.dwg

ENVIRONMENTAL ENGINEERS • CIVIL ENGINEERS • LAND PLANNERS 600 Ohio Avenue Lynn Haven, Florida 32444 (850)763-5200 www.panhandleengineering.com

CONSTRUCTION DETAILS
CALLAWAY COMMUNITY
CENTER
CITY OF CALLAWAY, FL

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Christopher B. Forehand, P.E. 58028
J. Doug Crook, P.E. 66556
Wiatt Z. Lewis, P.E. 94236
William B. Thompson, P.E. 95046

9-Dec-24

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