

PROJECT TITLE:

Appleya hassee

JOB NO.: 24.103

DRAWN: MP/JR

CHECKED: ML/SC

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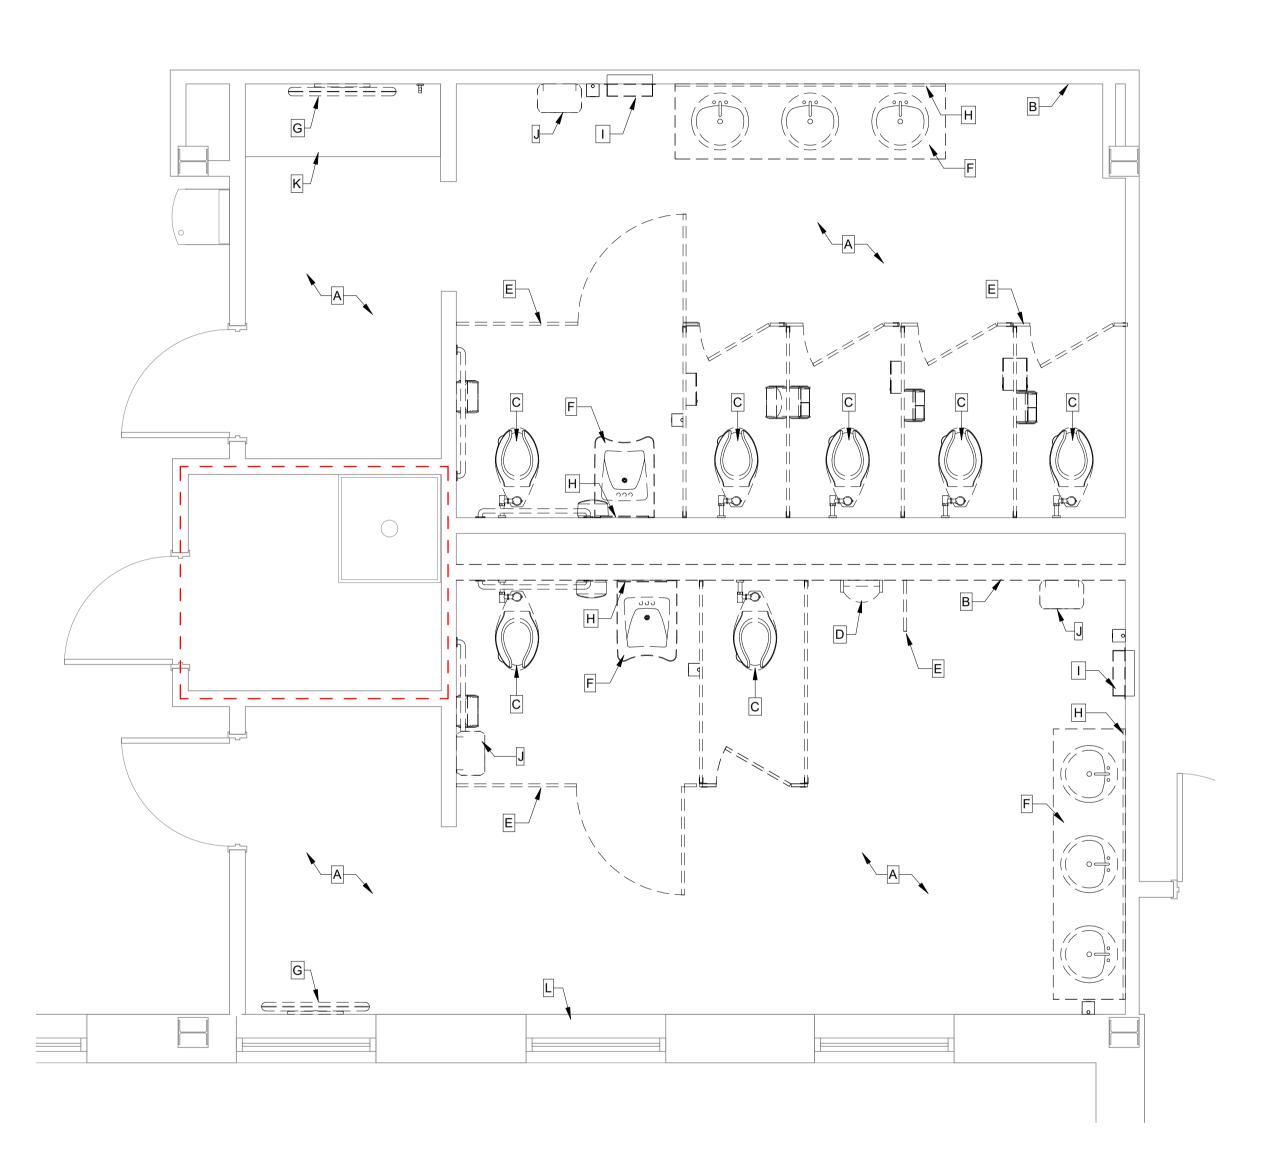
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DRAWING TITLE:

Level 1 Floor Plan -Demolition

SHEET NO.:

AD1.0



1 Level 1 Restrooms - Floor Plan - Demolition 3/8" = 1'-0"

General Demolition Notes:

SEALING DURING RENOVATION.

1. ALL DASHED ELEMENTS ARE TO BE REMOVED AS INDICATED PER

2. "SAFE-OFF" M.P.E. SYSTEMS BY QUALIFIED MECHANICAL, PLUMBING, AND ELECTRICAL CONTRACTOR, AS REQUIRED.

3. ALL DAMAGE TO FINISH SURFACES AND ALL THROUGH-SLAB OR WALL PENETRATIONS THAT REMAIN FOLLOWING THE DEMOLITION OF EXISTING WALLS SHALL BE NOTED BY CONTRACTOR FOR REPAIR AND

4. ALL DOORS AND HARDWARE ARE TO REMAIN IN PLACE AND PROTECTED UNLESS OTHERWISE INDICATED.


5. REMOVE MISCELLANEOUS WALL-MOUNTED ITEMS WITHIN THE WORK AREA, INCLUDING SIGNAGE, WALL ART, CLOCKS ETC. COORDINATE STORAGE AND REINSTALLATION W/ OWNER, UNLESS OTHERWISE NOTED.

6. EXTENT OF DEMOLITION INDICATED ON DRAWINGS IS APPROXIMATE. NOTIFY AOR IF ADDITIONAL DEMOLITION IS REQUIRED TO ACCOMMODATE NEW WORK SCOPE.

7. SLAB DEMOLITION IN RESTROOMS NOT SHOWN FOR CLARITY -EXTENTS TO BE DETERMINED ON SITE, COORDINATE WITH NEW WORK

8. PROTECT ALL FLOOR & WALL SURFACES NOT INCLUDED IN SCOPE OF WORK. DAMAGED SURFACES & FINISHES SHALL BE REPAIRED TO MATCH EXISTING CONDITIONS.

Demolition Legend:

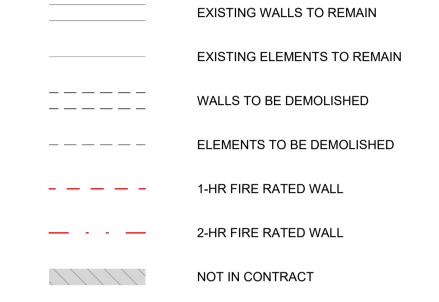

Restroom Demolition Keynotes:

- REMOVE AND DISPOSE OF EXISTING FLOOR TILE, BASE TILE, AND GROUT. PREPARE SUBSTRATE FOR NEW FINISHES INCLUDING FLOOR TOPPING AND PATCHING.
- B REMOVE AND DISPOSE OF EXISTING WALL TILE AND GROUT. PREPARE SUBSTRATE FOR NEW FINISHES.
- REMOVE & DISPOSE OF EXISTING TOILET, FLUSH VALVE &
- D REMOVE & DISPOSE OF EXISTING URINAL & FLUSH VALVE.
- REMOVE & DISPOSE OF EXISTING TOILET PARTITIONS AND
- ATTACHED ACCESSORIES.
- F REMOVE & DISPOSE OF EXISTING LAVATORY, VANITY & FAUCETS.
- G REMOVE & DISPOSE OF EXISTING CHANGING TABLE.
- H REMOVE & DISPOSE OF EXISTING MIRRORS.
- REMOVE & DISPOSE OF EXISTING HAND DRYER.
- J REMOVE & DISPOSE OF EXISTING PAPER TOWEL DISPENSER.
- K EXISTING BENCH SEATING TO REMAIN.
- REMOVE AND DISPOSE OF EXISTING WOOD WINDOW SILLS



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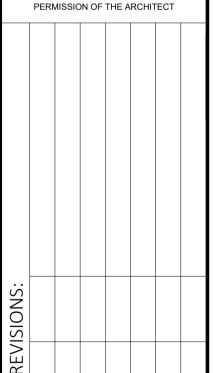
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Level 1 Restrooms -Floor Plan - Demolition

SHEET NO.:

AD1.1

DATE:





1. ALL DASHED ELEMENTS ARE TO BE REMOVED AS INDICATED PER

2. "SAFE-OFF" M.P.E. SYSTEMS BY QUALIFIED MECHANICAL, PLUMBING,

AND ELECTRICAL CONTRACTOR, AS REQUIRED.

3. ALL DAMAGE TO FINISH SURFACES AND ALL THROUGH-SLAB OR WALL PENETRATIONS THAT REMAIN FOLLOWING THE DEMOLITION OF EXISTING WALLS SHALL BE NOTED BY CONTRACTOR FOR REPAIR AND

4. ALL DOORS AND HARDWARE ARE TO REMAIN IN PLACE AND PROTECTED UNLESS OTHERWISE INDICATED.

5. REMOVE MISCELLANEOUS WALL-MOUNTED ITEMS WITHIN THE WORK AREA, INCLUDING SIGNAGE, WALL ART, CLOCKS ETC. COORDINATE STORAGE AND REINSTALLATION W/ OWNER, UNLESS

6. EXTENT OF DEMOLITION INDICATED ON DRAWINGS IS APPROXIMATE. NOTIFY AOR IF ADDITIONAL DEMOLITION IS REQUIRED TO

7. SLAB DEMOLITION IN RESTROOMS NOT SHOWN FOR CLARITY -EXTENTS TO BE DETERMINED ON SITE, COORDINATE WITH NEW WORK

8. PROTECT ALL FLOOR & WALL SURFACES NOT INCLUDED IN SCOPE OF WORK. DAMAGED SURFACES & FINISHES SHALL BE REPAIRED TO

Demolition Legend:

WALL TO BE DEMOLISHED

ELEMENT TO BE DEMOLISHED

WALL TO REMAIN

ELEMENT TO REMAIN

AREA NOT IN SCOPE

EXTENTS OF FIRE LID DEMOLITION ABOVE

EXISTING FIRE RATED WALL TO REMAIN

RCP Demolition Keynotes:

- REMOVE AND DISPOSE OF EXISTING BULKHEADS TO
- EXTENTS SHOWN.
- REMOVE AND DISPOSE OF EXISTING ACOUSTICAL CEILING TILES AND GRID TO EXTENTS SHOWN.
- REMOVE AND DISPOSE OF EXISTING RETURN GRILLES, SUPPLY
- GRILLES AND ASSOCIATED DUCTWORK IN ITS ENTIRETY - COORDINATE WITH MECHANICAL DRAWINGS.
- IDENTIFY AND "SAFE OFF" UNKNOWN DEVICES PRIOR TO REMOVAL -COORDINATE WITH ELECTRICAL DRAWINGS.
- REMOVE AND DISPOSE OF EXISTING 2' X 4' LIGHT FIXTURE IN EXISTING SUSPENDED CEILING - COORDINATE WITH ELECTRICAL
- REMOVE AND DISPOSE OF EXISTING FIRE STROBES COORDINATE
- WITH ELECTRICAL DRAWINGS.
- REMOVE AND DISPOSE OF EXISTING OCCUPANCY SENSORS - COORDINATE WITH ELECTRICAL DRAWINGS.
- REMOVE EXISTING WIFI ACCESS POINTS AND RETURN TO OWNER - COORDINATE WITH ELECTRICAL DRAWINGS.
- REMOVE AND DISPOSE OF EXISTING COVE LIGHTING TO EXTENTS
- EXISTING CEILING TO REMAIN COORDINATE WITH MEP DRAWINGS
- FOR NEW WORK SCOPE. DEMOLISH AND DISPOSE OF EXISTING FIRE LID AND ASSOCIATED
- ELEMENTS (CONDUIT, DUCTS, ETC.) TO EXTENTS SHOWN (EXISTING FRAMING/HAT CHANNELS TO REMAIN). REMOVE/SALVAGE EXISTING CABLE TRAY WITHIN FIRE LID DEMOLÍTION AREA AND STORE FOR REINSTALLATION DURING NEW WORK PHASE - COORDINATE WITH TELECOMMUNICATIONS DRAWINGS.
- REMOVE/SALVAGE EXISTING CABLE TRAY ABOVE A.C.T. CEILING ADJACENT TO PROJECT AREA AND STORE FOR REINSTALLATION DURING NEW WORK PHASE. EXTENDS OF CEILING REMOVAL TBD - COORDINATE WITH TELECOMMUNICATIONS DRAWINGS.
- M EXISTING CEILING/CEILING ELEMENTS IN RESTROOMS TO



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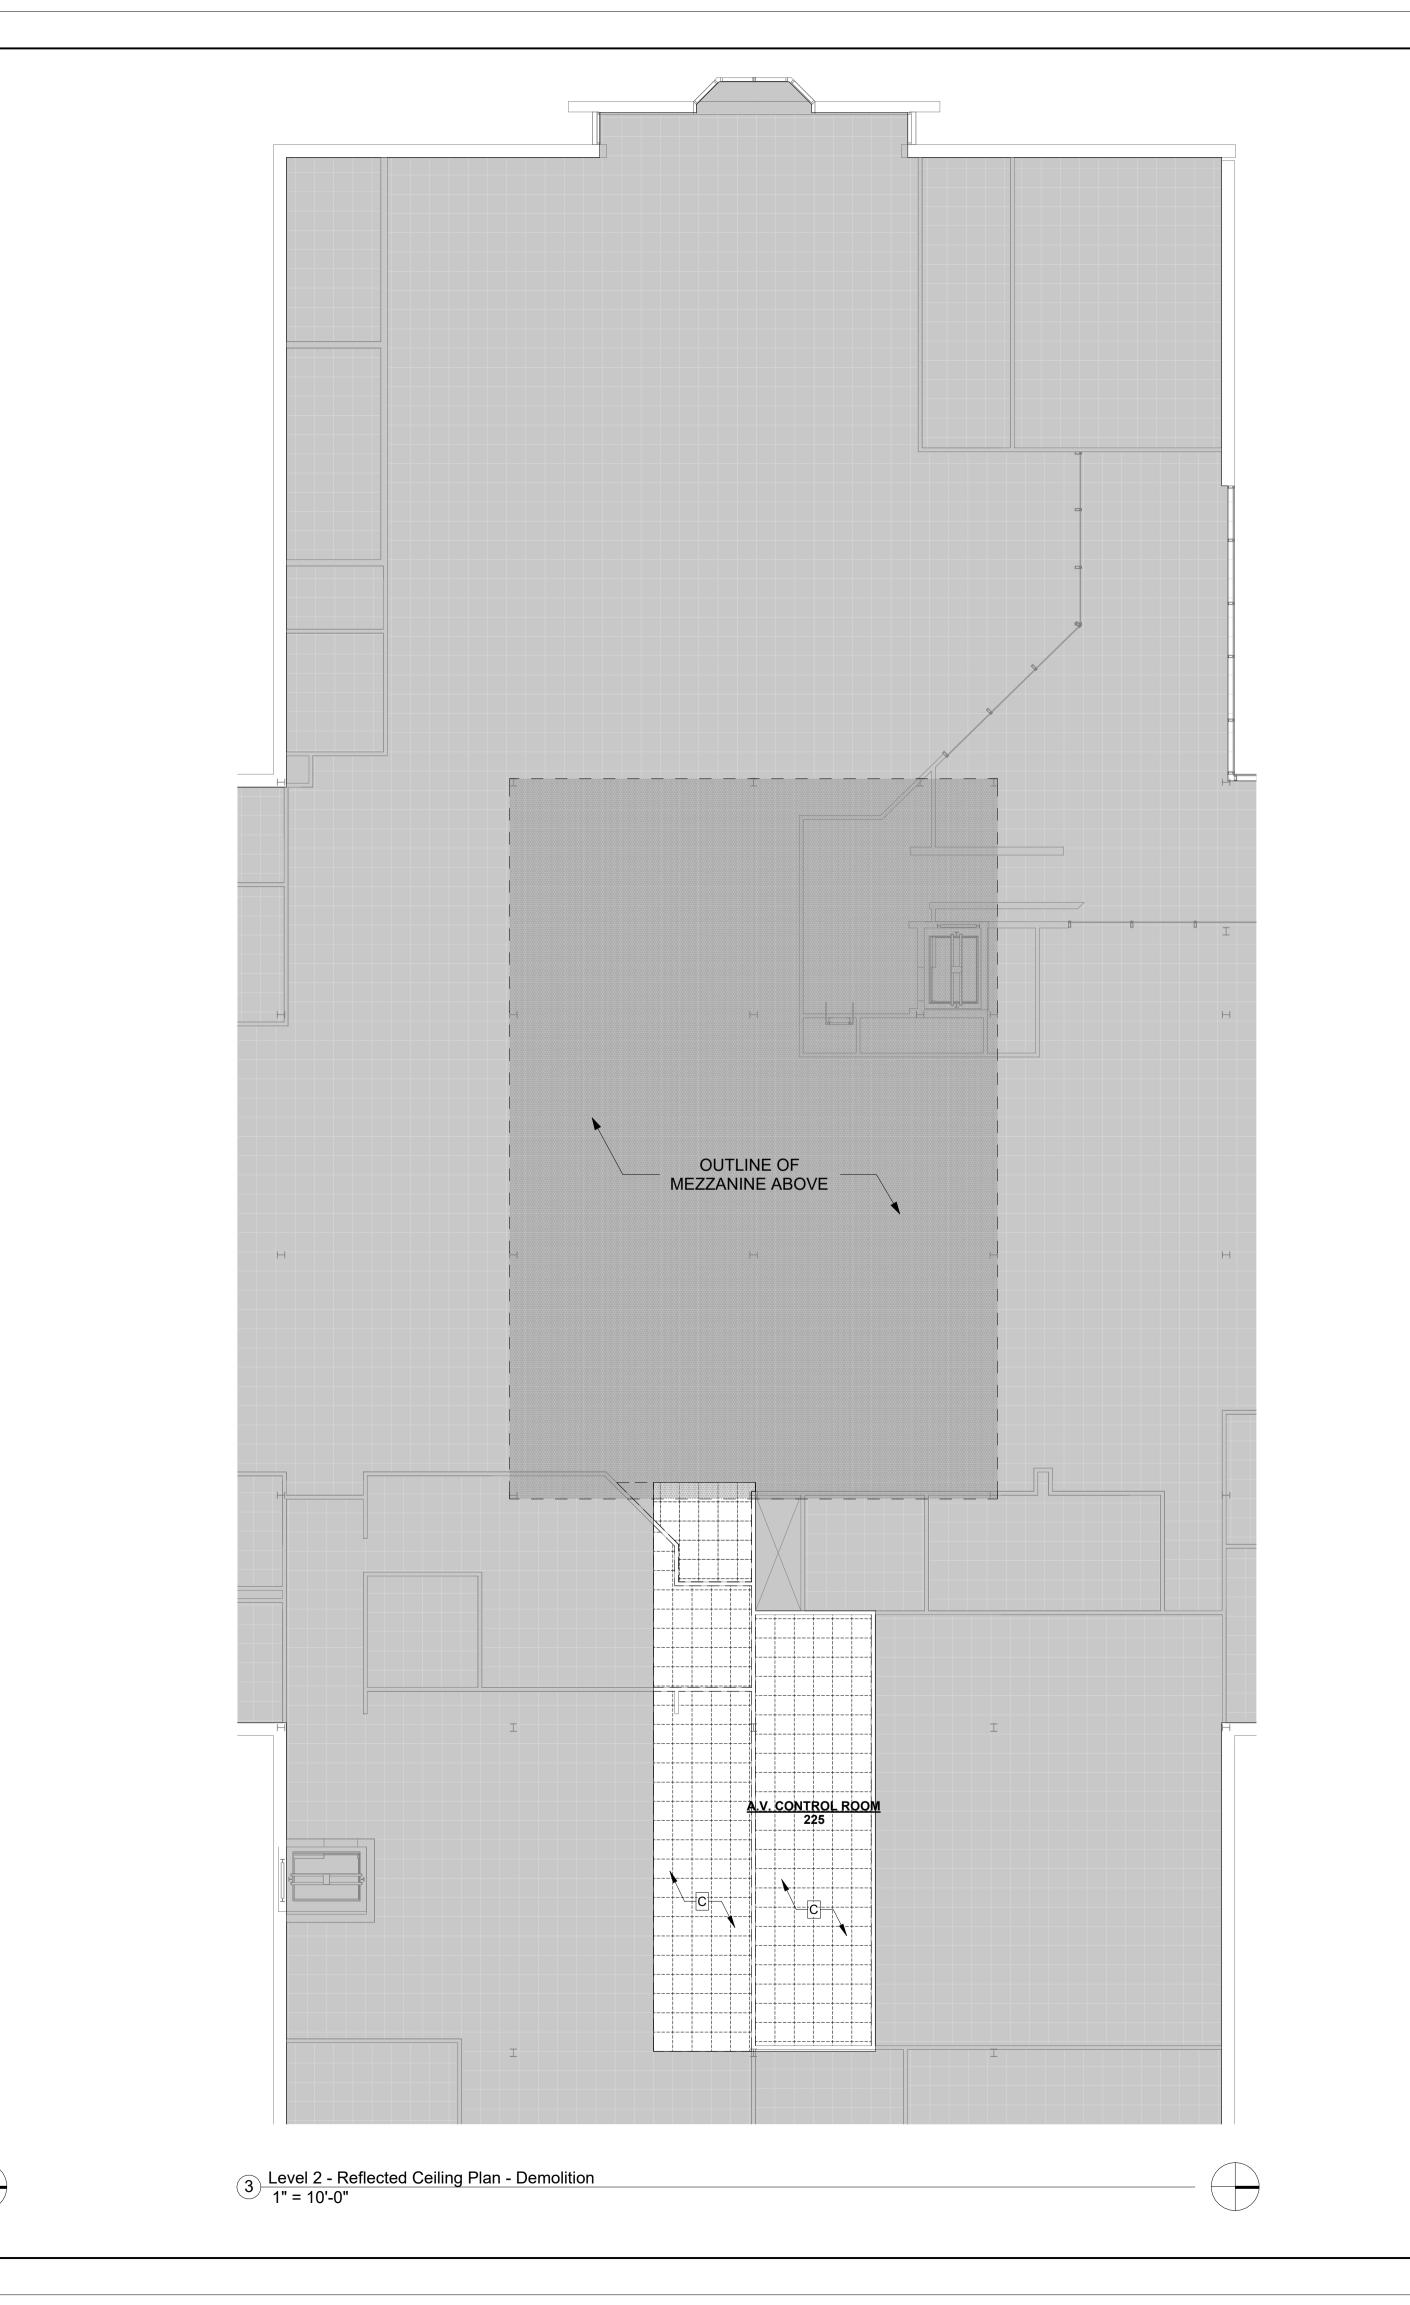
DRAWING TITLE:

Level 1 RCP -Demolition

SHEET NO.:

AD1.2

DATE:



A.V. CONTROL ROOM 225

1 Level 2 - Floor Plan - Demolition 1/4" = 1'-0"

Level 2 General Demolition Notes:

ALL DASHED ELEMENTS ARE TO BE REMOVED AS INDICATED PER
LEGEND

2. "SAFE-OFF" M.P.E. SYSTEMS BY QUALIFIED MECHANICAL, PLUMBING, AND ELECTRICAL CONTRACTOR, AS REQUIRED.

AND ELECTRICAL CONTRACTOR, AS REQUIRED.

3. ALL DAMAGE TO FINISH SURFACES AND ALL THROUGH-SLAB OR WALL PENETRATIONS THAT REMAIN FOLLOWING DEMOLITION SHALL BE NOTED

BY CONTRACTOR FOR REPAIR AND SEALING DURING RENOVATION.

4. ALL DOORS AND HARDWARE ARE TO REMAIN IN PLACE AND PROTECTED UNLESS OTHERWISE INDICATED.

5. REMOVE MISCELLANEOUS WALL-MOUNTED ITEMS WITHIN THE WORK AREA, INCLUDING SIGNAGE, WALL ART, CLOCKS ETC. COORDINATE STORAGE AND REINSTALLATION W/ OWNER, UNLESS OTHERWISE NOTED.

6. EXTENT OF DEMOLITION INDICATED ON DRAWINGS IS APPROXIMATE. NOTIFY AOR IF ADDITIONAL DEMOLITION IS REQUIRED TO ACCOMMODATE NEW WORK SCOPE.

7. PROTECT ALL FLOOR & WALL SURFACES NOT INCLUDED IN SCOPE OF WORK. DAMAGED SURFACES & FINISHES SHALL BE REPAIRED TO MATCH EXISTING CONDITIONS.

Demolition Legend:

WALL TO BE DEMOLISHED

ELEMENT TO BE DEMOLISHED

WALL TO REMAIN

ELEMENT TO REMAIN

AREA NOT IN SCOPE

EXTENTS OF FIRE LID DEMOLITION ABOVE

Level 2 Demolition Keynotes:

- - - EXISTING FIRE RATED WALL TO REMAIN

- DEMOLISH AND DISPOSE OF EXISTING FLOOR SLAB. EXTENTS OF DEMOLITION TO BE DETERMINED ON SITE AND LIMITED TO BETWEEN EXISTING BAR JOISTS COORDINATE WITH MECHANICAL DRAWINGS.
- REMOVE AND DISPOSE OF EXISTING POWER/DATA RECEPTACLES WITHIN AREA OF DEMOLITION. PATCH AND REPAIR EXISTING GYP. BOARD
- REMOVE AND STORE EXISTING CEILING GRID, TILES AND ASSOCIATED ELEMENTS (LIGHTS, HVAC DIFFUSERS AND RETURNS, SENSORS, ETC.) FOR REINSTALLATION DURING NEW WORK PHASE. EXTENTS OF REMOVAL TO BE DETERMINED ON SITE COORDINATE WITH MECHANICAL DRAWINGS.

AREA IN SCOPE

2 Area in Scope



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Maker

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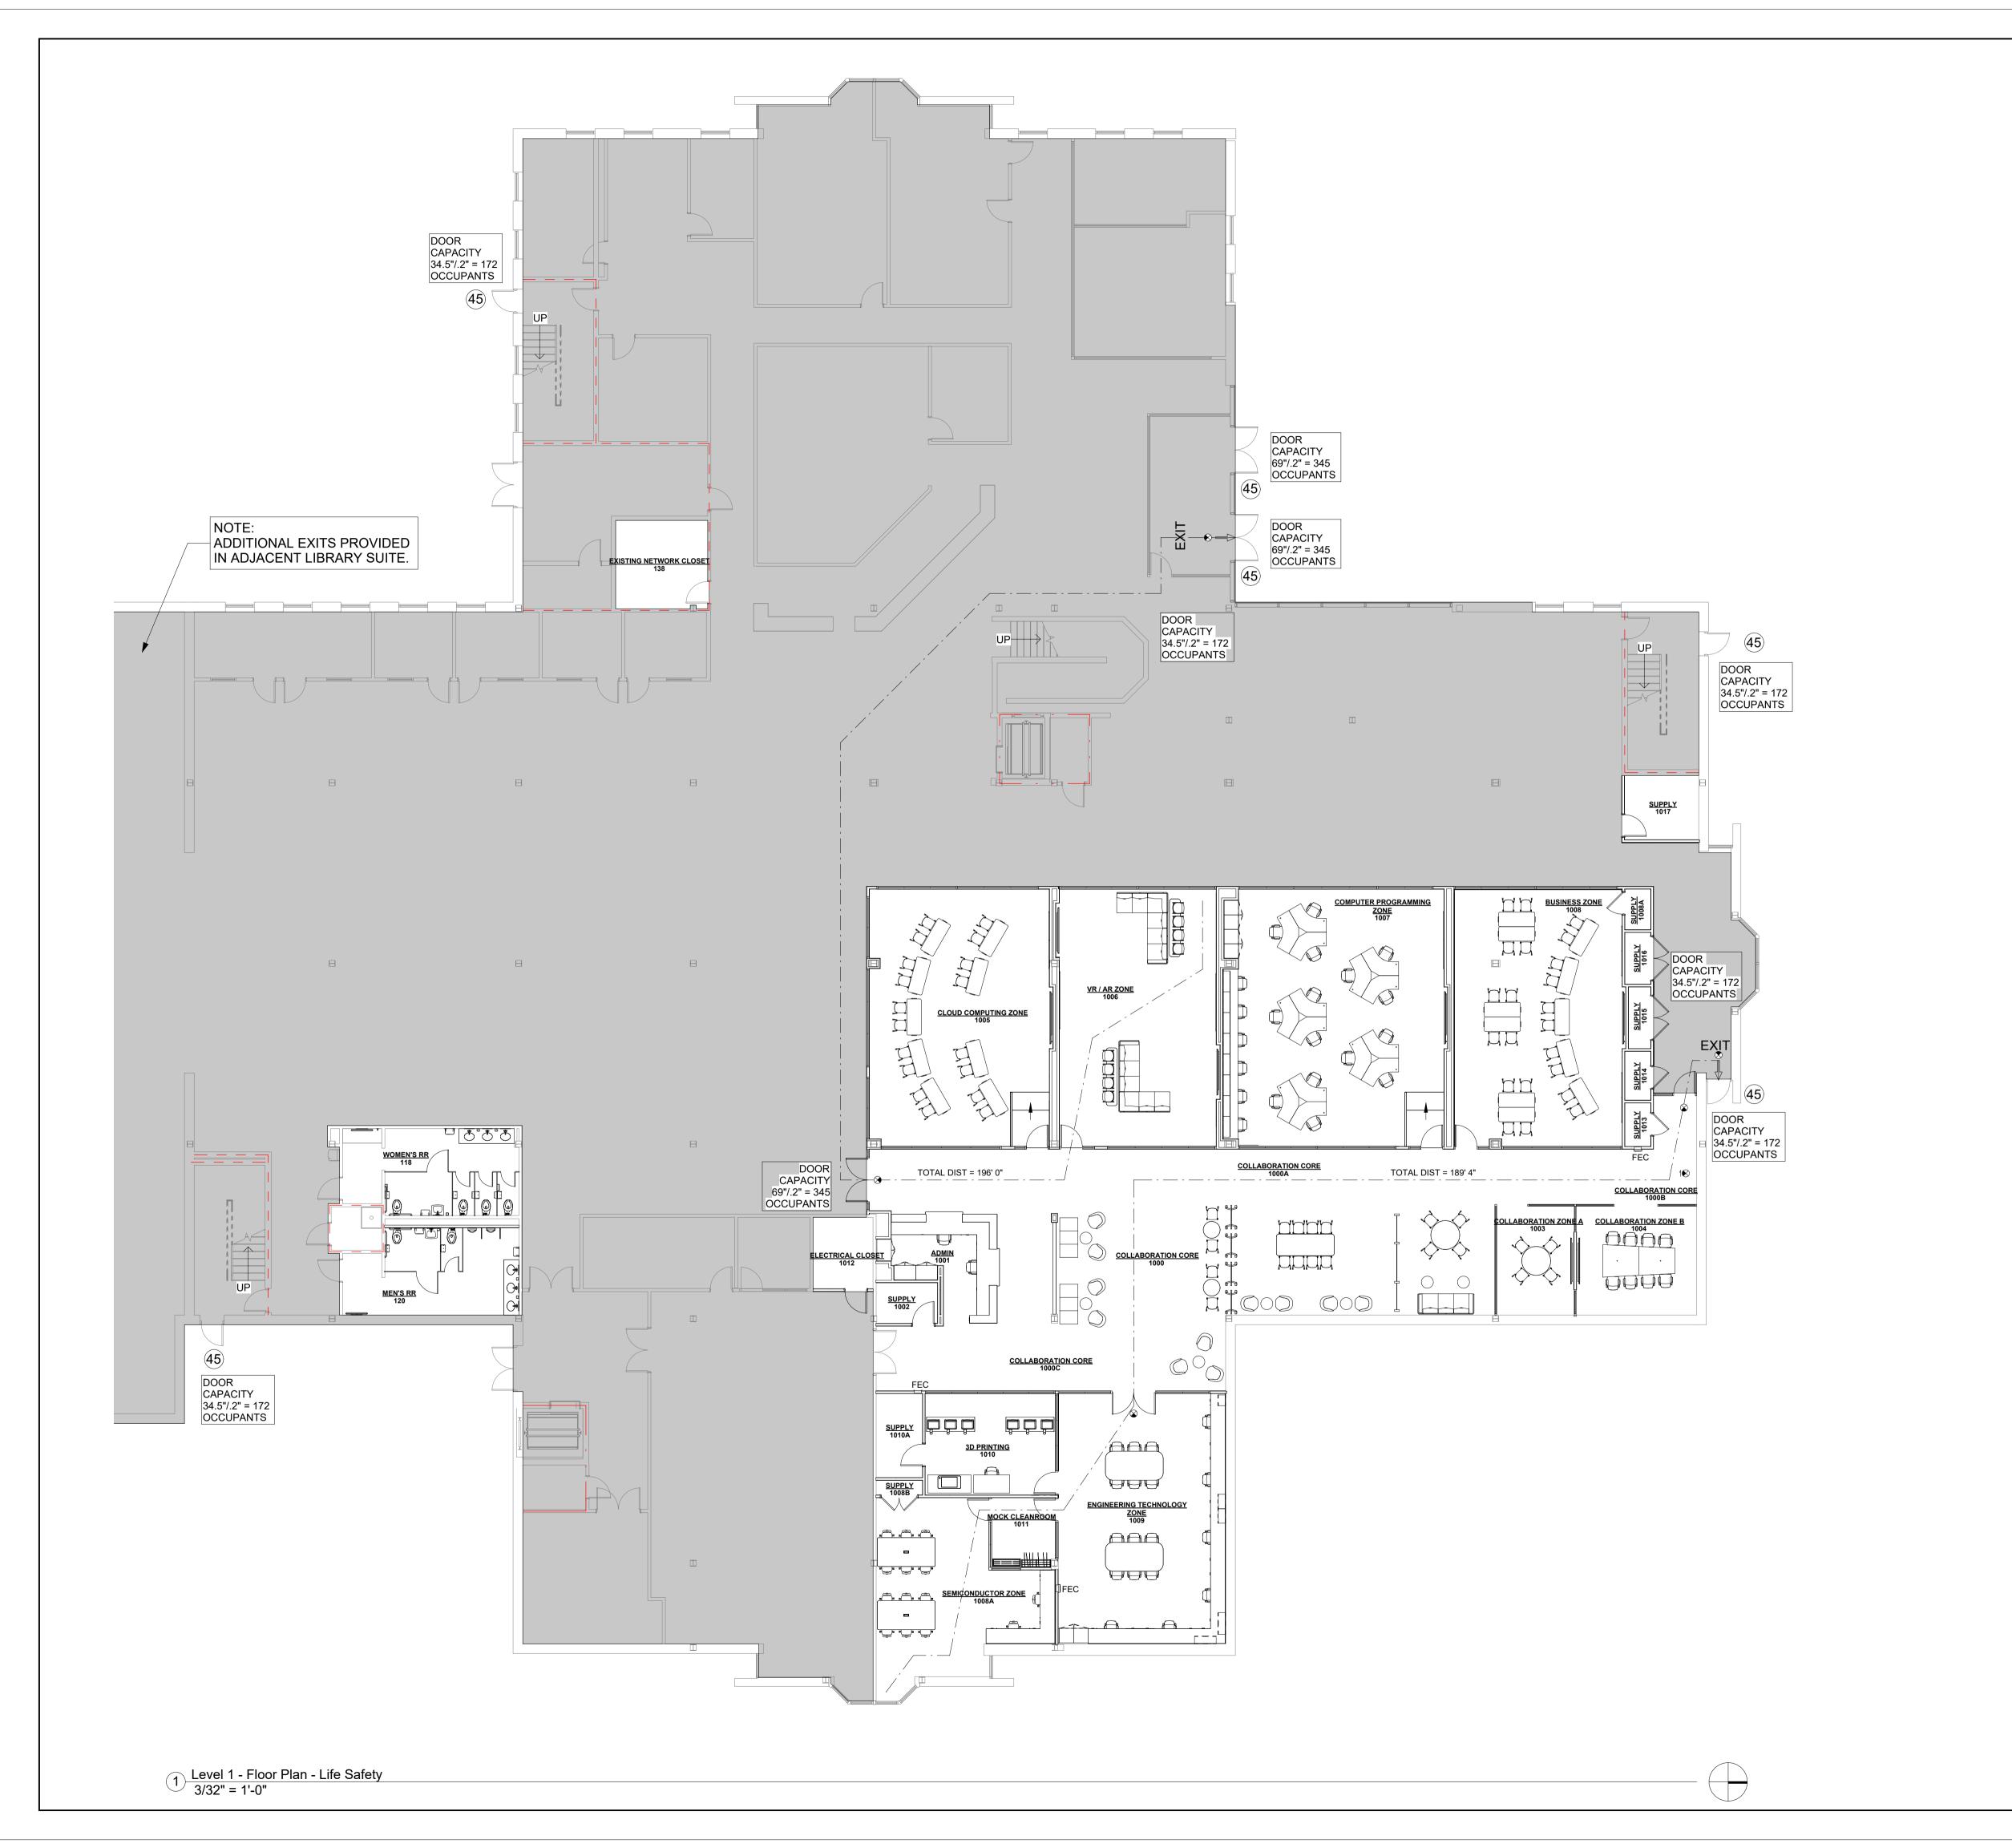
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Level 2 Floor Plan and RCP - Demolition

SHEET NO.:

AD1.3

DATE:



Life Safety Plan General Notes:

1. SEE ELECTRICAL DRAWINGS FOR INFORMATION ON EMERGENCY EGRESS LIGHTING LOCATIONS AND/OR FIRE ALARM INFORMATION.

EXISTING WALLS

EXISTING ELEMENTS

NEW WALLS


NEW ELEMENTS

- - - - 1-HR FIRE RATED WALL

- - - - TRAVEL DISTANCE

NOT IN CONTRACT

NUMBER OF OCCUPANTS AT EXIT

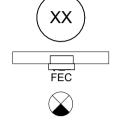

NUMBER OF OCCUPANTS AT EXIT

SEMI-RECESSED FIRE EXTINGUISHER CABINET

EXIT SIGN

Work area is less than 50% of the overall story area Use and Occupancy Classification Project Work Area Occupant Loads (FBC-B: 1004.5, FFPC: Table 7.3.1.2) Automatic Sprinkler Systems **Auto Sprinkler system is not required - the work area is les than 50% of the overall floor area for this story and does no require the addition of an auto sprinkler system per FBC-EB S804.2.2** Existing building is not sprinklered. Allowable Building Heights and Area
Assembly (A-3) (Type II A, Non-Sprinklered)
Allowable Building Height (Table 504.3)
Allowable Number of Stories (Table 504.4) Allowable Area Factor (Table 506.2) 27,125 31,849 increase.** Business (B) (Type II A, Non-Sprinklered)
Allowable Building Height (Table 504.3)
Allowable Number of Stories (Table 504.4)
Allowable Area Factor (Table 506.2) 65' 51' 5 2 65,625 31,849 Includes Frontage Increase Fire Resistance Rating for Building Elements (Type II A, Protected) Minimum Fire Resistance
Stair (FBC-B: 713.4)
Shaft/Elev. Equip. Rm. (FBC-B: 713.4) cupancy Separations (FBC-B Table 508.4) Corridors (FBC-B: 708.1 & 1020.1) Required Provided Comments lassification of Finishes (FBC-B: Table 803.11 / S804, FFPC: 39.3.3, FFPC: 12.3.3 Rooms and enclosed spaces

Exit enclosure and exit access corridors - floor finish (FBC-B: 804) Corridors
General Assembly Areas more then 300 occupants - N/A
General Assembly Areas less than 300 occupants
Exit enclosure and exit access corridors - floor finish (FBC-B: 804) Maximum Travel Distance (New Business - NS) Corridor Fire-Resistance Rating
Assembly - not sprinklered FBC-B Table 1020.1 / FFPC 13.3.6 FBC-B Table 1020.1 / FFPC 38.3.6 Business - not sprinklered Minimum Corridor Width
Minimum corridor width FBC-B Table 1020.3 44" N/A **36" Where less than 50 occupants served** Dead End Corridor

Maximum Dead End Corridor

Maximum Dead End Corridor Minimum Number of Exits
Minimum Number of Exits per Story
Minimum Number of Exits per Story Spaces with One Exit (business) 1 **Max. 49 occupants, with common path of egress of 75'**
2 **600 or fewer Occupants** Spaces with One Exit (assembly) Number of Means of Egress Minimum Number of Required Plumbing Fixtures (FBC-P Table 403.1) 4 floor fixture count.



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ements Floor

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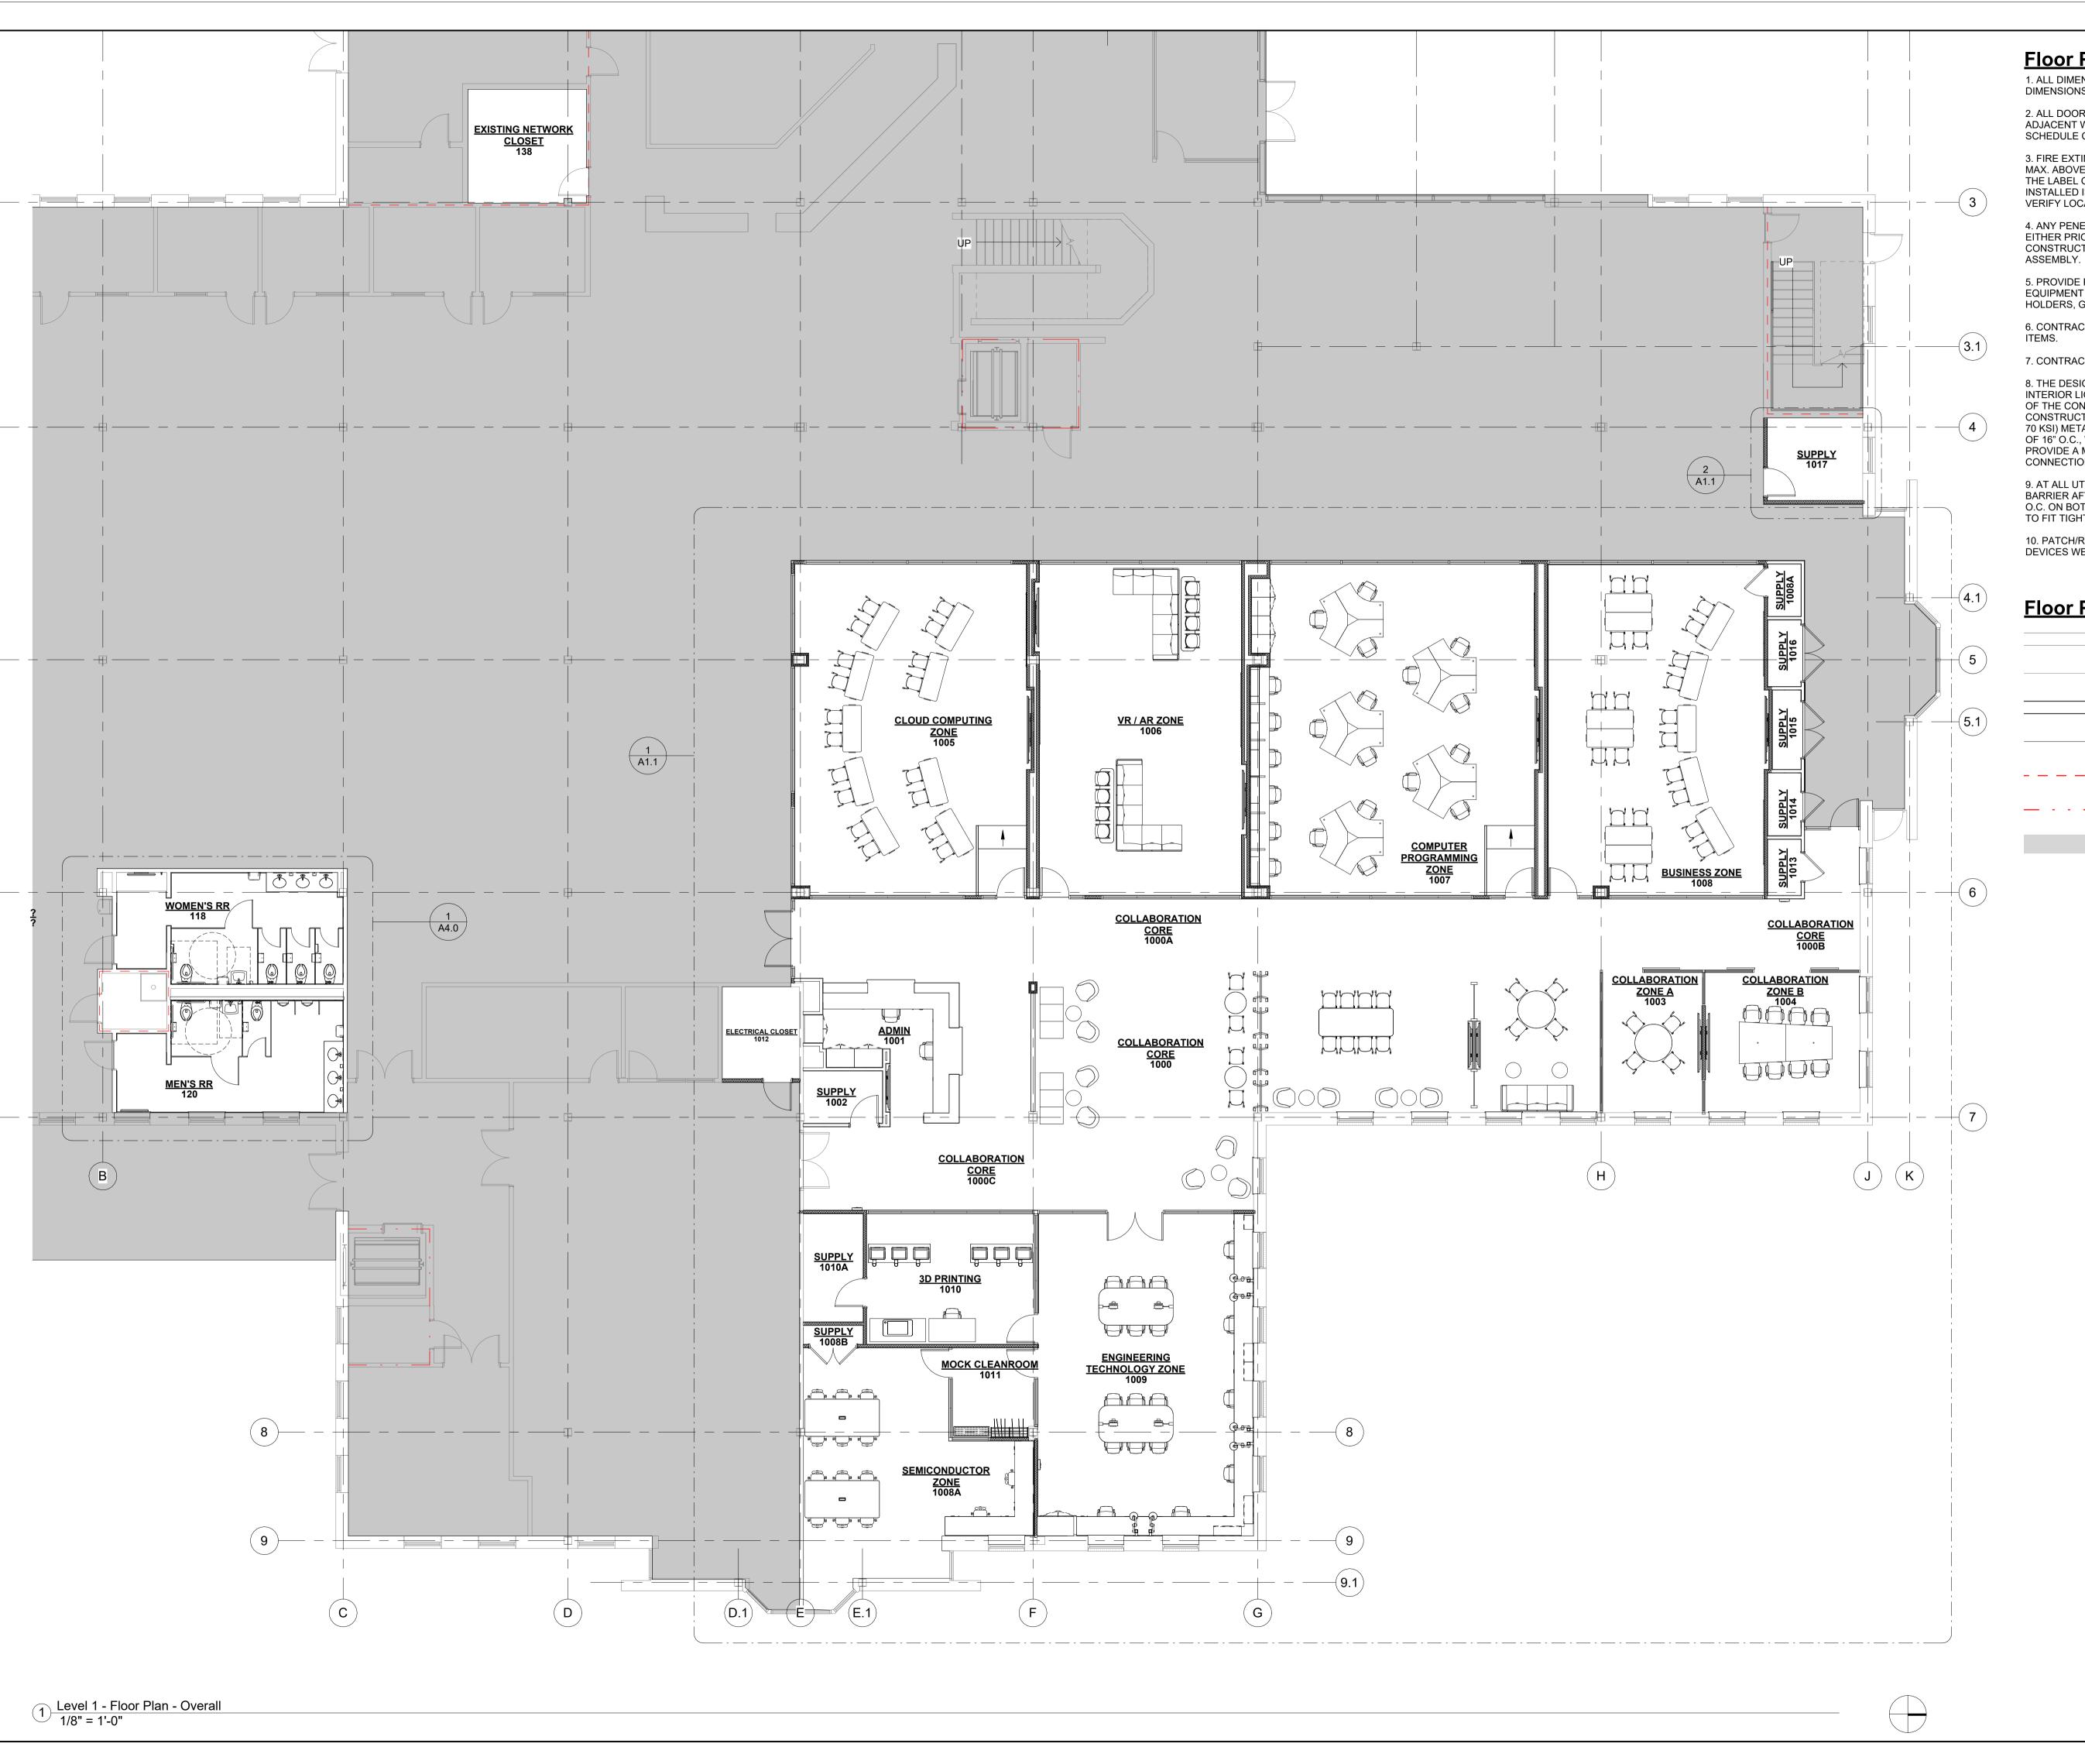
Level 1 Life Safety Plan

SHEET NO.:

A0.1

February 7, 2025

DATE:



Floor Plan General Notes:

1. ALL DIMENSIONS FOR NEW PARTITIONS ARE TO FACE OF STUD. DIMENSIONS TO EXISTING WALLS ARE TO FACE OF FINISH SURFACE.

2. ALL DOOR OPENINGS TO BE LOCATED 6" FROM FACE OF STUD OF ADJACENT WALL ON HINGE SIDE UNLESS OTHERWISE NOTED. SEE DOOR SCHEDULE COMMENTS AND PLAN DIMENSIONS.

3. FIRE EXTINGUISHERS SHALL BE MOUNTED BETWEEN 41" MIN. AND 48" MAX. ABOVE FINISH FLOOR. PORTABLE FIRE EXTINGUISHERS SHALL BEAR THE LABEL OF AN APPROVED AGENCY, BE AN APPROVED TYPE, AND BE INSTALLED IN A LOCATION VISIBLE AND ACCESSIBLE TO THE OCCUPANTS. VERIFY LOCATION IN FIELD WITH FIRE MARSHALL.

4. ANY PENETRATIONS THROUGH AN EXISTING FIRE RATED ASSEMBLY, EITHER PRIOR TO CONSTRUCTION ACTIVITIES, OR AS A RESULT OF CONSTRUCTION SHALL BE SEALED WITH APPROPRIATE U.L. RATED

5. PROVIDE PLYWOOD BLOCKING BEHIND GYP. BOARD TO SUPPORT EQUIPMENT AND/OR MISC. ITEMS INSTALLED (MILLWORK, TOILET PAPER HOLDERS, GRAB BARS, MIRRORS, ETC.).

6. CONTRACTOR TO COORDINATE DELIVERY OF ALL OWNER SUPPLIED

7. CONTRACTOR TO SUBMIT SHOP DRAWINGS FOR ALL MILLWORK.

8. THE DESIGN AND CONSTRUCTION OF ALL NON-LOAD BEARING INTERIOR LIGHT GAUGE METAL FRAMING SHALL BE THE RESPONSIBILITY OF THE CONTRACTOR. AT A MINIMUM, THIS FRAMING SHALL BE CONSTRUCTED OF 20 GAUGE (30 MIL – 33 KSI) OR 20 GAUGE EQ (18 MIL – 70 KSI) METAL STUDS AND TRACK, STUDS SHALL HAVE MAXIMUM SPACING OF 16" O.C., WITH DOUBLE STUDS AT DOOR AND WINDOW JAMBS. PROVIDE A MINIMUM OF TWO #10 SELF TAPPING SCREWS AT ALL CONNECTIONS.

9. AT ALL UTILITY TRENCHES IN EXISTING SLAB, ADD 6 MIL. VAPOR BARRIER AFTER SOIL HAS BEEN TREATED. PROVIDE #3 DOWELS @ 24" O.C. ON BOTH SIDES. DRILL HOLES 6" DEEP IN ADJACENT SLAB. DOWELS TO FIT TIGHT AND SECURE IN HOLES.

10. PATCH/REPAIR FIRE RATED GYP. BOARD AT COLUMNS WHERE DEVICES WERE REMOVED DURING DEMOLITION PHASE.

Floor Plan Legend:

EXISTING WALLS

EXISTING ELEMENTS

NEW WALLS

NEW ELEMENTS

— 2-HR FIRE RATED WALL

AREA NOT IN SCOPE

1-HR FIRE RATED WALL

ARCHITECTURE

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SC Library - 1st Floor

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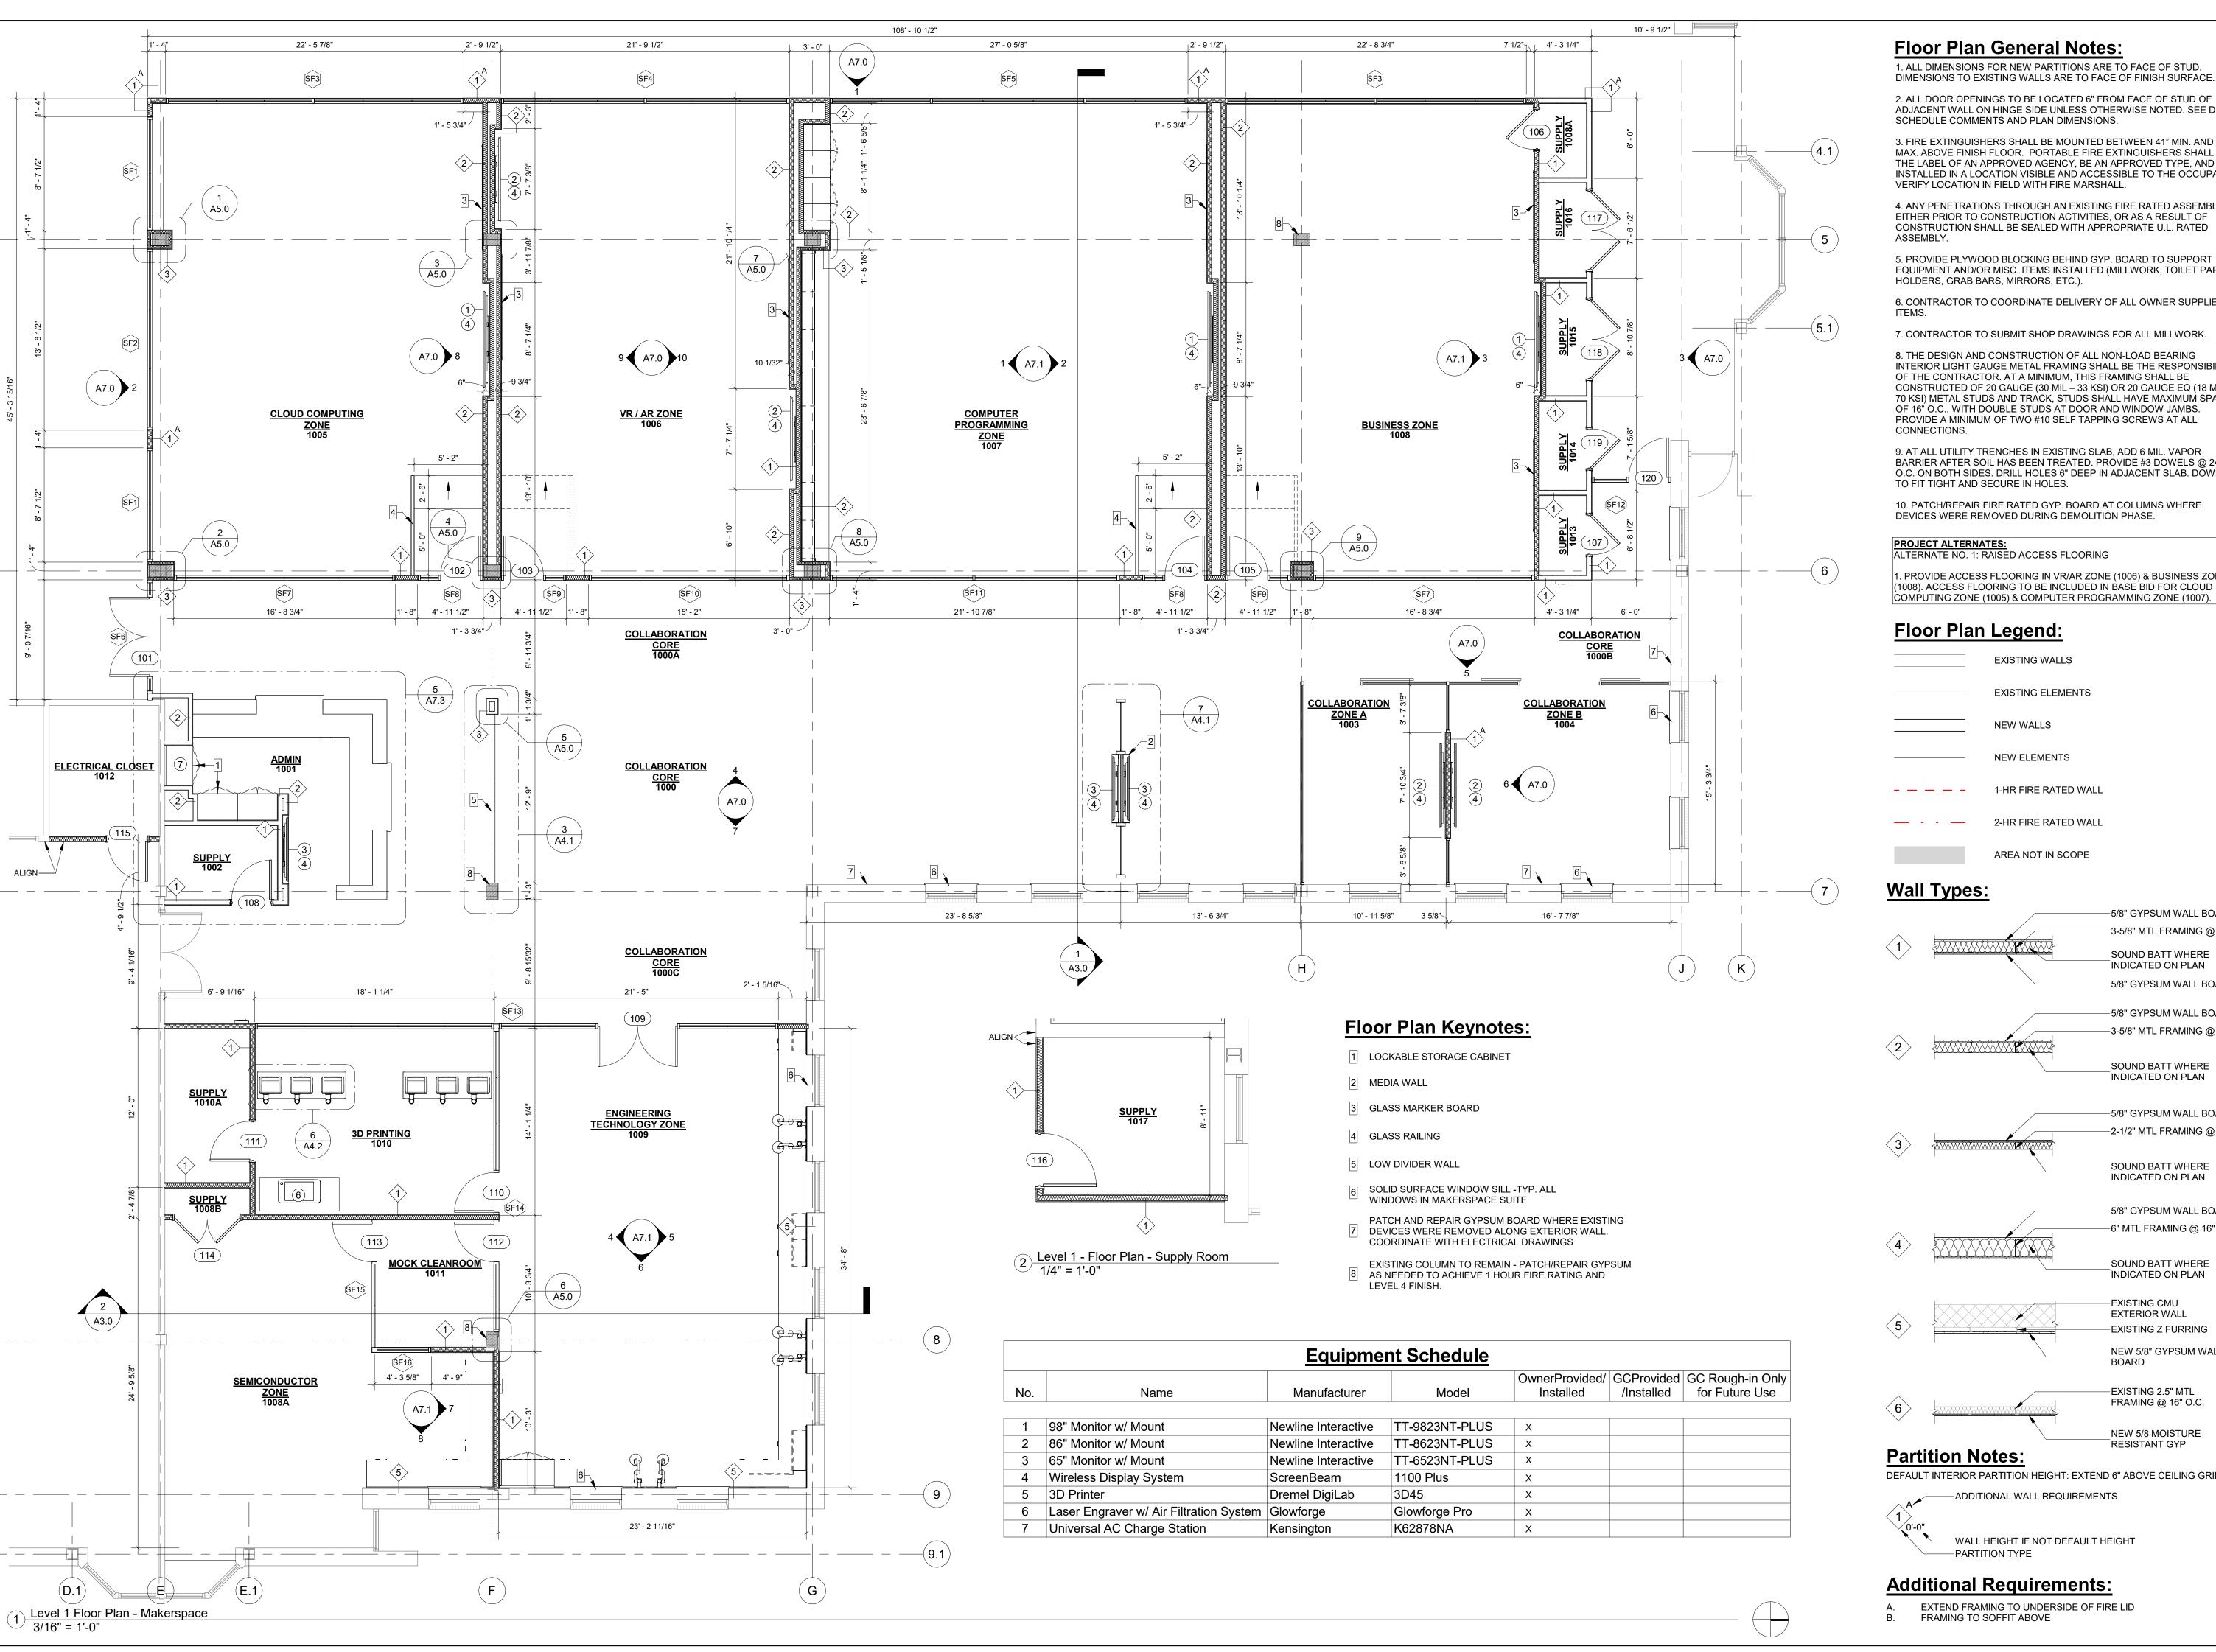
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Level 1 Floor Plan -Overall

SHEET NO.:

A1.0

DATE:



Floor Plan General Notes:

1. ALL DIMENSIONS FOR NEW PARTITIONS ARE TO FACE OF STUD. DIMENSIONS TO EXISTING WALLS ARE TO FACE OF FINISH SURFACE.

2. ALL DOOR OPENINGS TO BE LOCATED 6" FROM FACE OF STUD OF ADJACENT WALL ON HINGE SIDE UNLESS OTHERWISE NOTED. SEE DOOR SCHEDULE COMMENTS AND PLAN DIMENSIONS.

3. FIRE EXTINGUISHERS SHALL BE MOUNTED BETWEEN 41" MIN. AND 48" MAX. ABOVE FINISH FLOOR. PORTABLE FIRE EXTINGUISHERS SHALL BEAR THE LABEL OF AN APPROVED AGENCY, BE AN APPROVED TYPE, AND BE INSTALLED IN A LOCATION VISIBLE AND ACCESSIBLE TO THE OCCUPANTS. VERIFY LOCATION IN FIELD WITH FIRE MARSHALL.

4. ANY PENETRATIONS THROUGH AN EXISTING FIRE RATED ASSEMBLY, EITHER PRIOR TO CONSTRUCTION ACTIVITIES, OR AS A RESULT OF CONSTRUCTION SHALL BE SEALED WITH APPROPRIATE U.L. RATED

5. PROVIDE PLYWOOD BLOCKING BEHIND GYP. BOARD TO SUPPORT EQUIPMENT AND/OR MISC. ITEMS INSTALLED (MILLWORK, TOILET PAPER HOLDERS, GRAB BARS, MIRRORS, ETC.).

6. CONTRACTOR TO COORDINATE DELIVERY OF ALL OWNER SUPPLIED

7. CONTRACTOR TO SUBMIT SHOP DRAWINGS FOR ALL MILLWORK.

8. THE DESIGN AND CONSTRUCTION OF ALL NON-LOAD BEARING INTERIOR LIGHT GAUGE METAL FRAMING SHALL BE THE RESPONSIBILITY OF THE CONTRACTOR. AT A MINIMUM, THIS FRAMING SHALL BE CONSTRUCTED OF 20 GAUGE (30 MIL - 33 KSI) OR 20 GAUGE EQ (18 MIL -70 KSI) METAL STUDS AND TRACK, STUDS SHALL HAVE MAXIMUM SPACING OF 16" O.C., WITH DOUBLE STUDS AT DOOR AND WINDOW JAMBS. PROVIDE A MINIMUM OF TWO #10 SELF TAPPING SCREWS AT ALL CONNECTIONS.

9. AT ALL UTILITY TRENCHES IN EXISTING SLAB, ADD 6 MIL. VAPOR BARRIER AFTER SOIL HAS BEEN TREATED. PROVIDE #3 DOWELS @ 24" O.C. ON BOTH SIDES. DRILL HOLES 6" DEEP IN ADJACENT SLAB. DOWELS TO FIT TIGHT AND SECURE IN HOLES.

10. PATCH/REPAIR FIRE RATED GYP. BOARD AT COLUMNS WHERE DEVICES WERE REMOVED DURING DEMOLITION PHASE.

PROJECT ALTERNATES: ALTERNATE NO. 1: RAISED ACCESS FLOORING

1. PROVIDE ACCESS FLOORING IN VR/AR ZONE (1006) & BUSINESS ZONE (1008). ACCESS FLOORING TO BE INCLUDED IN BASE BID FOR CLOUD

Floor Plan Legend:

EXISTING WALLS EXISTING ELEMENTS NEW WALLS

1-HR FIRE RATED WALL

2-HR FIRE RATED WALL

AREA NOT IN SCOPE

NEW ELEMENTS

Wall Types:

-5/8" GYPSUM WALL BOARD -3-5/8" MTL FRAMING @ 16" O.C SOUND BATT WHERE INDICATED ON PLAN -5/8" GYPSUM WALL BOARD -5/8" GYPSUM WALL BOARD -3-5/8" MTL FRAMING @ 16" O.C SOUND BATT WHERE


-5/8" GYPSUM WALL BOARD -2-1/2" MTL FRAMING @ 16" O.C.


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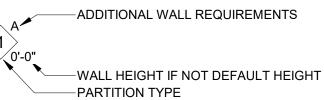
-5/8" GYPSUM WALL BOARD -6" MTL FRAMING @ 16" O.C.





Partition Notes:

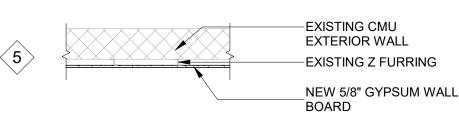DEFAULT INTERIOR PARTITION HEIGHT: EXTEND 6" ABOVE CEILING GRID

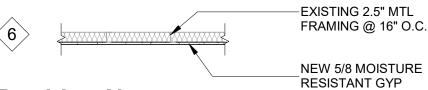

Additional Requirements:

EXTEND FRAMING TO UNDERSIDE OF FIRE LID FRAMING TO SOFFIT ABOVE

ARCHITECTURE

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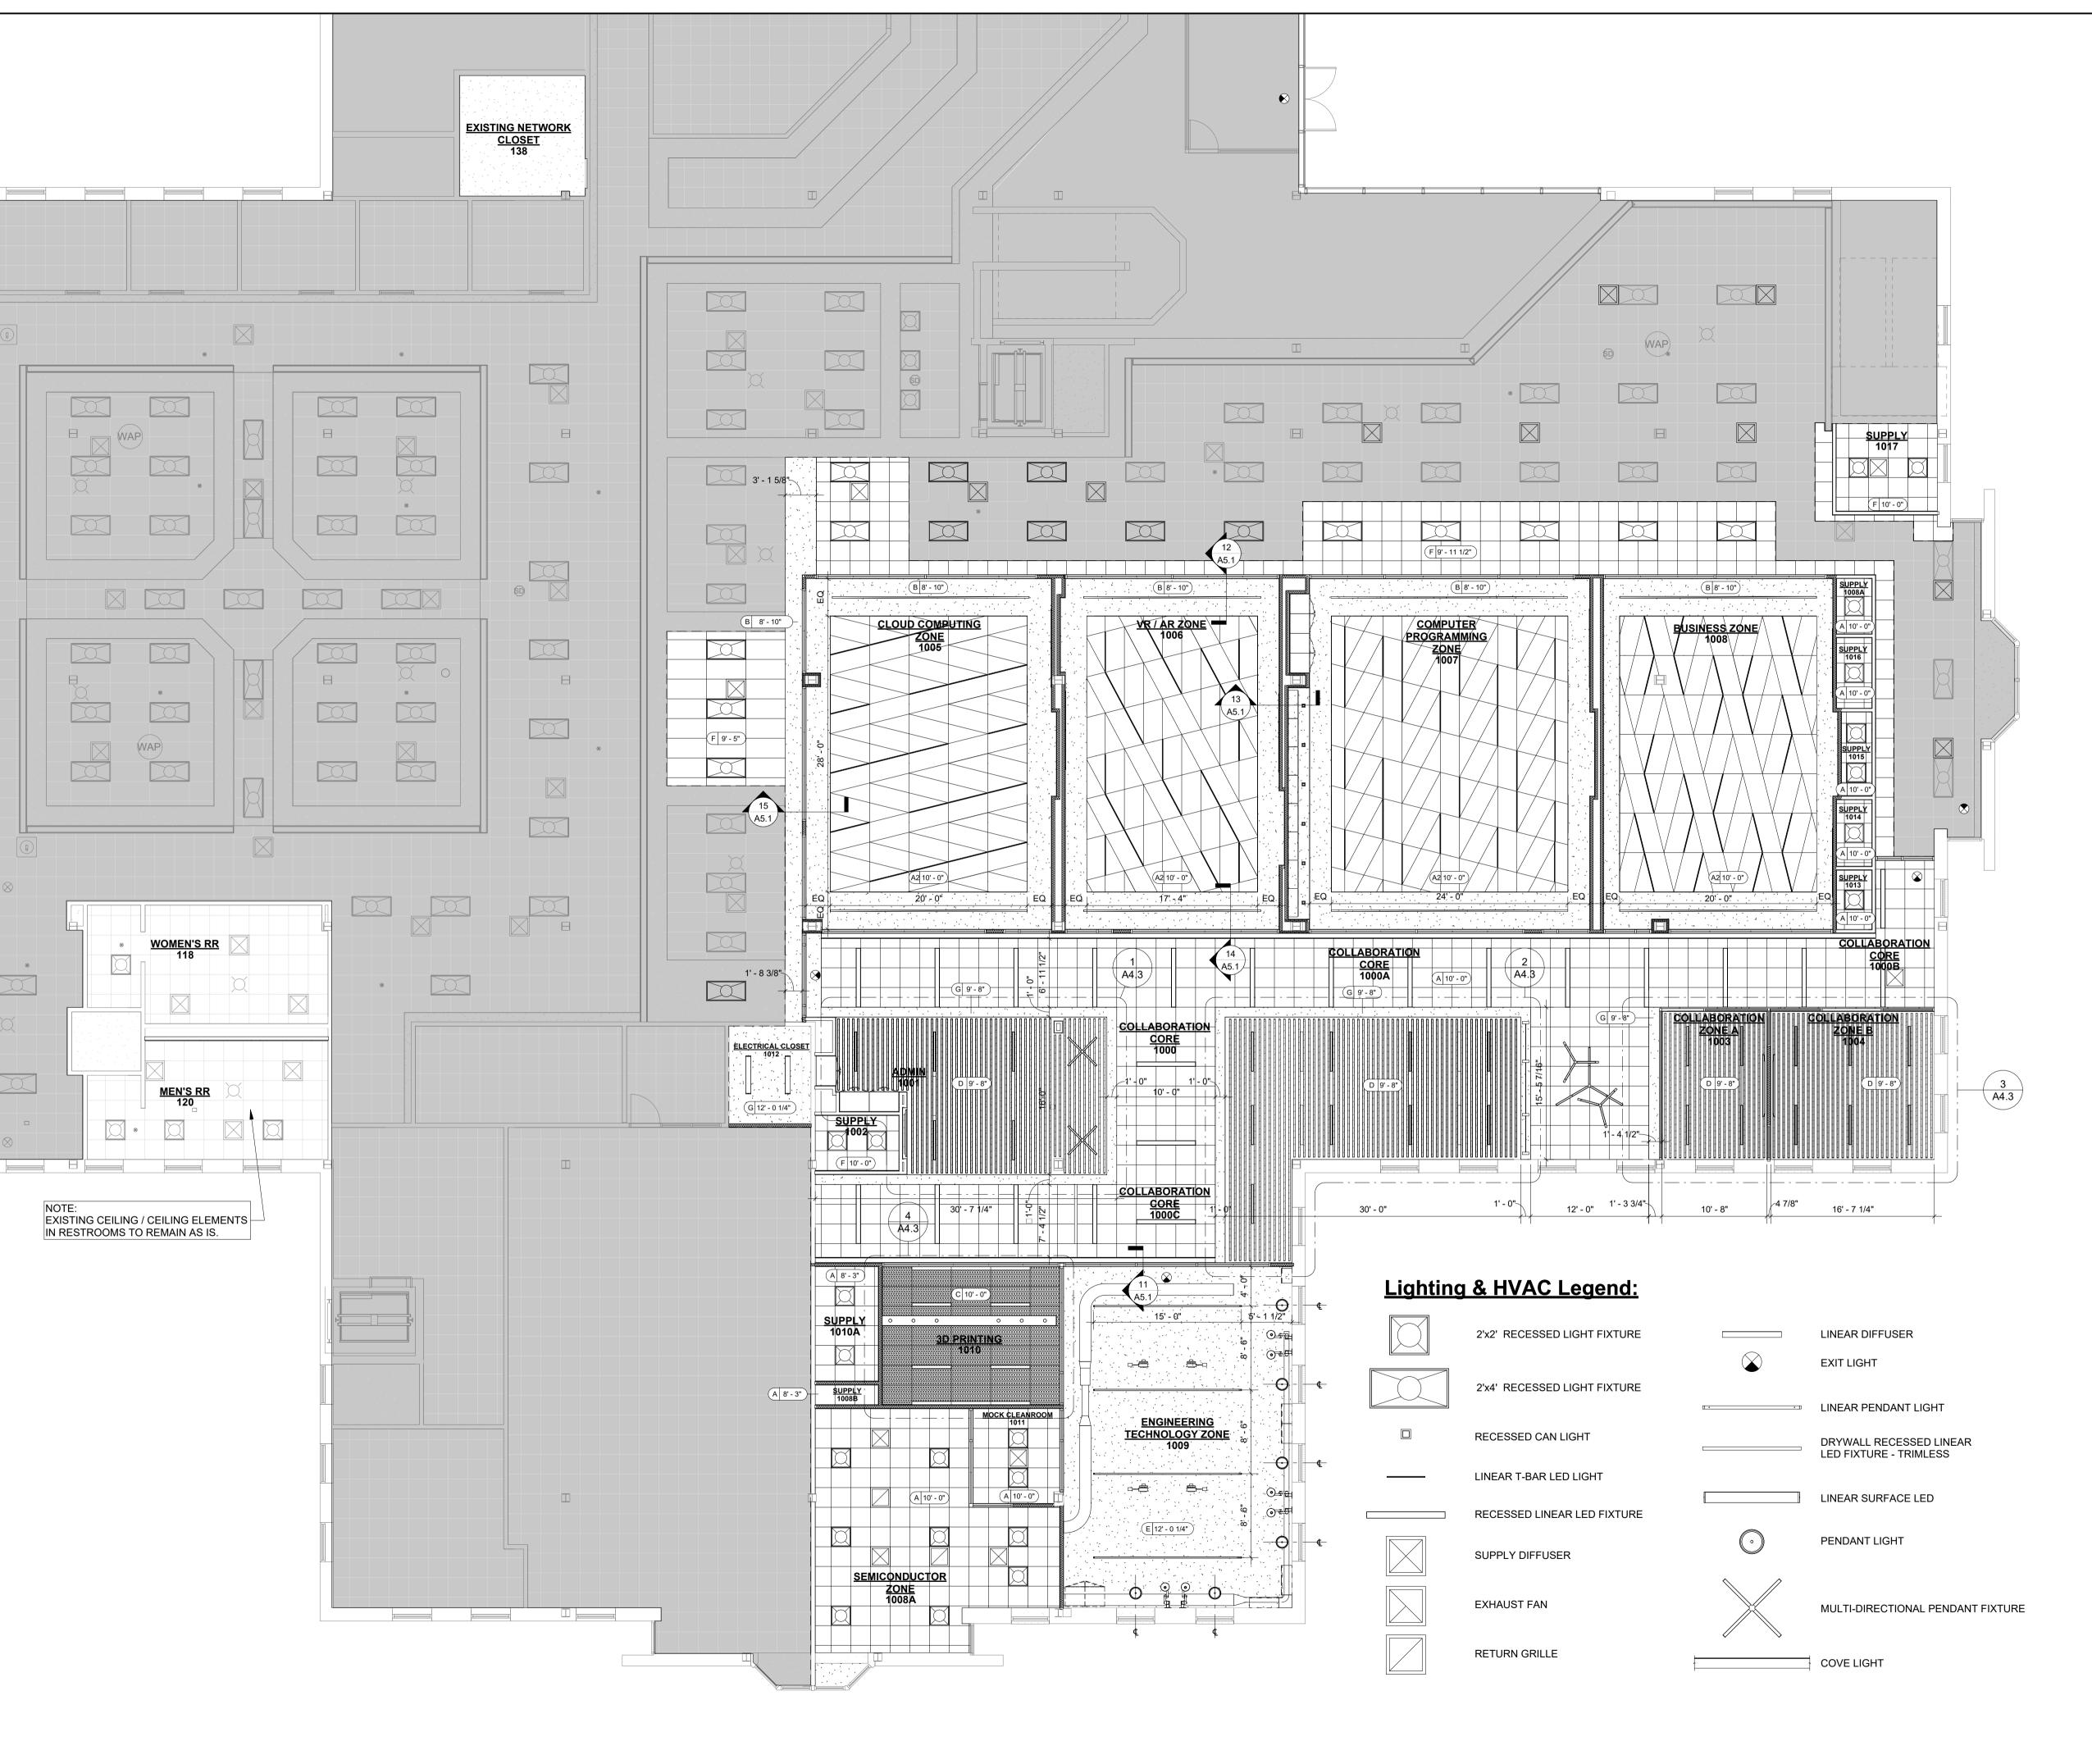
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DRAWING TITLE: Level 1 Floor Plan -

Makerspace

SHEET NO.: **A1.1**

DATE:



RCP General Notes:

1. COORDINATE WITH ELECTRICAL PLAN FOR LOCATION OF FIXTURES AND SWITCHING. ANY DISCREPANCIES DISCOVERED IN THE DRAWINGS SHALL BE BROUGHT TO THE ATTENTION OF THE ARCHITECT.

2. COORDINATE WITH MECHANICAL PLAN FOR LOCATION OF DUCTWORK AND DIFFUSERS. ANY DISCREPANCIES DISCOVERED IN THE DRAWINGS SHALL BE BROUGHT TO THE ATTENTION OF THE ARCHITECT.

3. BUILDING SYSTEMS, FIXTURES, AND DEVICES SHOWN ON THE REFLECTED CEILING PLANS AND INTERIOR ELEVATIONS, SUCH AS ALARM DEVICES, LIGHT FIXTURES, AIR DIFFUSERS, SPEAKERS, ETC. ARE SHOWN ON THE ARCHITECTURAL DRAWINGS TO SHOW LOCATION AND LAYOUT PATTERN. THE ARCHITECTURAL DRAWINGS DO NOT REPRESENT COMPLETE SYSTEMS THAT MAY BE REQUIRED BY OTHER CONTRACT DOCUMENTS.

4. LIGHT FIXTURES, ALARM DEVICES AND EXIT SIGNS MAY BE SHOWN ON THE ARCHITECTURAL REFLECTED CEILING PLANS FOR LAYOUT CLARITY ONLY. SEE INTERIOR ELEVATIONS FOR HEIGHTS AND PLACEMENT. SEE ELECTRICAL AND LIGHTING DRAWINGS FOR QUANTITIES AND OTHER REQUIREMENTS.

5. WHERE AN ITEM IS MOUNTED ON THE CEILING, DROPPED SOFFIT / CASED OPENING, ETC., IT SHALL BE CENTERED ON THE ELEMENT(CEILING TILE, GYPSUM BOARD BAND, ETC.) IN WHICH IT IS PLACED UNLESS OTHERWISE NOTED.

6. DIMENSIONS ARE TO THE CENTERLINE OF DEVICES, U.O.N.

7. CEILING DEVICES SHALL NOT BE LOCATED CLOSER THAN 12" TO ANY FINISHED VERTICAL WALL UNLESS OTHERWISE NOTED.

8. LIGHT FIXTURES, DUCTS, DEVICES SUSPENDED FROM STRUCTURE ABOVE, SPRINKLER HEADS, SPEAKERS, PIPING, ETC. AS LOCATED IN AREAS DESIGNATED TO BE OPEN TO STRUCTURE ABOVE SHALL PROVIDE A MINIMUM 9' - 0" CLEAR ABOVE FINISH FLOOR.

9. PROVIDE SUPPORT (BRACED AND ANCHORED) TO STRUCTURE ABOVE - INCLUDING MISCELLANEOUS STEEL METAL FRAMING, TREATED WOOD BLOCKING AS REQUIRED FOR MOUNTING OF DEVICES AND EQUIPMENT LOCATED WITHIN THE CEILING AND/OR CEILING PLENUM

10. DEVICES, CONDUITS, WIRING, ETC. SHALL NOT BE SUPPORTED FROM CEILING GRID, TILE, OR CEILING ATTACHMENTS.

11. LIGHT FIXTURES, LIFE SAFETY DEVICES, SPEAKERS, ETC. SHALL BE LOCATED AT THE CENTER OF CEILING TILES - IN WHICH THEY OCCUR -IN BOTH DIRECTIONS UNLESS OTHERWISE NOTED.

12. MEANS OF ACCESS SHALL BE PROVIDED AT SPECIFIC, APPROVED LOCATIONS IN CEILING SYSTEMS TO ALLOW FOR MAINTENANCE OF EQUIPMENT LOCATED WITHIN OR ABOVE THE CEILING.

Ceiling Finish Legend:

-CEILING HEIGHT -CEILING FINISH

A - ACOUSTICAL CEILING TILE A2 - DESIGN FLEX ACOUSTICAL CEILING TILE

B - GYPSUM BOARD CEILING

C - PERFORATED METAL CEILING

D - SUSPENDED ALUMINUM BEAMS E - 5/8 TYPE-X GYPSUM BOARD CEILING

FOR 1 HOUR RATED ASSEMBLY F - SALVAGED CEILING TILE

G - EXISTING GYPSUM BOARD CEILING

Reflected Ceiling Plan Legend:

EXISTING WALL TO REMAIN

EXISTING ELEMENT TO REMAIN

NEW WALL

NEW ELEMENT


OPEN CELL "EGGCRATE" CEILING

AREA NOT IN SCOPE


24" x 24" ACOUSTIC CEILING TILE

24" x 48" ACOUSTIC CEILING TILE

24" x 48" DESIGN FLEX ACOUSTIC CEILING TILE

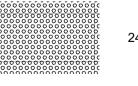

24" x 60" PERFORATED METAL CEILING TILE

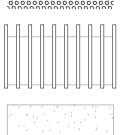

SUSPENDED ALUMINUM BEAMS HUNG ON 15/16" GRID WITH 24" x 24" ACOUSTIC CEILING TILE



GYPSUM BOARD CEILING

RETRACTABLE CABLE REEL



1621 Physicians Dr.
Tallahassee, Florida 32308
(P) 850.778.8007 | (F) 850.546.6150
www.bkjarchitecture.com
FL Architecture Corporation AA26002280

SEAL:

PROJECT TITLE:

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5 JOB NO.: 24.103 DESIGNED: ML/SC

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ONS:				
REVISIONS:				

DRAWING PHASE: 100% Construction **Documents**

DRAWING TITLE:

Level 1 Reflected Ceiling Plan


SHEET NO.:

A1.2

DATE:

February 7, 2025

1 Level 1 - Reflected Ceiling Plan - New 1/8" = 1'-0"

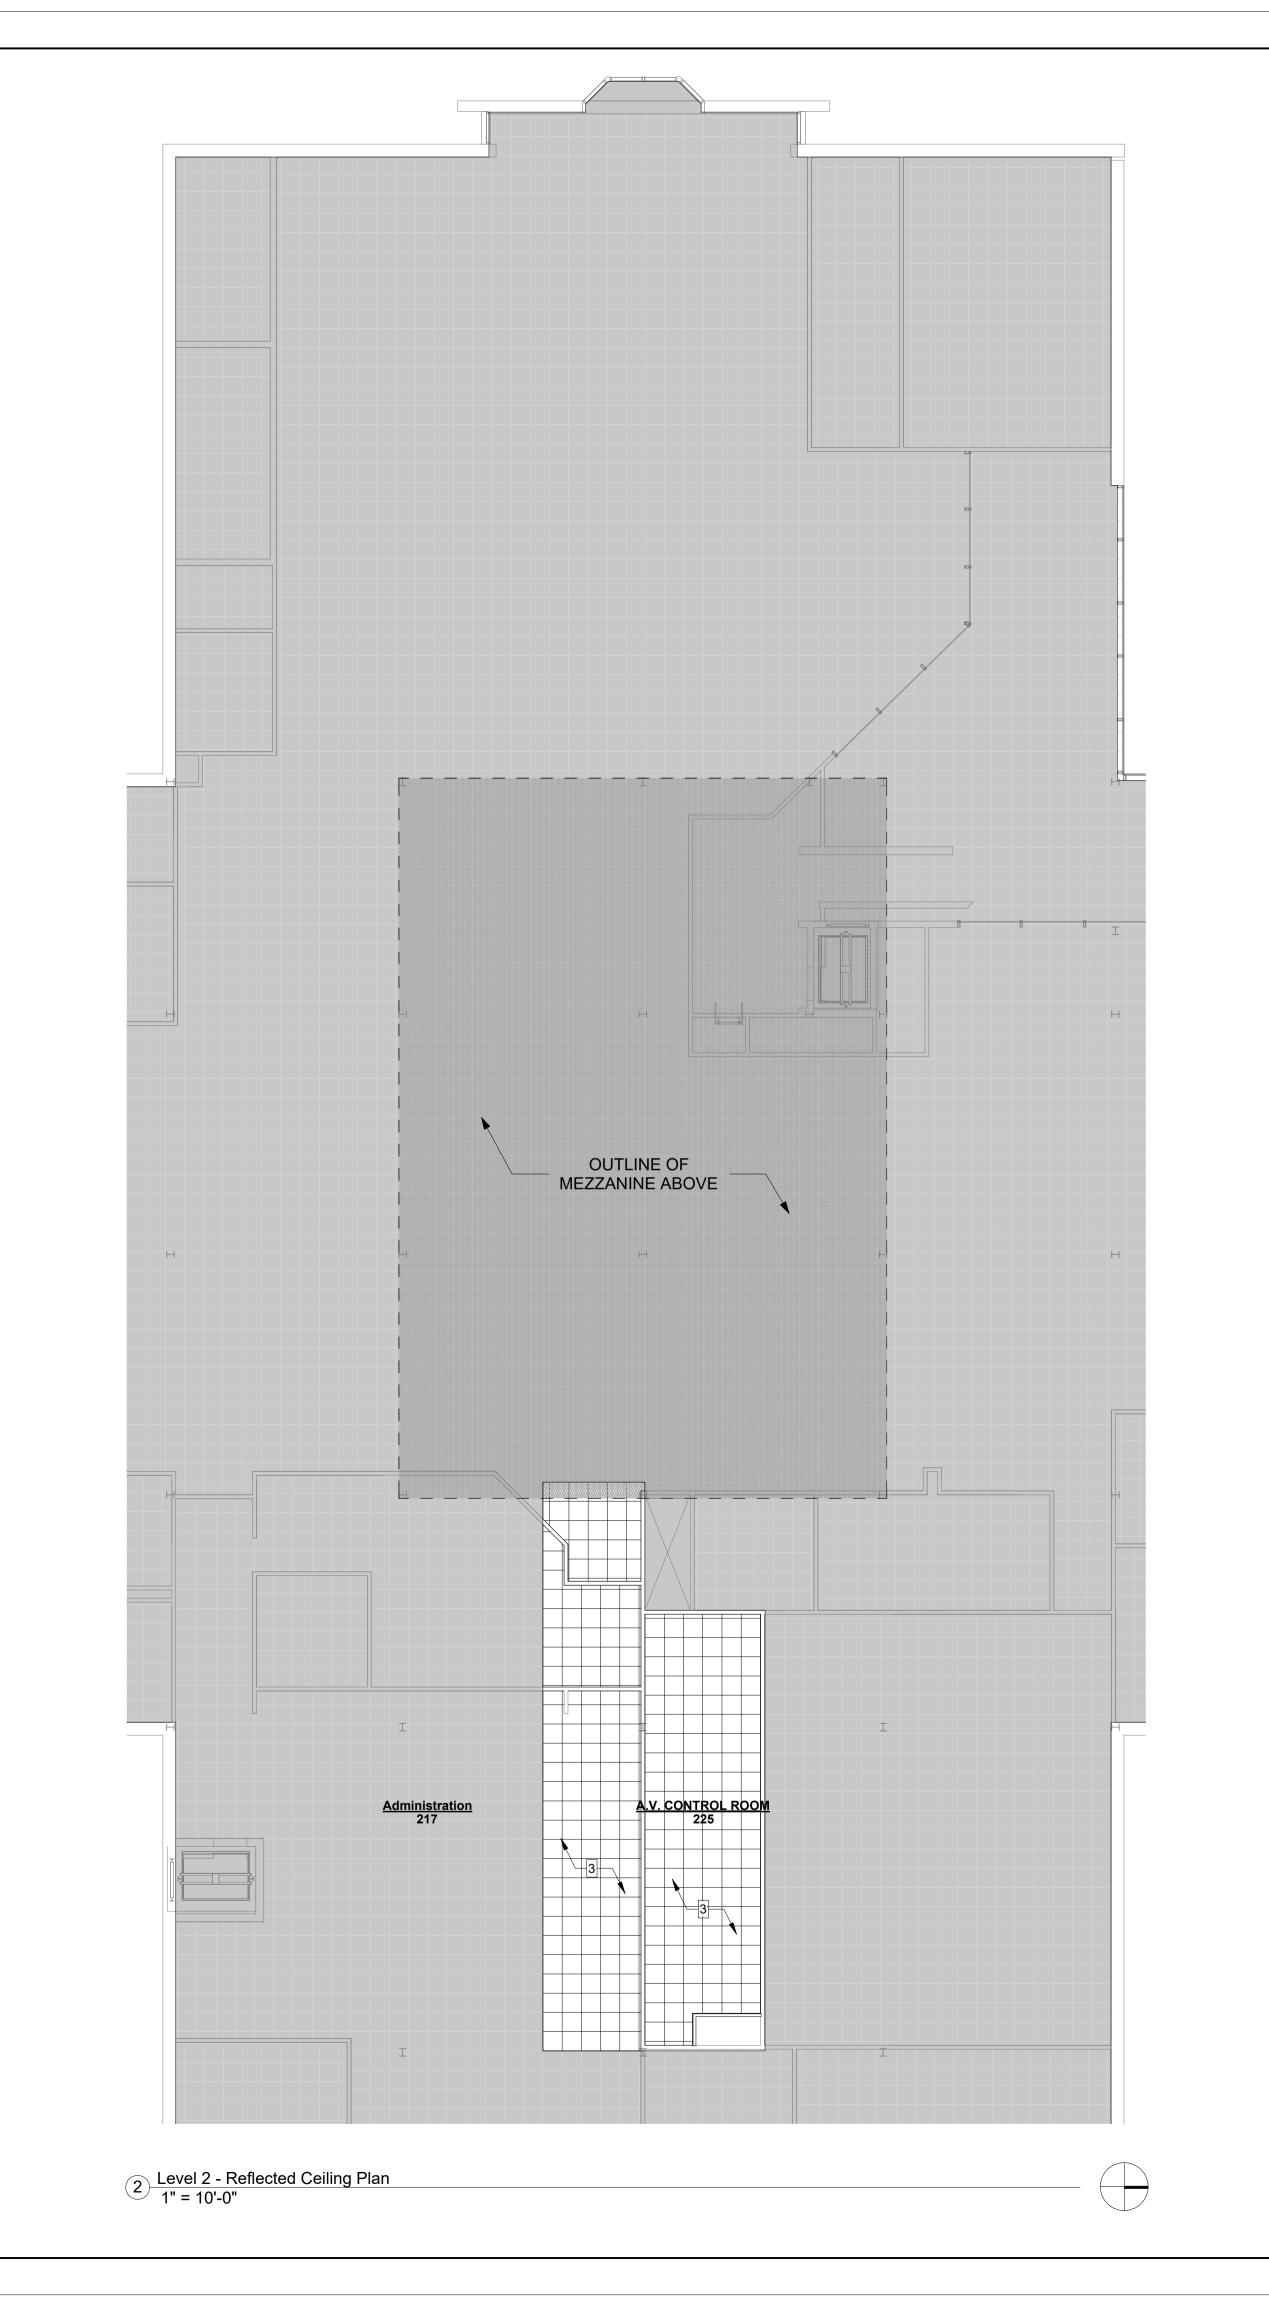

A.V. CONTROL ROOM 225

1 Level 2 - Floor Plan 1/4" = 1'-0"


Level 2 General Notes:

1. ALL DIMENSIONS FOR NEW PARTITIONS ARE TO FACE OF STUD. DIMENSIONS TO EXISTING WALLS ARE TO FACE OF FINISH SURFACE.

2. ANY PENETRATIONS THROUGH AN EXISTING FIRE RATED ASSEMBLY, EITHER PRIOR TO CONSTRUCTION ACTIVITIES, OR AS A RESULT OF CONSTRUCTION SHALL BE SEALED WITH APPROPRIATE U.L. RATED ASSEMBLY.

3. THE DESIGN AND CONSTRUCTION OF ALL NON-LOAD BEARING INTERIOR LIGHT GAUGE METAL FRAMING SHALL BE THE RESPONSIBILITY OF THE CONTRACTOR. AT A MINIMUM, THIS FRAMING SHALL BE CONSTRUCTED OF 20 GAUGE (30 MIL – 33 KSI) OR 20 GAUGE EQ (18 MIL – 70 KSI) METAL STUDS AND TRACK, STUDS SHALL HAVE MAXIMUM SPACING OF 16" O.C., WITH DOUBLE STUDS AT DOOR AND WINDOW JAMBS. PROVIDE A MINIMUM OF TWO #10 SELF TAPPING SCREWS AT ALL CONNECTIONS.

Floor Plan Legend:

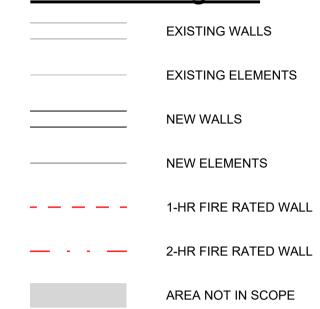


Level 2 Keynotes:


- PROVIDE NEW WALL TO ACCOMMODATE NEW HVAC CHASE. LOCATION OF WALL TO BE DETERMINED BASED ON FINAL FLOOR SLAB DEMOLITION COORDINATE WITH MECH. DRAWINGS.
- PROVIDE INTUMESCENT PAINT AS SPECIFIED ON ALL EXPOSED BAR JOISTS THAT REMAIN IN NEW HVAC CHASE.
- REINSTALL CEILING GRID, TILES AND ASSOCIATED ELEMENTS WHERE REMOVED DURING DEMOLITION PHASE COORDINATE WITH MECHANICAL AND ELECTRICAL DRAWINGS.

INTUMESCENT PAINT
BASIS OF DESIGN:
FLAMEOFF - FIRE BARRIER PAINT
COLOR: TBD

MANUFACTURER: FLAMEOFF WWW.FLAMEOFFCOATINGS.COM INFO@FLAMEOFFCOATINGS.COM 1-888-518-9849

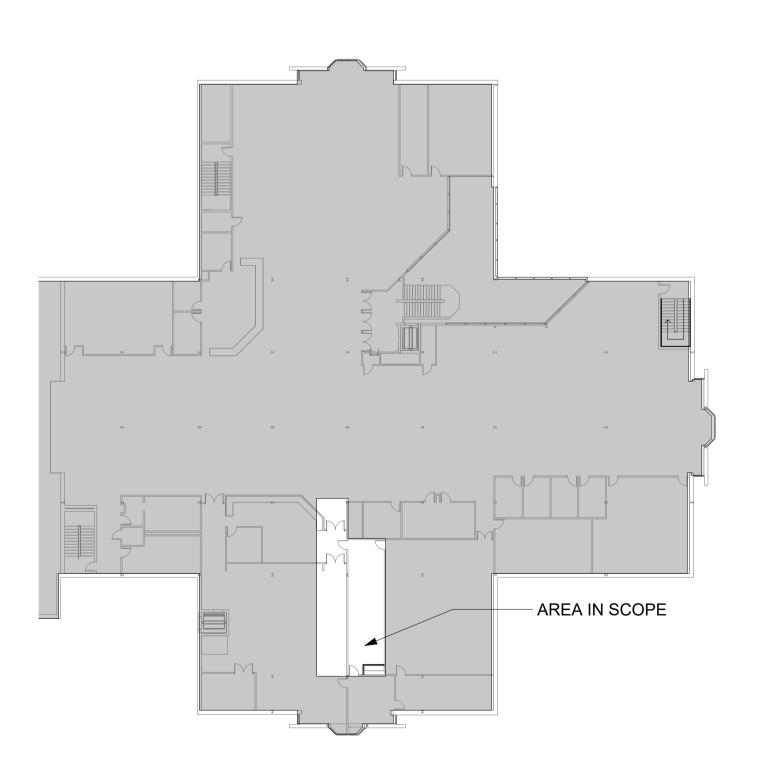

3 Area in Scope

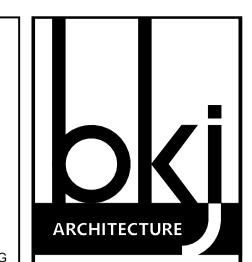

BKJ, Inc., Architecture 1621 Physicians Dr. Tallahassee, Florida 32308 (P) 850.778.8007 | (F) 850.546.6150 www.bkjarchitecture.com FL Architecture Corporation AA26002280

SEAL:

PROJECT TITLE:

nents oor

SC Library - 1st Floo 444 Appleyard Drive, Tallahassee, FL 32304

Makersp

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DF	RAV	۷N	: JF	₹							
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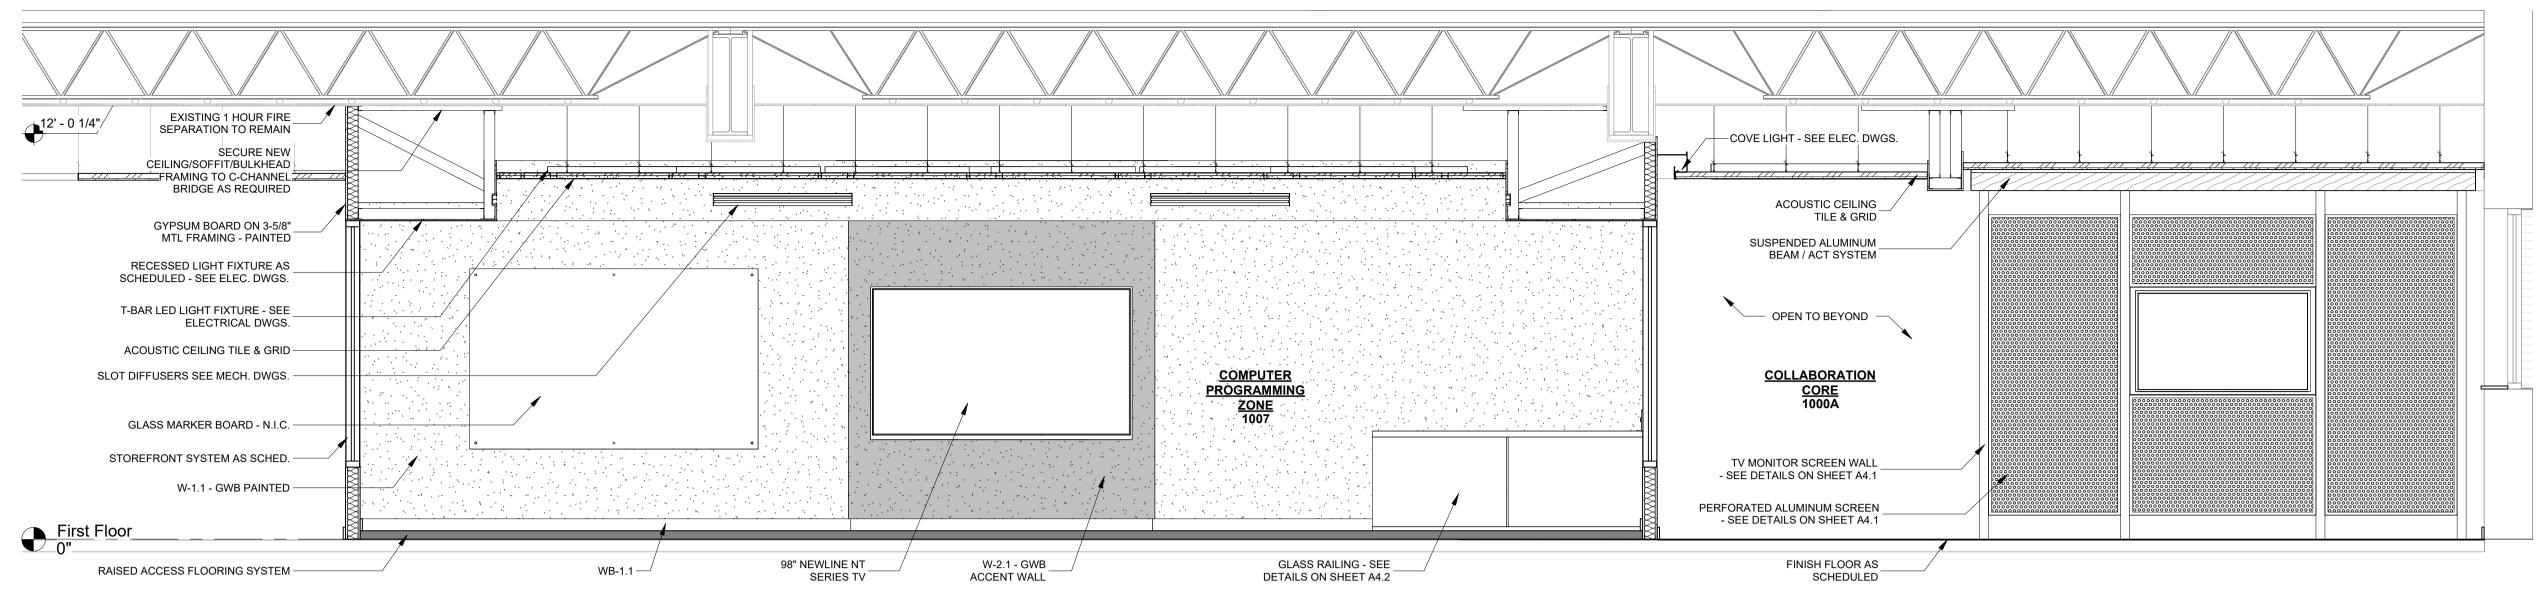
DRAWING TITLE:

Level 2 Floor Plan & RCP


SHEET NO.:

A1.3


DATE:



Section - Computer Programming Zone and Collaboration Core 3/8" = 1'-0"

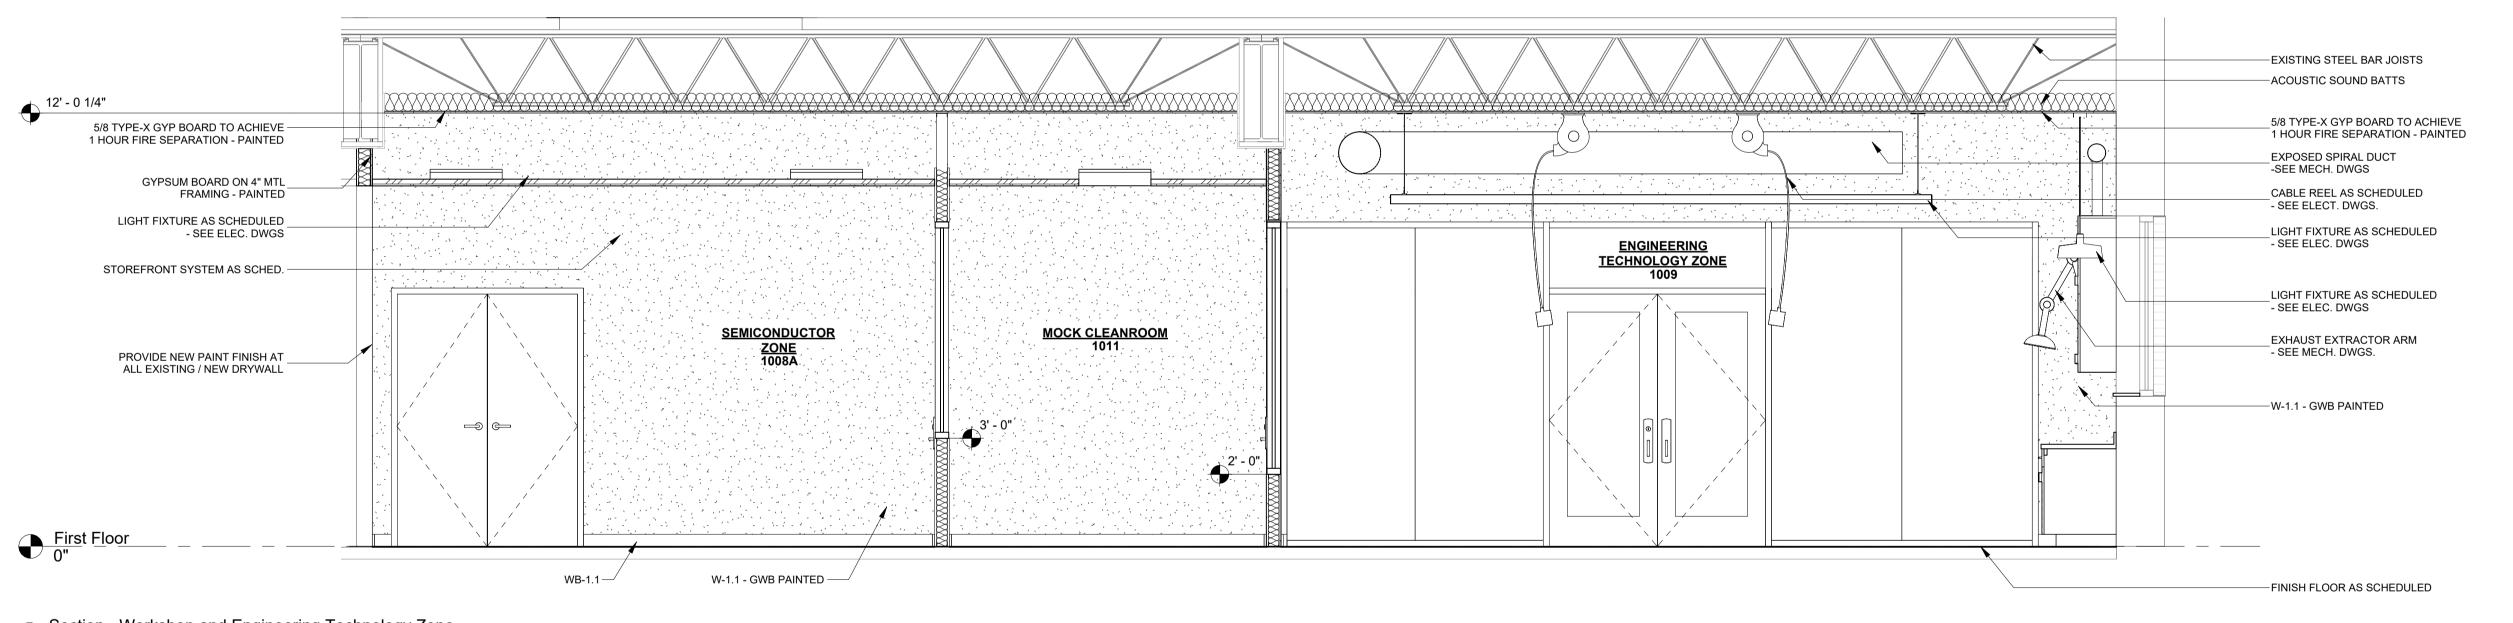

Section - Workshop and Engineering Technology Zone
3/8" = 1'-0"

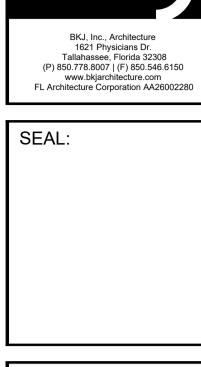

Ements Eloor Floor (%)

Makerspace Improvements
TSC Library - 1st Floor
444 Appleyard Drive,
Tallahassee, FL 32304

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Documents


DRAWING TITLE:

Building Sections

SHEET NO.:

A3.0

DATE:

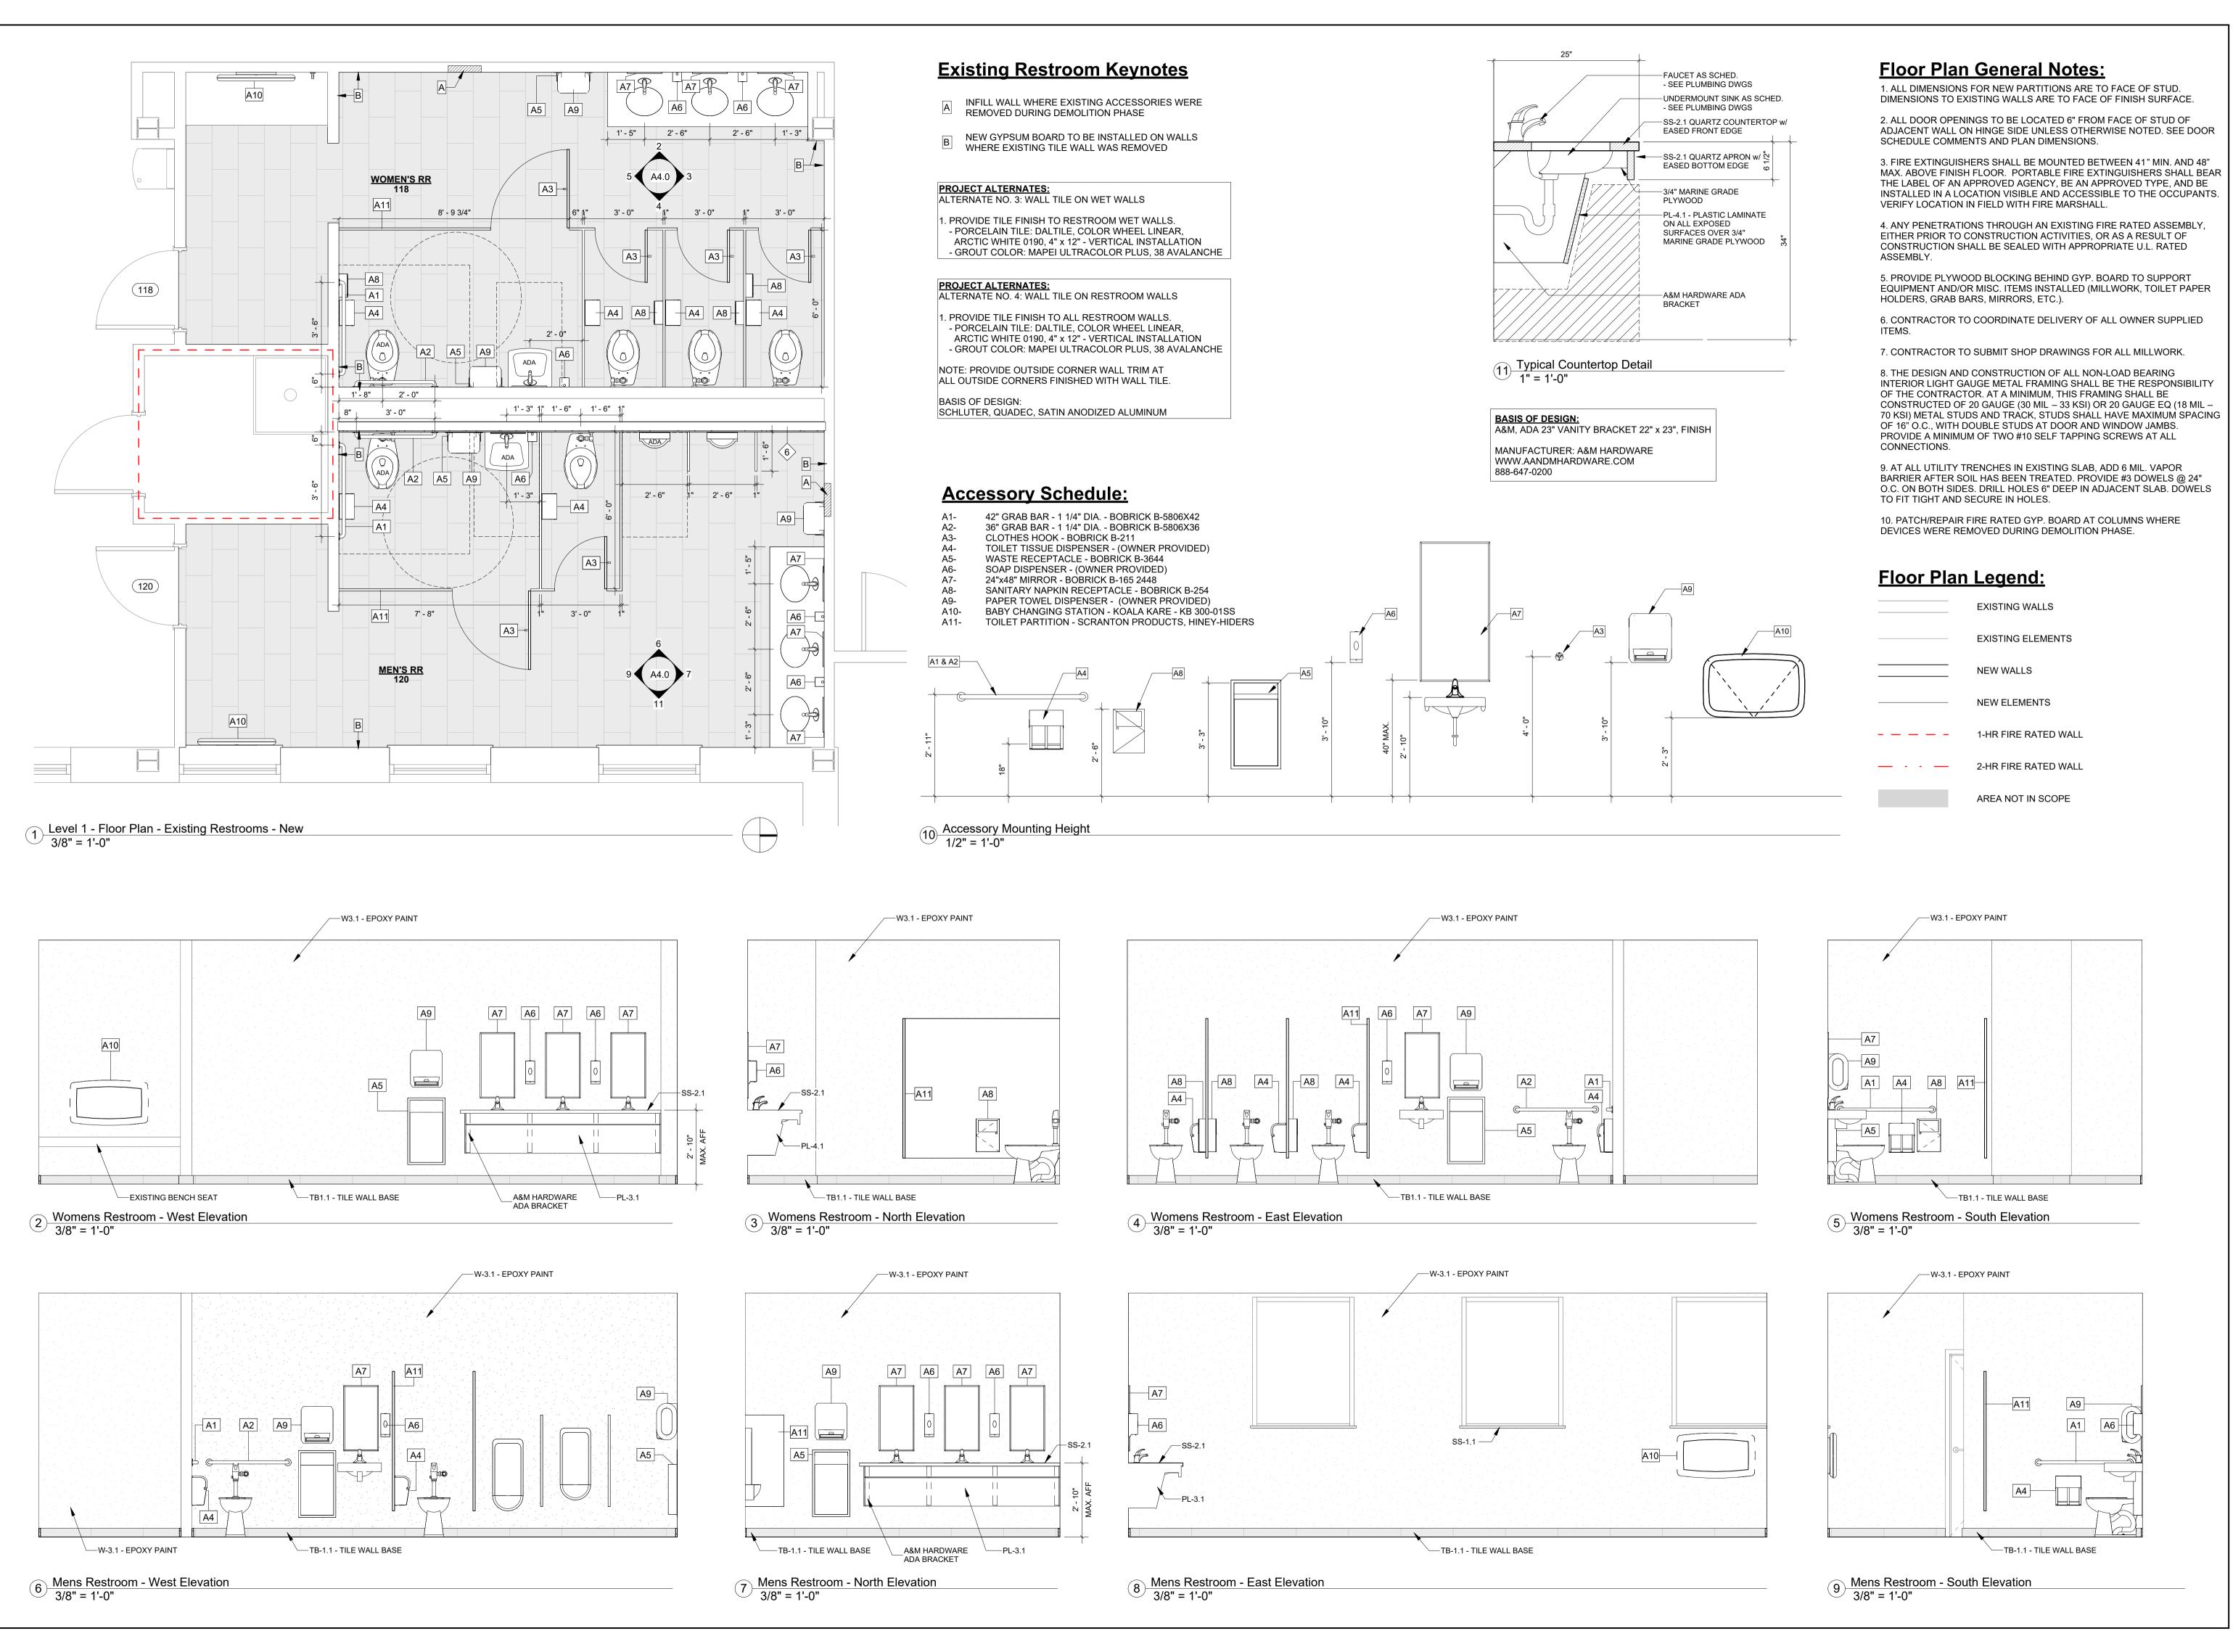

ARCHITECTURE

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JOB NO.: 24.103 DESIGNED: ML/SC

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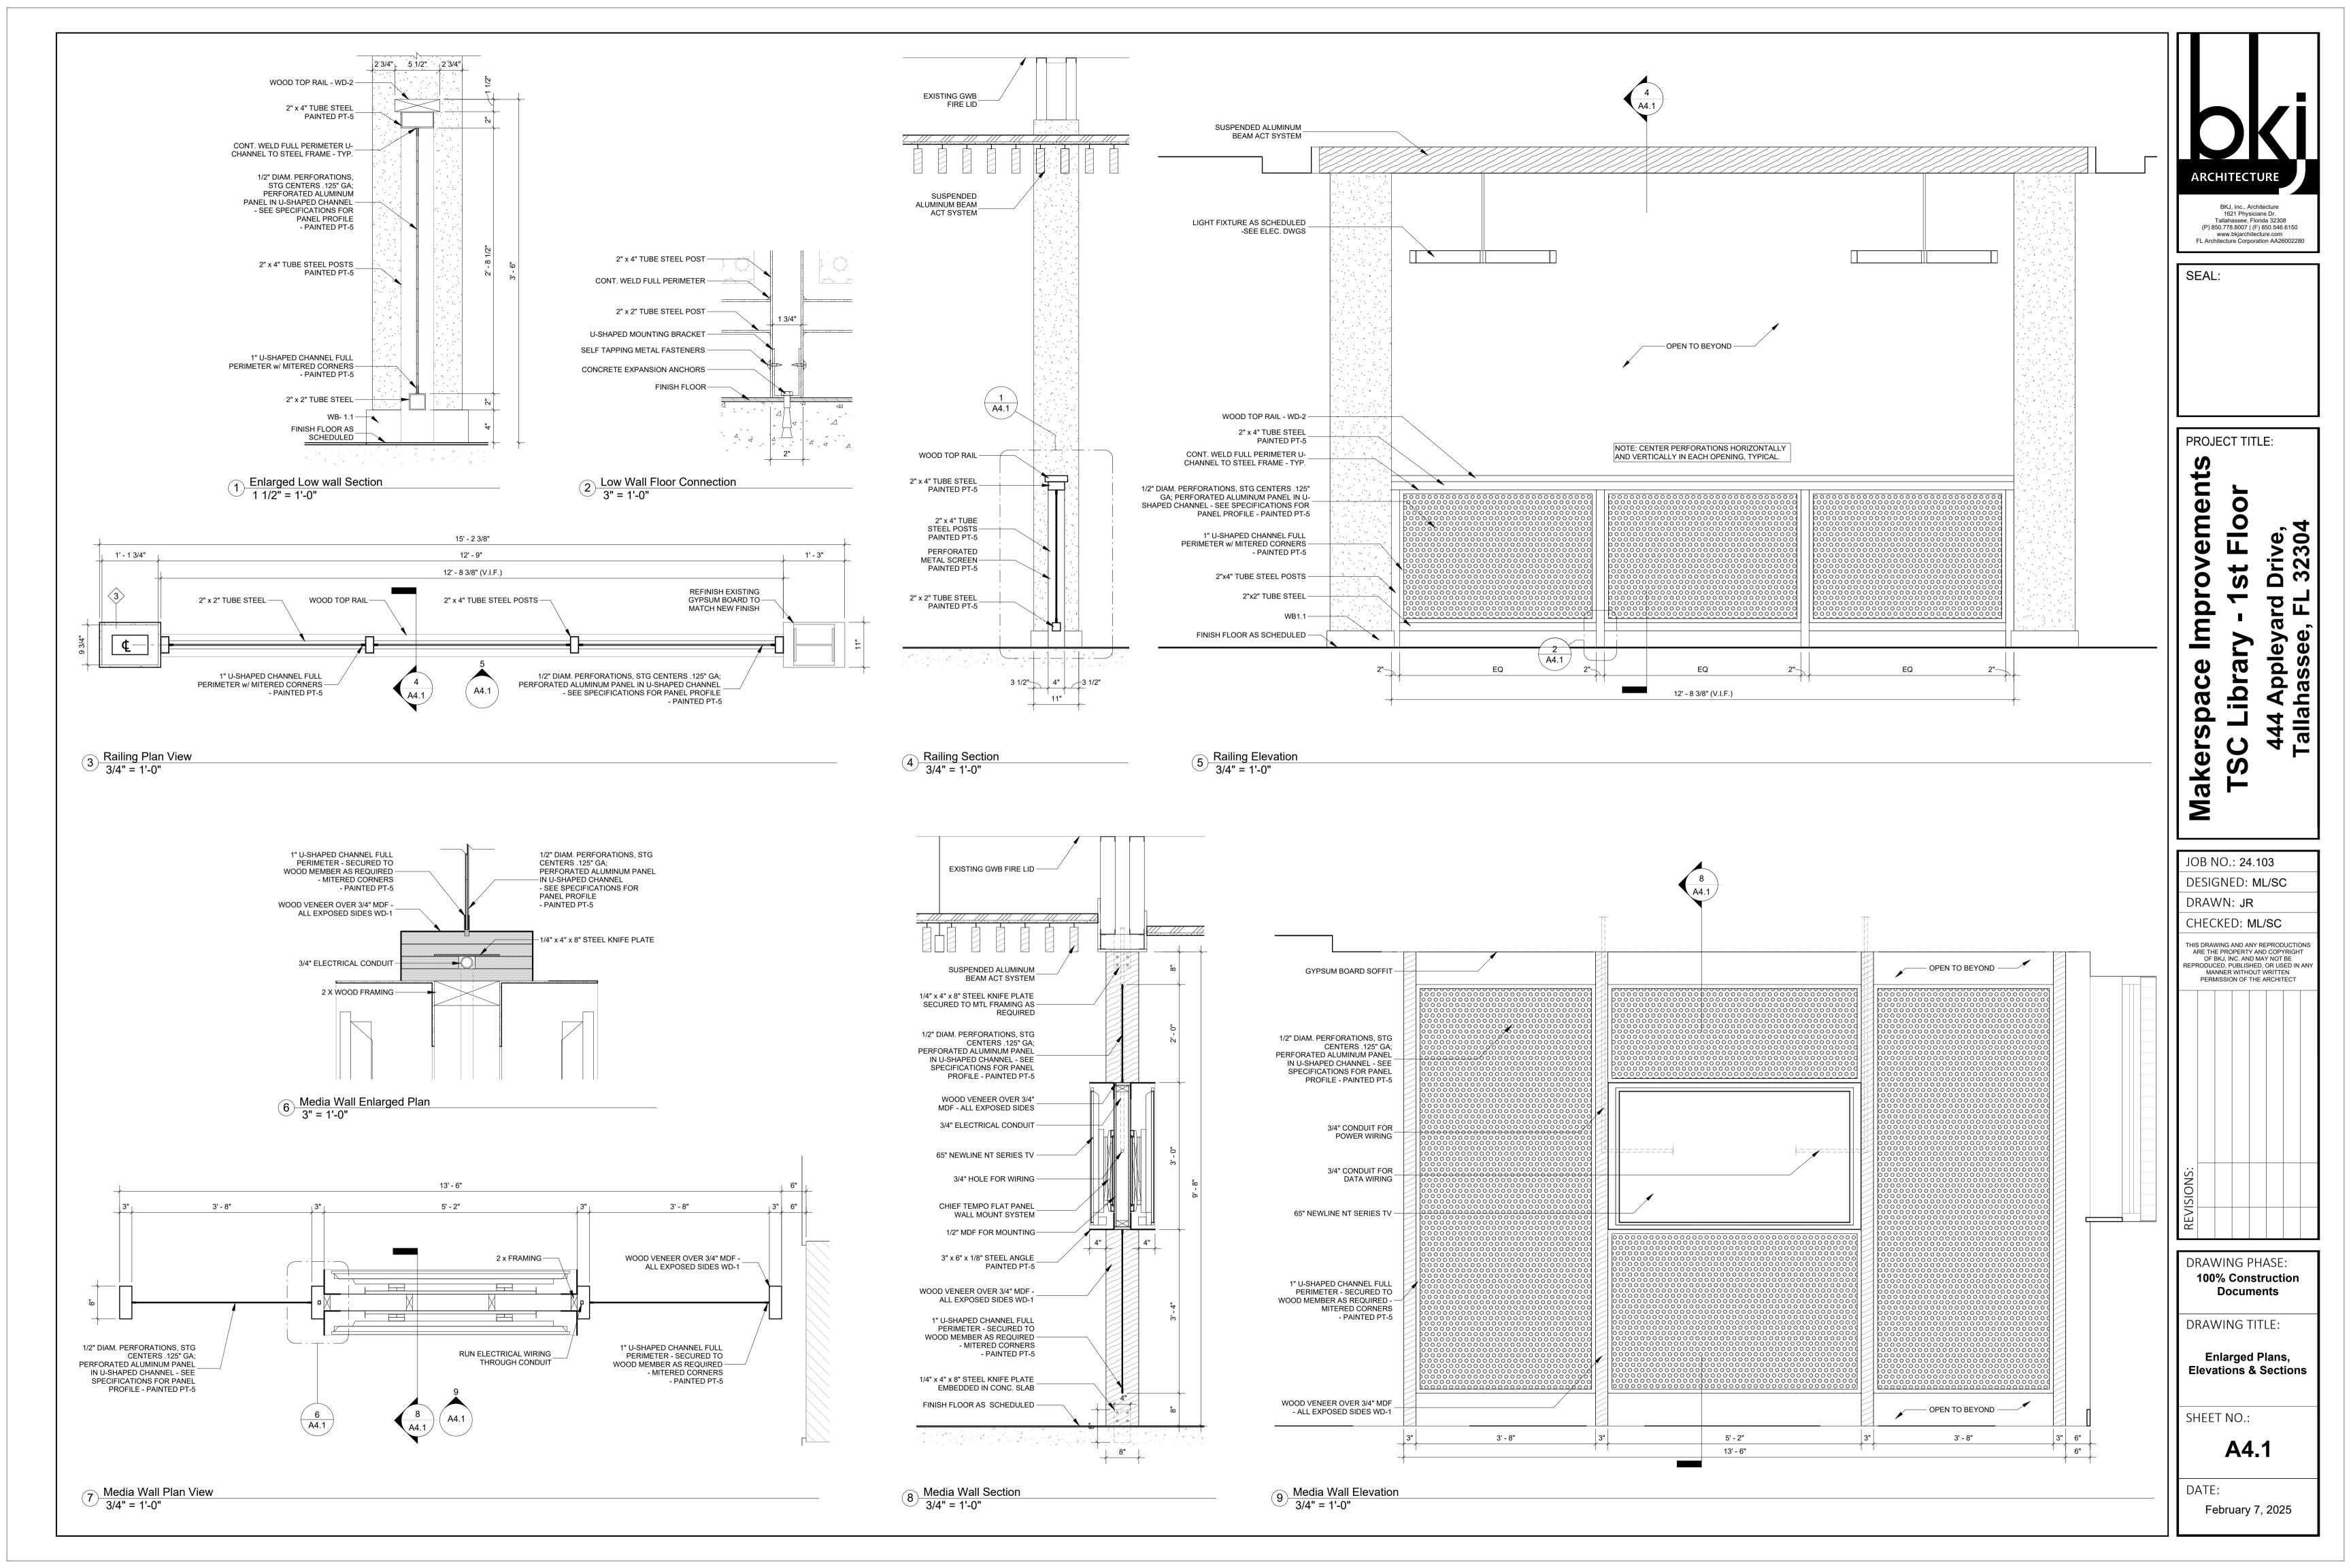
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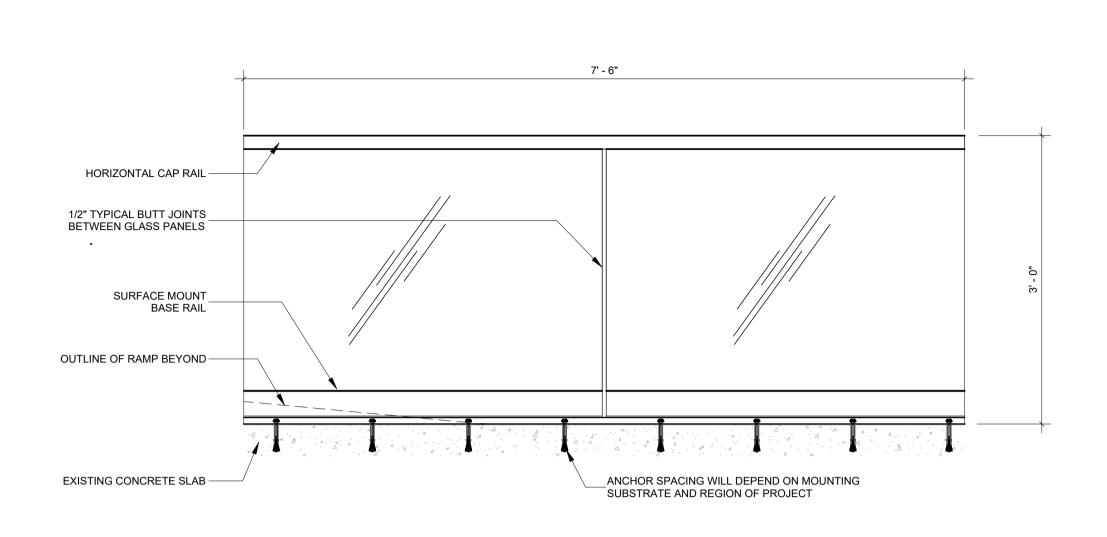
Restrooms - Enlarged Plan & Elevations

SHEET NO.:

A4.0

DATE:





3 A4.2 -HORIZONTAL CAP RAIL __1/2" THICK TEMPERED MONOLITHIC GLASS _CRL SURFACE MOUNT BASE SHOE

2 11/16" __1/2" THICK TEMPERED MONOLITHIC GLASS RAISED ACCESS FLOORING -ALUMINUM BASE RAIL EXPANSION ANCHOR BOLT —EXISTING 4" SLAB

2 Glass Railing Base Rail Section 6" = 1'-0"

___ALUMINUM CAP RAIL __1/2" THICK TEMPERED MONOLITHIC GLASS

GLASS RAILING BASIS OF DESIGN:

MANUFACTURER: CRL WWW.CRLAURENCE.COM

FINISH: MILL

1-800-421-6144


BASE RAIL: MODEL: 8B10D, CRL 8B SERIES ALUMINUM FOR 1/2" GLASS


CAP RAIL: MODEL: GRS20M, CRL 2" SQUARE FOR 1/2" GLASS FINISH: MILL


3 Glass Railing Cap Rail Section 6" = 1'-0"

1 Glass Railing Elevation & Section 1" = 1'-0"

4 3D Printer Shelf Elevation 3/4" = 1'-0"

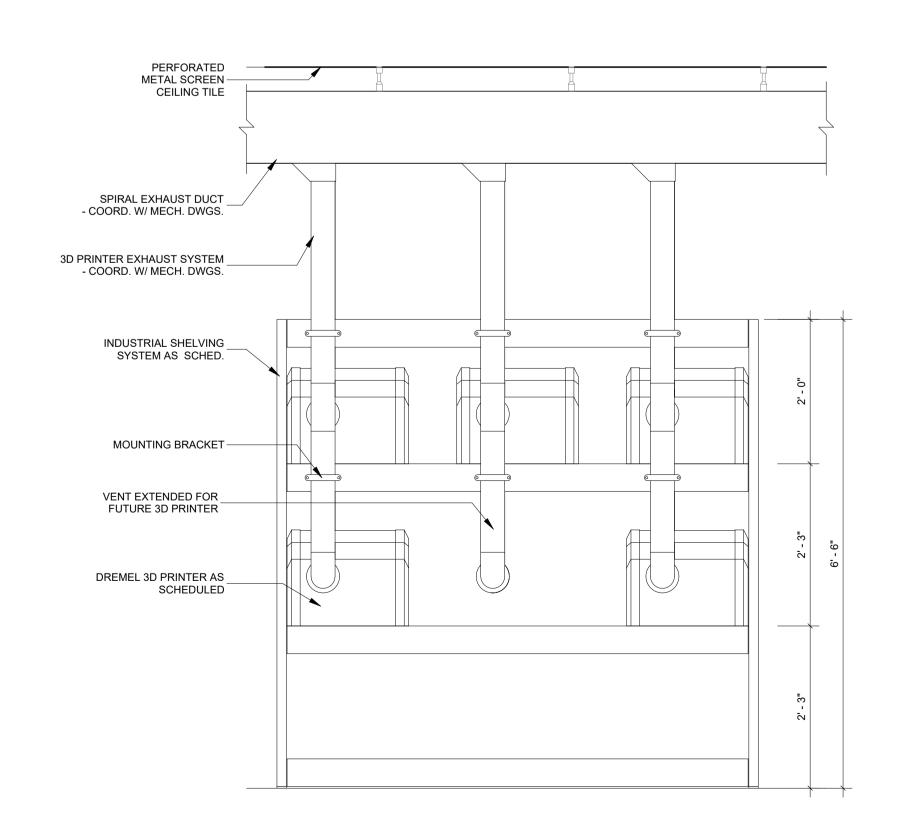

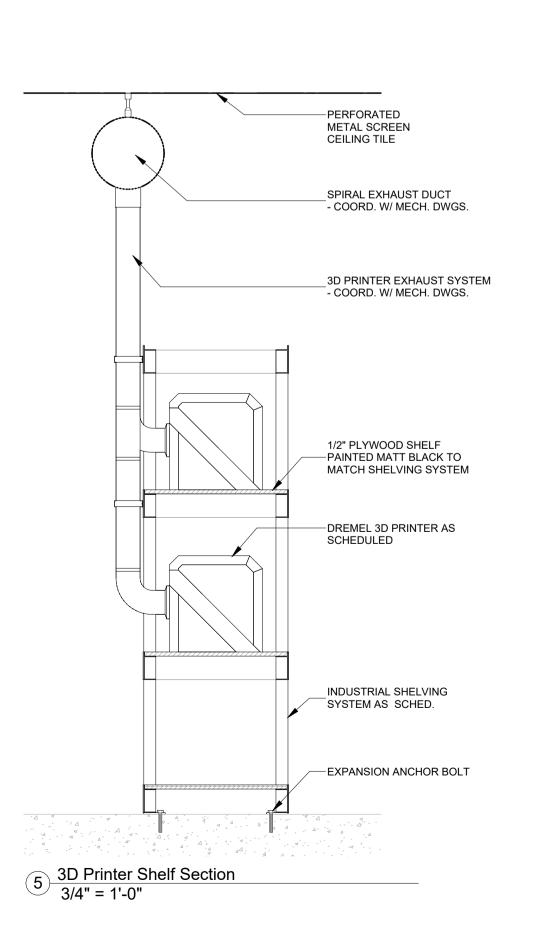

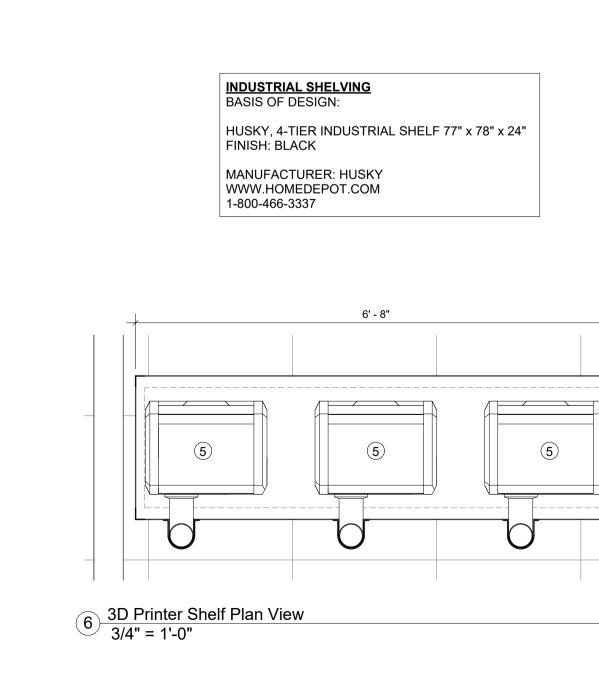

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SEAL:

PROJECT TITLE: Improvements 0 st Flo

Drive, . 32304 ard , FL 444 Appleya Tallahassee, **Makerspace**

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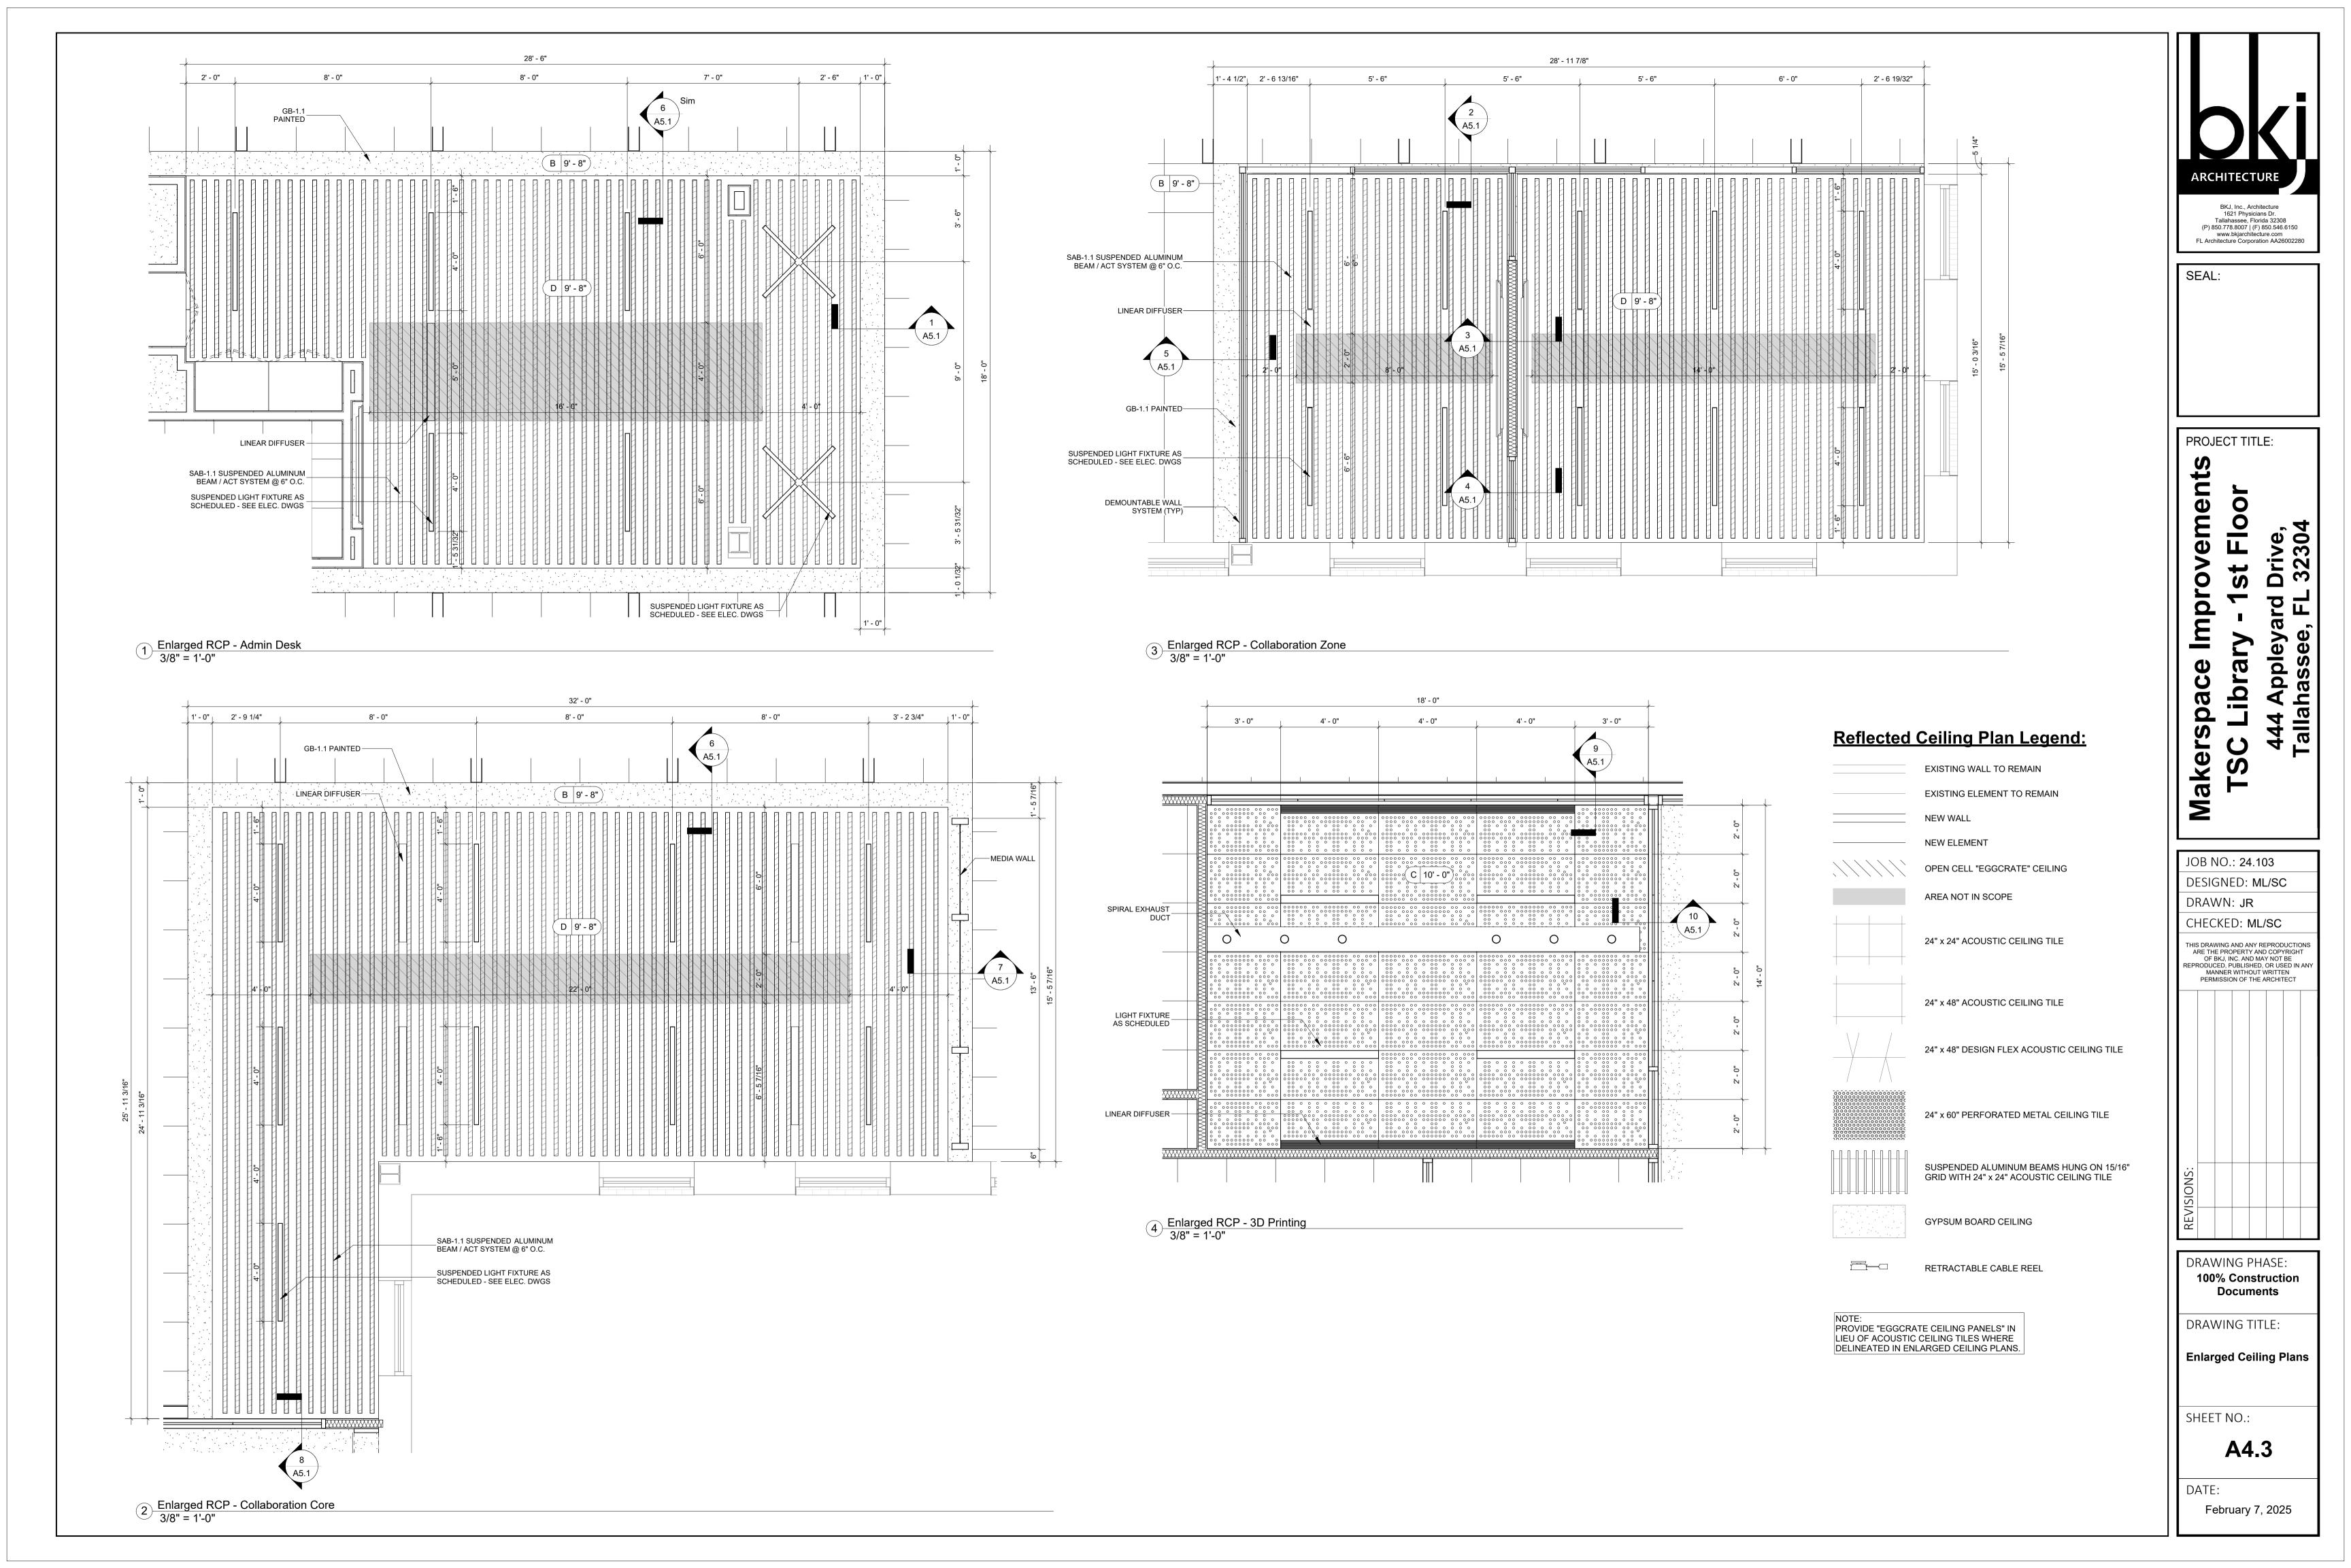
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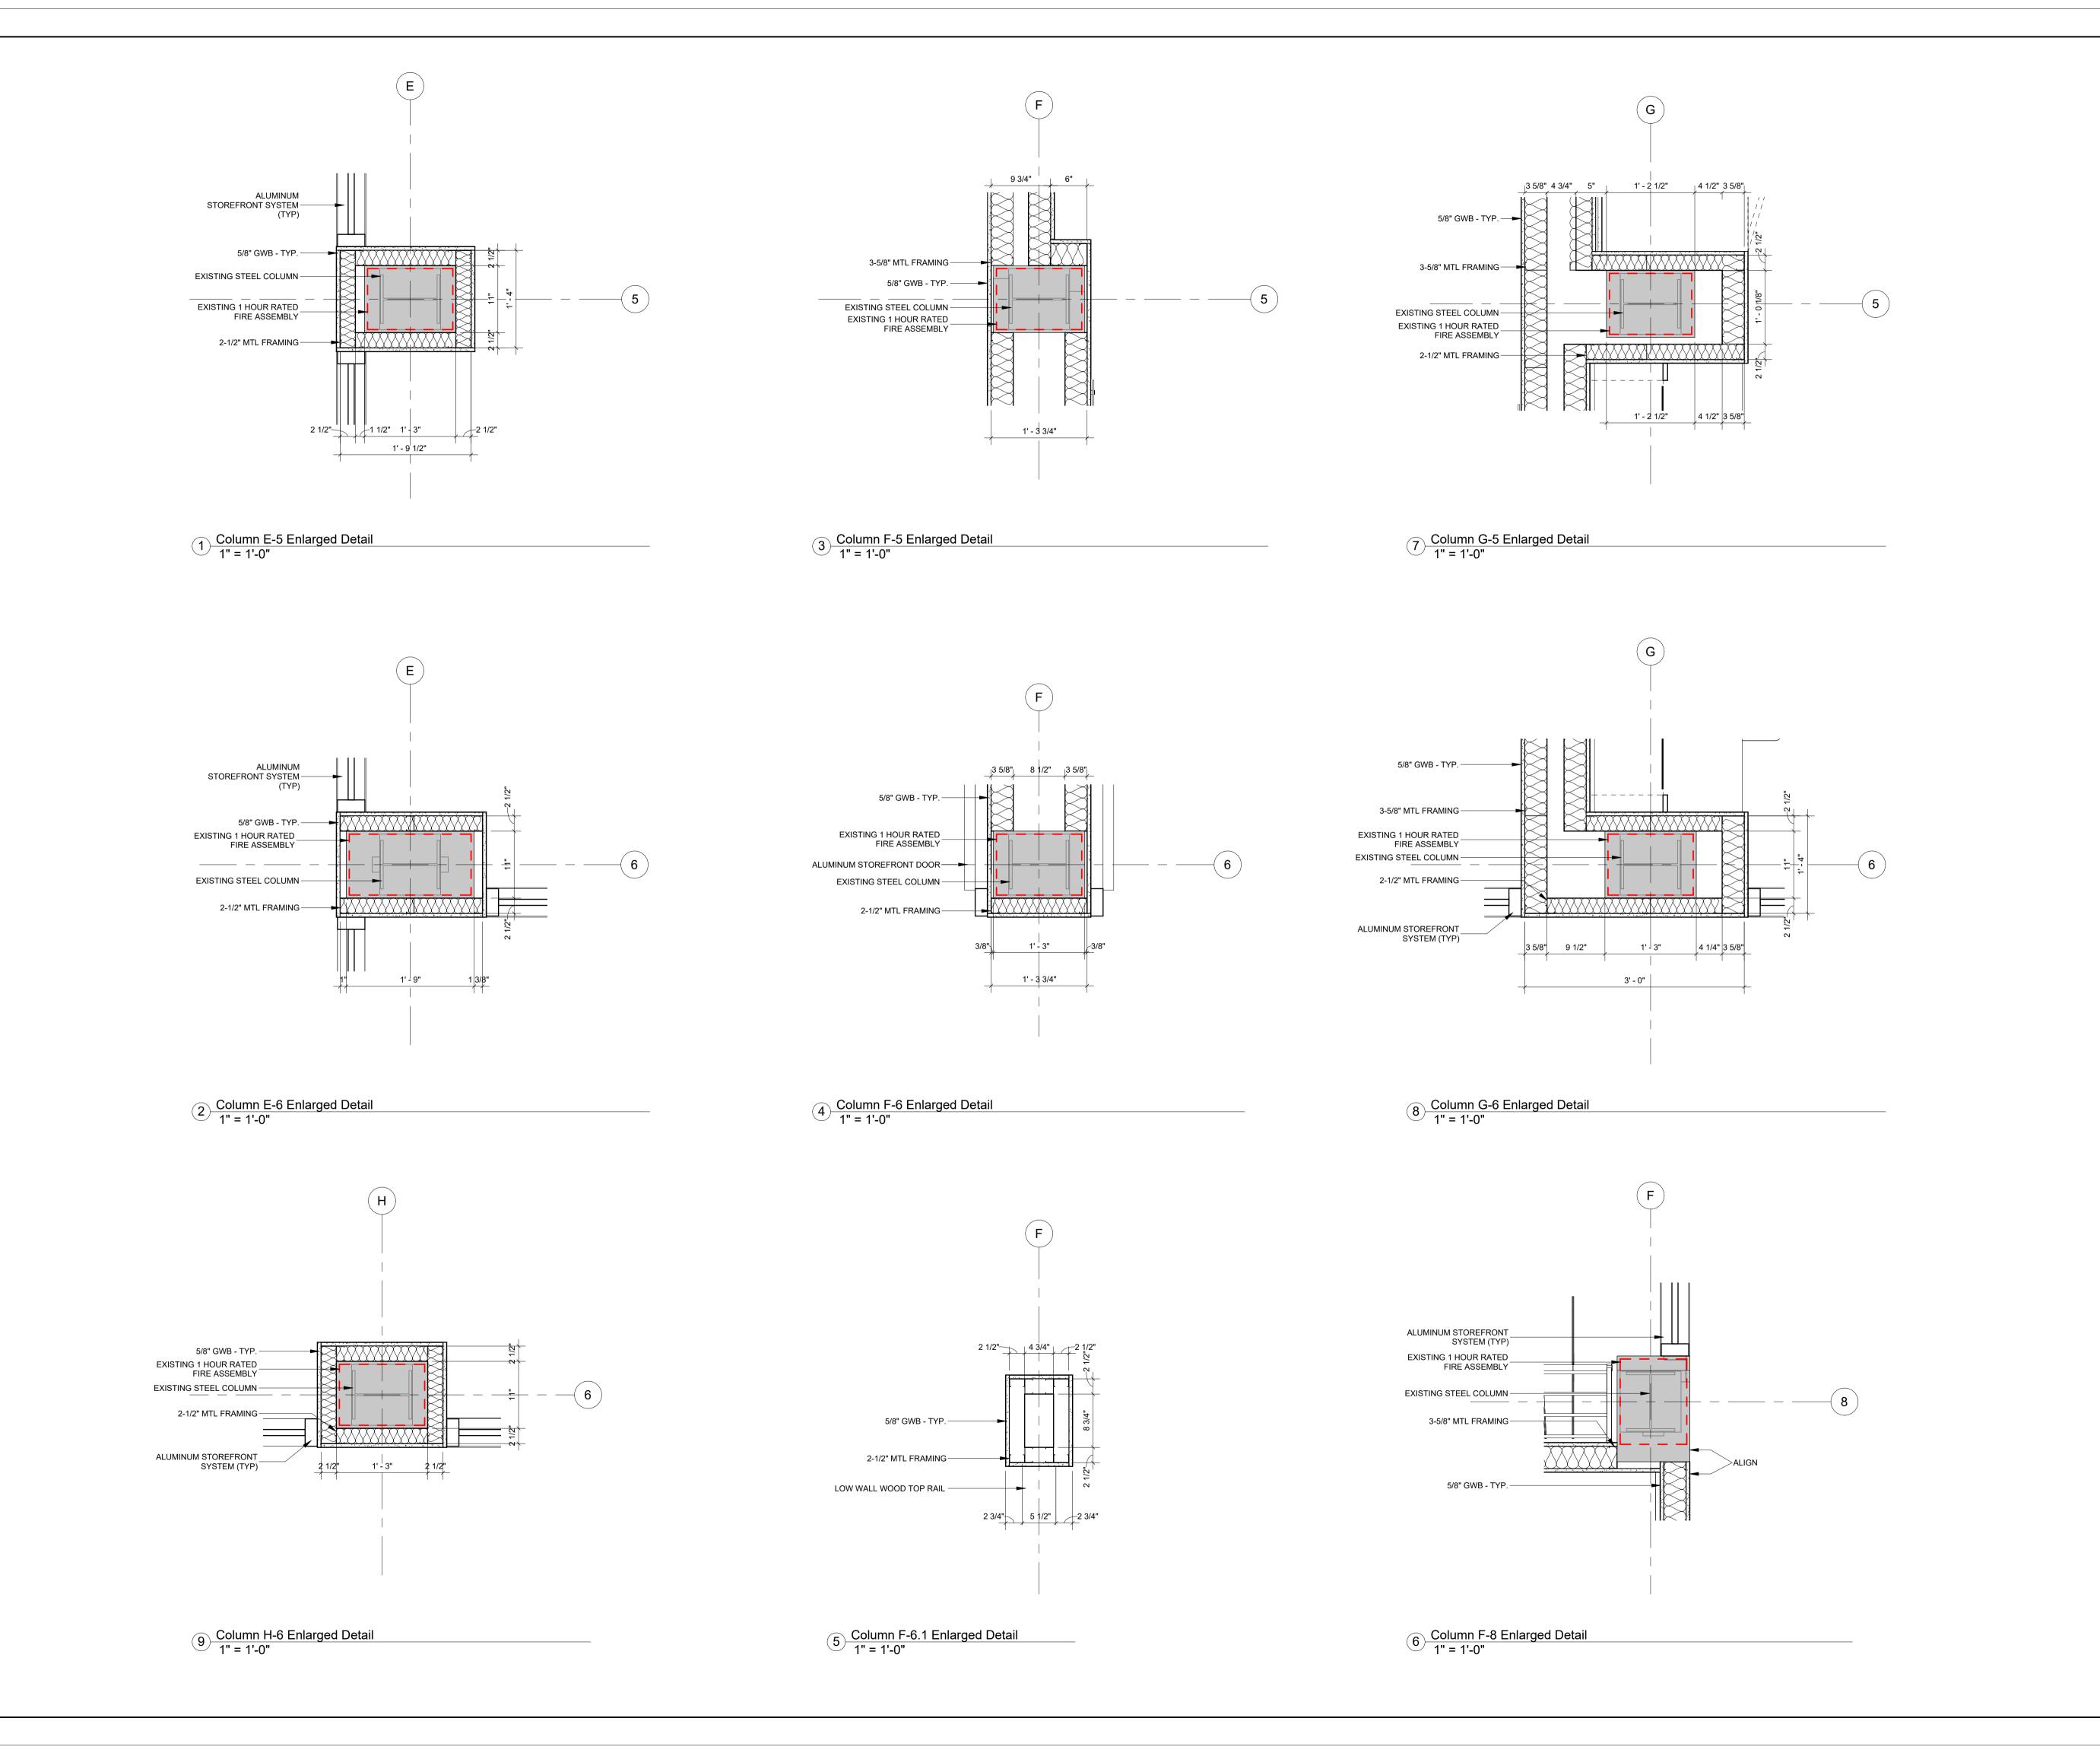
Enlarged Plans, **Elevations & Sections**

SHEET NO.:

A4.2

DATE:





SEAL:

PROJECT TITLE:

Improvements

Makerspace

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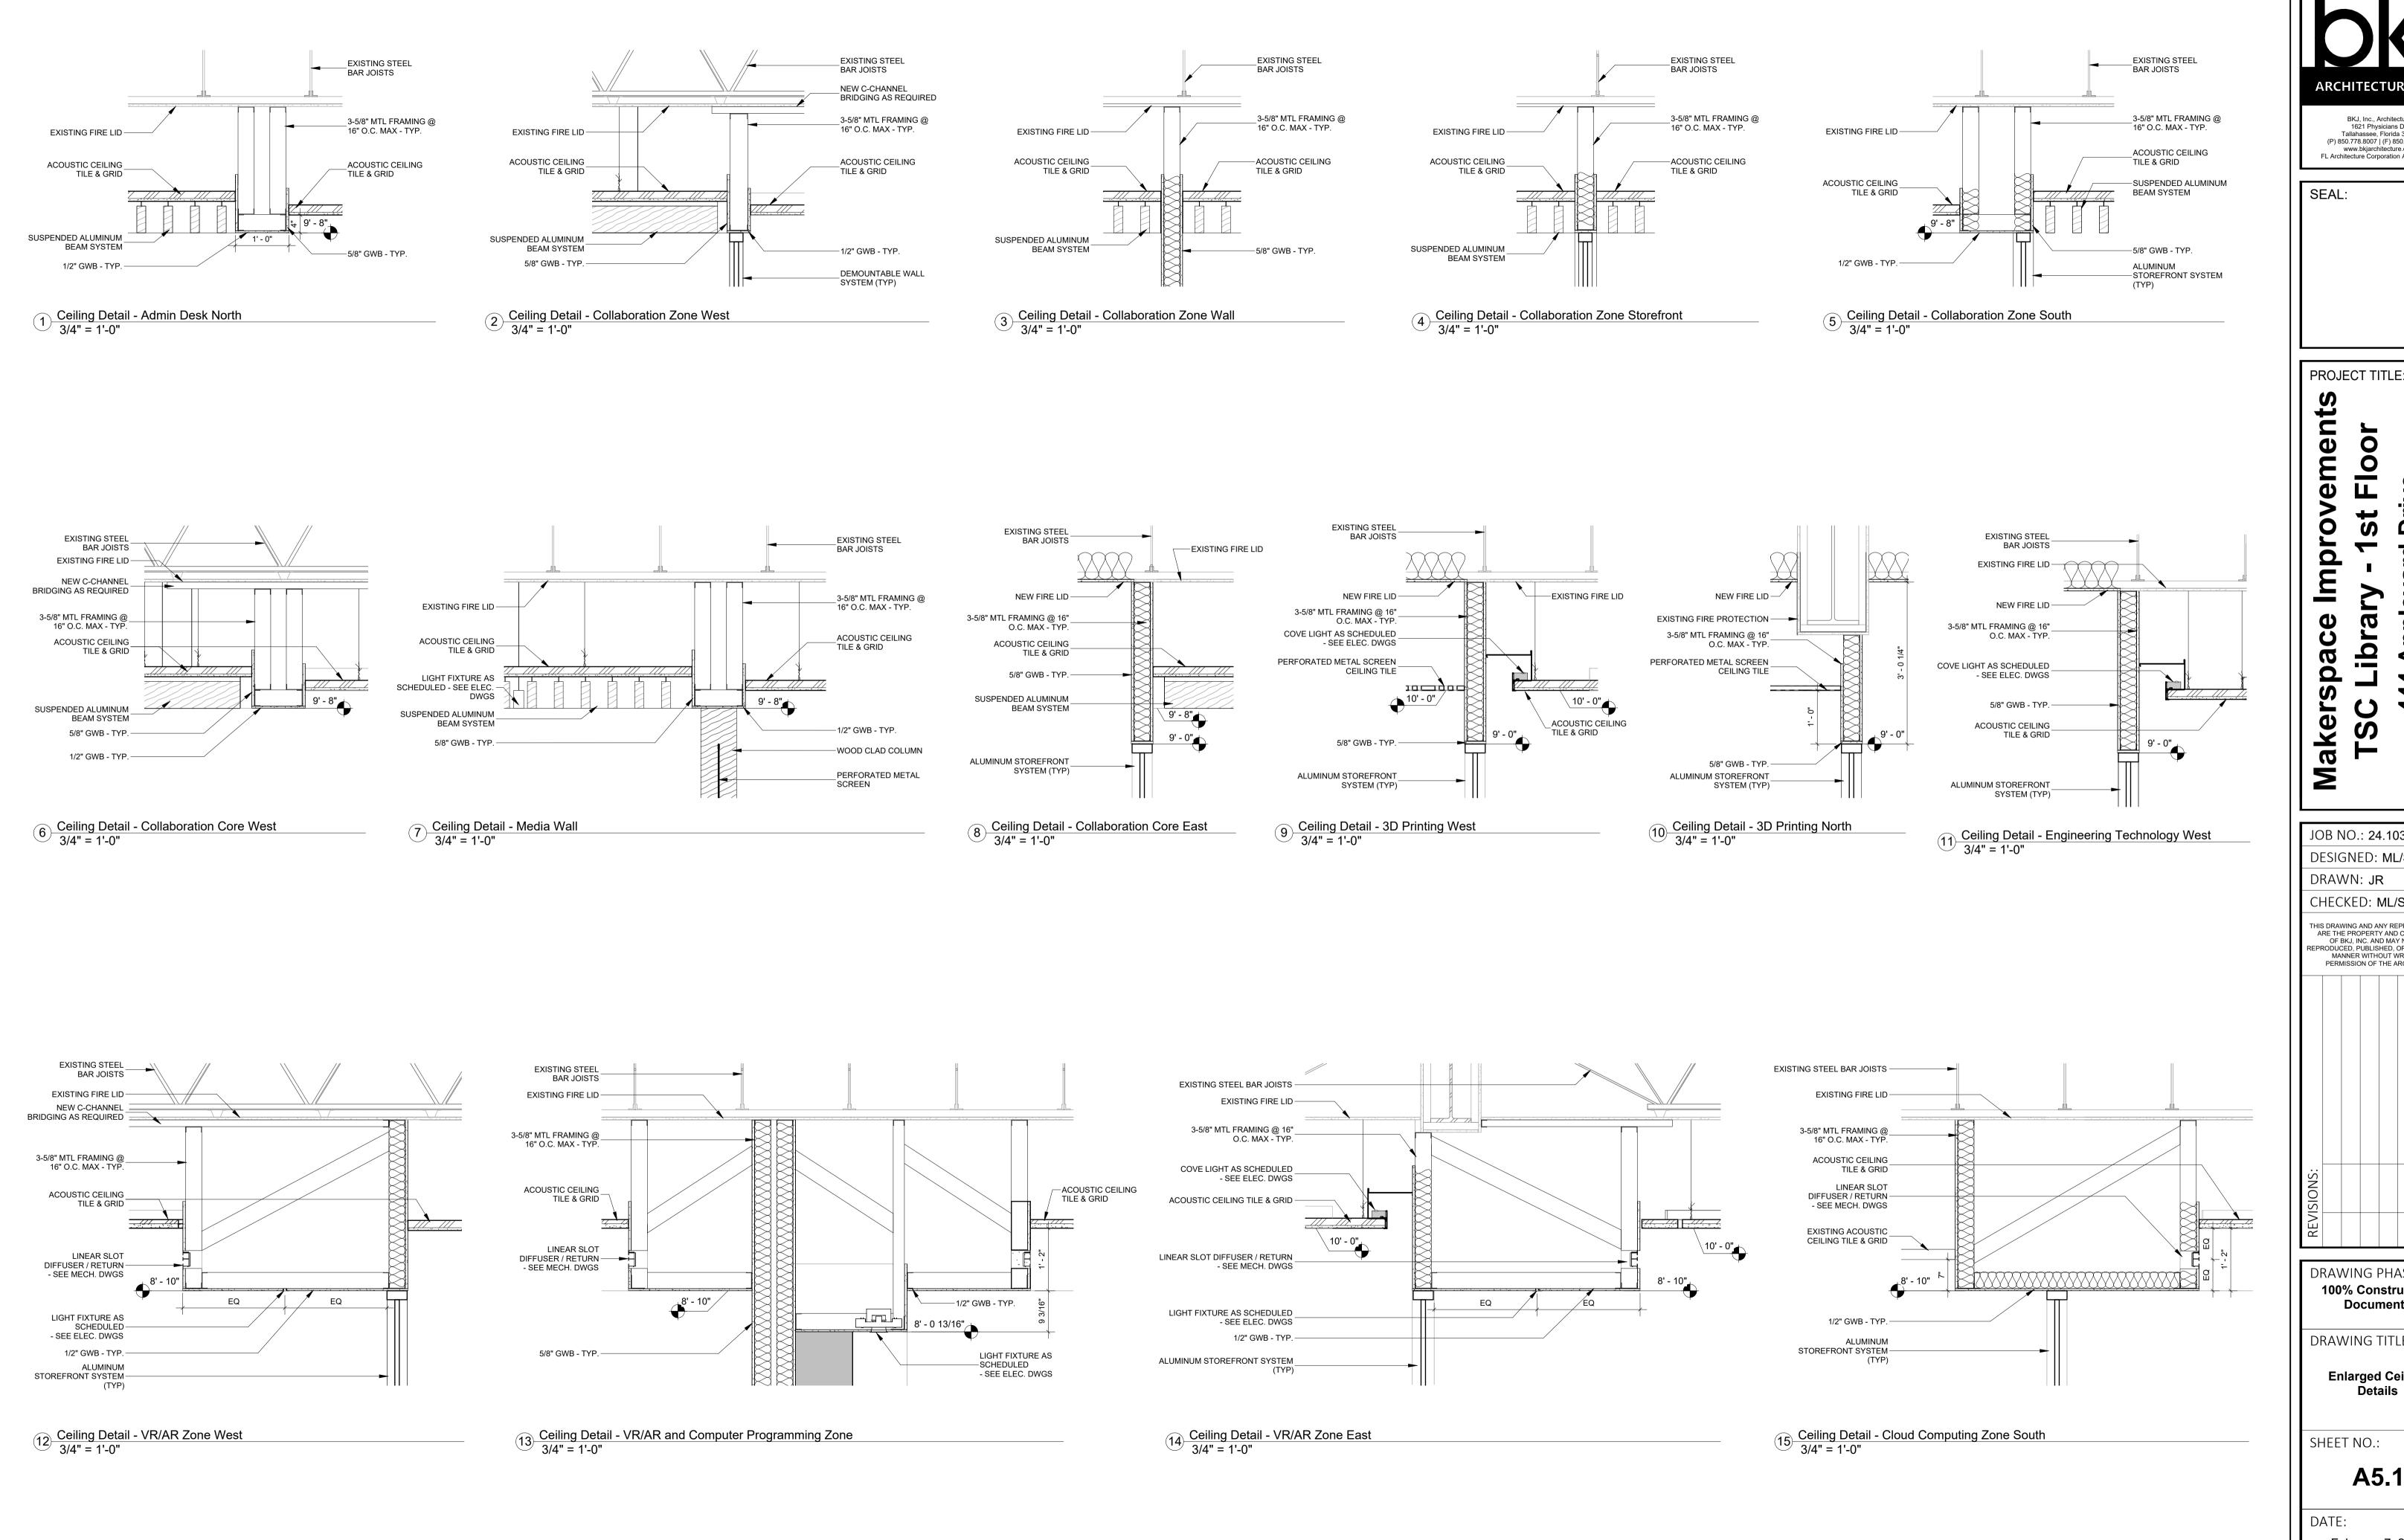
DRAWING PHASE: 100% Construction **Documents**

DRAWING TITLE:

Enlarged Plan Details

SHEET NO.: **A5.0**

DATE:





PROJECT TITLE:

FIO Ve.

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> DRAWING PHASE: 100% Construction **Documents**

DRAWING TITLE:

Enlarged Ceiling

A5.1

					Finish Schedu	le					
Number	Name	Base Finish	Floor Finish	North Wall	East Wall	South Wall	West Wall	Ceiling Finish	Ceiling Height	Notes	Numbe
118	WOMEN'S RR	TB-1.1	T-1.1	W-3.1	W-3.1	W-3.1	W-3.1	EXIST	EXIST		1008A
120	MEN'S RR	TB-1.1	T-1.1	W-3.1	W-3.1	W-3.1	W-3.1	EXIST	EXIST		
1000	COLLABORATION CORE	WB-1.1	CT-1.1 / LVT	W-1.1	W-2.3	W-1.1	W-1.1	GB-1.1/ SAB-1.1 / ECG-1.1 / ACT-1.1	9' 8" , 9' 8" , 10' 0"		1008B 1009
1000A	COLLABORATION CORE	WB-1.1	LVT	W-1.1	W-1.1 , W-2.1	W-1.1	W-1.1	GB-1.1 / ACT-1.1	9' 8" ,10' 0"		1010
1000B	COLLABORATION CORE	WB-1.1	LVT	W-1.1	W-1.1	W-1.1	W-1.1	ACT-1.1	10' 0"		1010A 1011
1000C	COLLABORATION CORE	WB-1.1	LVT	W-2.3	W-1.1	W-1.1	W-2.1	GB-1.1/ SAB-1.1 / ACT-1.1	9' 8" , 9' 8" , 10' 0"		1011
1001	ADMIN	WB-1.1	LVT	W-1.1	W-2.1	W-2.1	W-1.1	SAB-1.1 / ECG-1.1	9' 8"		1013
1002	SUPPLY	WB-1.1	LVT	W-1.1	W-1.1	W-1.1	W-1.1	ACT-1.1	10' 0"		1013
1003	COLLABORATION ZONE A	WB-1.1	CT-1.1	W-2.2	W-2.3	W-1.1	W-1.1	SAB-1.1 / ECG-1.1	9' 8"		1015
1004	COLLABORATION ZONE B	WB-1.1	CT-1.1	W-1.1	W-2.3	W-2.2	W-1.1	SAB-1.1 / ECG-1.1	9' 8"		1016
1005	CLOUD COMPUTING ZONE	WB-1.1	CT-1.1	W-1.1 , W-2.1	W-1.1	W-1.1	W-1.1	GB-1.1 / ACT-2.1	8' 10" , 10' 0"		
1006	VR / AR ZONE	WB-1.1	CT-1.1	W-1.1 , W-2.2	W-1.1	W-1.1 , W-2.1	W-1.1	GB-1.1 / ACT-2.1	8' 10" , 10' 0"		
1007	COMPUTER PROGRAMMING ZONE	WB-1.1	CT-1.1	W-1.1 , W-2.1	W-1.1	W-1.1 , W-2.1	W-1.1	GB-1.1 / ACT-2.1	8' 10" , 10' 0"		
1008	BUSINESS ZONE	WB-1.1	CT-1.1	W-1.1 , W-2.2	W-1.1	W-1.1	W-1.1	GB-1.1 / ACT-2.1	8' 10" , 10' 0"		
1008A	SUPPLY	WB-1.1	CT-1.1	W-1.1	W-1.1	W-1.1	W-1.1	ACT-1.1	10' 0"		
	PROJECT ALTERNATES: ALTERNATE NO. 3: WALL TILE OF THE PROVIDE TILE FINISH TO RESE PORCELAIN TILE: DALTILE, OF ARCTIC WHITE 0190, 4" x 12" - GROUT COLOR: MAPEI ULTE. PROJECT ALTERNATES: ALTERNATE NO. 4: WALL TILE OF THE PORCELAIN TILE: DALTILE, OF THE	STROOM WET W COLOR WHEEL " - VERTICAL INS RACOLOR PLUS ON RESTROOM W COLOR WHEEL " - VERTICAL INS	LINEAR, STALLATION 5, 38 AVALANCHE WALLS ALLS. LINEAR, STALLATION						CLOUD COM ZON 1008		
	- GROUT COLOR: MAPEI ULTI NOTE: PROVIDE OUTSIDE CORI ALL OUTSIDE CORNERS FINISH BASIS OF DESIGN:	NER WALL TRIM	I AT TILE.							- + -	

1 Level 1 - Finish Floor Plan 1/8" = 1'-0"

						Finish Schedu	ıle				
es	Number	Name	Base Finish	Floor Finish	North Wall	East Wall	South Wall	West Wall	Ceiling Finish	Ceiling Height	Notes
						•					
	1008A	SEMICONDUCTOR ZONE	WB-1.1	LVT	W-1.1	W-1.1	W-1.1	W-1.1	ACT-1.1	10' 0"	
	1008B	SUPPLY	WB-1.1	LVT	W-1.1	W-1.1	W-1.1	W-1.1	ACT-1.1	8' 3"	
	1009	ENGINEERING TECHNOLOGY ZONE	WB-1.1	LVT	W-2.3	W-1.1	W-1.1	W-1.1	GB-2.1	12 0 1/4"	
	1010	3D PRINTING	WB-1.1	LVT	W-1.1	W-2.3	W-1.1	W-1.1	PMT-1.1	10' 0"	
	1010A	SUPPLY	WB-1.1	LVT	W-1.1	W-1.1	W-1.1	W-1.1	ACT-1.1	8' 3"	
	1011	MOCK CLEANROOM	WB-1.1	LVT	W-1.1	W-1.1	W-1.1	W-1.1	ACT-1.1	10' 0"	
	1012	ELECTRICAL CLOSET	EXIST	TBD	EXIST	MATCH EXIST	EXIST	EXIST	EXIST	12 0 1/4"	
	1013	SUPPLY	WB-1.1	LVT	W-1.1	W-1.1	W-1.1	W-1.1	ACT-1.1	10' 0"	
	1014	SUPPLY	WB-1.1	CT-1.1	W-1.1	W-1.1	W-1.1	W-1.1	ACT-1.1	10' 0"	
	1015	SUPPLY	WB-1.1	CT-1.1	W-1.1	W-1.1	W-1.1	W-1.1	ACT-1.1	10' 0"	
	1016	SUPPLY	WB-1.1	CT-1.1	W-1.1	W-1.1	W-1.1	W-1.1	ACT-1.1	10' 0"	

Interior Finish General Notes:

1. PATCH, REPAIR AND PAINT EXISTING WALLS W/ LIMITED ALTERATIONS AS NEEDED TO MATCH EXISTING FINISHES.

2. REFER TO RCP FOR MULTIPLE CEILING HEIGHTS IDENTIFIED IN

3. REFER TO FINISH PLAN FOR LOCATION OF ALL ACCENT PAINT WALLS. 4. REFER TO FINISH PLAN FOR LOCATIONS OF THRESHOLDS AND FLOORING TRANSITION STRIPS.

Finish Plan Keynotes:

RUBBER THRESHOLD / TRANSITION - TR-3.1

MARBLE THRESHOLD - TR-3.2

METAL EDGE TRANSITION STRIP - TR-3.3

Finish Plan Legend:

24" X 24" LVT

24" x 24" CARPET TILE

Sealed Concrete

12" X 24" PORCELAIN TILE

ACCENT WALL PAINT - PT2 ACCENT WALL PAINT - PT3

ACCENT WALL PAINT - PT4

Interior Finish Schedule Legend:

FLOORS: LUXURY VINYL TILE, SHAW, COMPOUND 5.0, COLLECTION: COMPOUND & CAST, THRESHOLD 77515, 24" X 24" CT-1.1 CARPET TILE, SHAW, ENGAGE TILE, COLLECTION: MINDFUL PLAY, NUANCE CHARCOAL 86516, 24" x 24" PORCELAIN TILE, DALTILE, PORTFOLIO, PF06 IRON GRAY,12" x 24"

GROUT COLOR: MAPEI ULTRACOLOR PLUS, 27 SILVER 4" RUBBER BASE, TARKETT, TIGHT LOCK 63, BURNT UMBER, 3 1/4" PORCELAIN TILE, DALTILE, PORTFOLIO, PF06 IRON GRAY,12" x 24" TB-1.1 (CUT TO 6" x 24") GROUT: MAPEI ULTRACOLOR PLUS, 27 SILVER

> FIELD PAINT, PT1 ACCENT PAINT, PT2 ACCENT PAINT, PT3 ACCENT PAINT, PT4 EPOXY PAINT, PT1

T-1.1

W-1.1

W-2.1

W-2.2 W-2.3

W-3.1

CEILING: ACT-1.1 ACOUSTICAL CEILING TILE, WHITE ACOUSTICAL CEILING TILE, WHITE 24" x 48" DESIGN FLEX ACT-2.1 ACOUSTIC CEILING TILE

GB-1.1 GYPSUM BOARD - PAINTED, PT1 GB-2.1 GYPSUM BOARD - PAINTED, PT5 PERFORATED METAL CEILING TILE PMT-1.1 SAB-1.1 SUSPENDED LINEAR ALUMINUM BEAMS, ARMSTRONG METALWORKS BLADES - CLASSICS 2" x 6", M1 UNPERFORATED, EFFECTS OAK, 6" O.C SPACING ECG-1.1 EGGCRATE CEILING PANEL, BLACK 24" x 24" **EXIST** EXISTING TO REMAIN

DOORS: D-1 DOOR FRAMES - PAINTED, PT5 D-2 INTERIOR DOORS - WOOD VENEER, WD-1 PAINT:

PT-1 SHERWIN WILLIAMS, SW7005 PURE WHITE PT-2 SHERWIN WILLIAMS, SW6811 HONORABLE BLUE PT-3 SHERWIN WILLIAMS, SW6904 GUSTO GOLD PT-4 SHERWIN WILLIAMS, SW6255 MORNING FOG PT-5 SHERWIN WILLIAMS, SW7068 GRIZZLE GRAY

STAIN: ST-1 MINWAX, WATER BASED, CLEAR SATIN / DULL PLASTIC LAMINATE

BASE / UPPER / UTILITY CABINETS - WILSONART, PL-1.1 PEWTER D73-60 PL-2.1 COUNTERTOP / FACE OF DESK - WILSONART, DESIGNER WHITE D354 PL-3.1 SINK APRON - WILSONART, WA-FAIRCHILD 8238K-05

PHENOLIC RESIN: COUNTERTOP - DURCON, COLOR: GRAPHITE

SOLID SURFACE: COUNTERTOP / WINDOW SILLS - WILSONART, ENGINEERED SS-1.1 QUARTZ, DESIGNER WHITE, D354SL - W/ EASED EDGE SS-2.1 COUNTERTOP - WILSONART, ENGINEERED QUARTZ, BODEGA, WA-Q1022 - W/ EASED EDGE

WOOD: WHITE OAK VENEER, RIFT CUT: ST-1 WD-1 WD-2 SOLID WHITE OAK, RIFT CUT: ST-1

METAL: MT-1 PERFORATED METAL / TUBE STEEL, ACCENT PAINT PT-5

TOILET PARTITION: TP-1 -

SCRANTON PRODUCTS, HINEY-HIDERS, SHALE, ORANGE PEEL INTERIOR STOREFRONT:

COLOR: MATCH EXISTING

TRANSITIONS / THRESHOLDS: TARKETT RUBBER TRANSITION, COLOR: TBD TR-3.1 TR-3.2 MARBLE THRESHOLD TR-3.3 TARKETT TRANSITION STRIP, ME002, COLOR: IRONSTONE

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FL Architecture Corporation AA26002280

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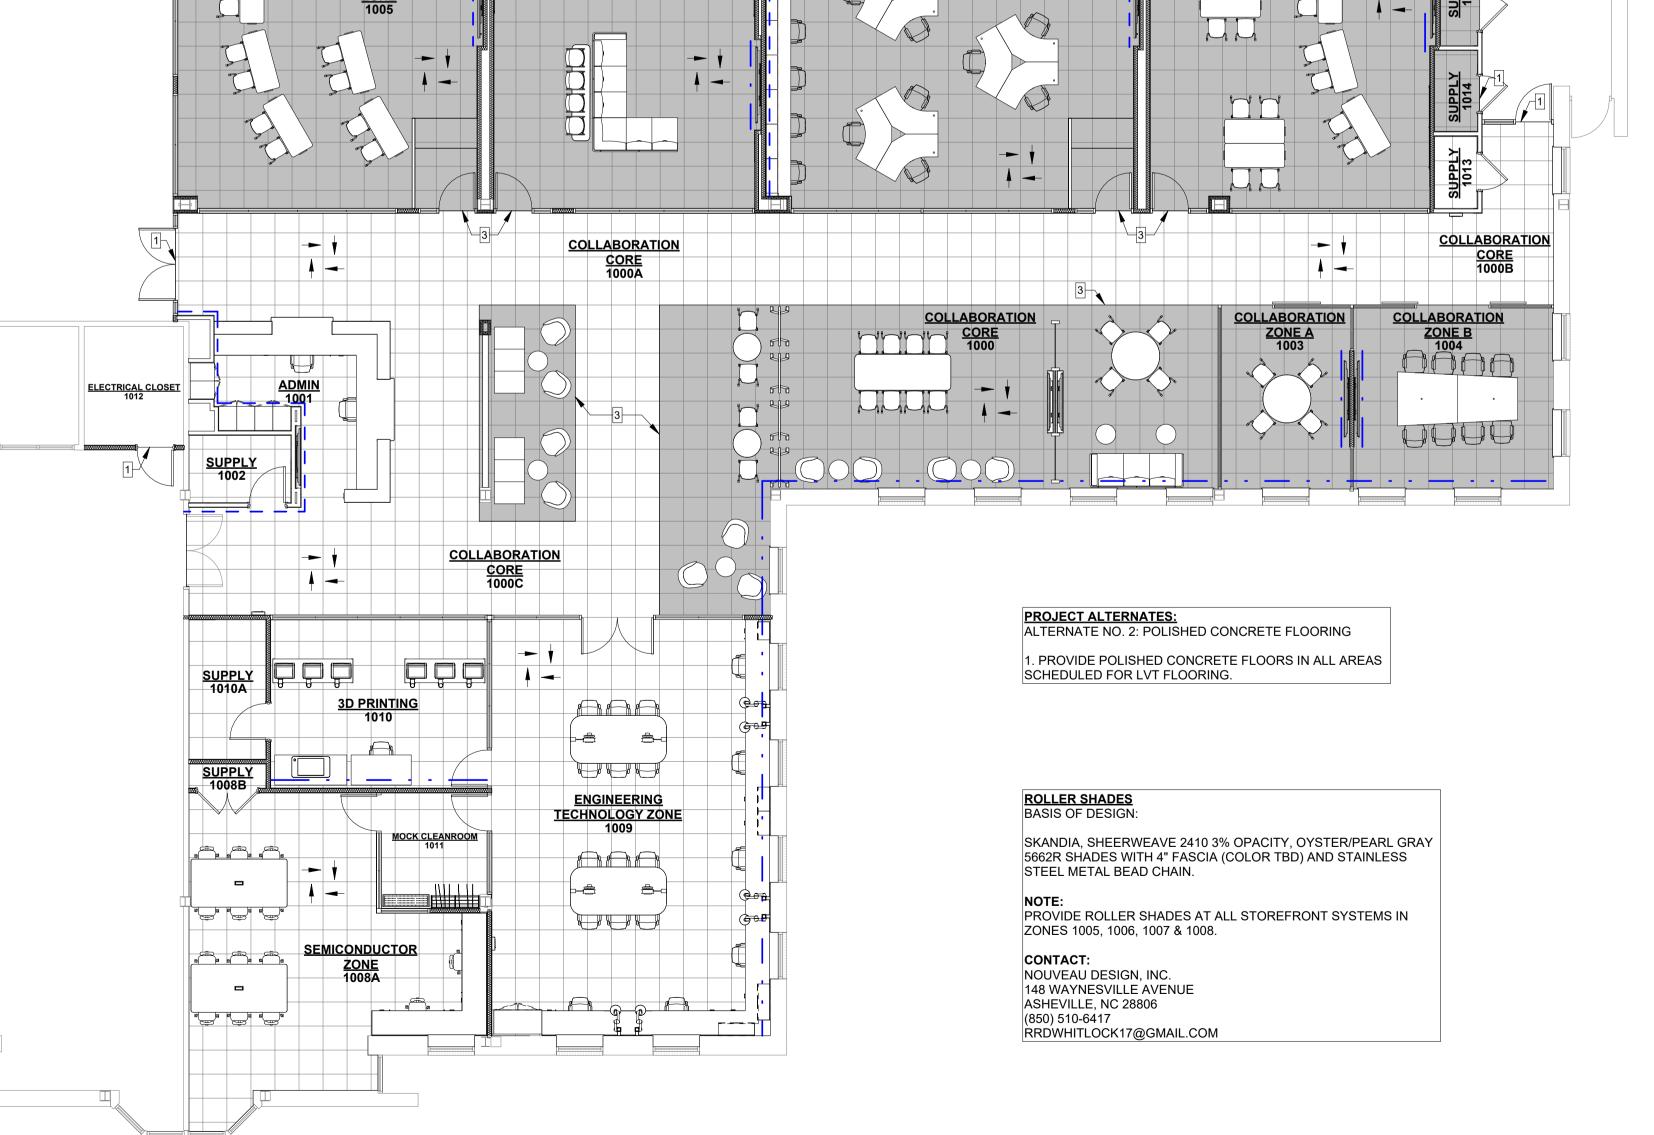
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Finish Plan & Schedule


SHEET NO.:

A6.0

February 7, 2025



VR / AR ZONE

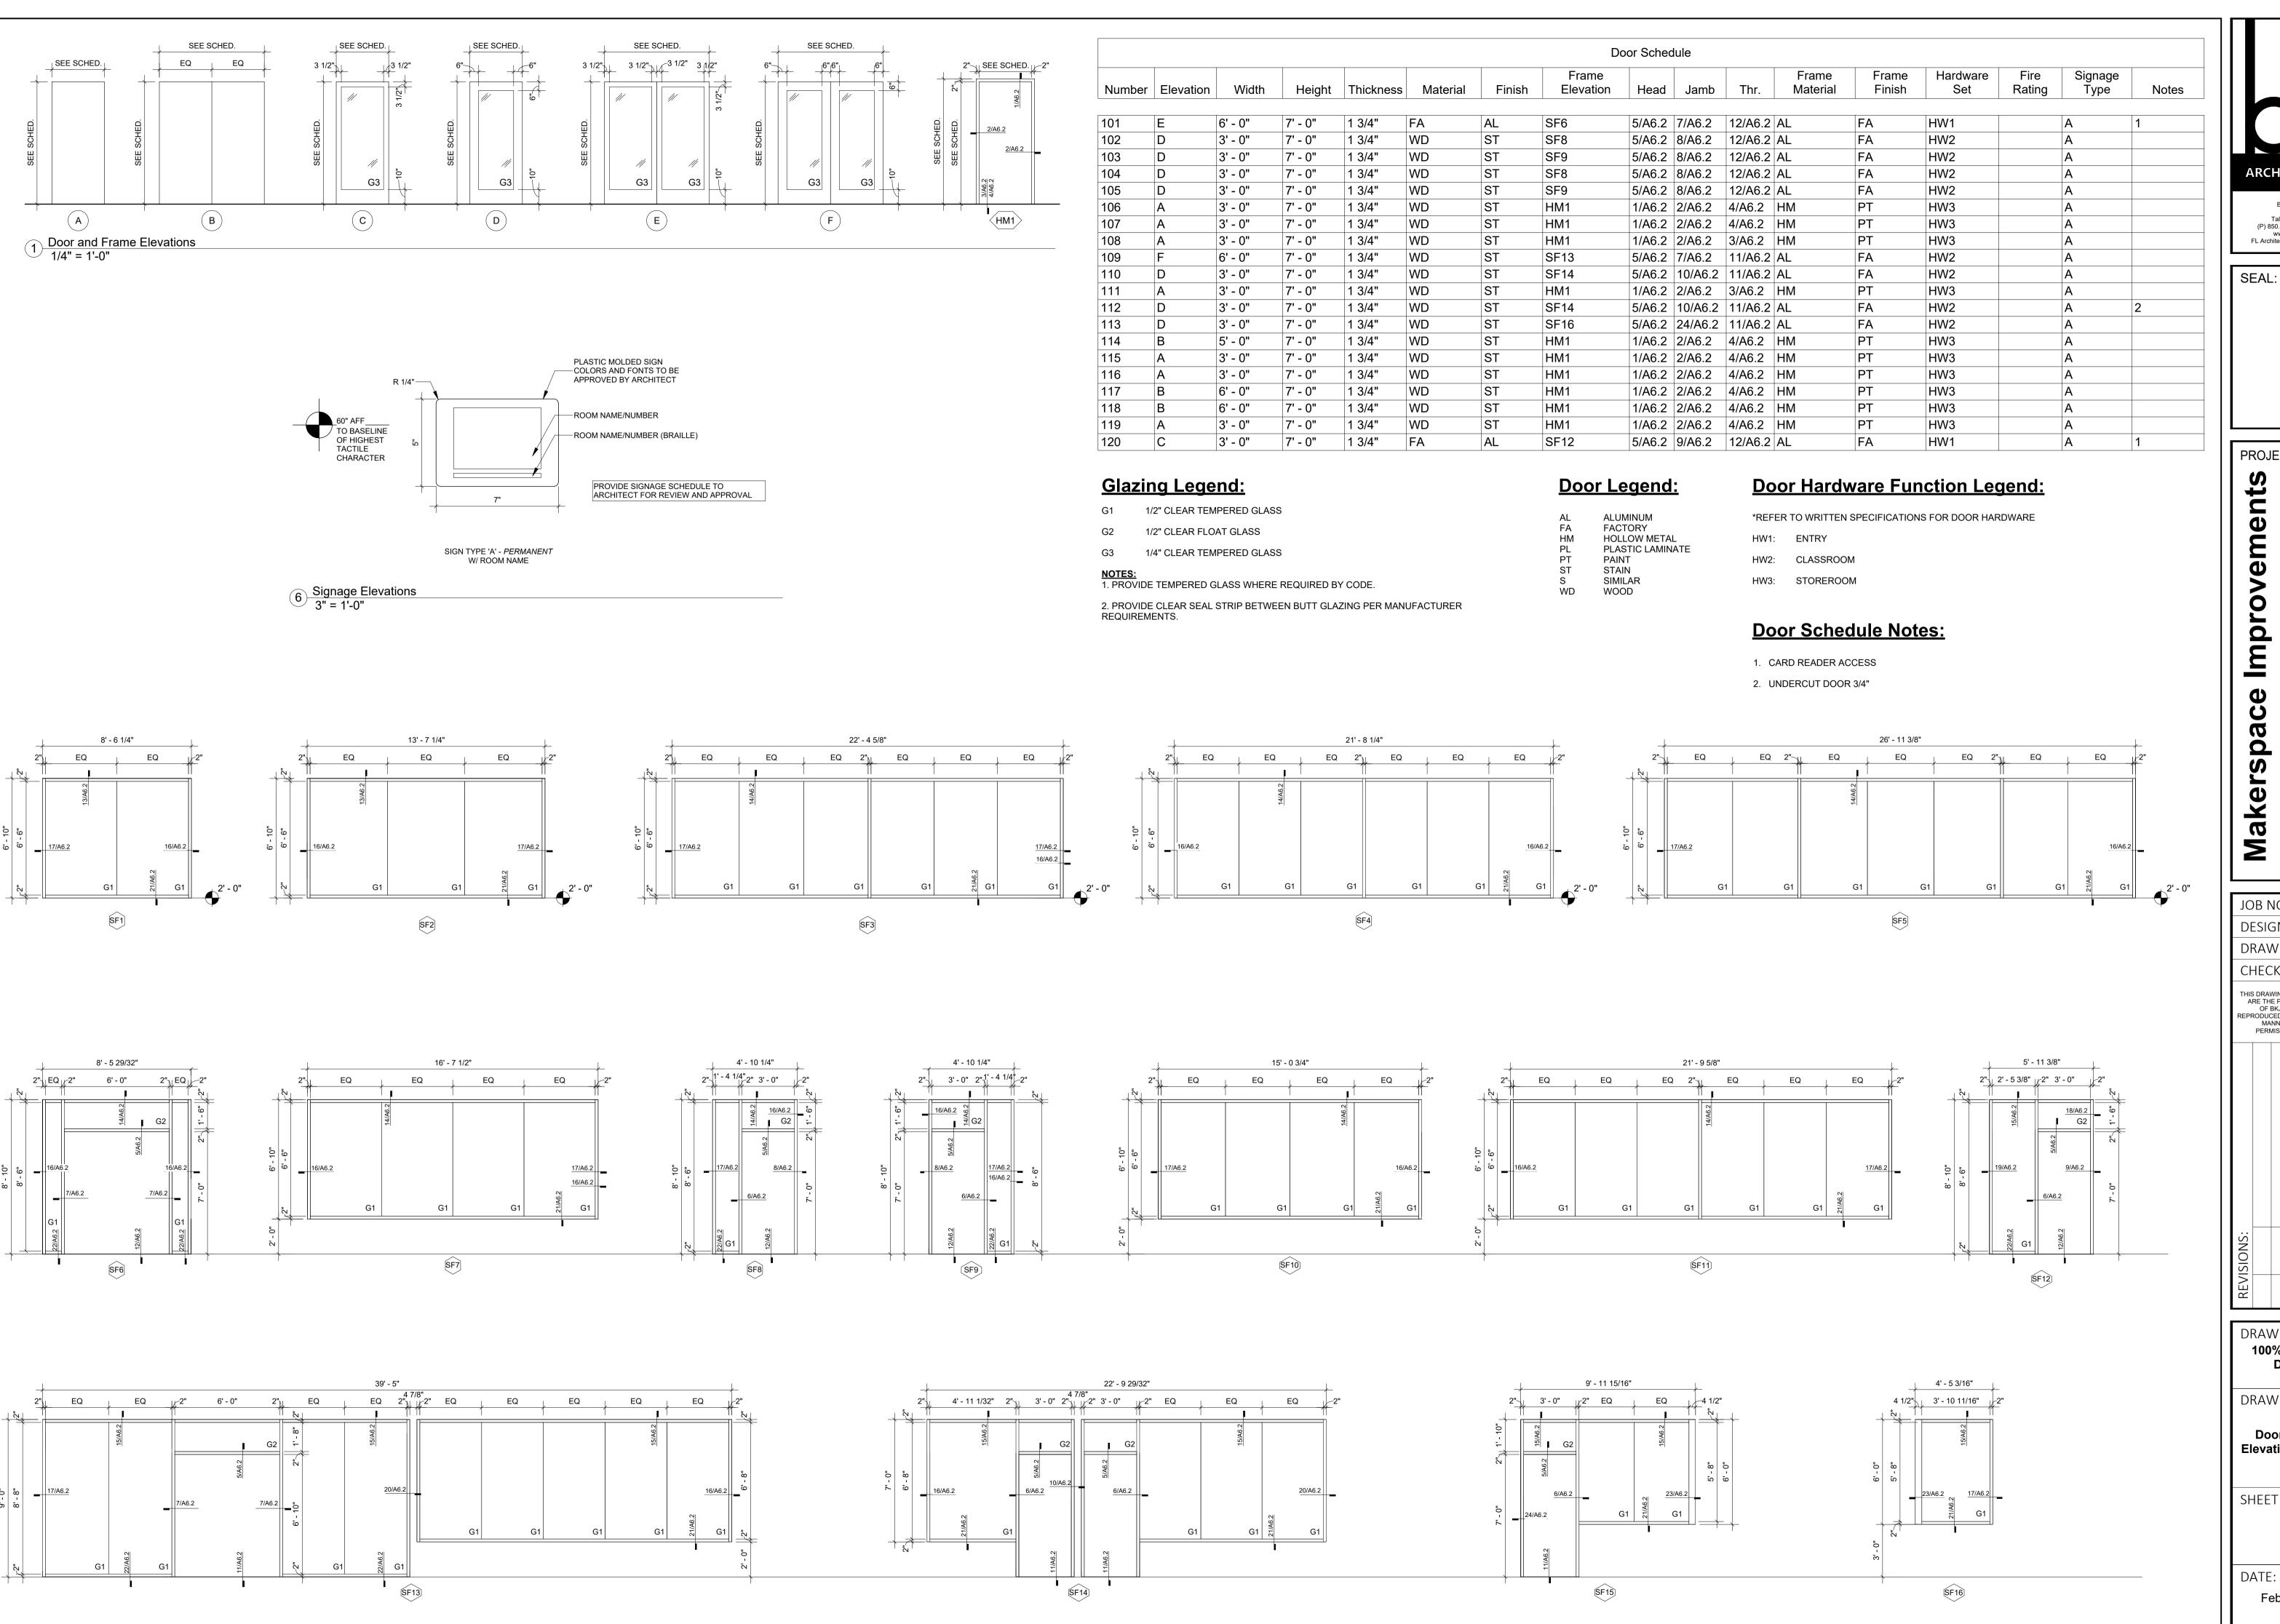



PROJECT TITLE:

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F **Drive,** 32304 Impro arc F 444 Appleya Tallahassee,

JOB NO.: 24.103 DESIGNED: ML/SC DRAWN: JR CHECKED: ML/SC ARE THE PROPERTY AND COPYRIGHT
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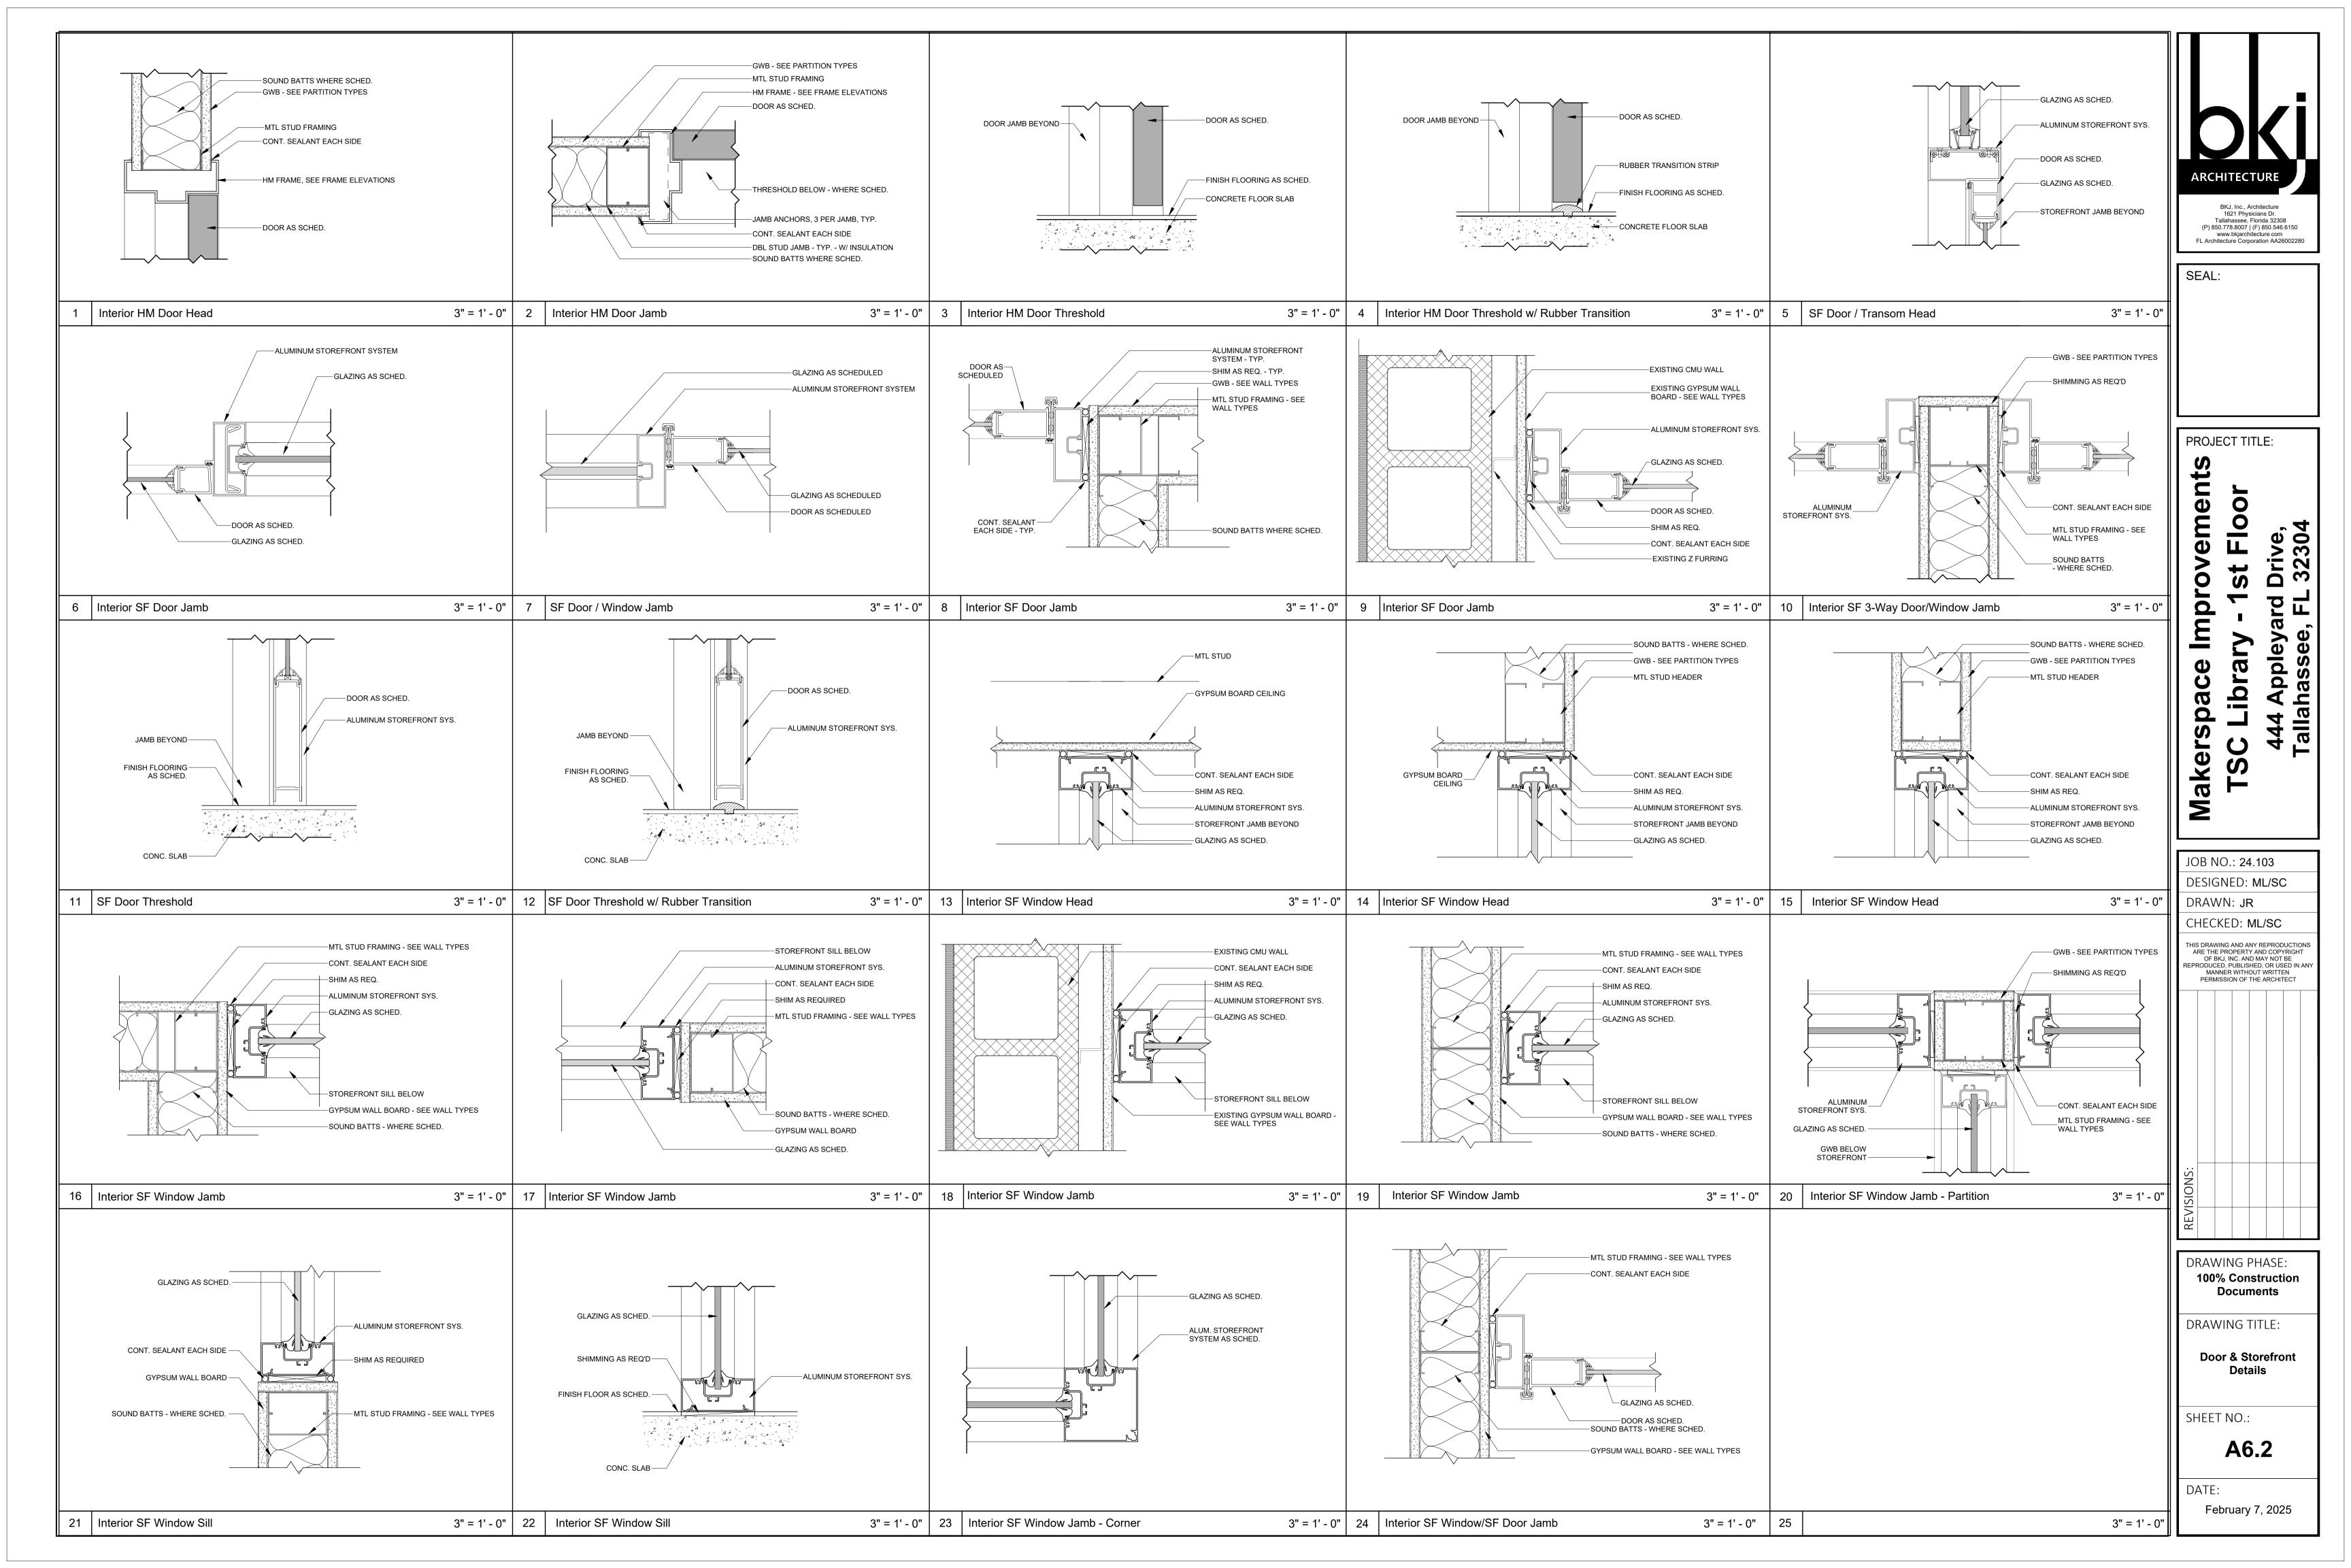
DRAWING TITLE:

Door & Storefront Elevations & Schedule

SHEET NO.:

A6.1

DATE:







PROJECT TITLE:

Improvements

Makerspace

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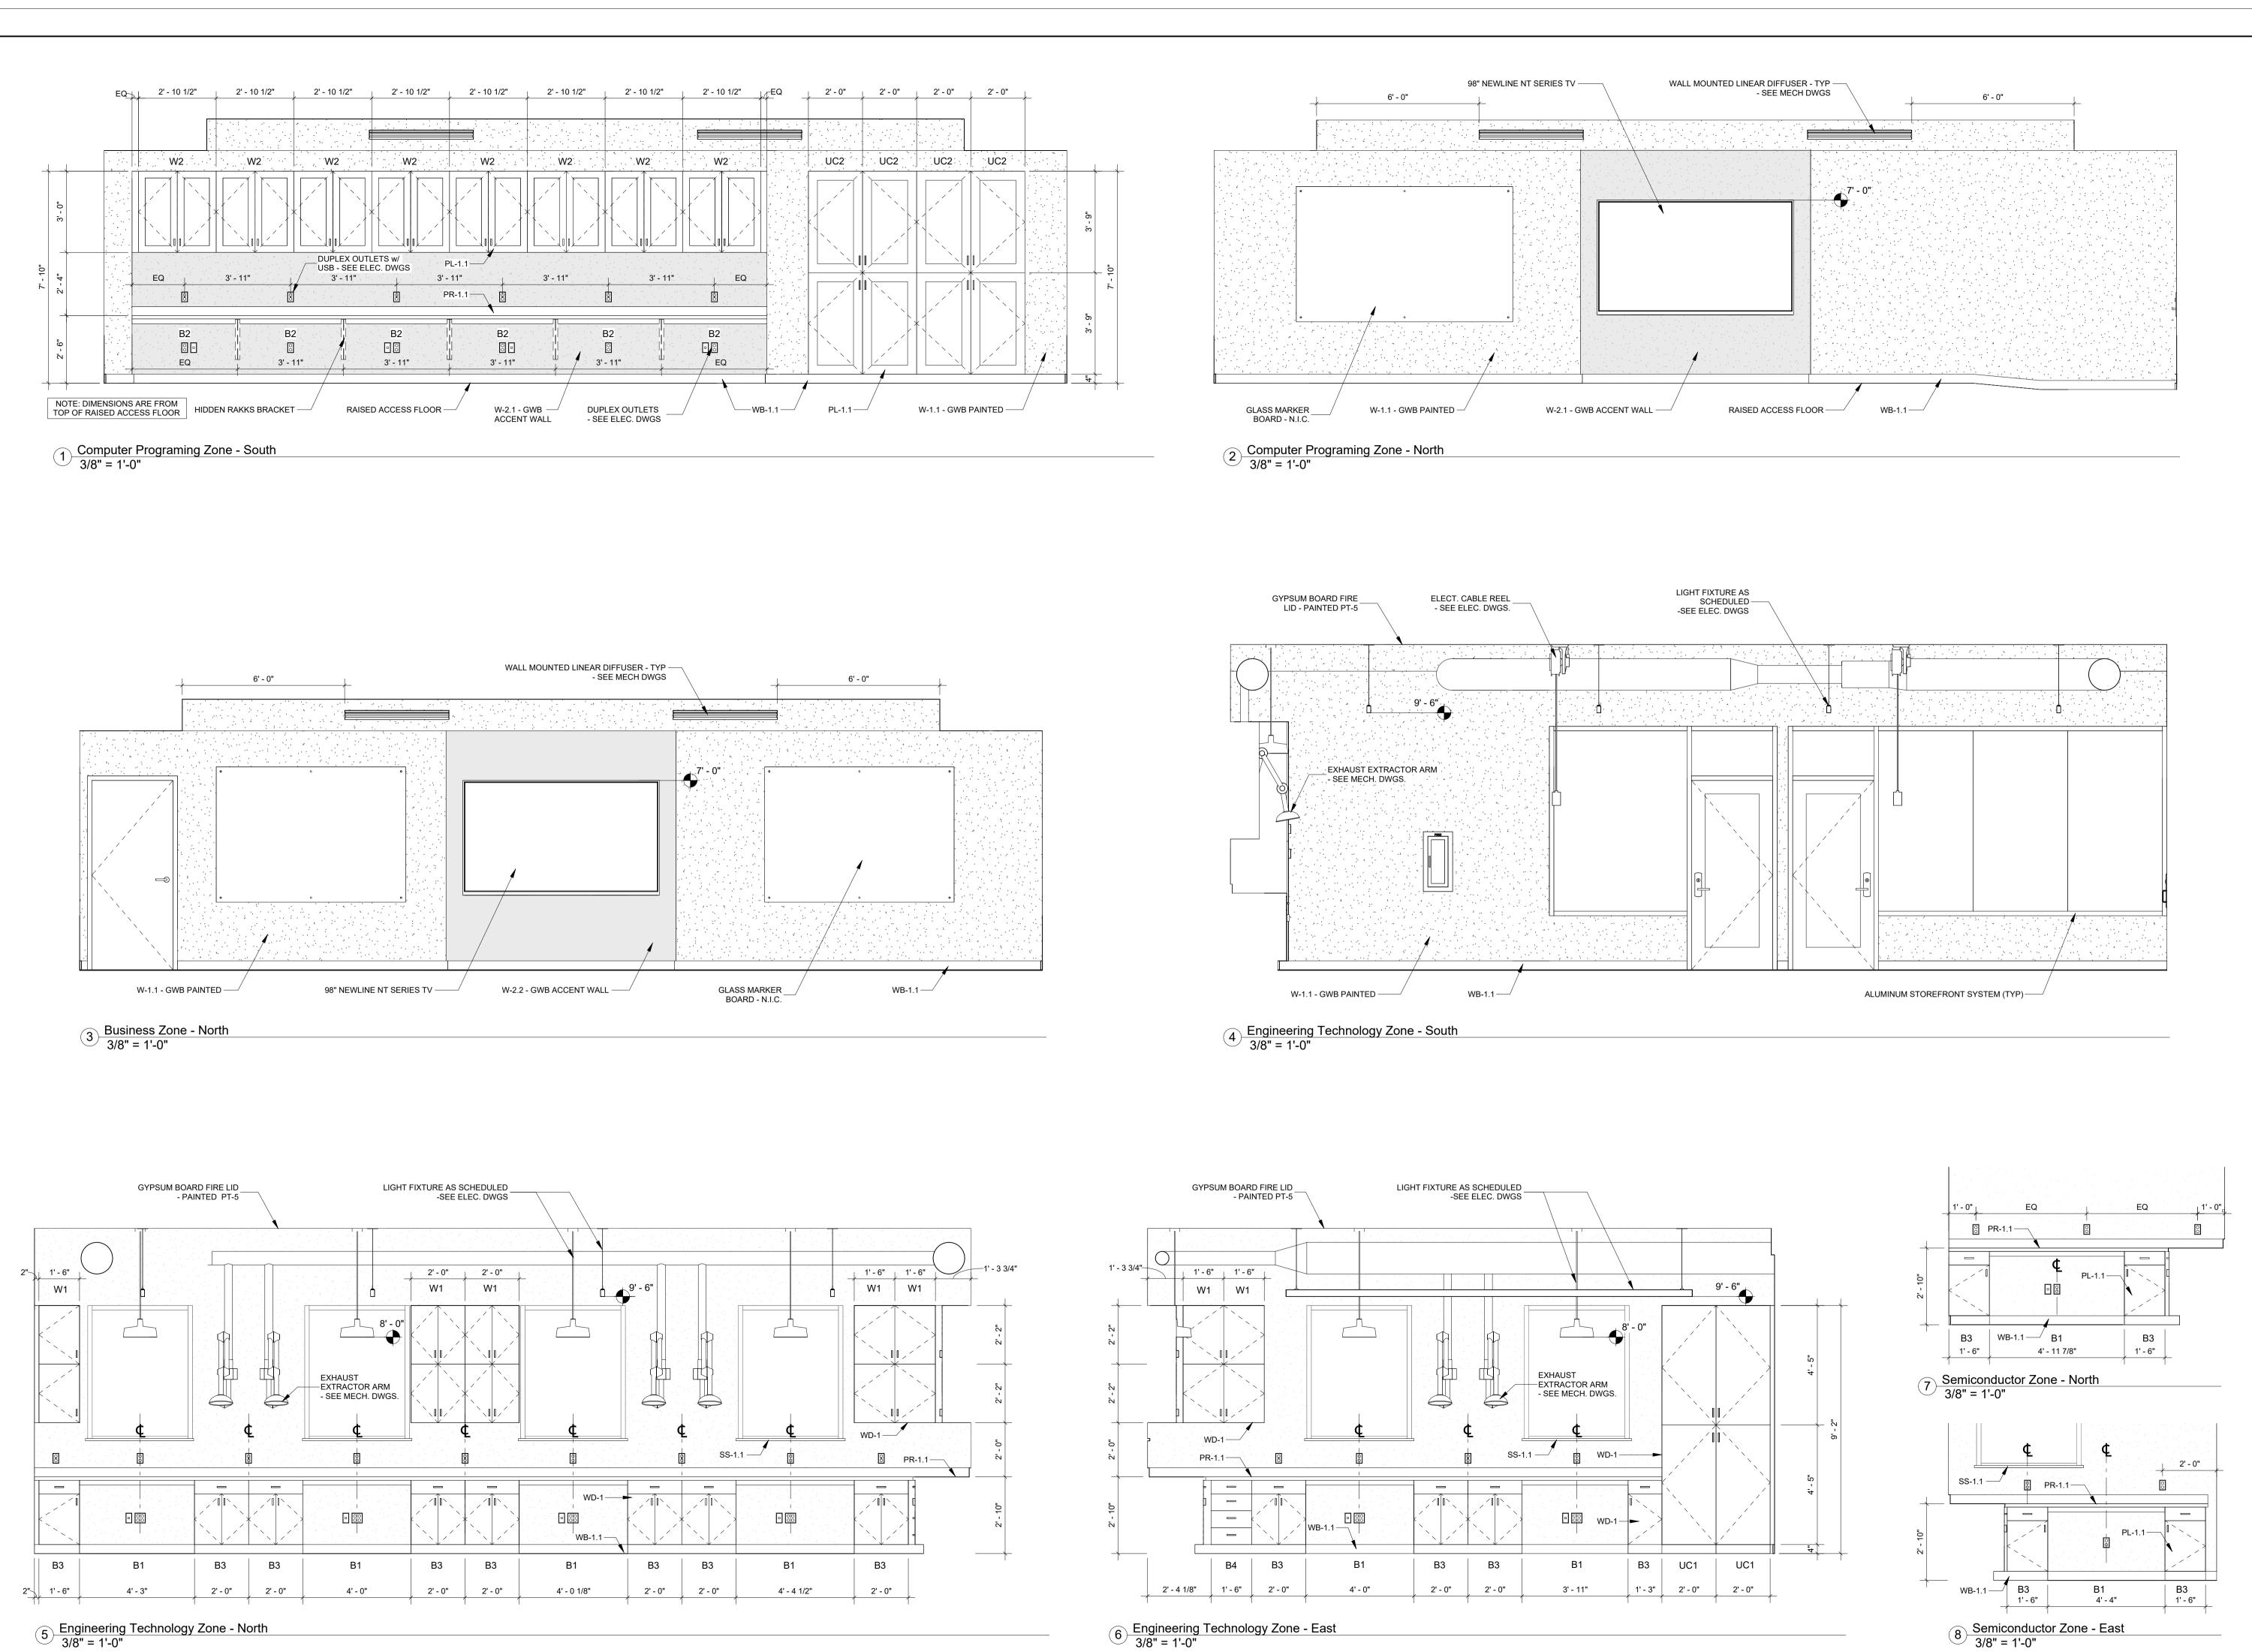
DRAWING TITLE:

Interior Elevations

SHEET NO.:

A7.0

DATE:



SEAL:

PROJECT TITLE:

Improvements st Flo 444 Appleyard I Tallahassee, FL

Makerspace JOB NO.: 24.103 DESIGNED: ML/SC

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DRAWING TITLE:

Interior Elevations

SHEET NO.: A7.1

DATE:


2' - 1" BACKSPLASH AS SCHED. -COUNTERTOP AS SCHED. -3/4" PLYWOOD — 1.5" x 1.5" STEEL TUBE - PAINTED BLACK 1.5" x 1.5" STEEL ANGLE AT EACH END -- PAINTED BLACK 2x2 WOOD BLOCKING -BASE AS SCHED. -2' - 0" 2 B1 - Countertop 1" = 1'-0" P.L. WALL CABINET — ADJUSTABLE SHELF


SHELF SUPPORT HOLES AT 2" O.C.

P.L. ON ALL


VISIBLE SURFACES

4 W1 - Wall Cabinet 1" = 1'-0"

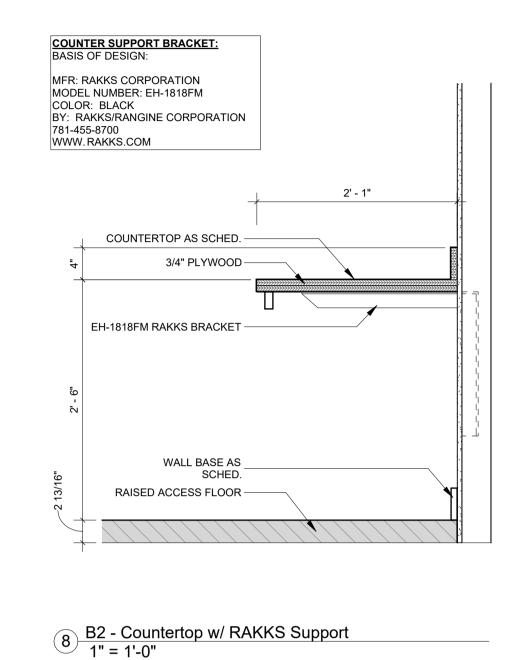

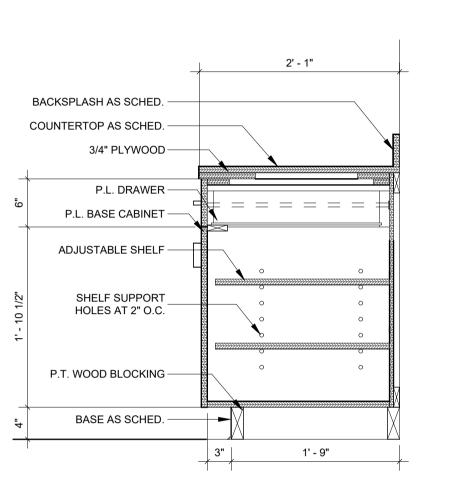



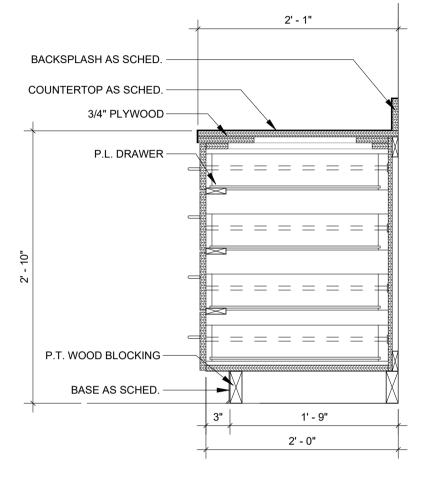

1 B4 - Base Cabinet w/ 4 Drawers
1" = 1'-0"

Millwork General Notes:

 MILLWORK TO BE USED AS BASIS OF DESIGN.
 CONTRACTOR TO SUBMIT SHOP DRAWINGS FOR ALL MILLWORK TO TENANT FOR COORDINATION AND FINAL APPROVAL. 3. MILLWORK DIMENSIONS ARE MEASURED FROM FACE OF FINISH SURFACE

Millwork Finish Schedule:

STAIN: ST-1 MINWAX, WATER BASED, CLEAR SATIN / DULL

PLASTIC LAMINATE: PL-1.1

BASE / UPPER / UTILITY CABINETS -

WILSONART, PL-2.1

COUNTERTOP / FACE OF DESK - WILSONART, DESIGNER WHITE D354

PHENOLIC RESIN: COUNTERTOP - DURCON, COLOR: GRAPHITE

SOLID SURFACE SS-1.1

PL-3.1

PR-1.1

P.L. WALL CABINET ----

PERFORATED_

METAL SCREEN

P.L. ON ALL _ VISIBLE SURFACES

ADJUSTABLE SHELF -

SHELF SUPPORT

HOLES AT 2" O.C.

P.T. WOOD BLOCKING -

BASE AS SCHED. -

1' - 9"

10 UC3 - Utility Cabinet w/ Metal Screen Panel Deep

COUNTERTOP / WINDOW SILLS - WILSONART, ENGINEERED QUARTZ, DESIGNER WHITE, D354SL - W/ EASED EDGE

SINK APRON - WILSONART, WA-FAIRCHILD

COUNTERTOP - WILSONART, ENGINEERED SS-2.1

QUARTZ, BODEGA, WA-Q1022 - W/ EASED EDGE WOOD: WHITE OAK VENEER, RIFT CUT: ST-1 SOLID WHITE OAK, RIFT CUT: ST-1 WD-1 WD-2

PROJECT TITLE:

SEAL:

Improvements FIO

1621 Physicians Dr.
Tallahassee, Florida 32308
(P) 850.778.8007 | (F) 850.546.6150
www.bkjarchitecture.com
FL Architecture Corporation AA26002280

444 Appleya Tallahassee, **Makerspace**

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DRAWING TITLE:

Millwork Details

SHEET NO.:

1' - 6" MINIMUM


CLEARANCE FOR


CHARGING STATIONS


A7.2


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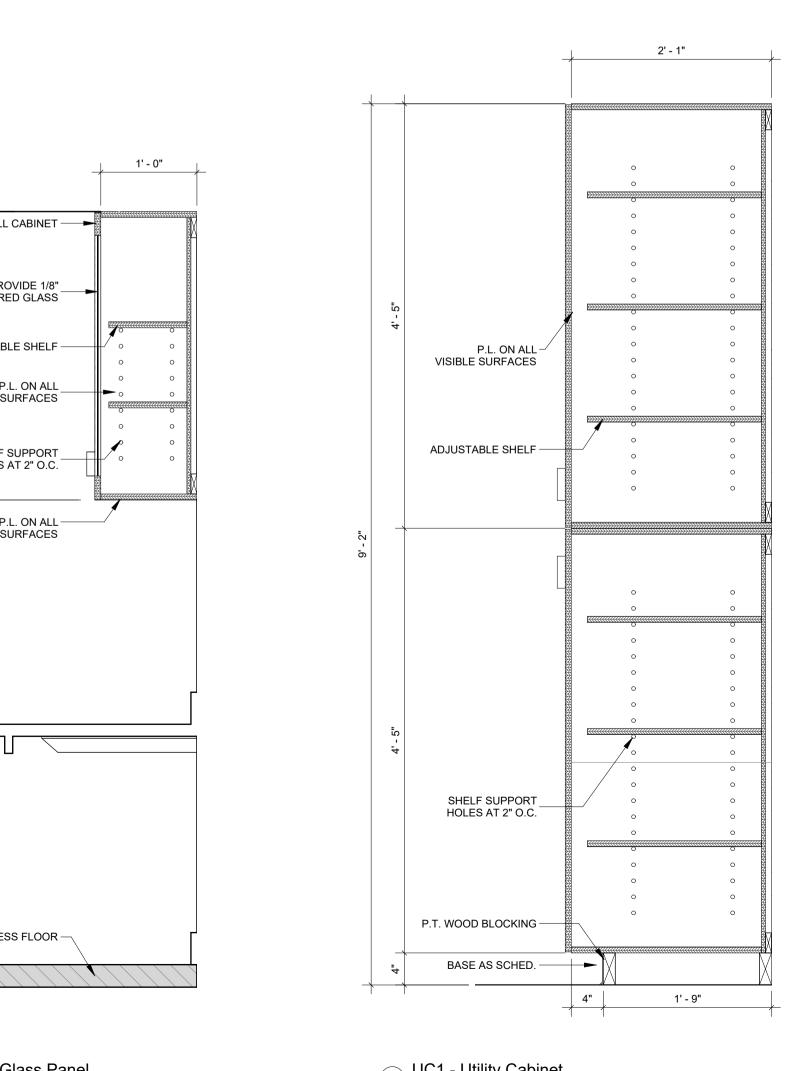
February 7, 2025




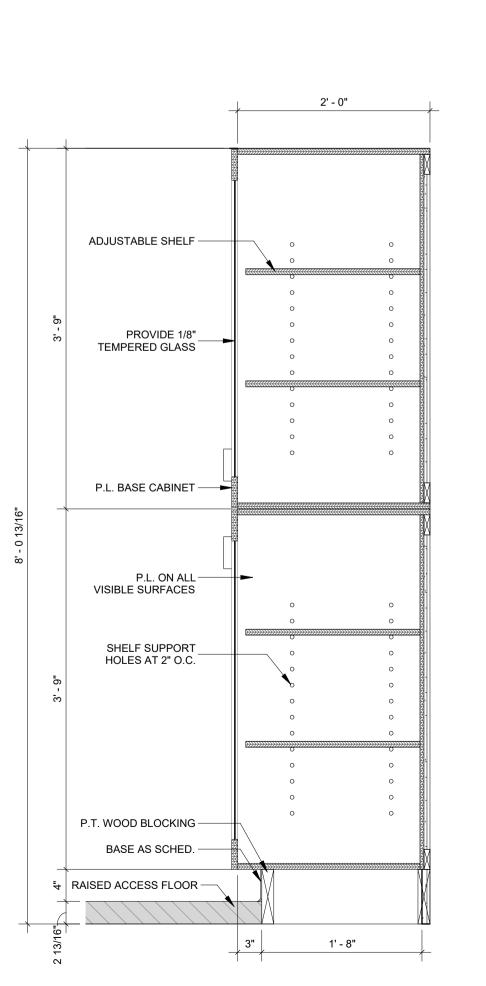

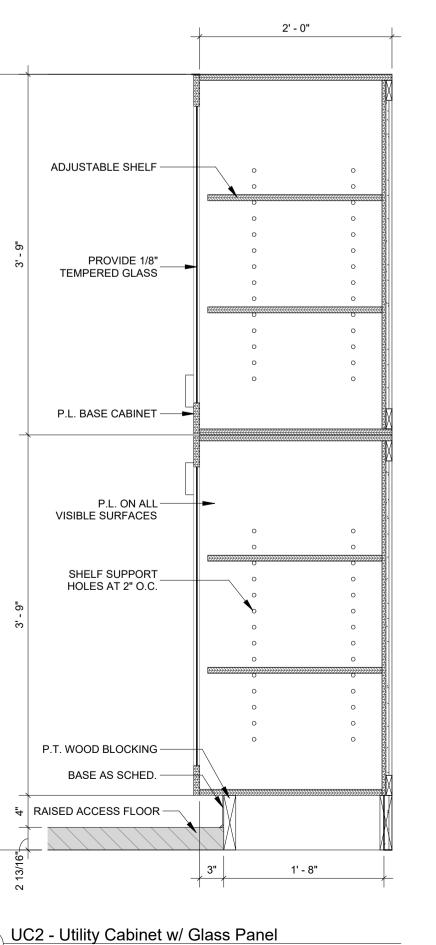

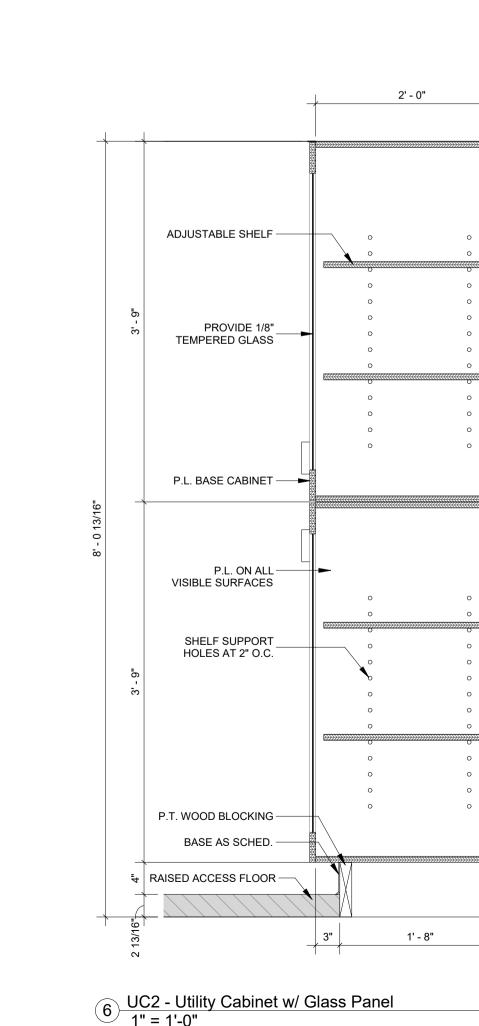


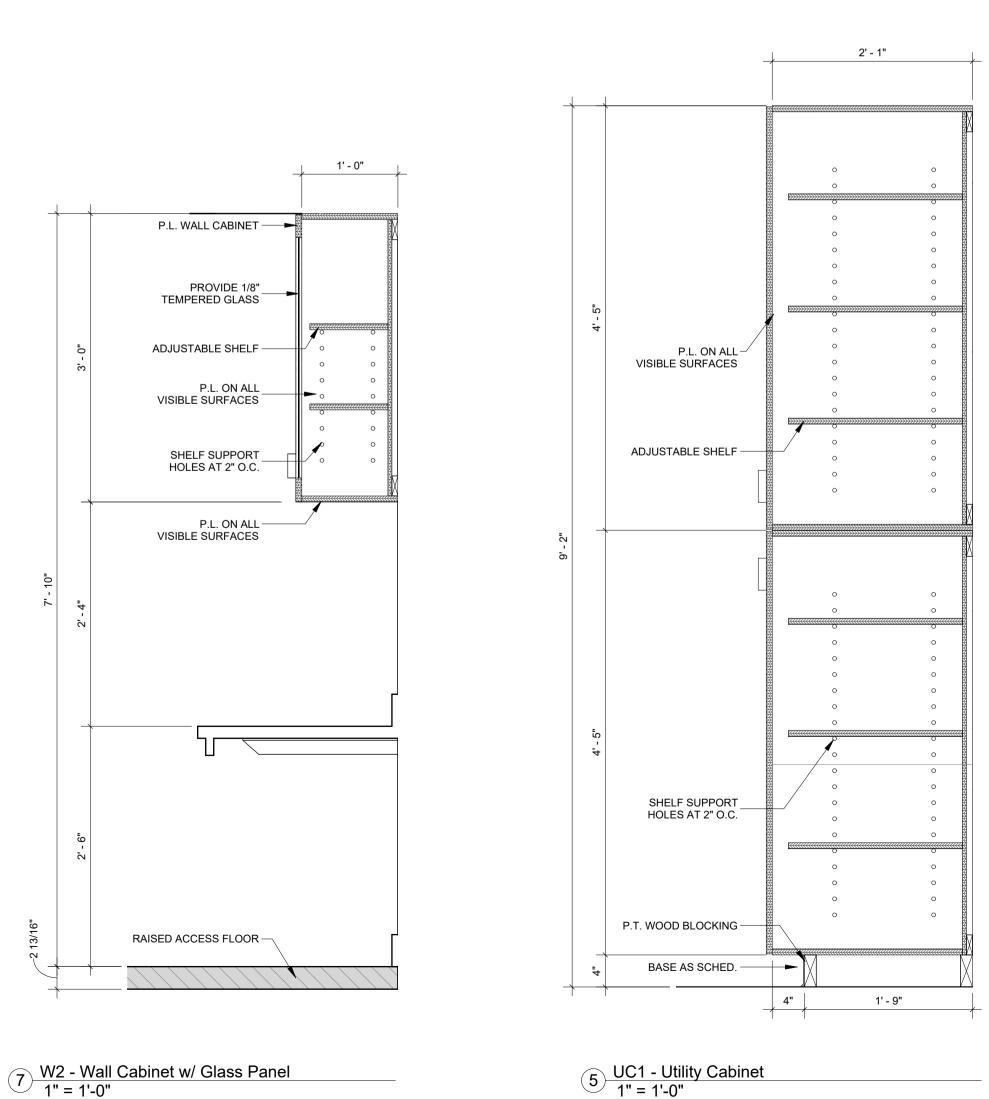

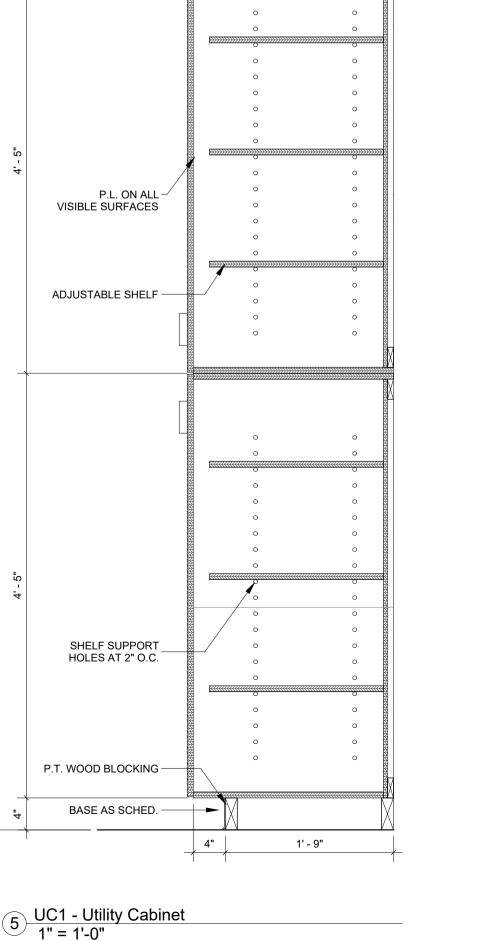



6 UC2 - Utility Cabinet w/ Glass Panel 1" = 1'-0"

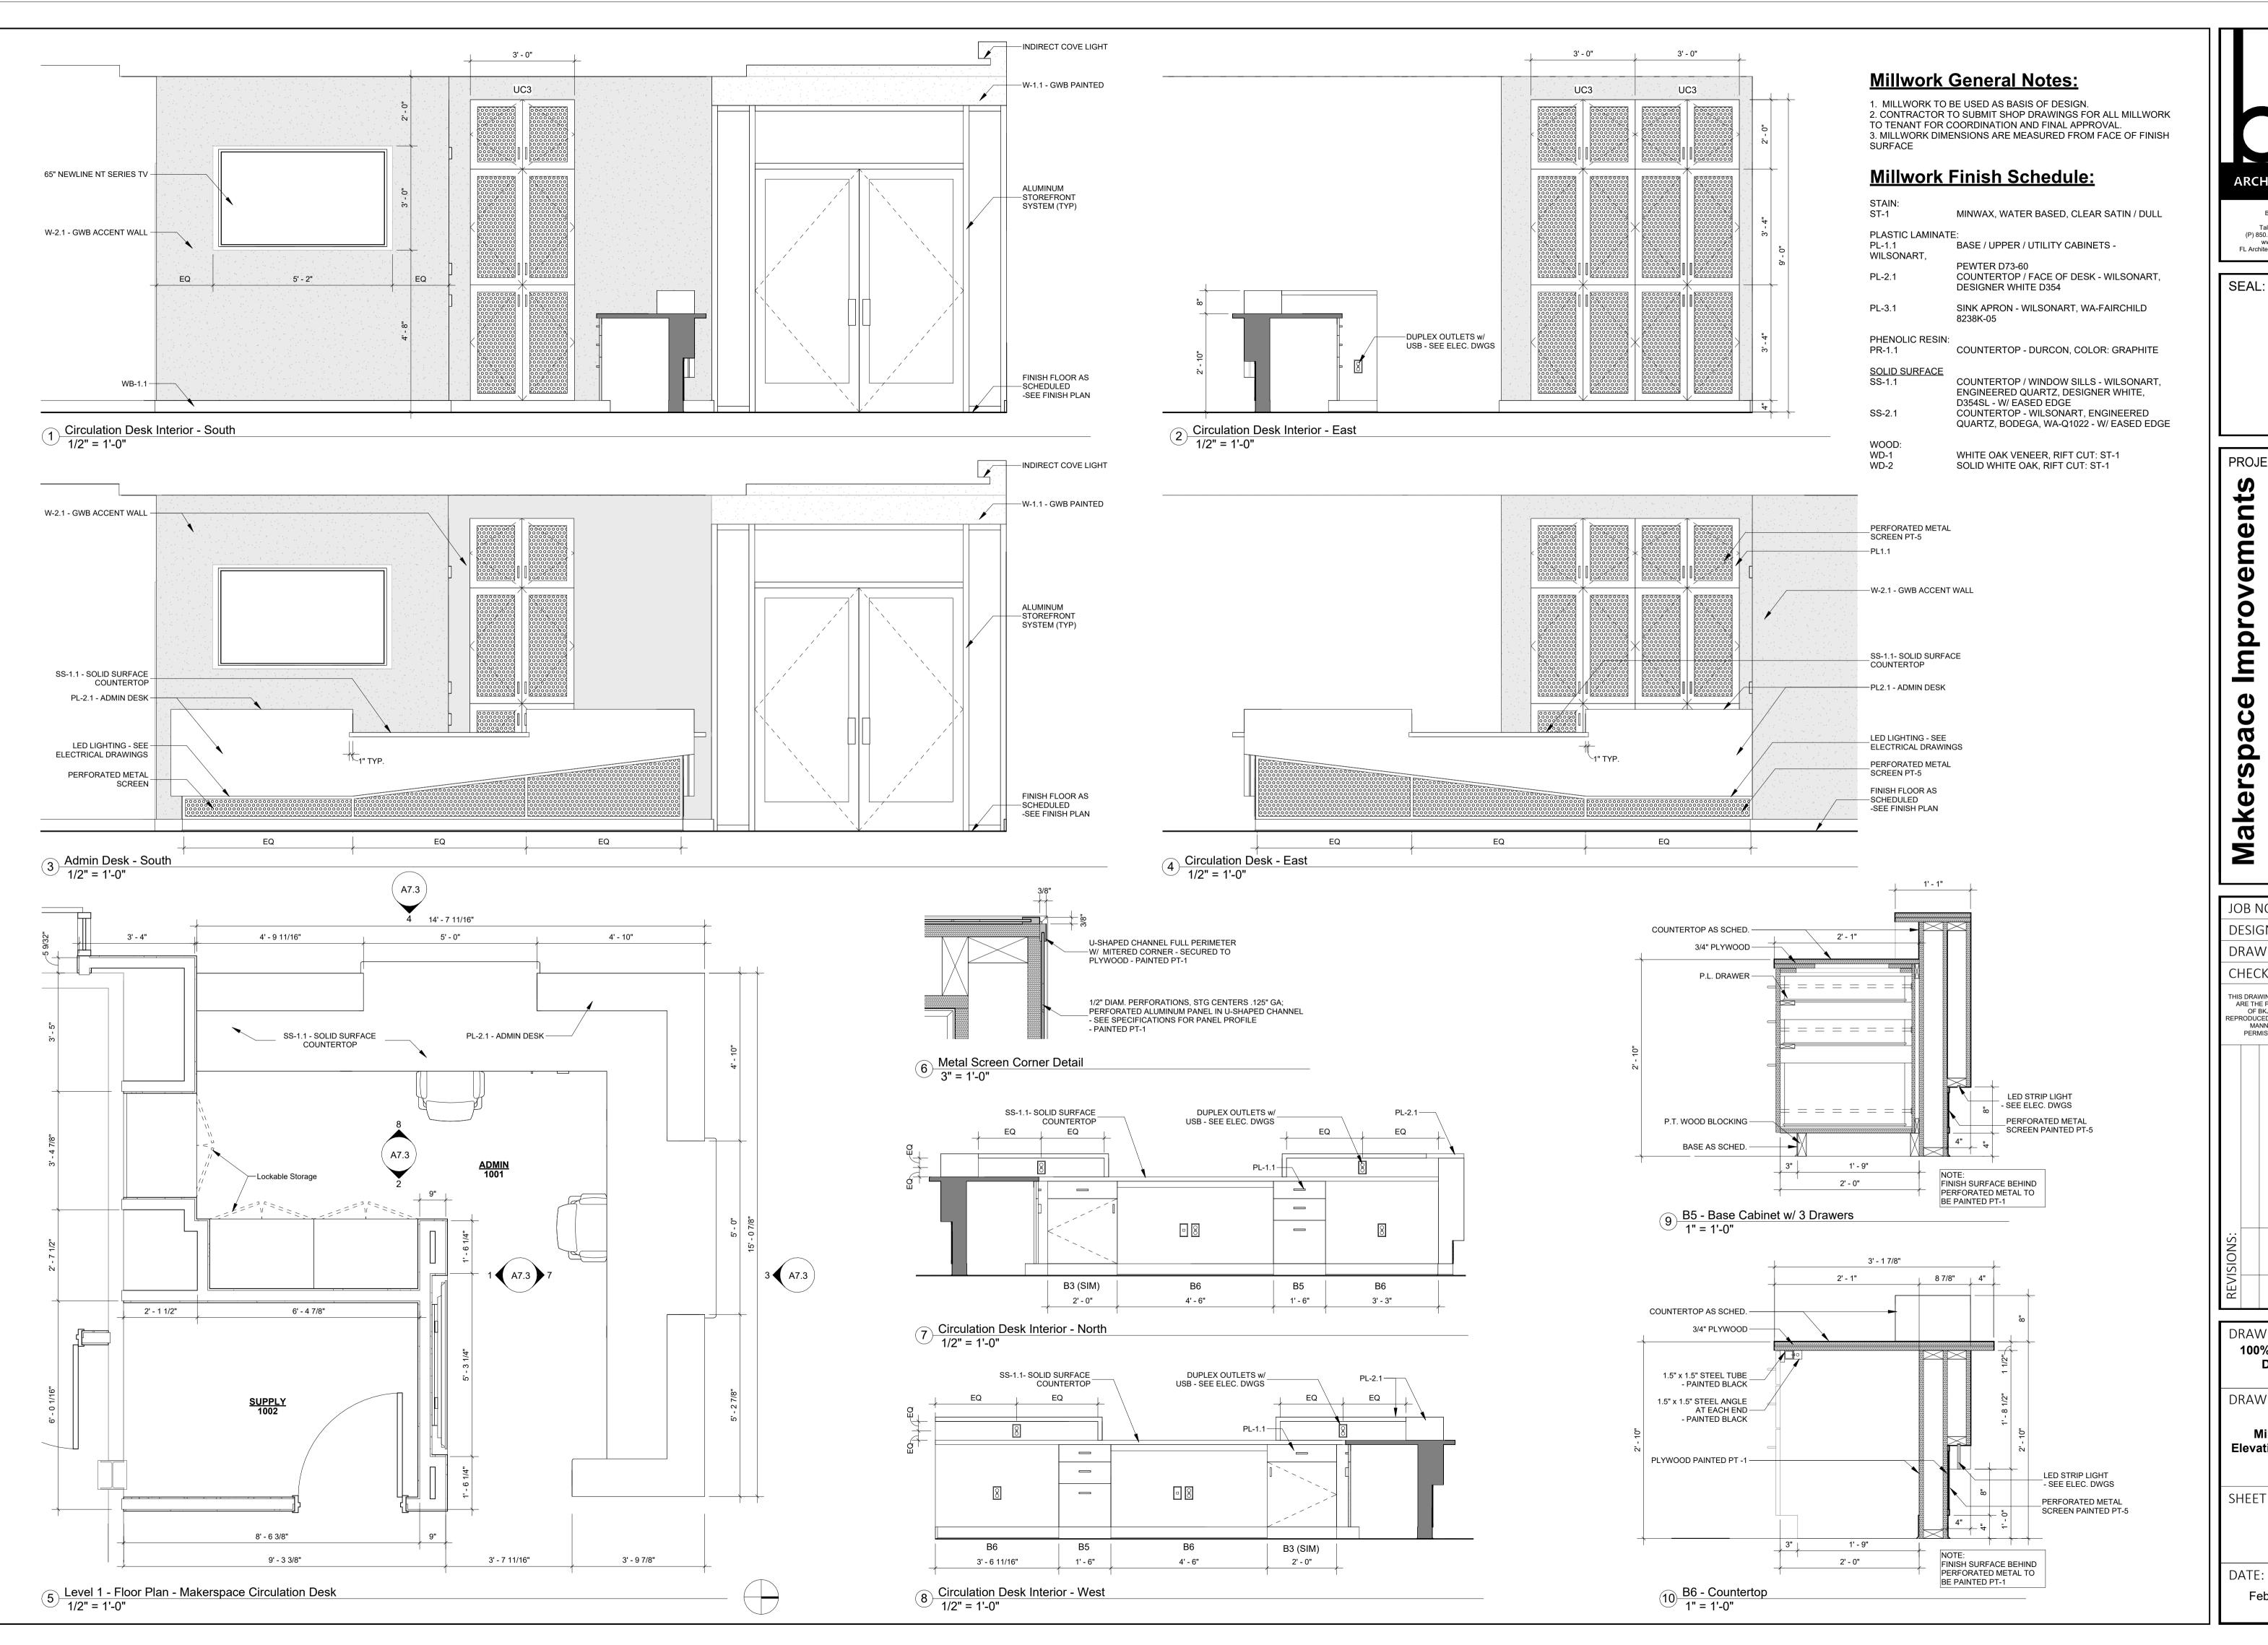



PROJECT TITLE:

4 Appleyalahassee

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DRAWING TITLE:


Millwork Plan, **Elevations & Sections**


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PROJECT TITLE:

Makerspace Improvements 444 Appleyard D Tallahassee, FL

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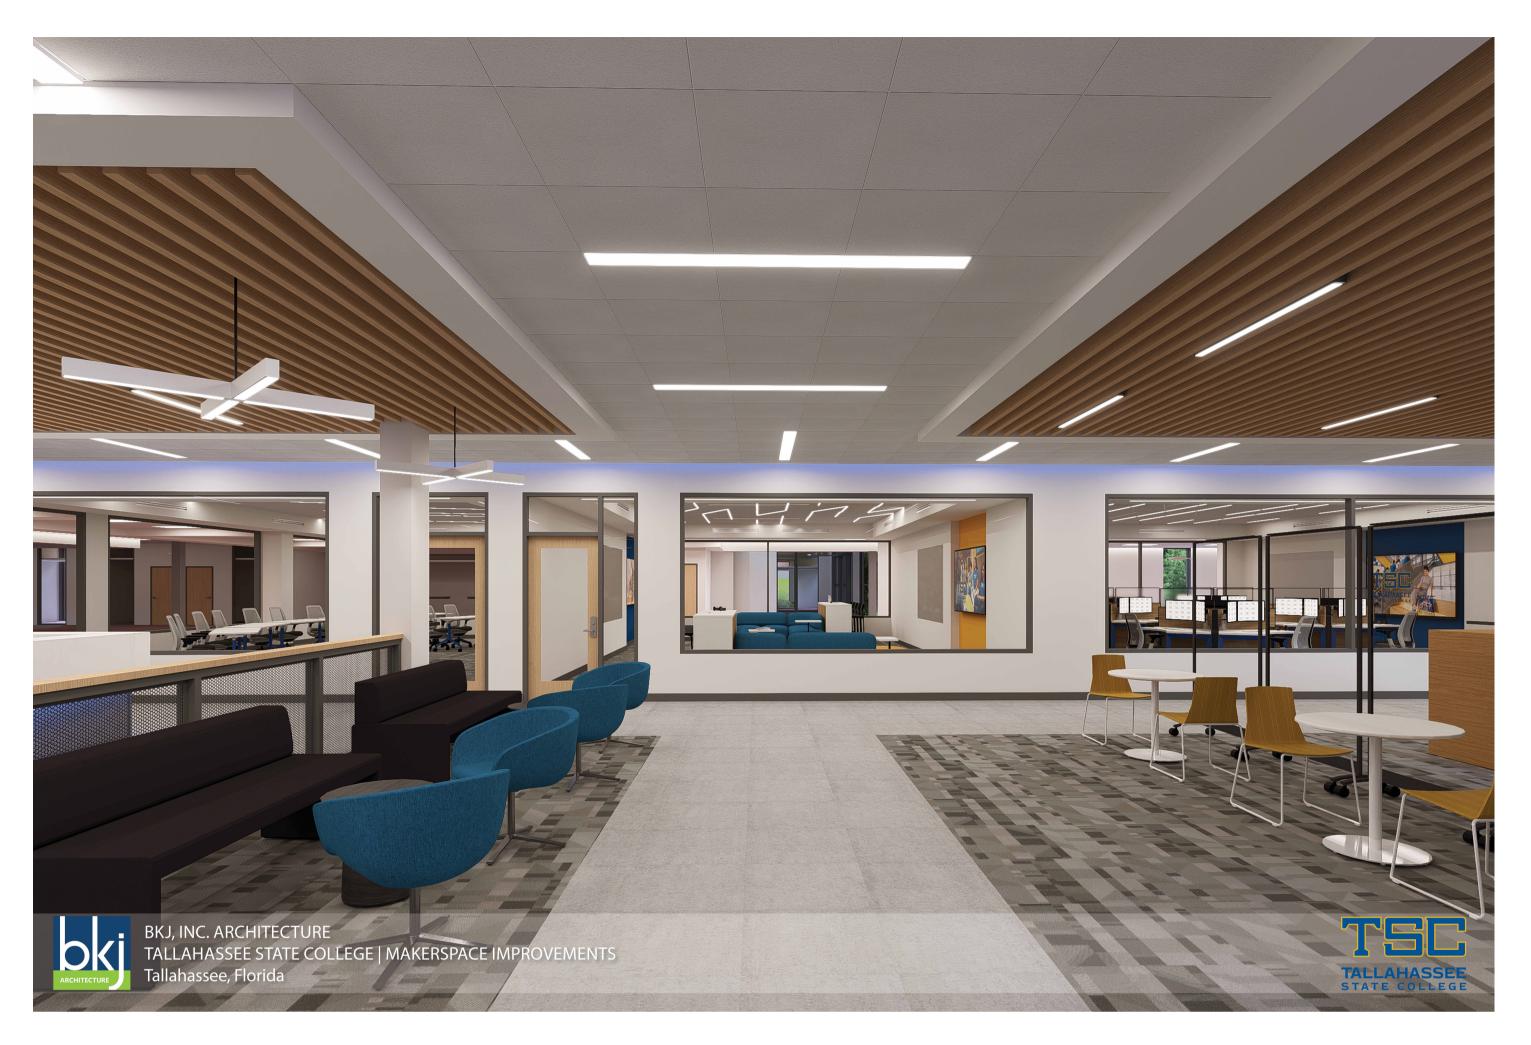
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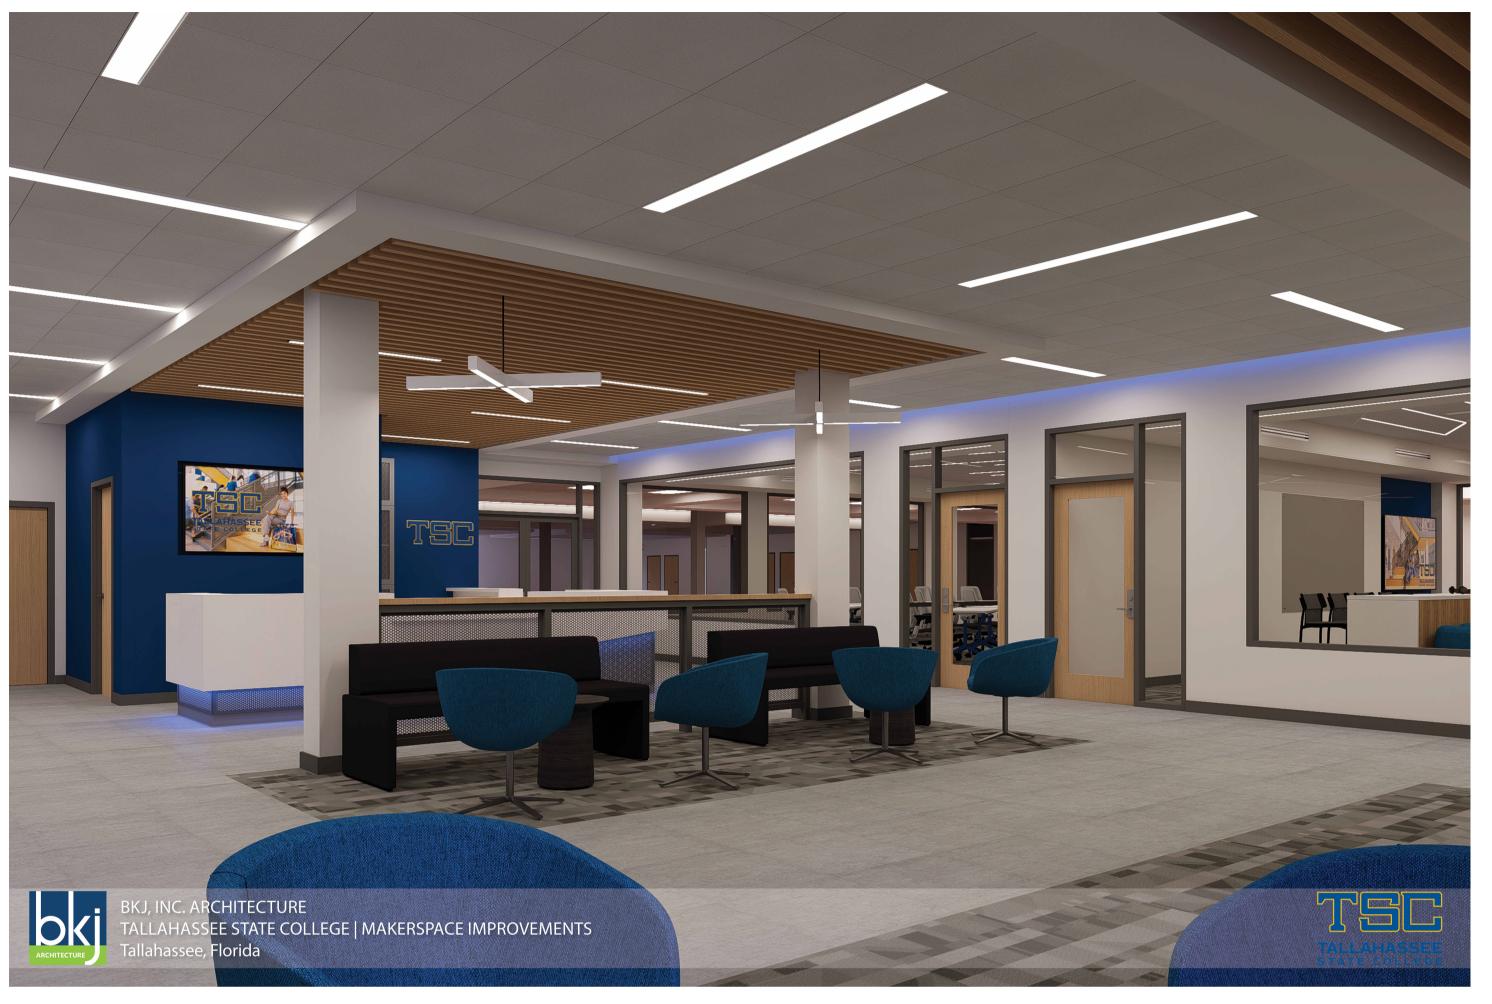
3D Views


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DATE:

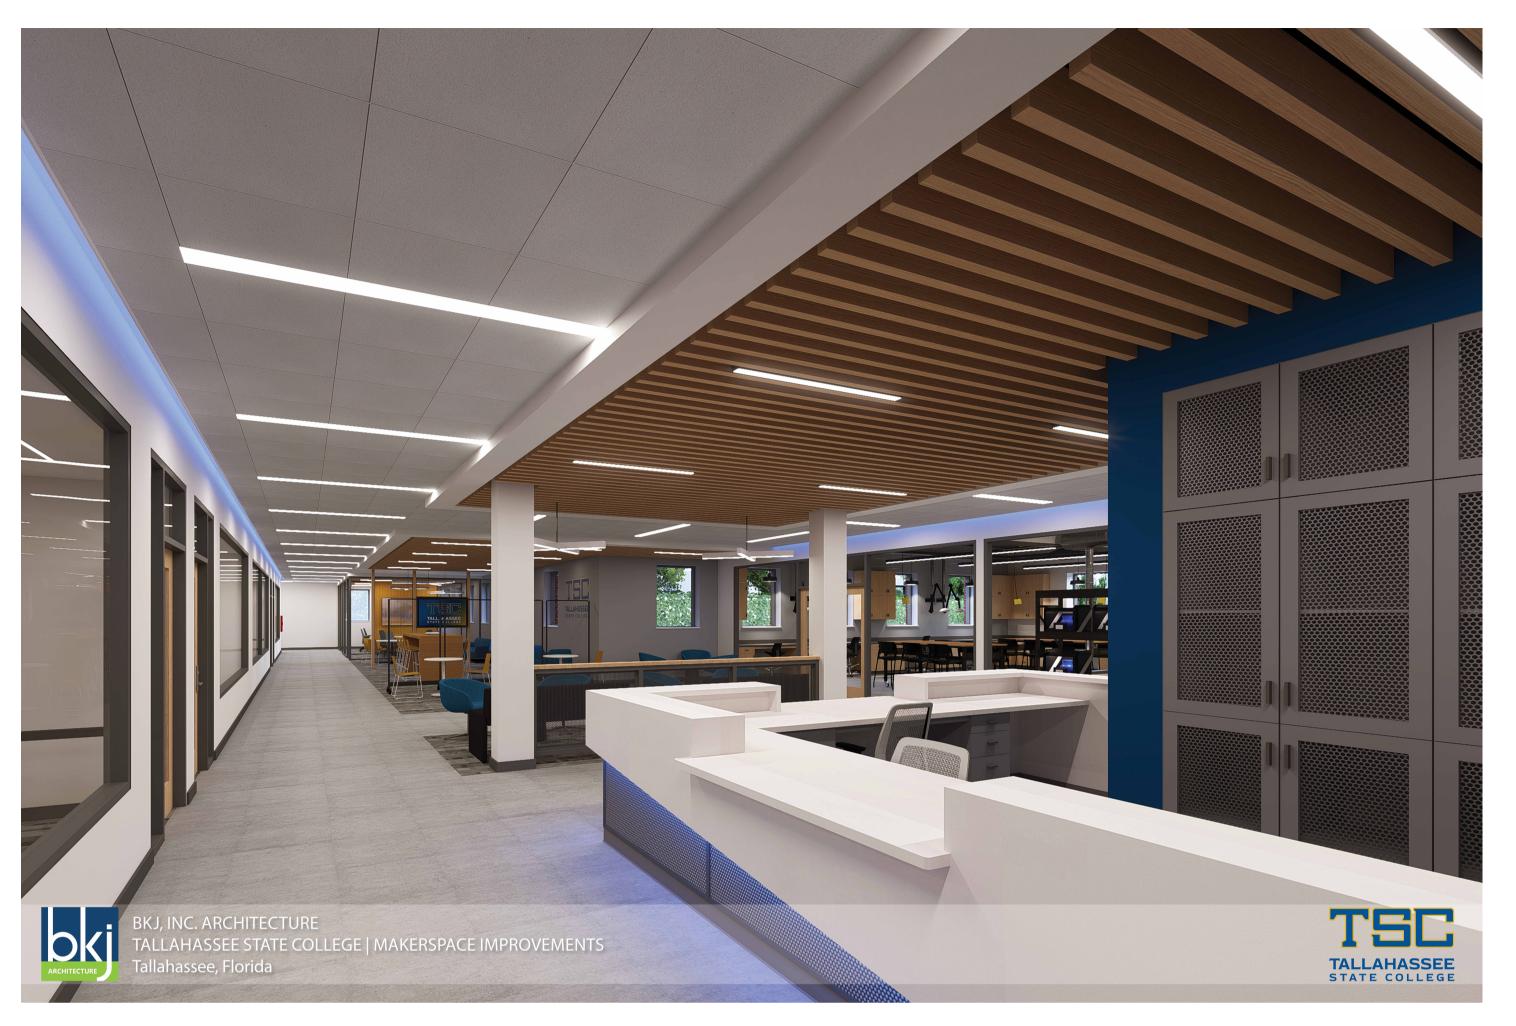

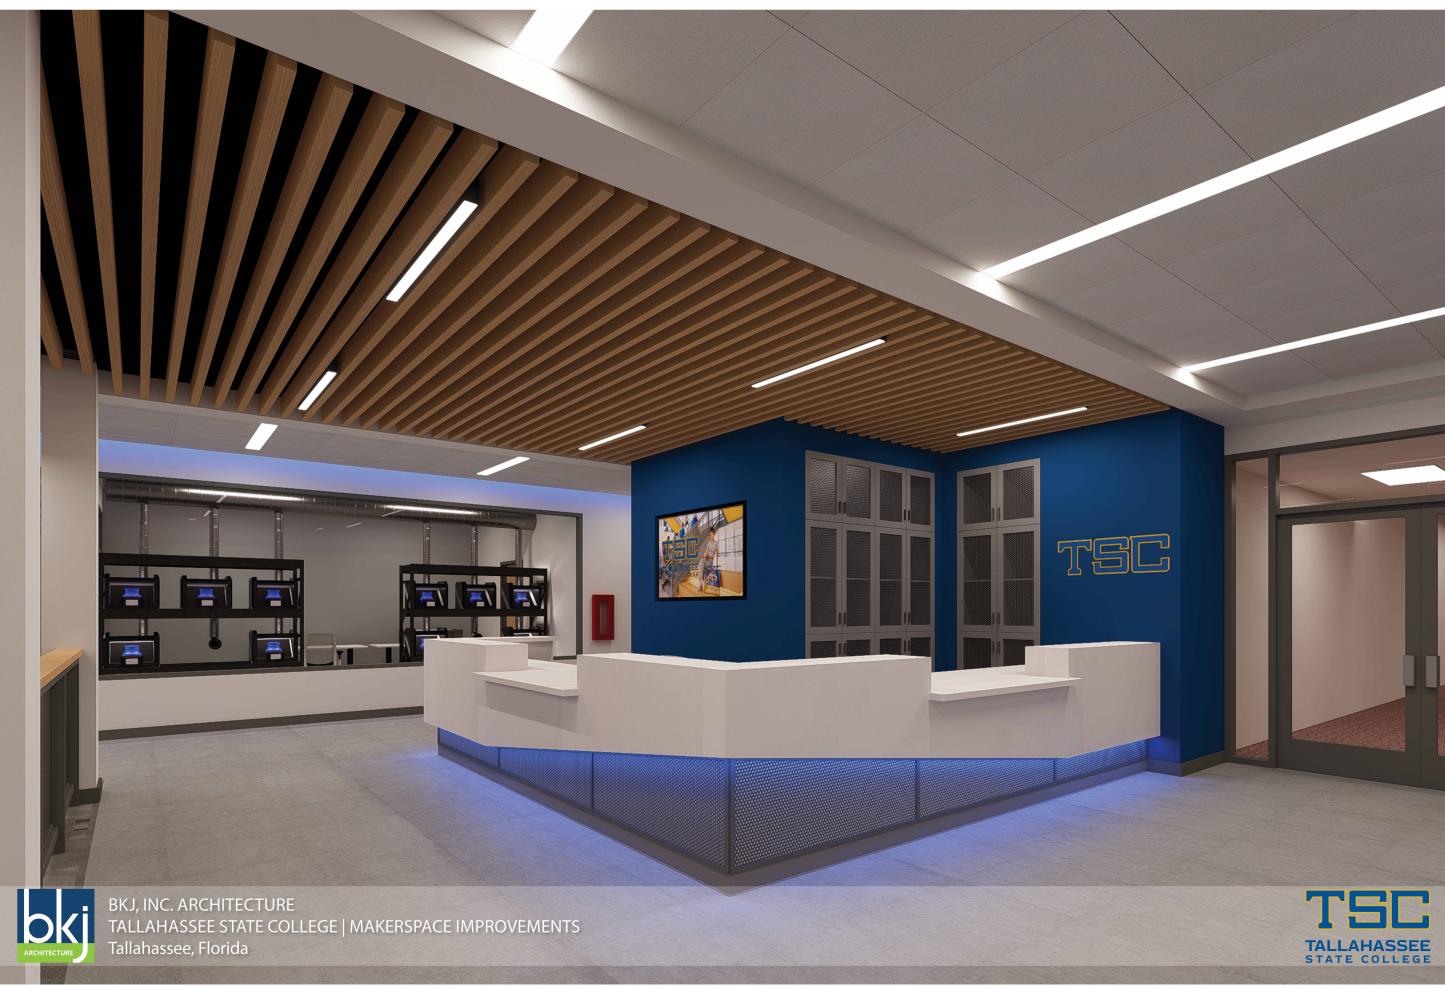





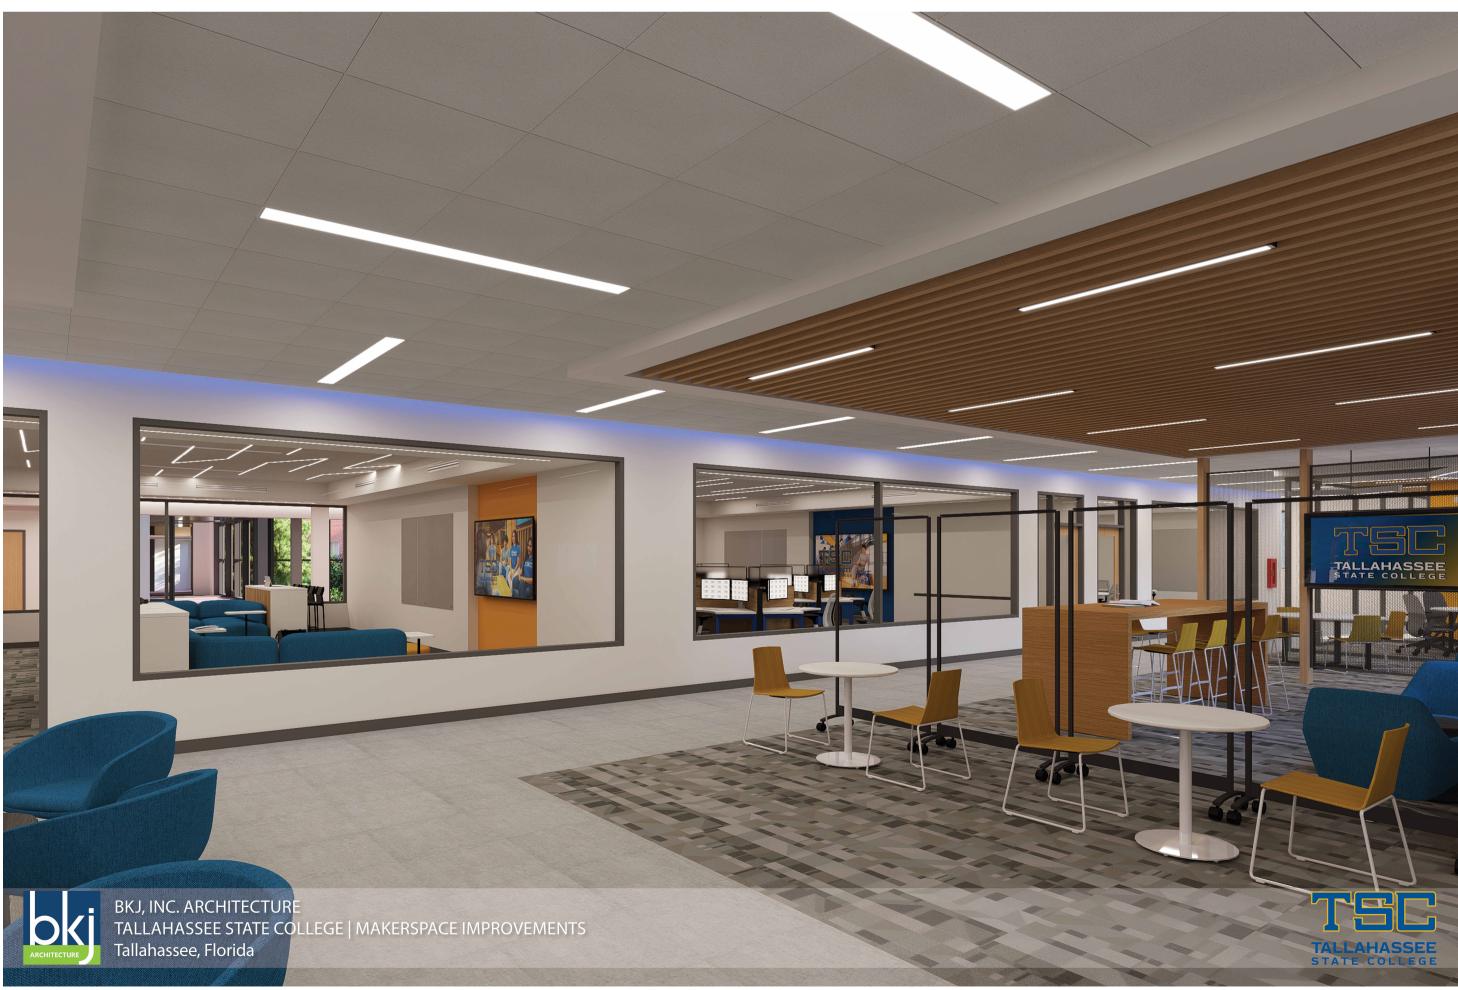

PROJECT TITLE:

Makerspace Improvemer TSC Library - 1st Floor

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3D Views


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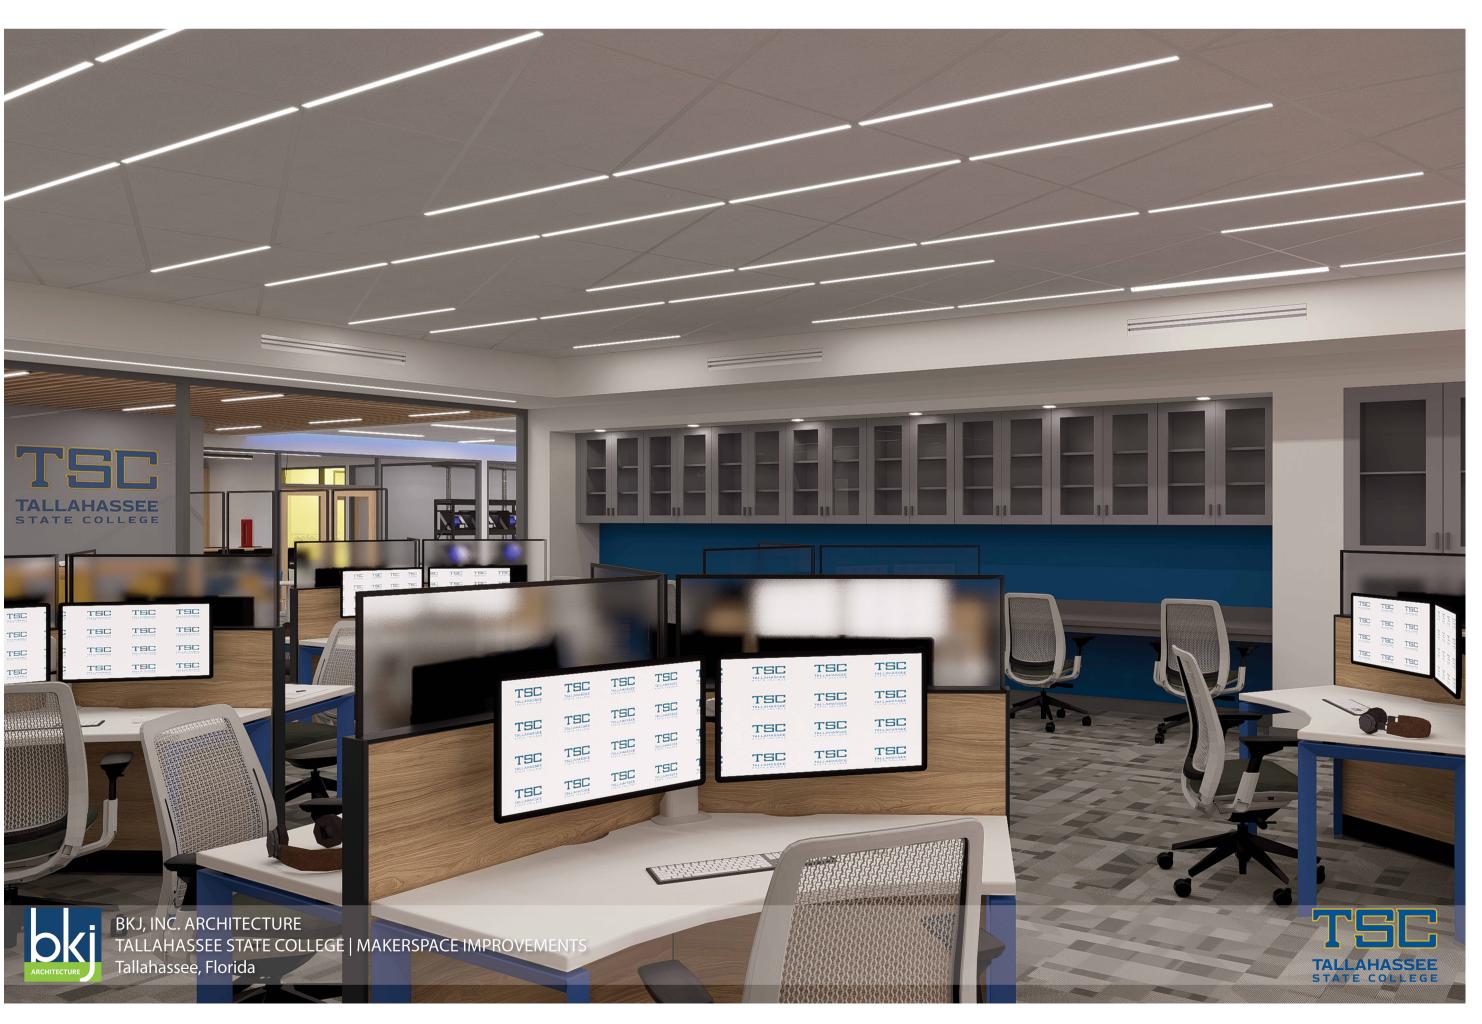
A9.1

DATE: February 7, 2025







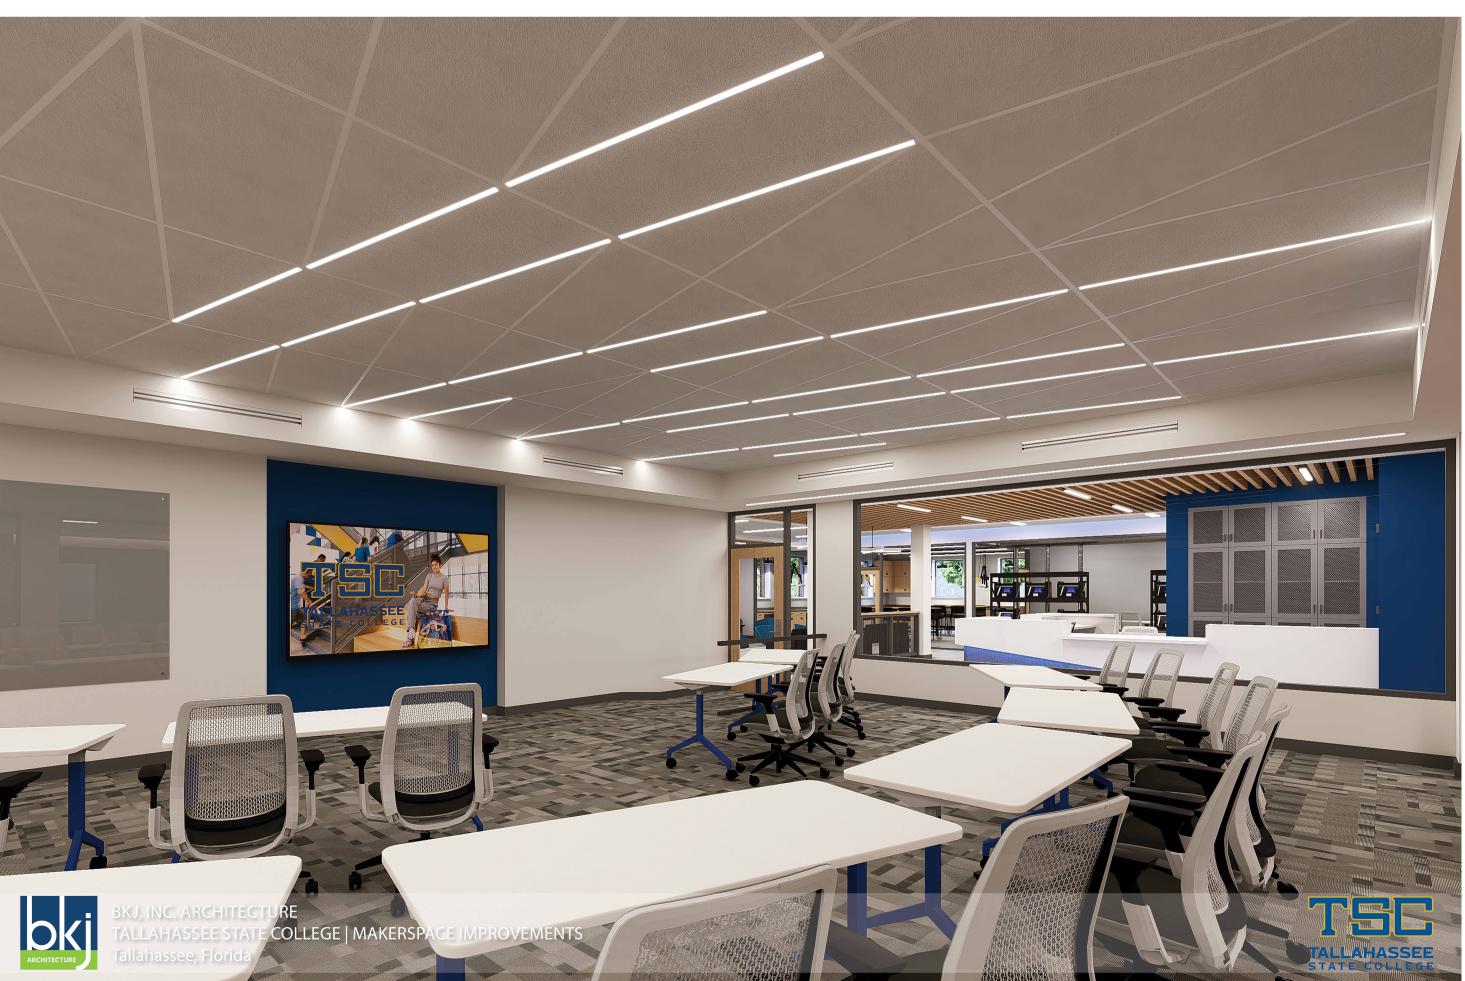



PROJECT TITLE:

Makerspace Improvements 444 Appleyard D Tallahassee, FL TSC

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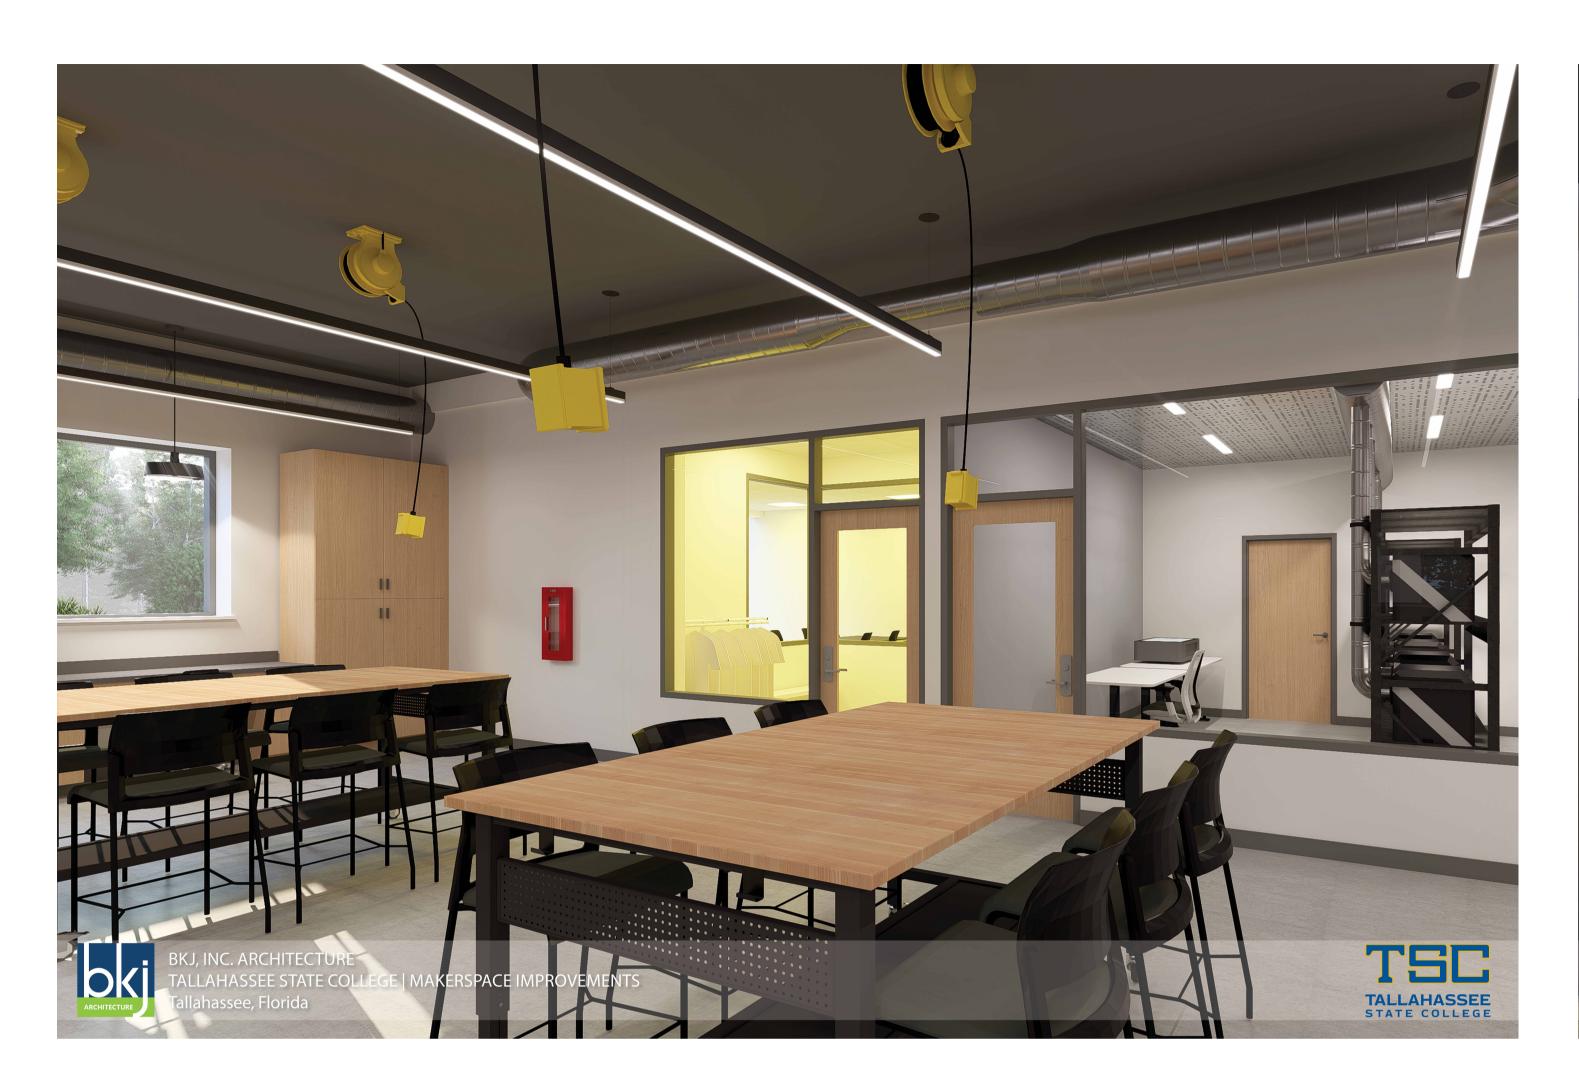
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3D Views

SHEET NO.:


A9.2

DATE: February 7, 2025







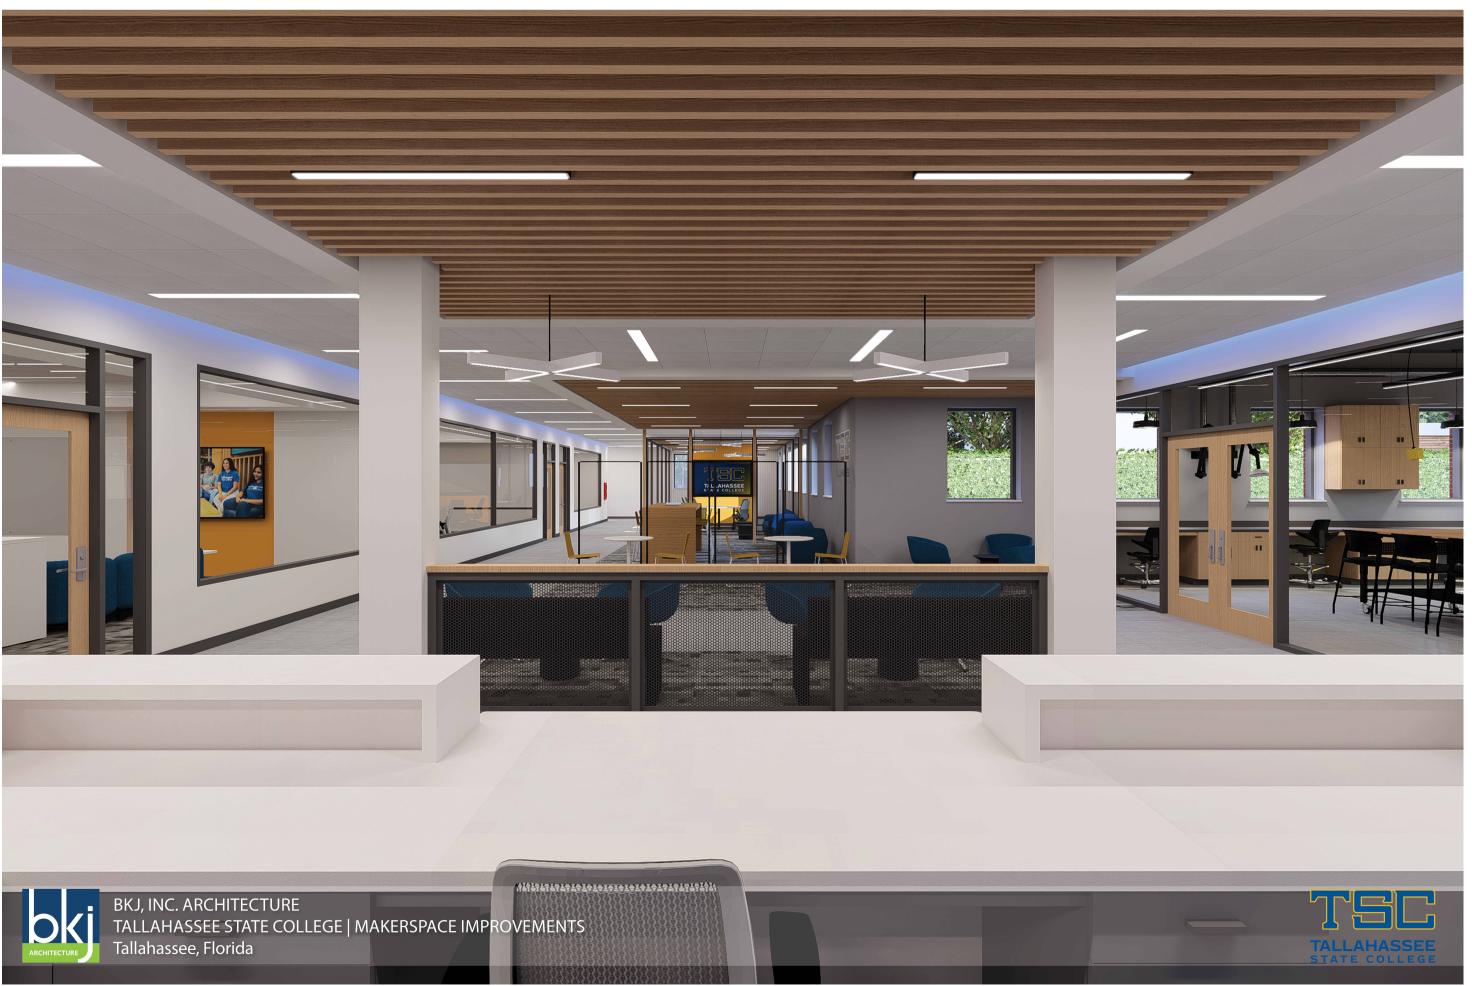



PROJECT TITLE:

nprovements
- 1st Floor

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3D Views

SHEET NO.: **A9.3**

DATE: