


1 ARCHITECTURAL SITE PLAN NOTE: SEE CIVIL SITE PLAN
 SCALE: 3/32" = 1'-0"

- SITE FINISHES**
- [P1] PRECAST CONCRETE PAVER
 - [P2] BRUSHED CONCRETE
 - [L] LANDSCAPE PLANTING

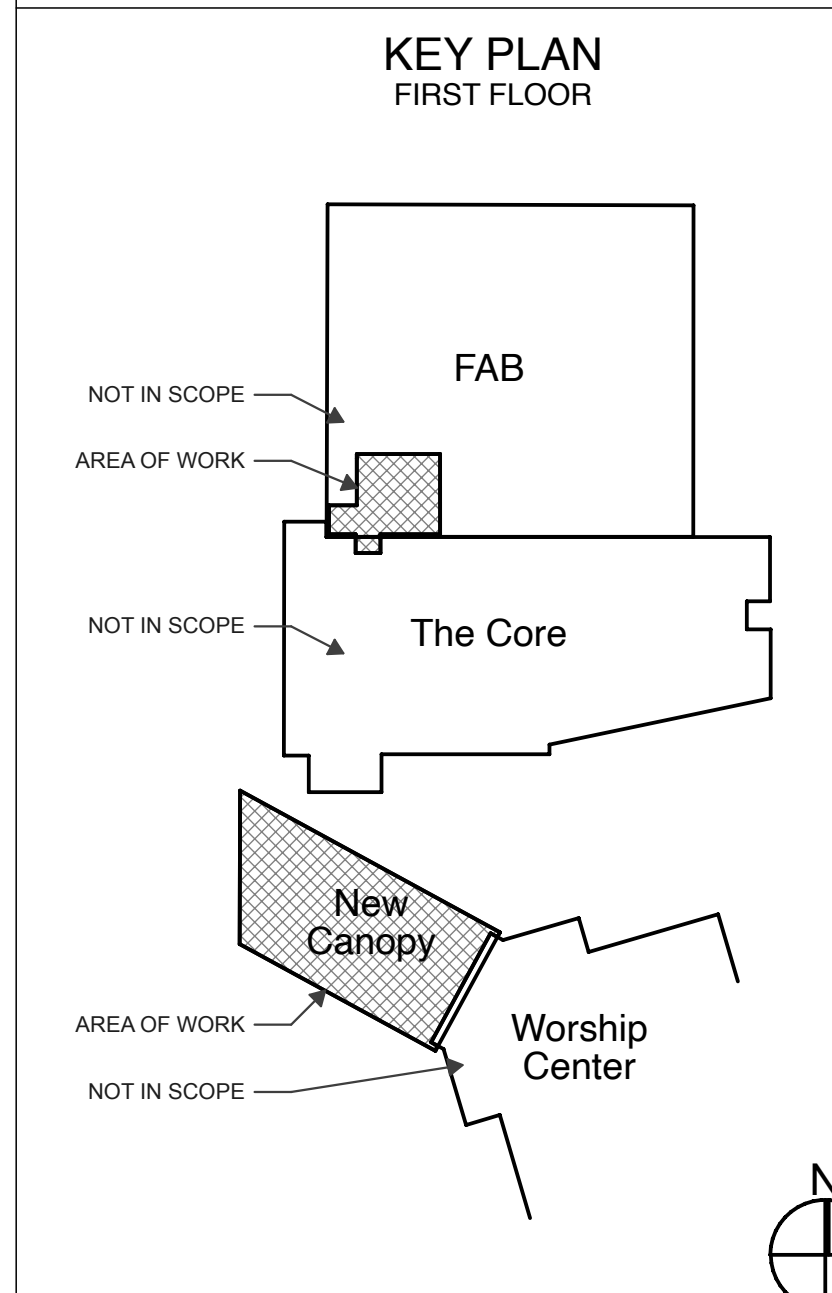

PHASE:	DRAWN:	REVIEWED:	DATE:	ID:	REVISION:	EDITED:	REVIEWED:	DATE:
CONCEPT SCHEM. DESIGN	H. LAYARD	H. LAYARD	08/08/2024					
ADVANCED SCHEM. DESIGN	J. HAYES	H. LAYARD	07/23/2024					
DESIGN DEVELOPMENT	J. HAYES	H. LAYARD	07/23/2024					
CONSTRUCTION DOCS 90%	J. HAYES	H. LAYARD	07/23/2024					
CONSTRUCTION DOCS 100%	J. HAYES	H. LAYARD	07/23/2024					
PERMIT DOCS								

Client: **Celebration Baptist Church**
 3300 Shamrock St. E.
 Tallahassee, FL 32309

Project Title: **Canopy and Corridor Improvements**

Sheet No. **A1.0**

Consultant: Civil
Plainman ENGINEERING

Consultant: MEP
FSM Engineering

Consultant: Structural
KEVER MCKEE ENGINEERING

Architect:
HAYS LAYARD ARCHITECTURE

Seal:



ARCHITECTURAL SITE PLAN

DO NOT SCALE DRAWINGS. THESE DRAWINGS / PLANS, IN PHYSICAL AND/OR DIGITAL FORM, ARE THE COPYRIGHTED PROPERTY OF HAYS LAYARD ARCHITECTURE.


DO NOT SCALE DRAWINGS. Tallahassee, FL 32309

850-727-5367
 kevermckee.com
 1624 Metropolitan Blvd
 Tallahassee, FL 32309

1221 Summer Haven Ct.
 Franklin, TN 37069
 850-558-3613
 hays@hayslayerd.com
 HAYS LAYARD ARCHITECTURE
 FL License: AP06759

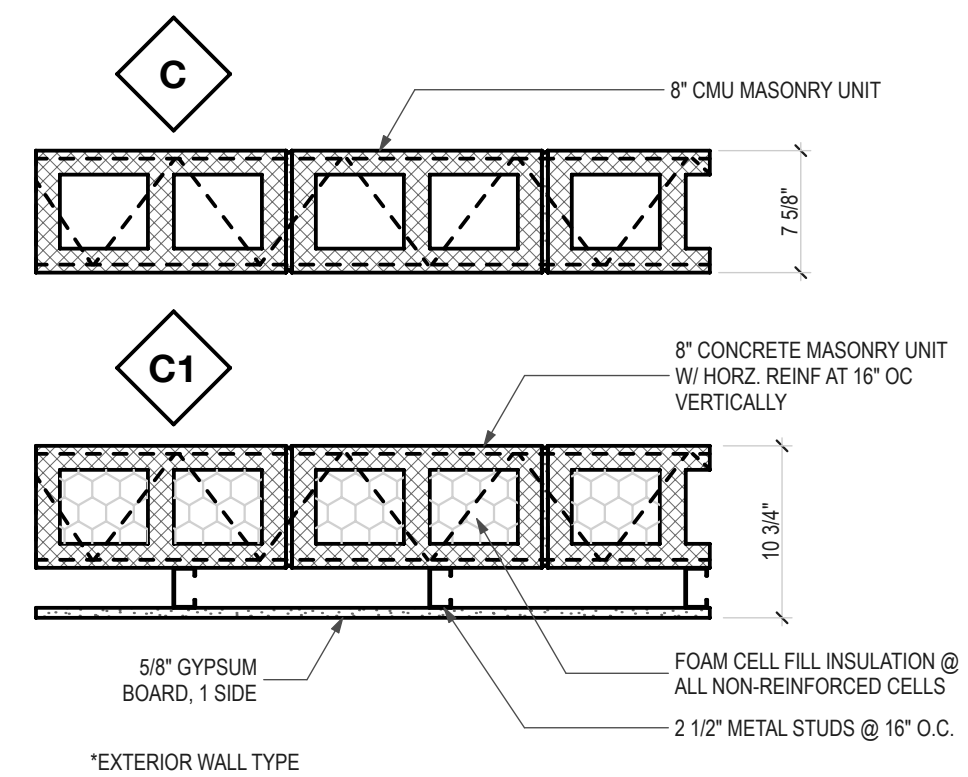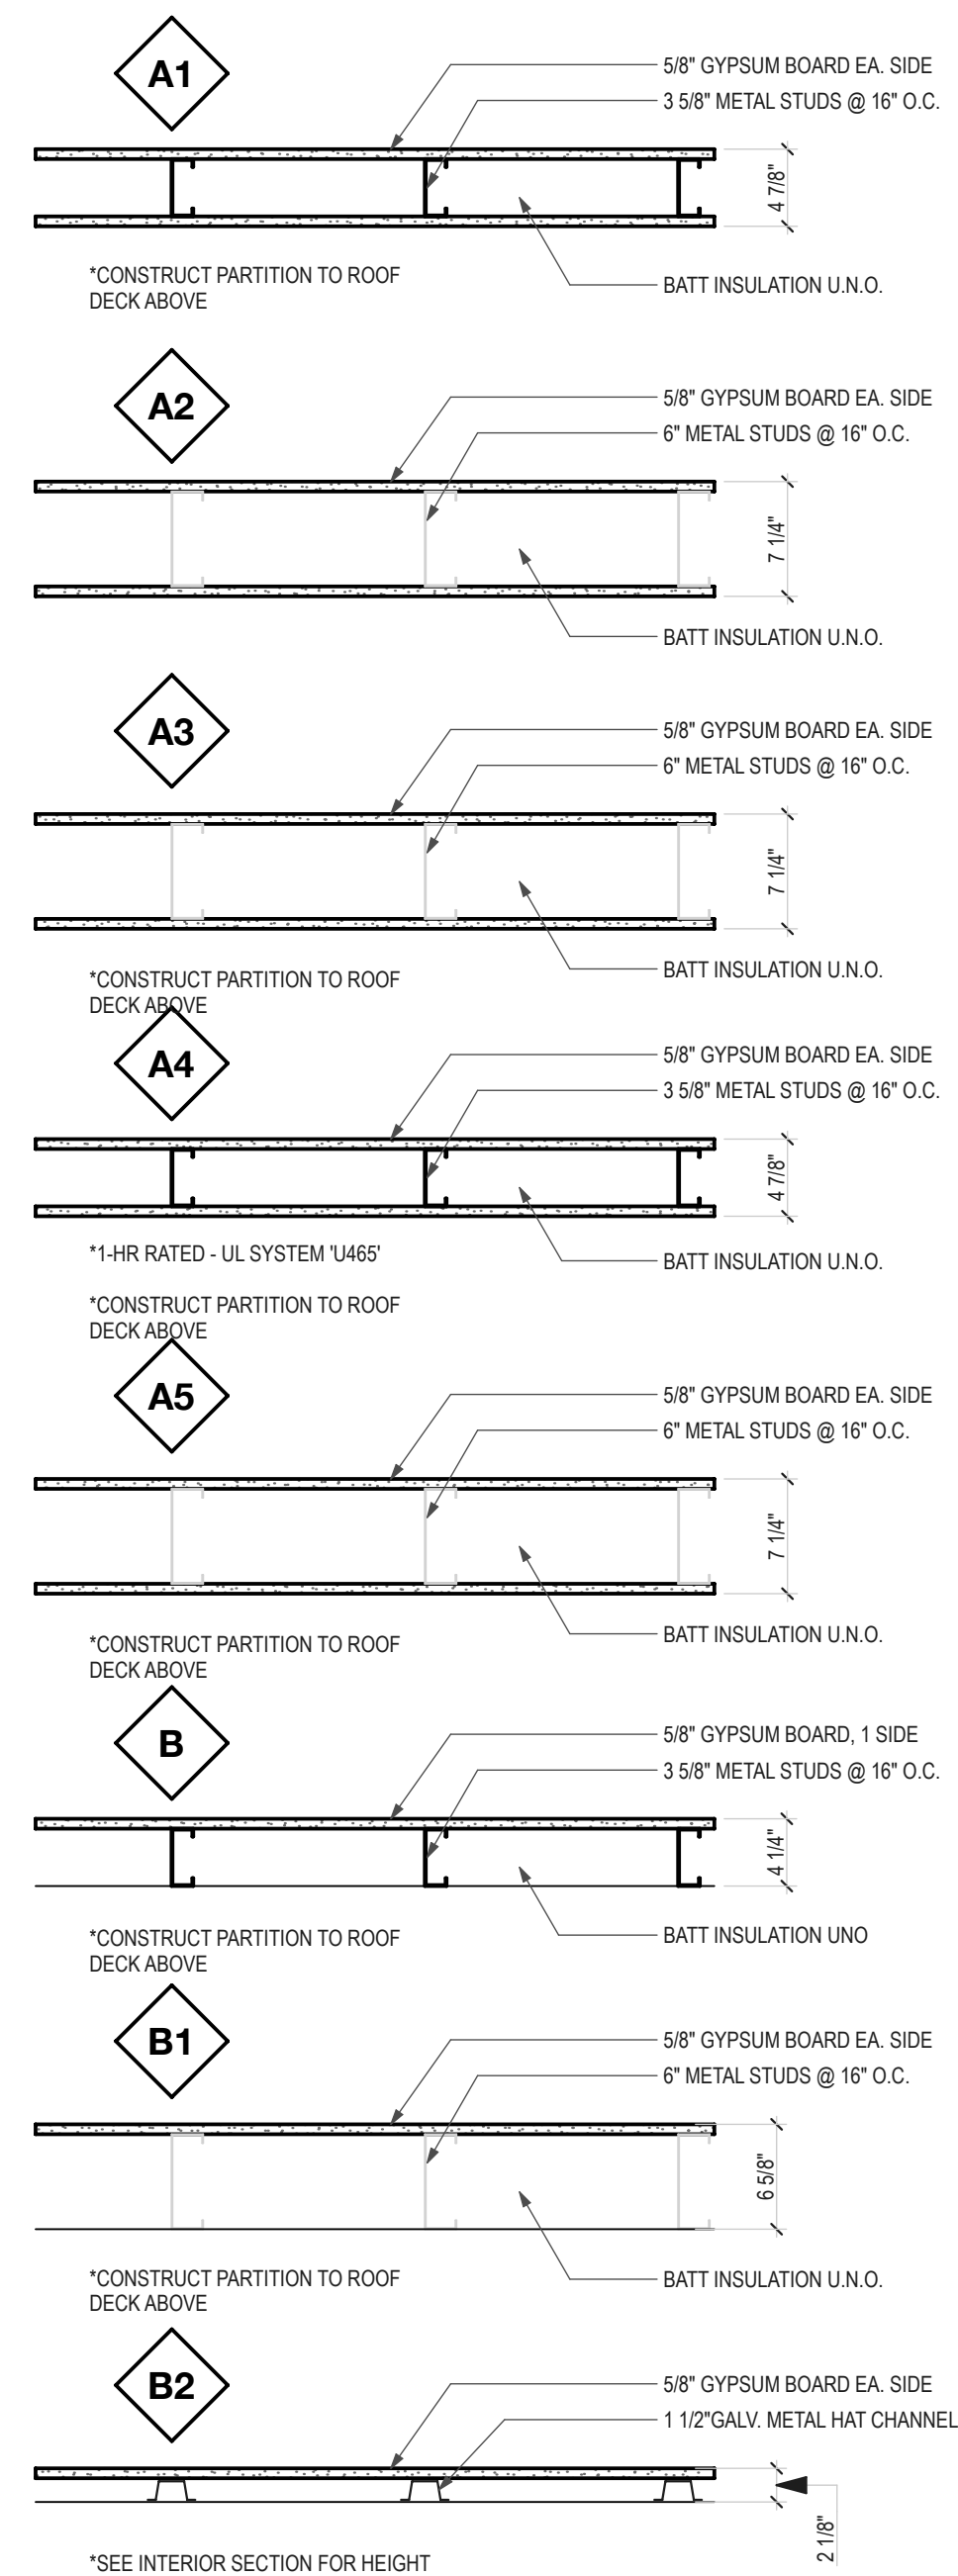

2 PARTITION TYPES
SCALE: 1" = 1'-0"

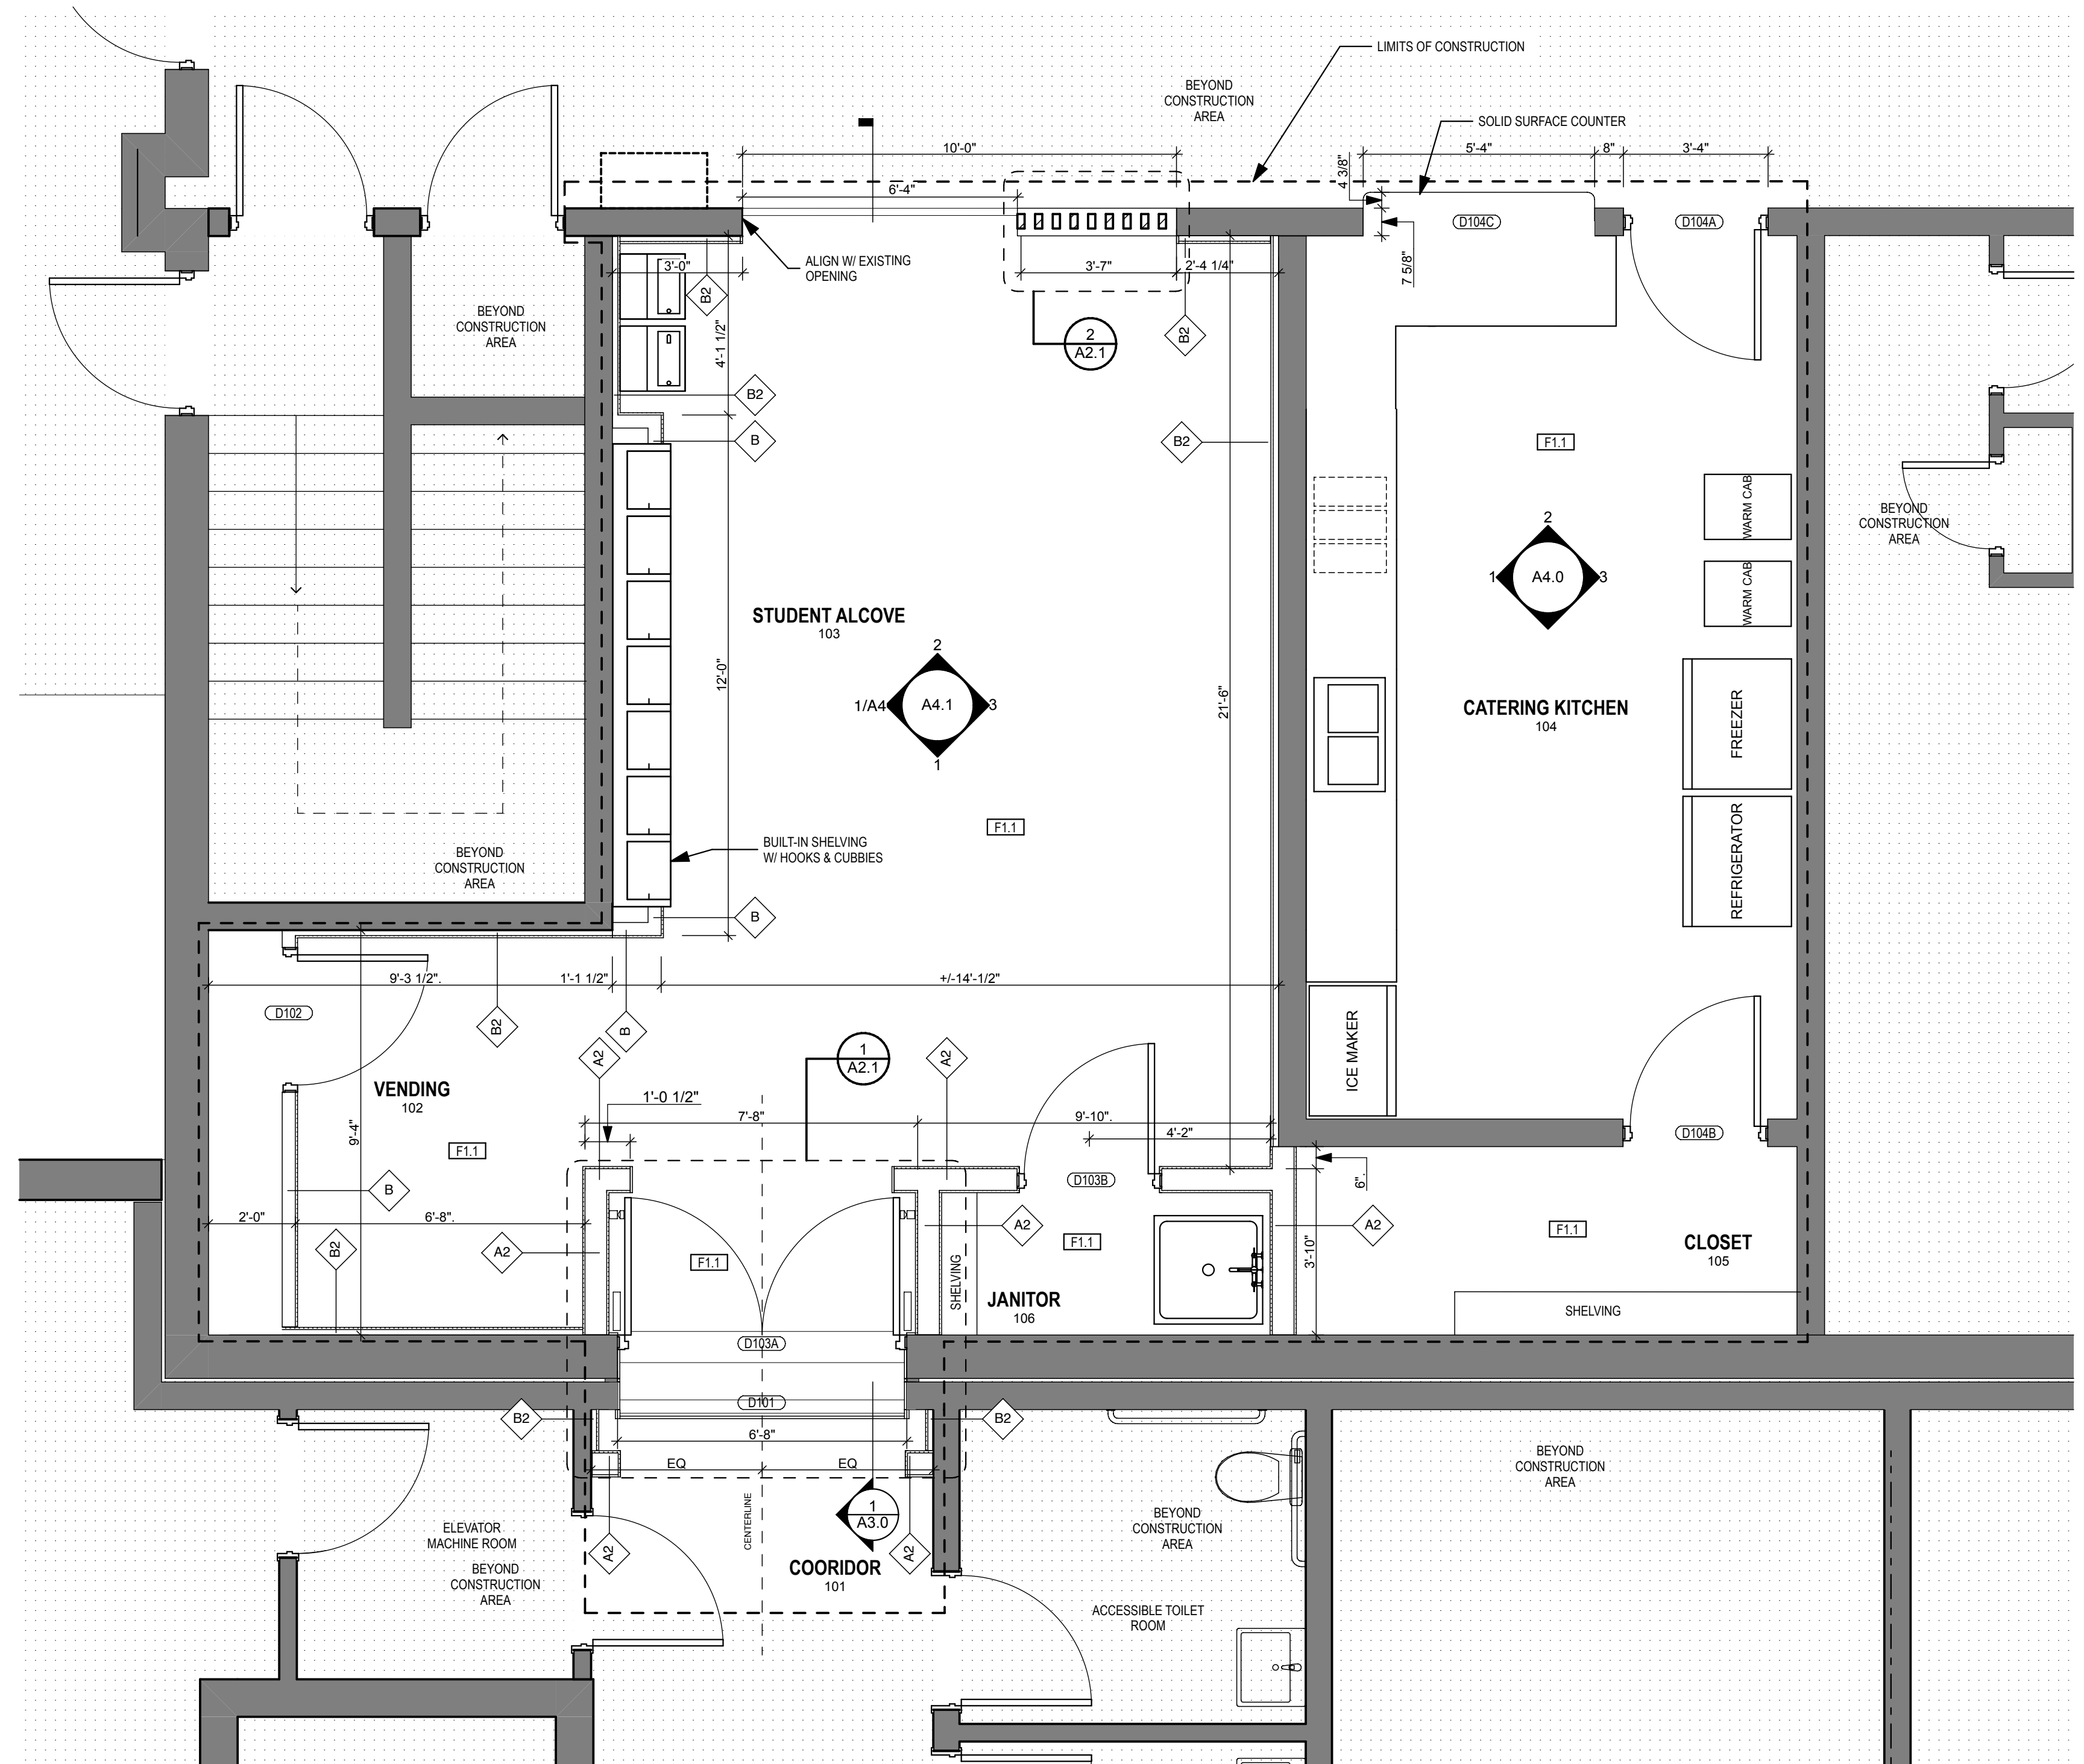


1 FIRST FLOOR
SCALE: 3/8" = 1'-0"

General Construction Notes

1. THE CONTRACTOR SHALL EXAMINE THE SITE AND EXISTING CONDITIONS AND BECOME FAMILIAR WITH ALL CONDITIONS WHICH MAY AFFECT THE WORK, PRIOR TO STARTING.
2. DIMENSIONS INDICATED FOR NEW PARTITIONS ARE TO THE CENTER OR LEADING EDGE OF PARTITION FOR METAL PARTITIONS. MASONRY PARTITIONS ARE TO EDGE OF WALL (OR SLAB EDGE).
3. ALL NEW WALL SURFACES SHALL BE FINISHED AND PAINTED PER SPECIFICATIONS.
4. CLEAN AND PREP ALL AREAS WITHIN SCOPE OF WORK TO RECEIVE NEW FINISHES.
5. DIMENSIONS INDICATED FOR EX. CONSTRUCTION ARE ACCURATE TO +/- 1".
6. CONTRACTOR SHALL PATCH AND REPAIR ALL WALLS THAT ARE IMPACTED BY MECHANICAL AND/OR ELECTRICAL CONDUIT, PIPING, AND ALL OTHER MISC. DEVICES.
7. ALL WORK IS TO BE LAID OUT TRUE, SQUARE, AND PLUMB, AND TO EXACT AND CORRECT DIMENSIONS. IF DIMENSIONAL DISCREPANCIES ARE DISCOVERED, THE CONTRACTOR MUST NOTIFY THE OWNER AND THE ARCHITECT IN WRITING PRIOR TO PROCEEDING. THE ARCHITECT WILL ISSUE A DIMENSIONAL OR LAYOUT CORRECTION.
8. THE CONTRACTOR IS RESPONSIBLE FOR COORDINATION OF ALL TRADES AND WORK, INCLUDING WORK OF OTHERS WHERE AFFECTED.
9. THE CONTRACTOR SHALL PROVIDE BARRICADES, DUST CONTROL, TEMPORARY POWER, LIGHTING, TELEPHONE SERVICE, ETC. AS REQUIRED TO COMPLETE THE WORK.
10. THE CONTRACTOR SHALL MAINTAIN A FULL SET OF COMPLETE AND CURRENT DRAWINGS AVAILABLE FOR REVIEW AT THE JOB SITE AT ALL TIMES. ALL FIELD MODIFICATIONS TO THE ORIGINAL DESIGN DOCUMENTS SHALL BE NOTED AND MAINTAINED FOR THE OWNER'S RECORD COPY.
11. ALL EXISTING FIRE EXTINGUISHERS TO BE REUSED IN CONSTRUCTION SHALL BE RE-CERTIFIED BEFORE REINSTALLATION.

Construction Notes

1. CUSTOM MILLWORK AND CABINERY. SEE ELEVATIONS AND DETAILS
2. 20" DEEP VINYL-COATED WIRE SHELVING SPACED AT 1'-6" O.C. VERTICAL
3. DOOR THRESHOLD / TRANSITION STRIP
4. GYP. BULKHEAD / CLG. ACCENT ABOVE. SEE REFLECTED CLG. PLAN
5. FIRE EXTENSION CABINET - PARTIALLY RECESSED
6. JANITOR'S WASH SINK. SEE PLUMBING DWGS
7. INTERIOR SIGNAGE/ GRAPHICS MOUNTED TO PREP FOR FUTURE SIGNAGE / GRAPHICS
8. ACCESSIBLE HIGH / LOW WALL-MOUNTED DRINKING FOUNTAIN
9. DOOR ELECTRONIC HOLD-OPENS - SEE ELEC. DWGS.
10. 90-MINUTE RATED DOOR
11. 90-MINUTE RATED FIRE CURTAIN
12. ALTERNATE - WOOD SLAT ACCENT WALL. SEE ELEVATION
13. ROLL-UP WINDOW / DOOR
14. GYP. BULKHEAD ABOVE

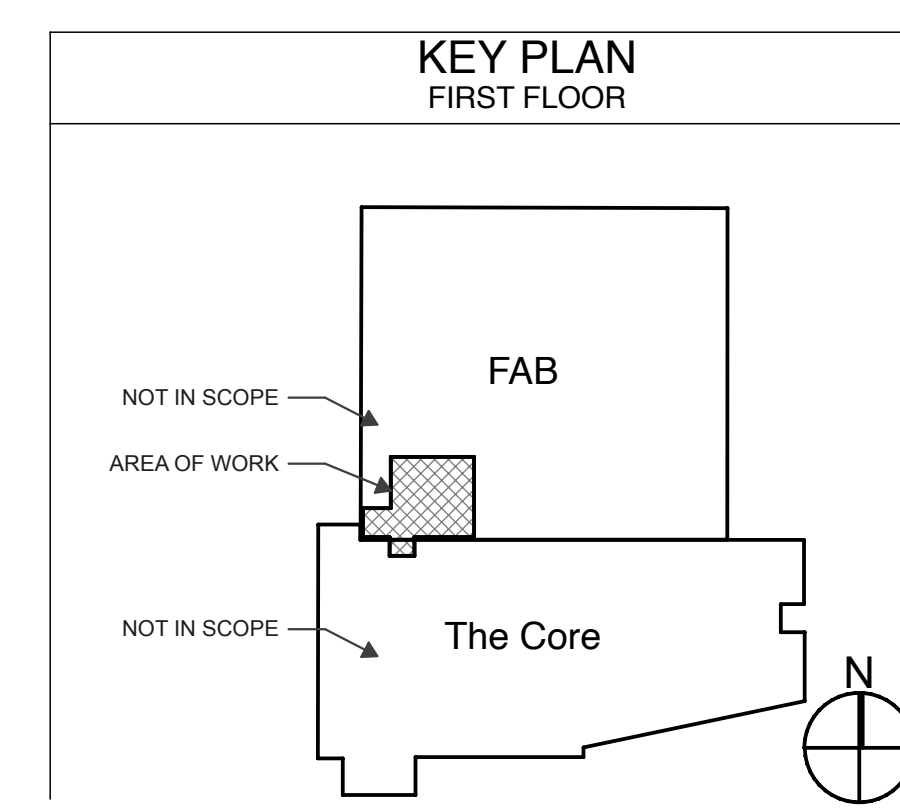


Consultant: Civil Plainman ENGINEERING 850-227-5367 kevern@plainman.com 1624 Metropolitan Blvd Tallahassee, FL 32309	Consultant: MEP FSM Engineering 850-227-5367 fsm@fsme.com 1624 Metropolitan Blvd Tallahassee, FL 32309	Consultant: Structural KM KEVER MCKEE ENGINEERING 850-727-5367 kevern@kme.com 1624 Metropolitan Blvd Tallahassee, FL 32309	Architect: HAYS LAYER ARCHITECTURE 1221 Summer Haven Cir. Franklin, TN 37069 615-559-3613 hays@hayslayer.com FL License: AP096759	Seal: HAYS LAYER ARCHITECTURE
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ADVANCED SCHEM. DESIGN	R. LAYERS	R. LAYERS	07/22/2024
DESIGN DEVELOPMENT	J. HAYES	J. HAYES	07/22/2024
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PERMIT DOCS	J. HAYES	J. HAYES	07/22/2024


Client:
Celebration Baptist Church
3300 Shamrock St. E.
Tallahassee, FL 32309

Project Title:
Canopy and Corridor Improvements

Sheet No.
A2.0

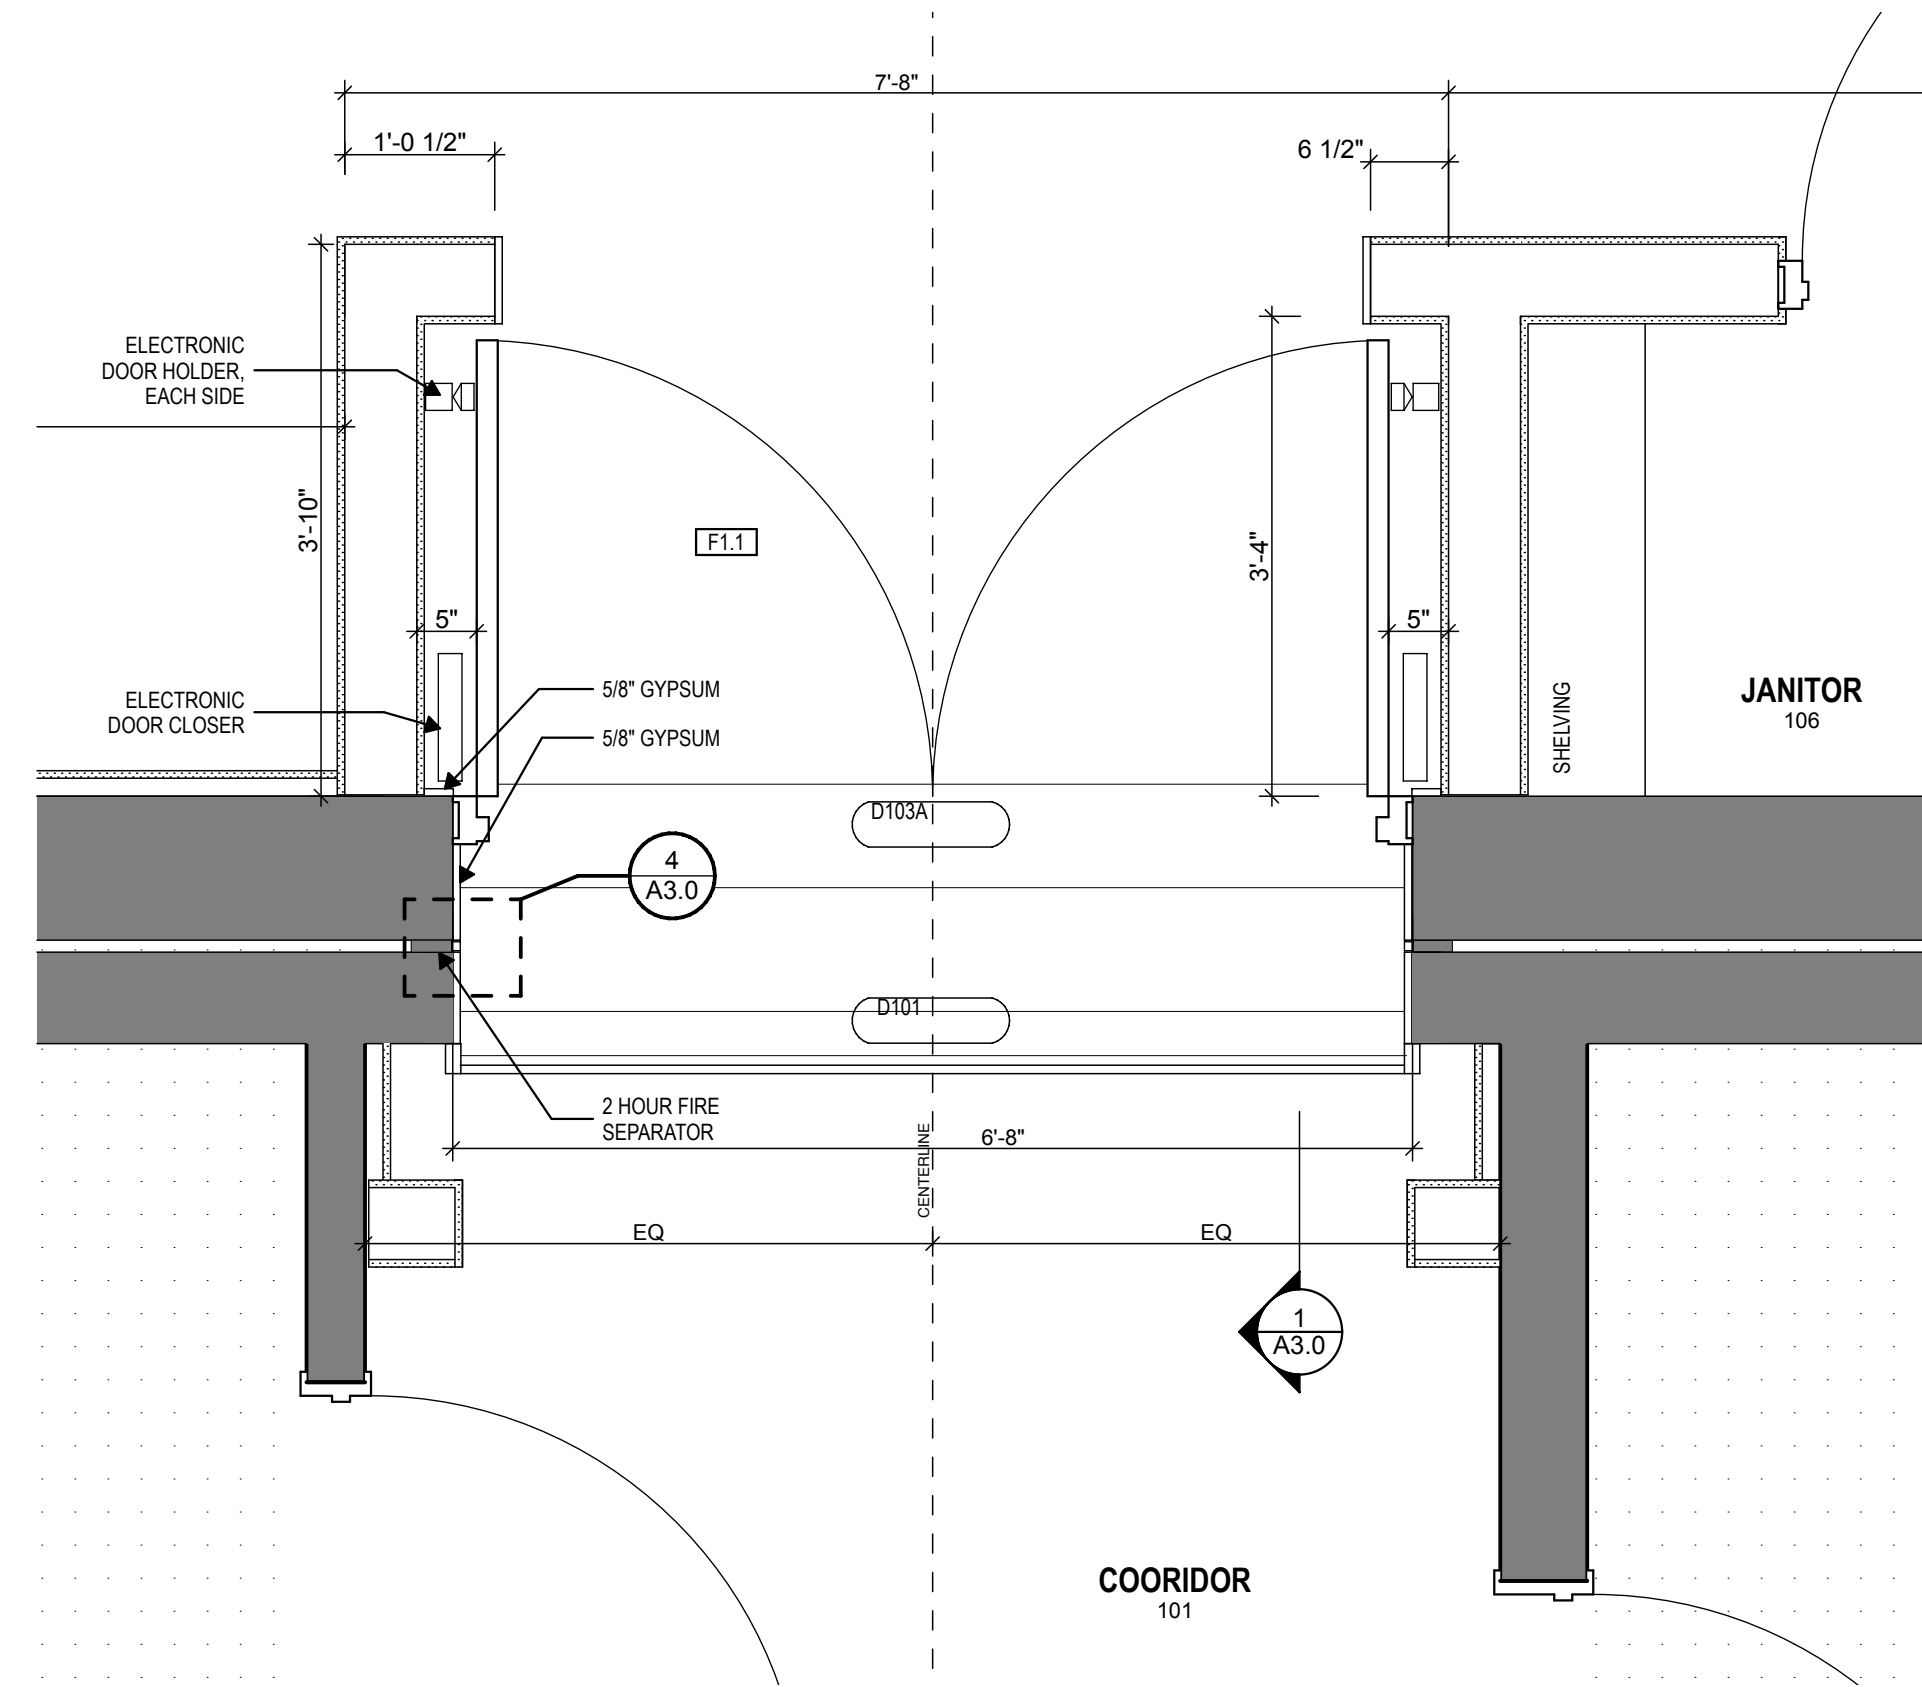

1 ENLARGED CORRIDOR
SCALE: 3/4" = 1'-0"

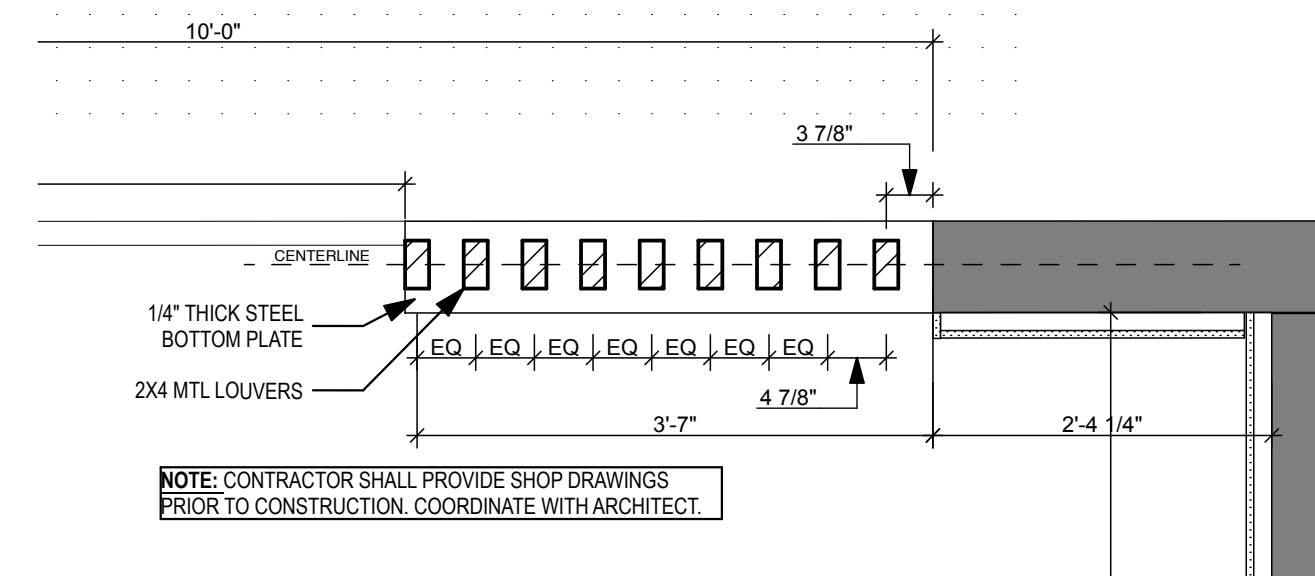

2 ENLARGED PLAN- STEEL LOUVERS
SCALE: 3/4" = 1'-0"


ROOM FINISH SCHEDULE

ROOM NO.	ROOM NAME	FLOOR		WALLS												CEILING			REMARKS		
		FINISH	NOTES	NORTH	EAST	SOUTH	WEST	FINISH	HEIGHT	NOTES	FINISH	HEIGHT	NOTES								
1ST FLOOR																					
101	CORRIDOR	F1.1	-	B1.1	-	W1.1	-	3	W1.3	-	3	W1.1	-	3	W1.1	-	3	C3.1	8'-0" / 7'-0"	1	
102	VENDING	F1.1	-	B1.1	-	W1.1	-	3	W1.1	-	3	W1.1	-	3	W1.1	-	3	C1.1 / C3.1	8'-0" / 7'-0"	1	
103	STUDENT ALCOVE	F1.1	-	B1.1	-	W1.1	-	3	W2.1 / W1.1	-	2,3	W1.1	-	3	W1.1	-	3	C1.1 / C2.1	8'-0" / 10'-2"	1	
104	CATERING KITCHEN	F1.1	-	B1.1	-	W1.1	-	3	W1.1	-	3	W1.1	-	3	W1.4	-	3	C2.1	10'-2"	-	
105	CLOSET	F1.1	-	B1.1	-	W1.1	-	3	W1.1	-	3	W1.1	-	3	W1.1	-	3	C2.1	10'-2"	4	
106	JANITOR	F1.1	-	B1.1	-	W1.1	-	3	W1.1	-	3	W1.1	-	3	W1.1	-	3	C2.1	10'-2"	4	

FINISH LEGEND


FLOORS	
F1.1	LVT PLANK FLOORING; SHAW QUIET COVER (0186V), 00770 RECLAIMED - MATCH EXISTING LVT IN CORE BUILDING LOBBY
WALL BASE	
B1.1	2" RESILIENT BASE - 29 MOONROCK, VINYL, JOHNSONITE
B1.2	1" WOOD BASE
WALLS	
W1.1	FIELD PAINT - SW 7016 MINDFUL GREY - SHERWIN WILLIAMS, SATIN
W1.2	ACCENT PAINT - SW 7046 URBANE BRONZE - SHERWIN WILLIAMS, SATIN
W1.3	ACCENT PAINT - SW 7046 ANONYMOUS - SHERWIN WILLIAMS, SATIN
W1.4	ACCENT PAINT - SW 6215 ROCKY RIVER - SHERWIN WILLIAMS, SATIN
W2.1	WOOD SLAT WALL PANELING, 1X2, STAINED ON 1X2 FURRING OVER MATTE BLACK WALL PAINT
CEILINGS	
C1.1	ACP ACCENT - USG CEILING - MARS LOOK CHANNEL PANELS 7536 FLB (PANEL SIZES: 12X48, 12X24, 6X48 - SEE RCP FOR LAYOUT), GRID: USG IDENTITEE DX1
C2.1	EXPOSED CEILING STRUCTURE, PAINTED - SW 7046 URBANE BRONZE - SHERWIN WILLIAMS
C3.1	GYPSUM CEILING BOARD - MATCH TO ASSOCIATED WALL COLOR
MILLWORK	
M1.1	1-1/4" THK. QUARTZ SURFACE - CAMBRIA TEMPLETON CLASSIC SERIES, POLISHED
PL1.1	PLASTIC LAMINATE (BREAK ROOM) - WILSONART, D91K-18 SLATE GREY
PL1.2	PLASTIC LAMINATE - WILSONART, R201 VALLEY FORGE ELM
PL1.3	PLASTIC LAMINATE - WILSONART, 15515 SPRUCE VELVET
PL1.4	PLASTIC LAMINATE - WILSONART, 15617 ETHERIAL VELVET
PL1.5	PLASTIC LAMINATE - WILSONART, 15516 ICECAP VELVET
DOOR FRAME AND FABRICATED STEEL PARTS	
FR1.1	PAINT COLOR ON FRAME TO MATCH ADJACENT WALL, EGG-SHELL

- ROOM FINISH NOTES**
1. CEILING VARIATION AND TRANSITION, SEE RCP
 2. PAINT WALL FIELD COLOR ABOVE WOOD SLAT ACCENT, UP TO FLOOR DECK ABOVE
 3. PAINT WALL COLOR UP TO FLOOR DECK ABOVE
 4. CEILING REQUIRES NO PAINT

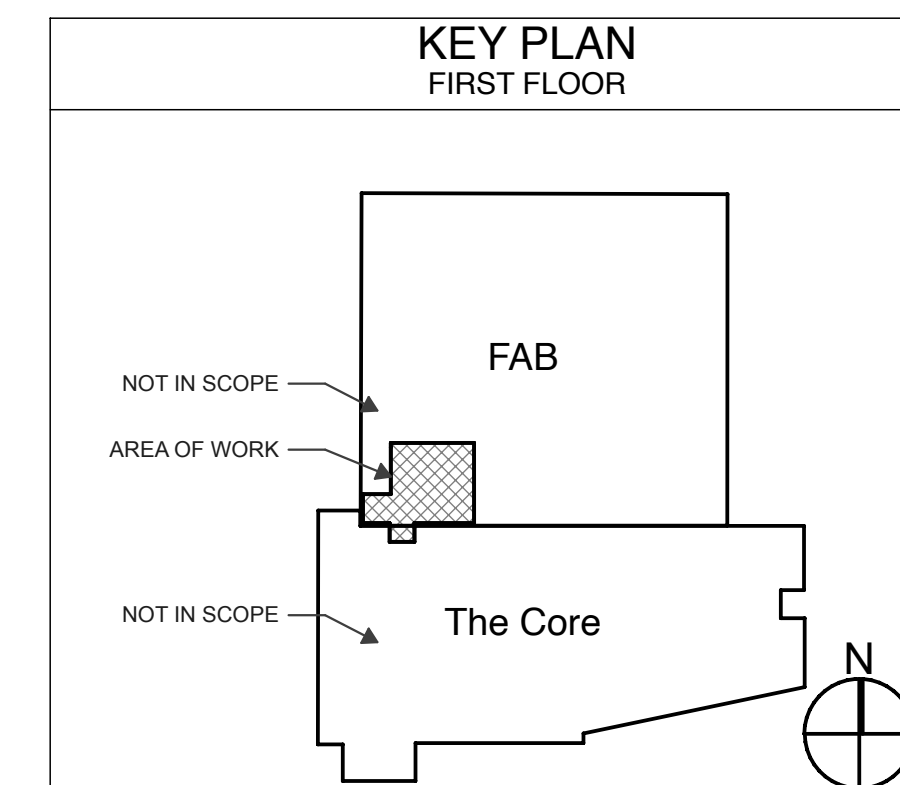


PHASE:	CONCEPT SCHEM. DESIGN	ADVANCED SCHEM. DESIGN	DESIGN DEVELOPMENT	CONSTRUCTION DOCS 90%	CONSTRUCTION DOCS 100%	PERMIT DOCS
DRAWN:	J. LAYERS	J. LAYERS	J. LAYERS	J. LAYERS	J. LAYERS	J. LAYERS
REVIEWED:	J. LAYERS	J. LAYERS	J. LAYERS	J. LAYERS	J. LAYERS	J. LAYERS
DATE:	08/08/2024	07/22/2024	07/22/2024	07/22/2024	07/22/2024	07/22/2024
EDITED:						
REVISION:						
ID:						
CLIENT:	Celebration Baptist Church 3300 Sharnock St. E. Tallahassee, FL 32309					
PROJECT TITLE:	Canopy and Corridor Improvements					

Consultant: Civil Plainman ENGINEERING 904-382-2289 5404 Appleford Lane Tallahassee, FL 32309	Consultant: MEP FSM Engineering 850-727-5367 kevermckee.com 1624 Metropolitan Blvd Tallahassee, FL 32309	Consultant: Structural KEVER MCKEE ENGINEERING 850-727-5367 kevermckee.com 1624 Metropolitan Blvd Tallahassee, FL 32309	Architect: HAYS LAYERS ARCHITECTURE 1221 Summer Haven Ct. Franklin, TN 37069 650-558-3613 hays@hayslayers.com FL License: AP06759	Seal:	Client: Celebration Baptist Church 3300 Sharnock St. E. Tallahassee, FL 32309	Project Title: Canopy and Corridor Improvements	Sheet No. A2.1
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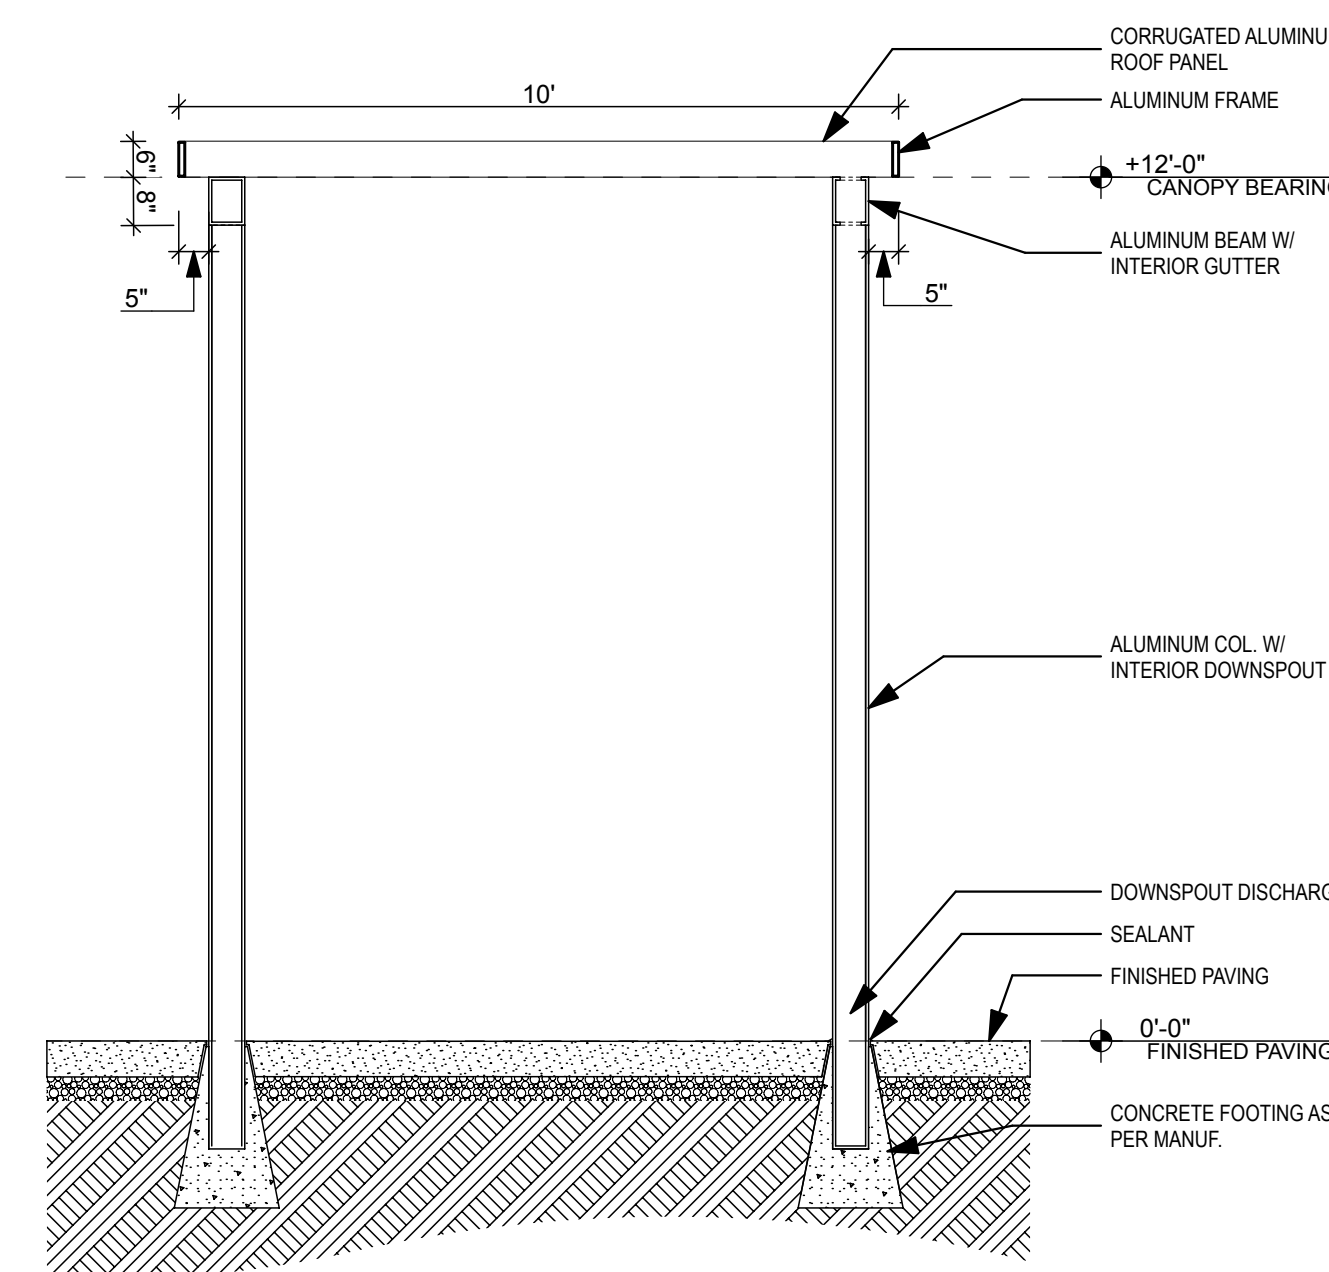


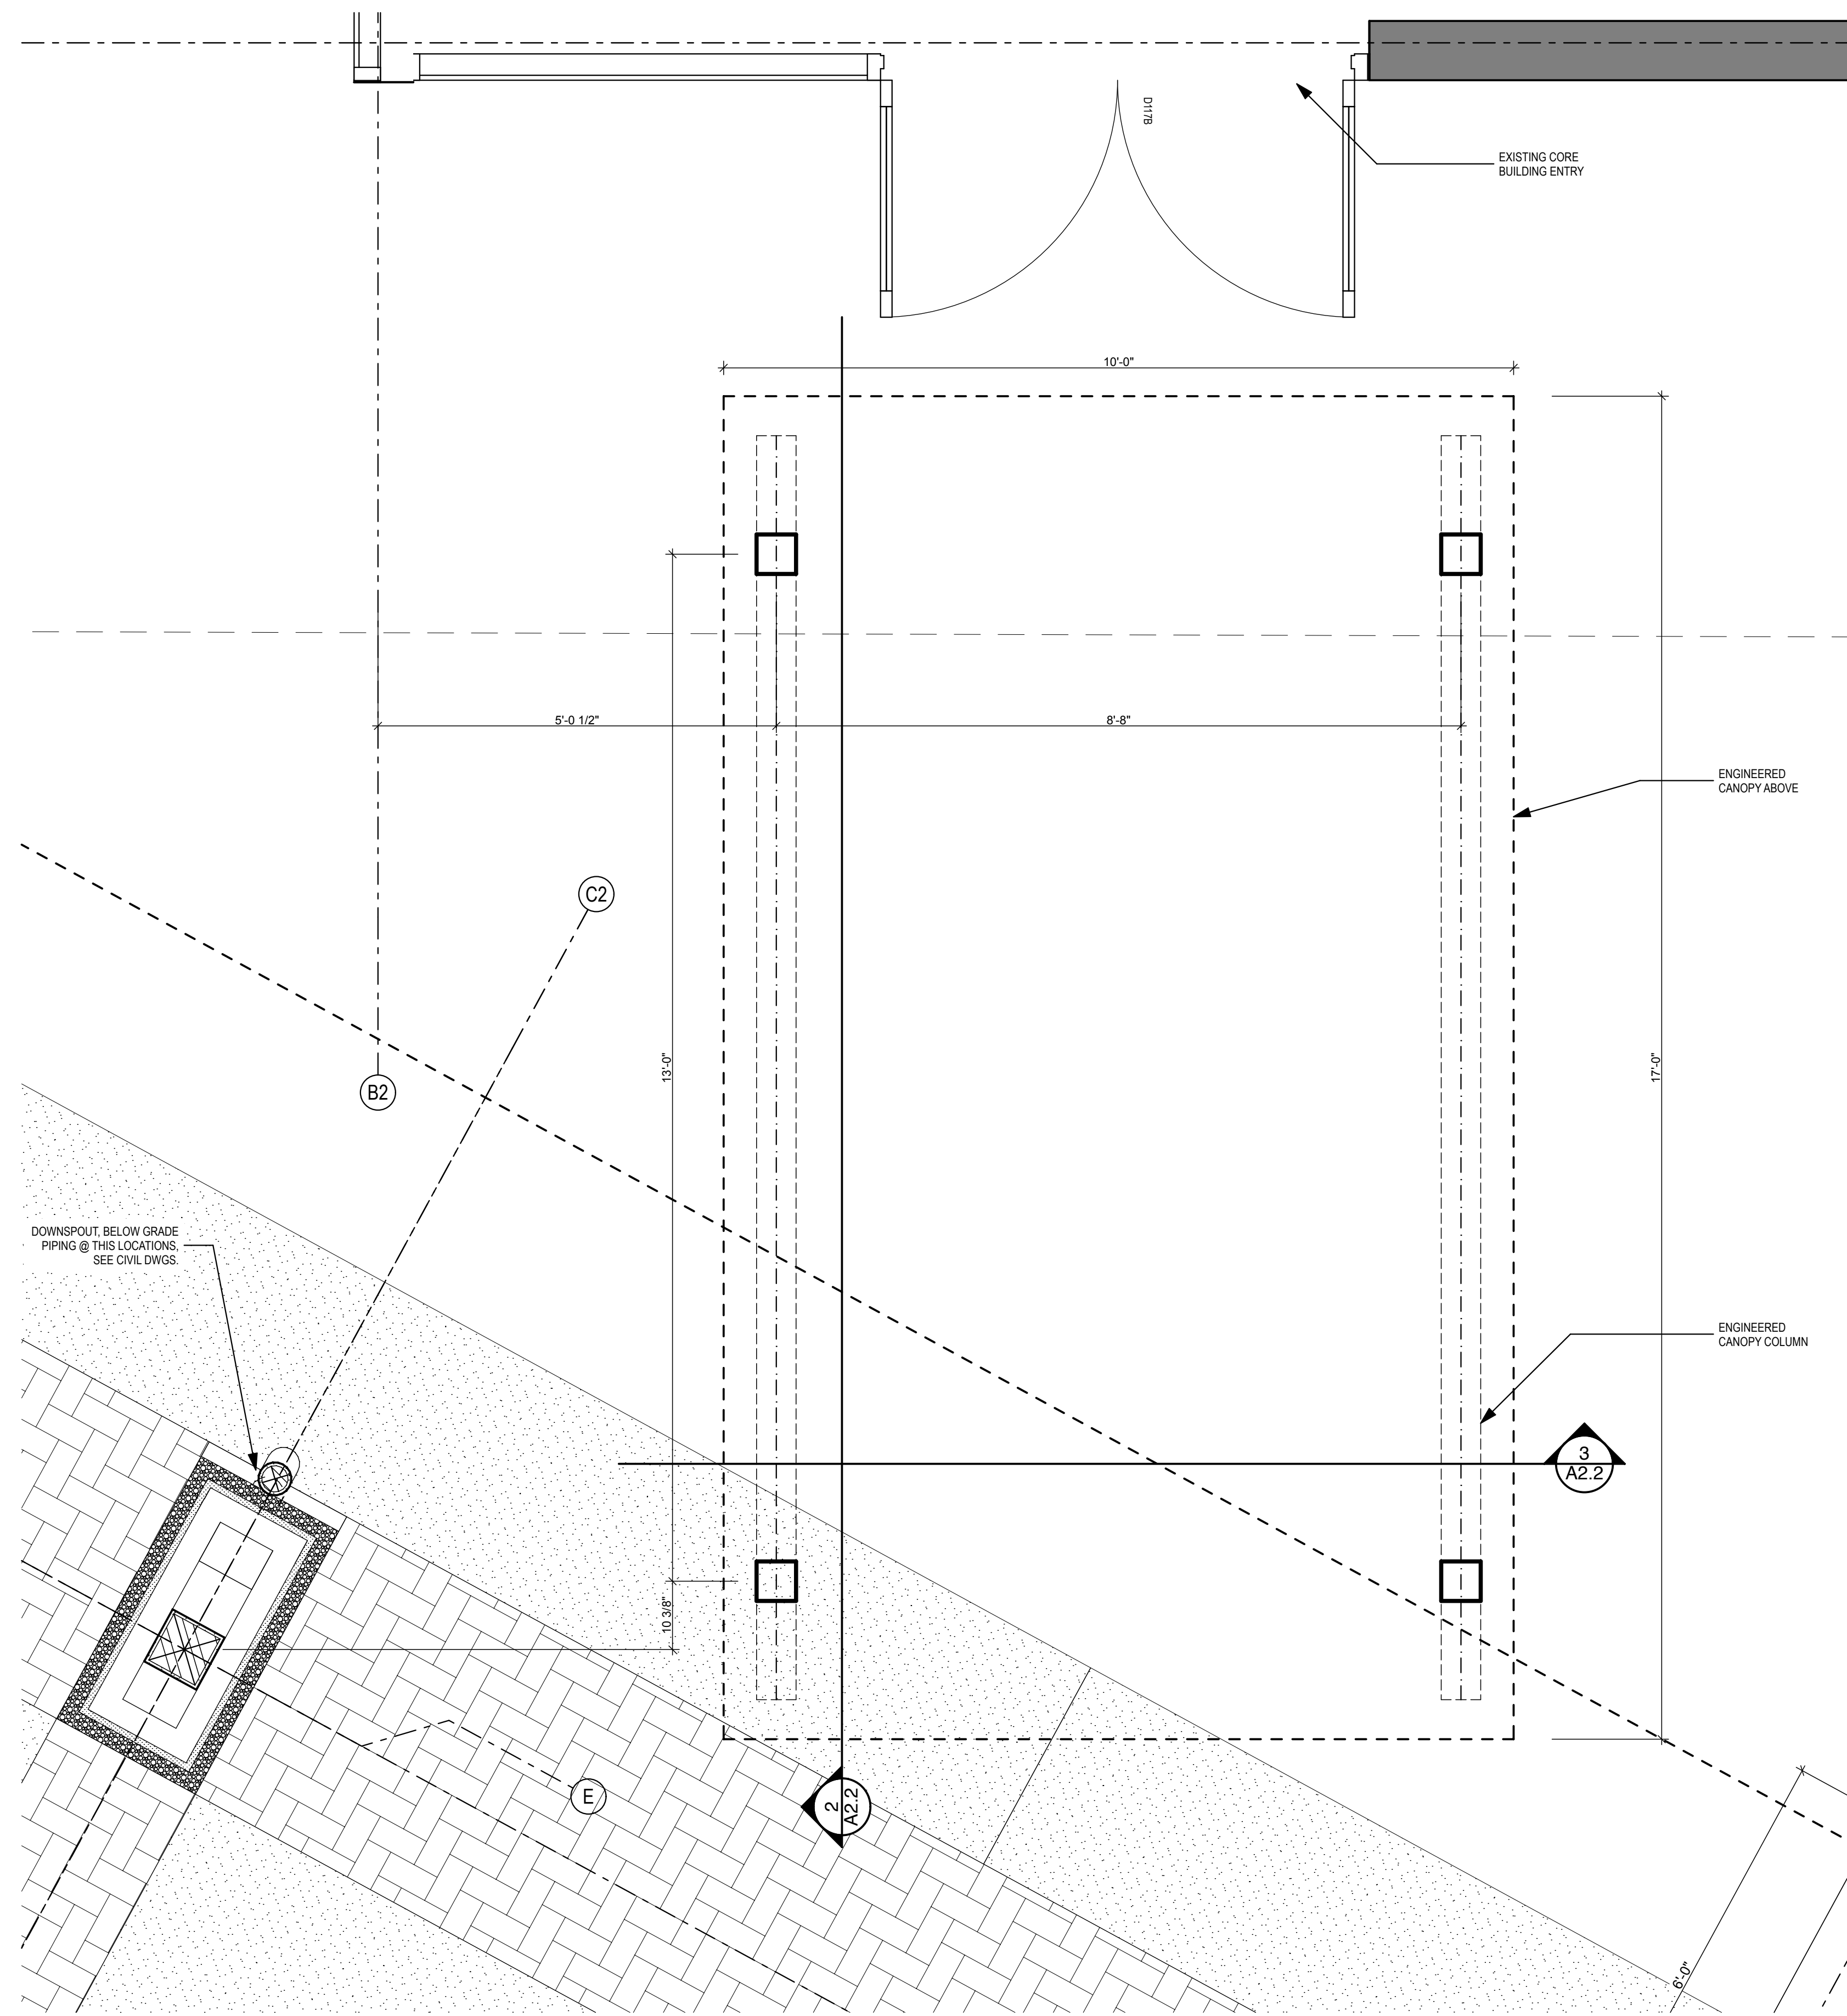1 ENLARGED PLAN- STEEL LOUVERS
SCALE: 3/4" = 1'-0"

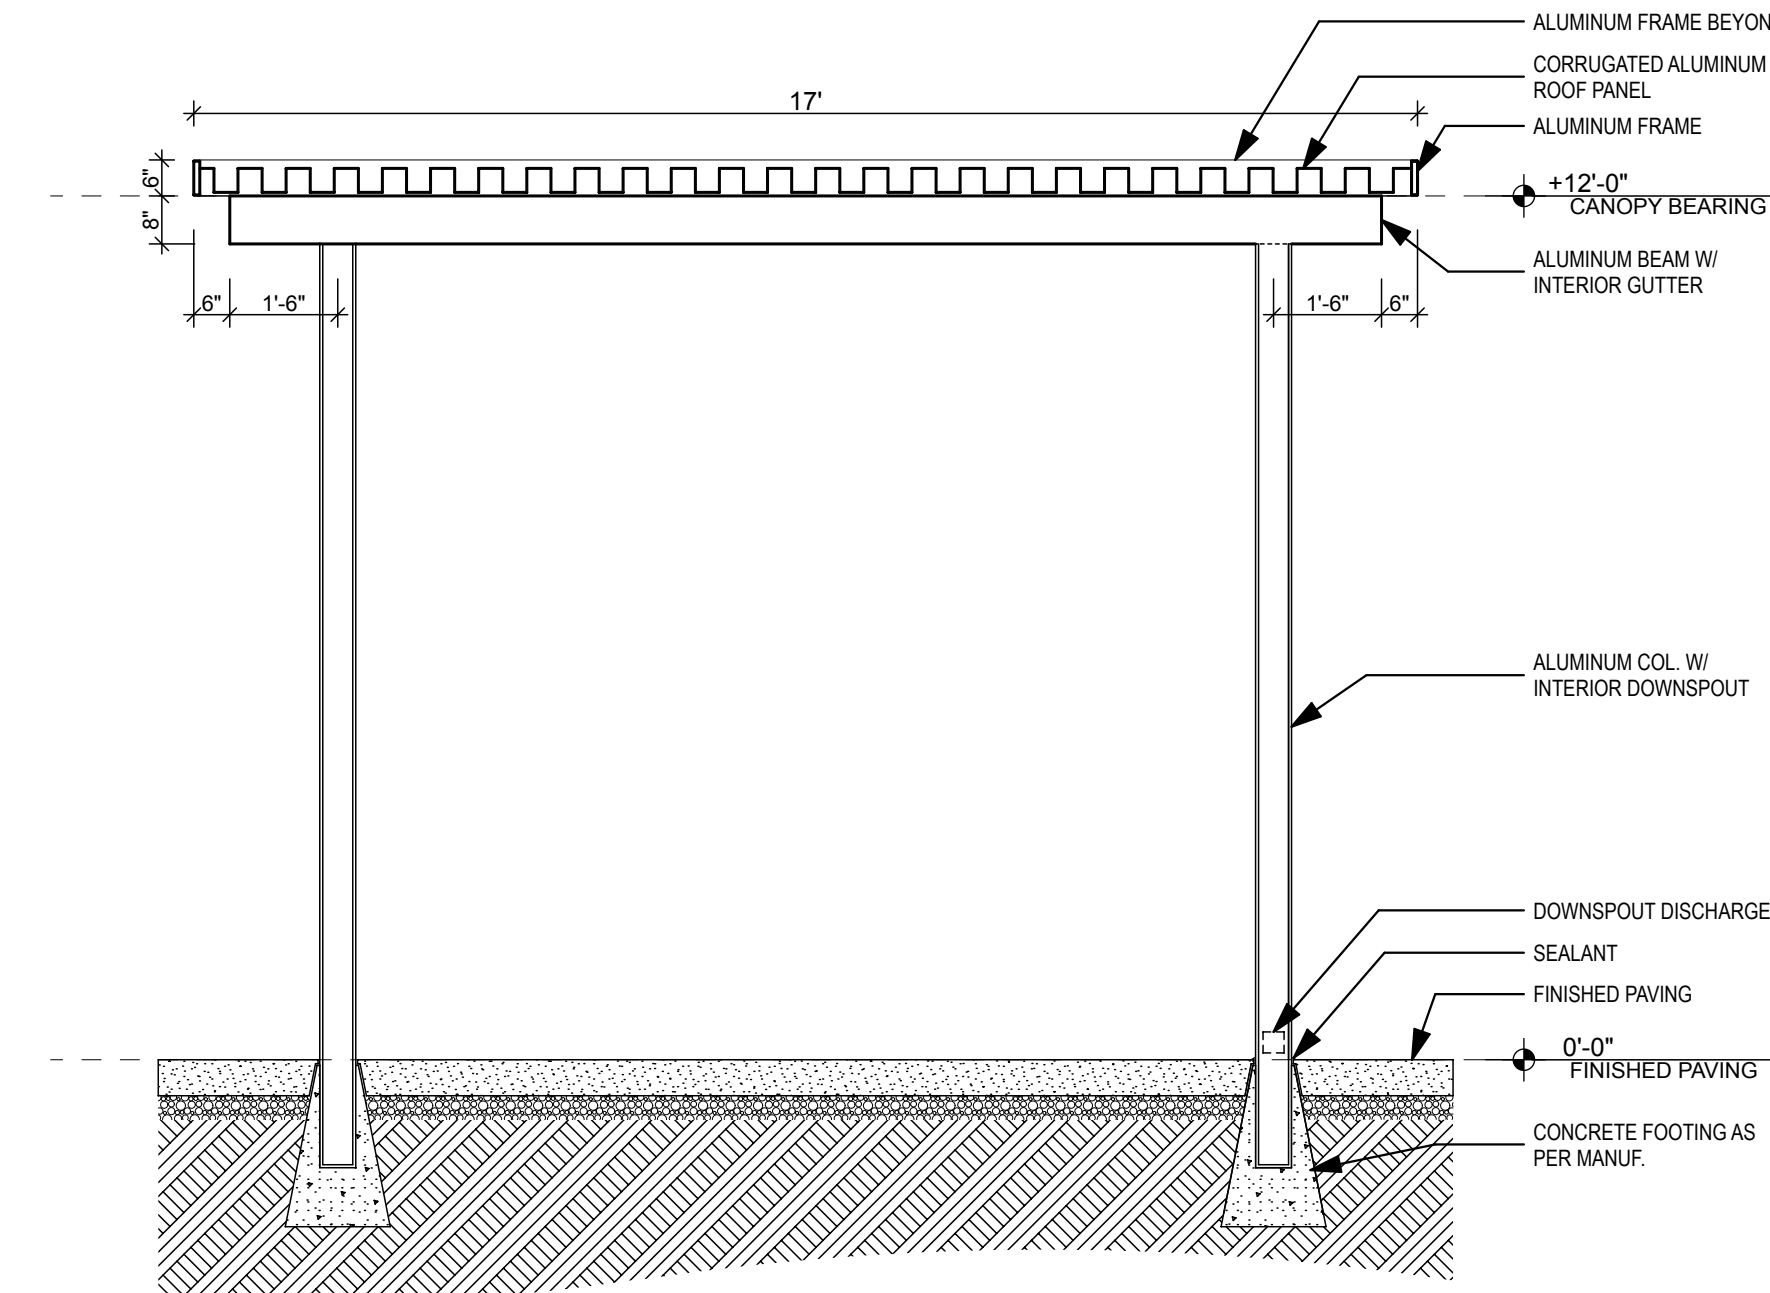

2 ENG. CANOPY LONG SECTION
SCALE: 3/8" = 1'-0"

NOTE: CONTRACTOR SHALL PROVIDE SHOP DRAWINGS PRIOR TO CONSTRUCTION. COORDINATE WITH ARCHITECT.



3 ENG. CANOPY CROSS SECTION
SCALE: 3/8" = 1'-0"

PRE-ENGINEERED METAL CANOPY

BASIS OF DESIGN: PRE-ENGINEERED EXTRUDED ALUMINUM DECKING WALKWAY COVER

MANUFACTURER: AWNING WORKS, INC.

PROVIDE ALUMINUM WALKWAY COVERS, COLUMNS AND FOUNDATIONS, INCLUDING ALL NECESSARY ACCESSORIES TO ACHIEVE CONFIGURATIONS AND PROFILES AS INDICATED ON THE DRAWINGS

CODE: DESIGNED PER FLORIDA BUILDING CODE, 8TH ADDITION, A.M.A. ALUMINUM DESIGN MANUAL 2010, ASTM B221-12, ANSII/ASCE 7-10 WIND LOADS, AND PROVIDE FLORIDA PRODUCT APPROVAL #.

MATERIALS: ALUMINUM COLUMNS, BEAM AND TUBING: 6061 AND 6063 ALLOY HEAT TREATED TO A T-5 AND T-6 TEMPER, AND WITH NOT LESS THAN THE STRENGTH AND DURABILITY PROPERTIES SPECIFIED IN ASTM B 221-12 FOR 6063-T5.

MATERIAL THICKNESS: PROVIDE MINIMUM THICKNESS OF METAL AS FOLLOWS:


1. BEAMS: 0.125 INCHES ON VERTICAL FACES AND 0.190 INCHES ON HORIZONTAL FACES.
2. COLUMNS: 0.150 INCHES.
3. DECK: 0.60 INCHES.
4. FLASHING: 0.032 INCHES.

FINISH: TIGER DRYLAC SERIES8 SYSTEM 38 IS A HIGHLY UV AND WEATHER RESISTANT POWDER COATING FOR ARCHITECTURAL ALUMINUM, BASED ON TGIC-FREE SUPER DURABLE POLYESTER, WHICH MEETS AAMA 2604-05 G88 AND QUALICOAT CLASS 2 SPECIFICATIONS.

COLOR: 3870061 GREY CLASSIC 314 / SATIN

SUBMITTALS: SUBMIT MATERIAL AND COLOR SAMPLES, AS WELL AS SHOP DRAWINGS, PRODUCT DATA, AND ENGINEER'S CERTIFICATIONS TO ARCHITECT FOR APPROVAL PRIOR TO ACCEPTANCE.

CONTACT: AWNINGWORKSINC.COM (727) 524-1118

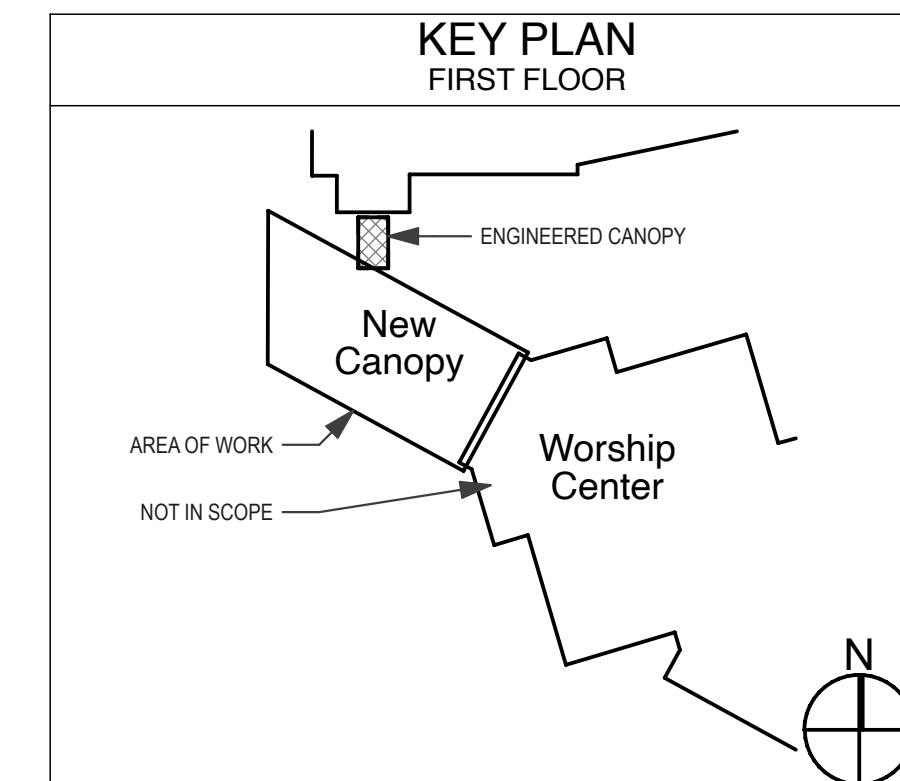

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REVIEWED:	H. LAYARD	H. LAYARD	H. LAYARD	H. LAYARD	H. LAYARD	H. LAYARD
DATE:	10/20/2024	10/27/2024	11/13/2024	11/13/2024	11/13/2024	11/13/2024
ID:						
REVISION:						
EDITED:						
REVIEWED:						
DATE:						

Client:
Celebration Baptist Church
3900 Shamrock St. E.
Tallahassee, FL 32309

Project Title:
Canopy and Corridor Improvements

Consultant:
Civil
Plainman ENGINEERING
904-382-2286 5404 Appleford Lane Tallahassee, FL 32309


Consultant:
MEP
FSM Engineering
850-727-5367
kevern@fsme.com
1624 Metropolitan Blvd Tallahassee, FL 32309

Consultant:
Structural
KM KEVER MCKEE ENGINEERING
850-727-5367
kevern@fsme.com
1624 Metropolitan Blvd Tallahassee, FL 32309


Architect:
HAYS LAYARD ARCHITECTURE
1221 Summer Haven Ct. Franklin, TN 37069
850-558-3613
hays@hayslayer.com
FL License: AP06759

Seal:
HAYS LAYARD ARCHITECTURE


ENGINEERED CANOPY
Sheet No. **A2.2**

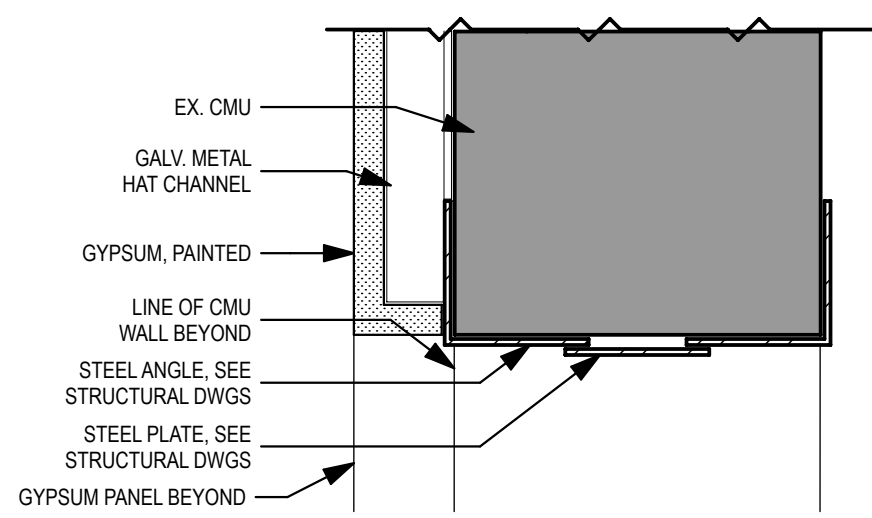


3 TYP. LINTEL
SCALE: 3" = 1'-0"

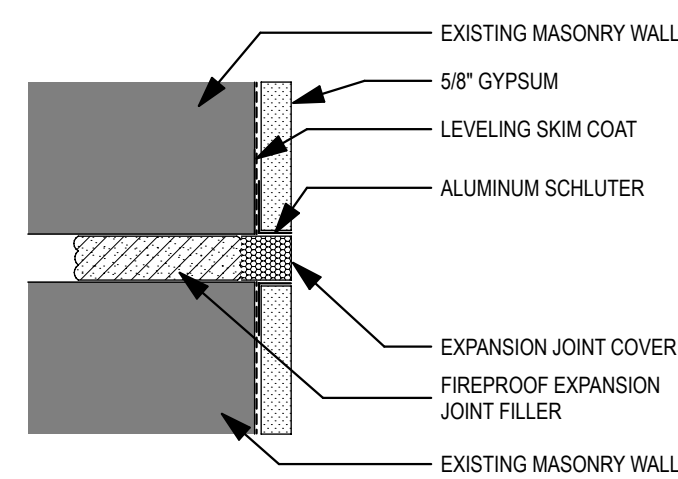


4 EXPANSION JOINT JAMB
SCALE: 3" = 1'-0"

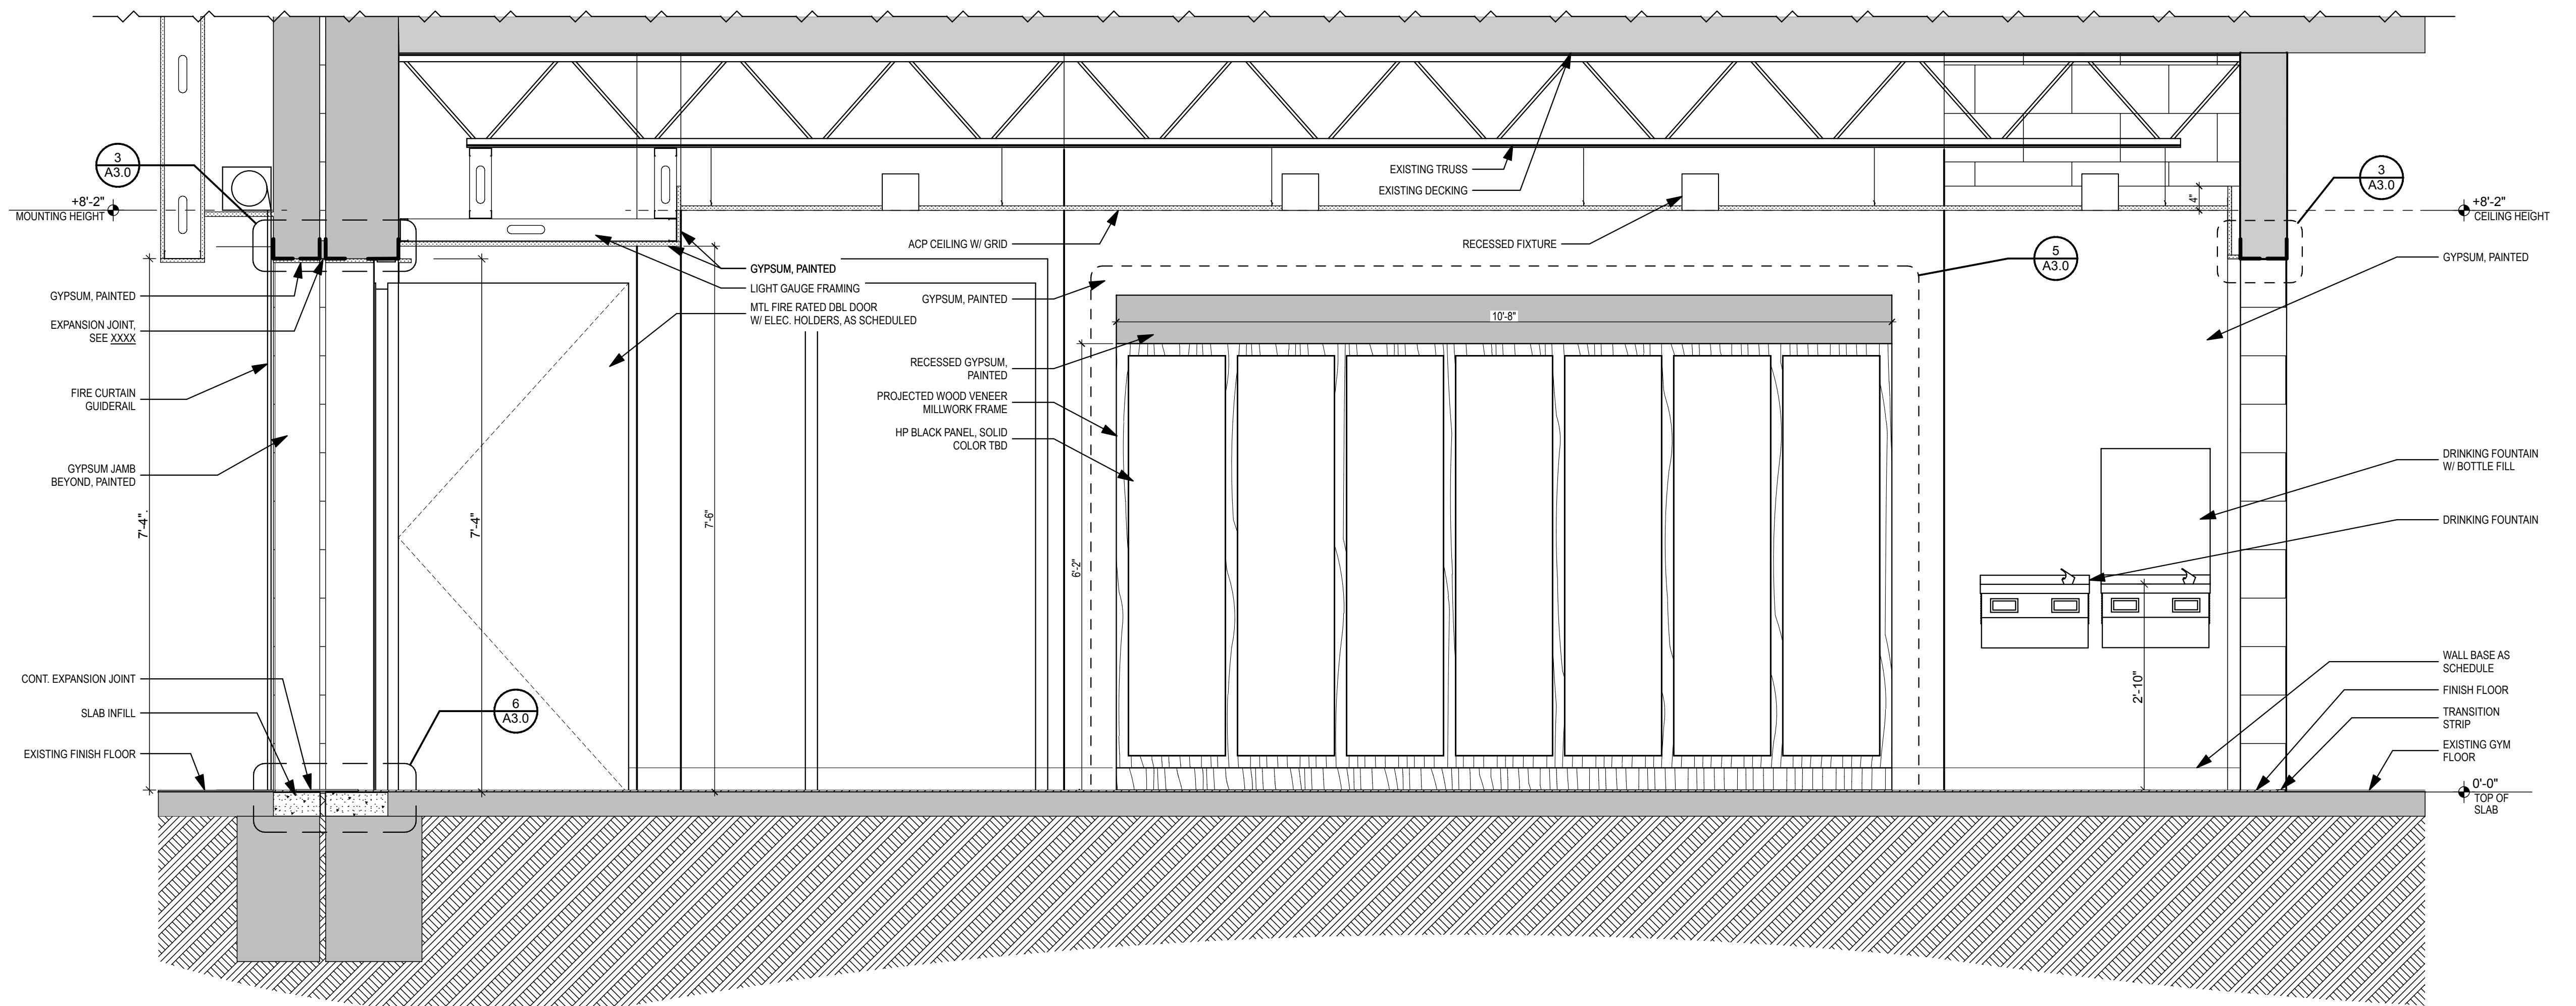

1 CORRIDOR SECTION
SCALE: 3/4" = 1'-0"

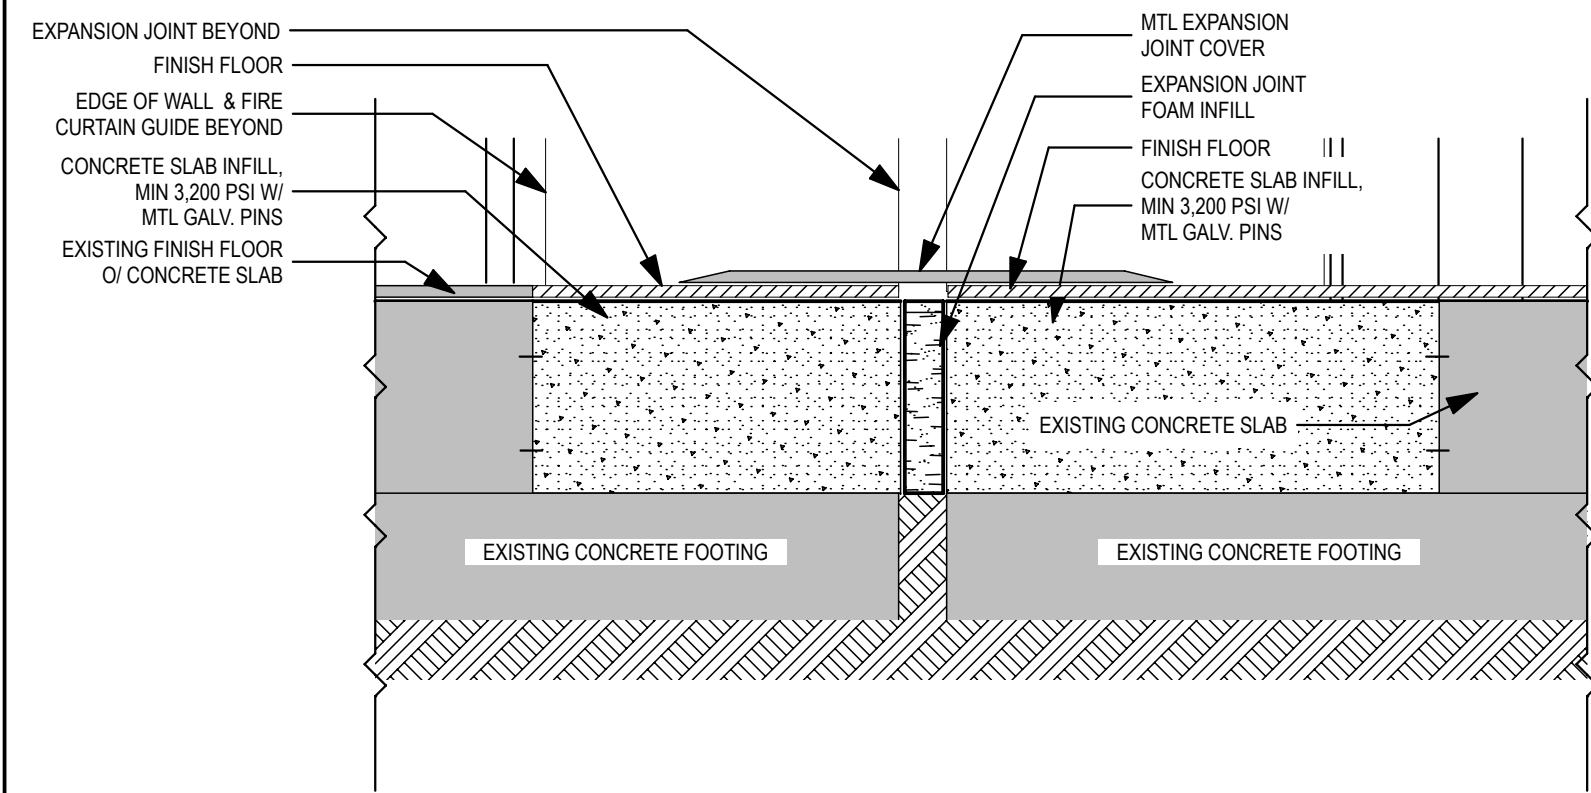


6 CONT. EXPANSION JOINT
SCALE: 3" = 1'-0"

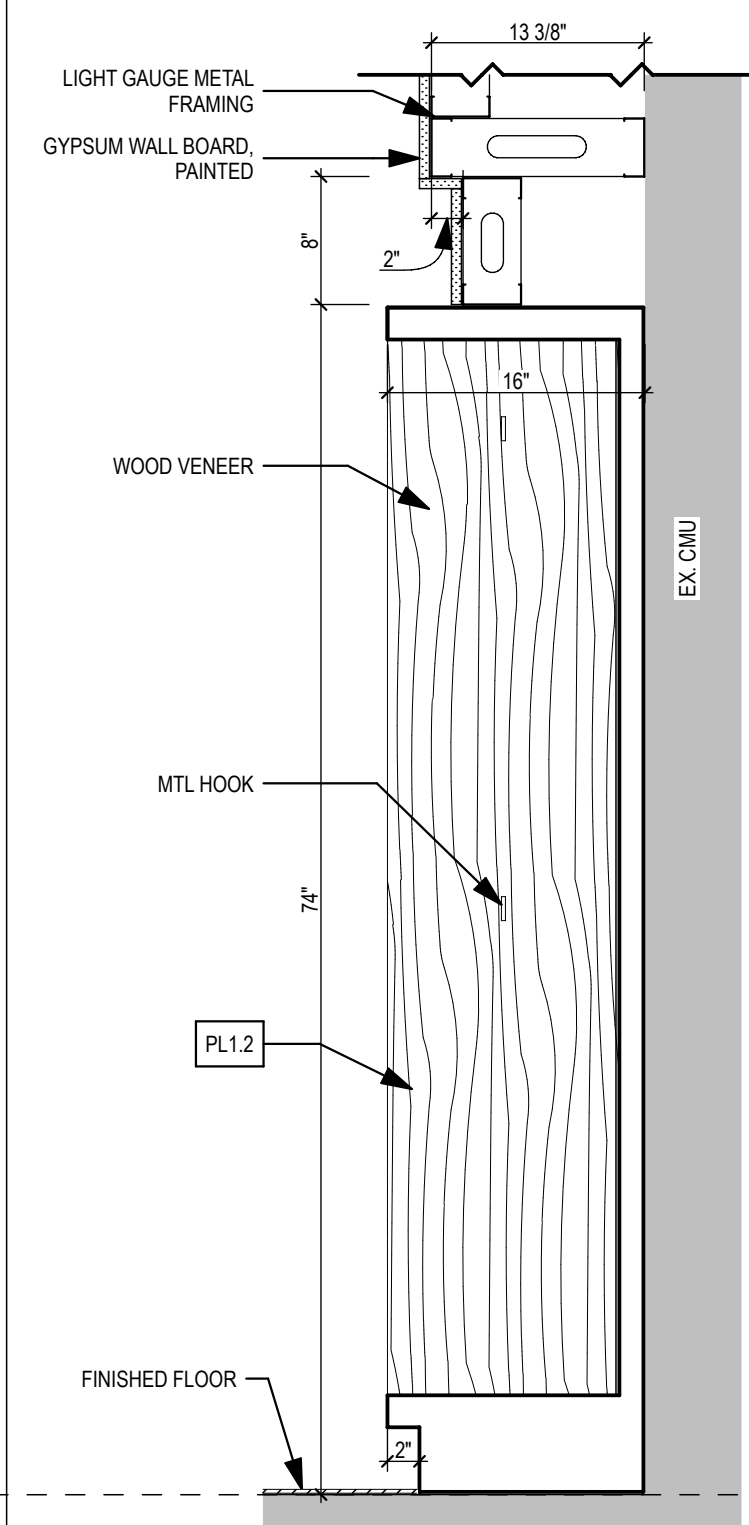


SECTION

5 BACKPACK STORAGE
SCALE: 1" = 1'-0"

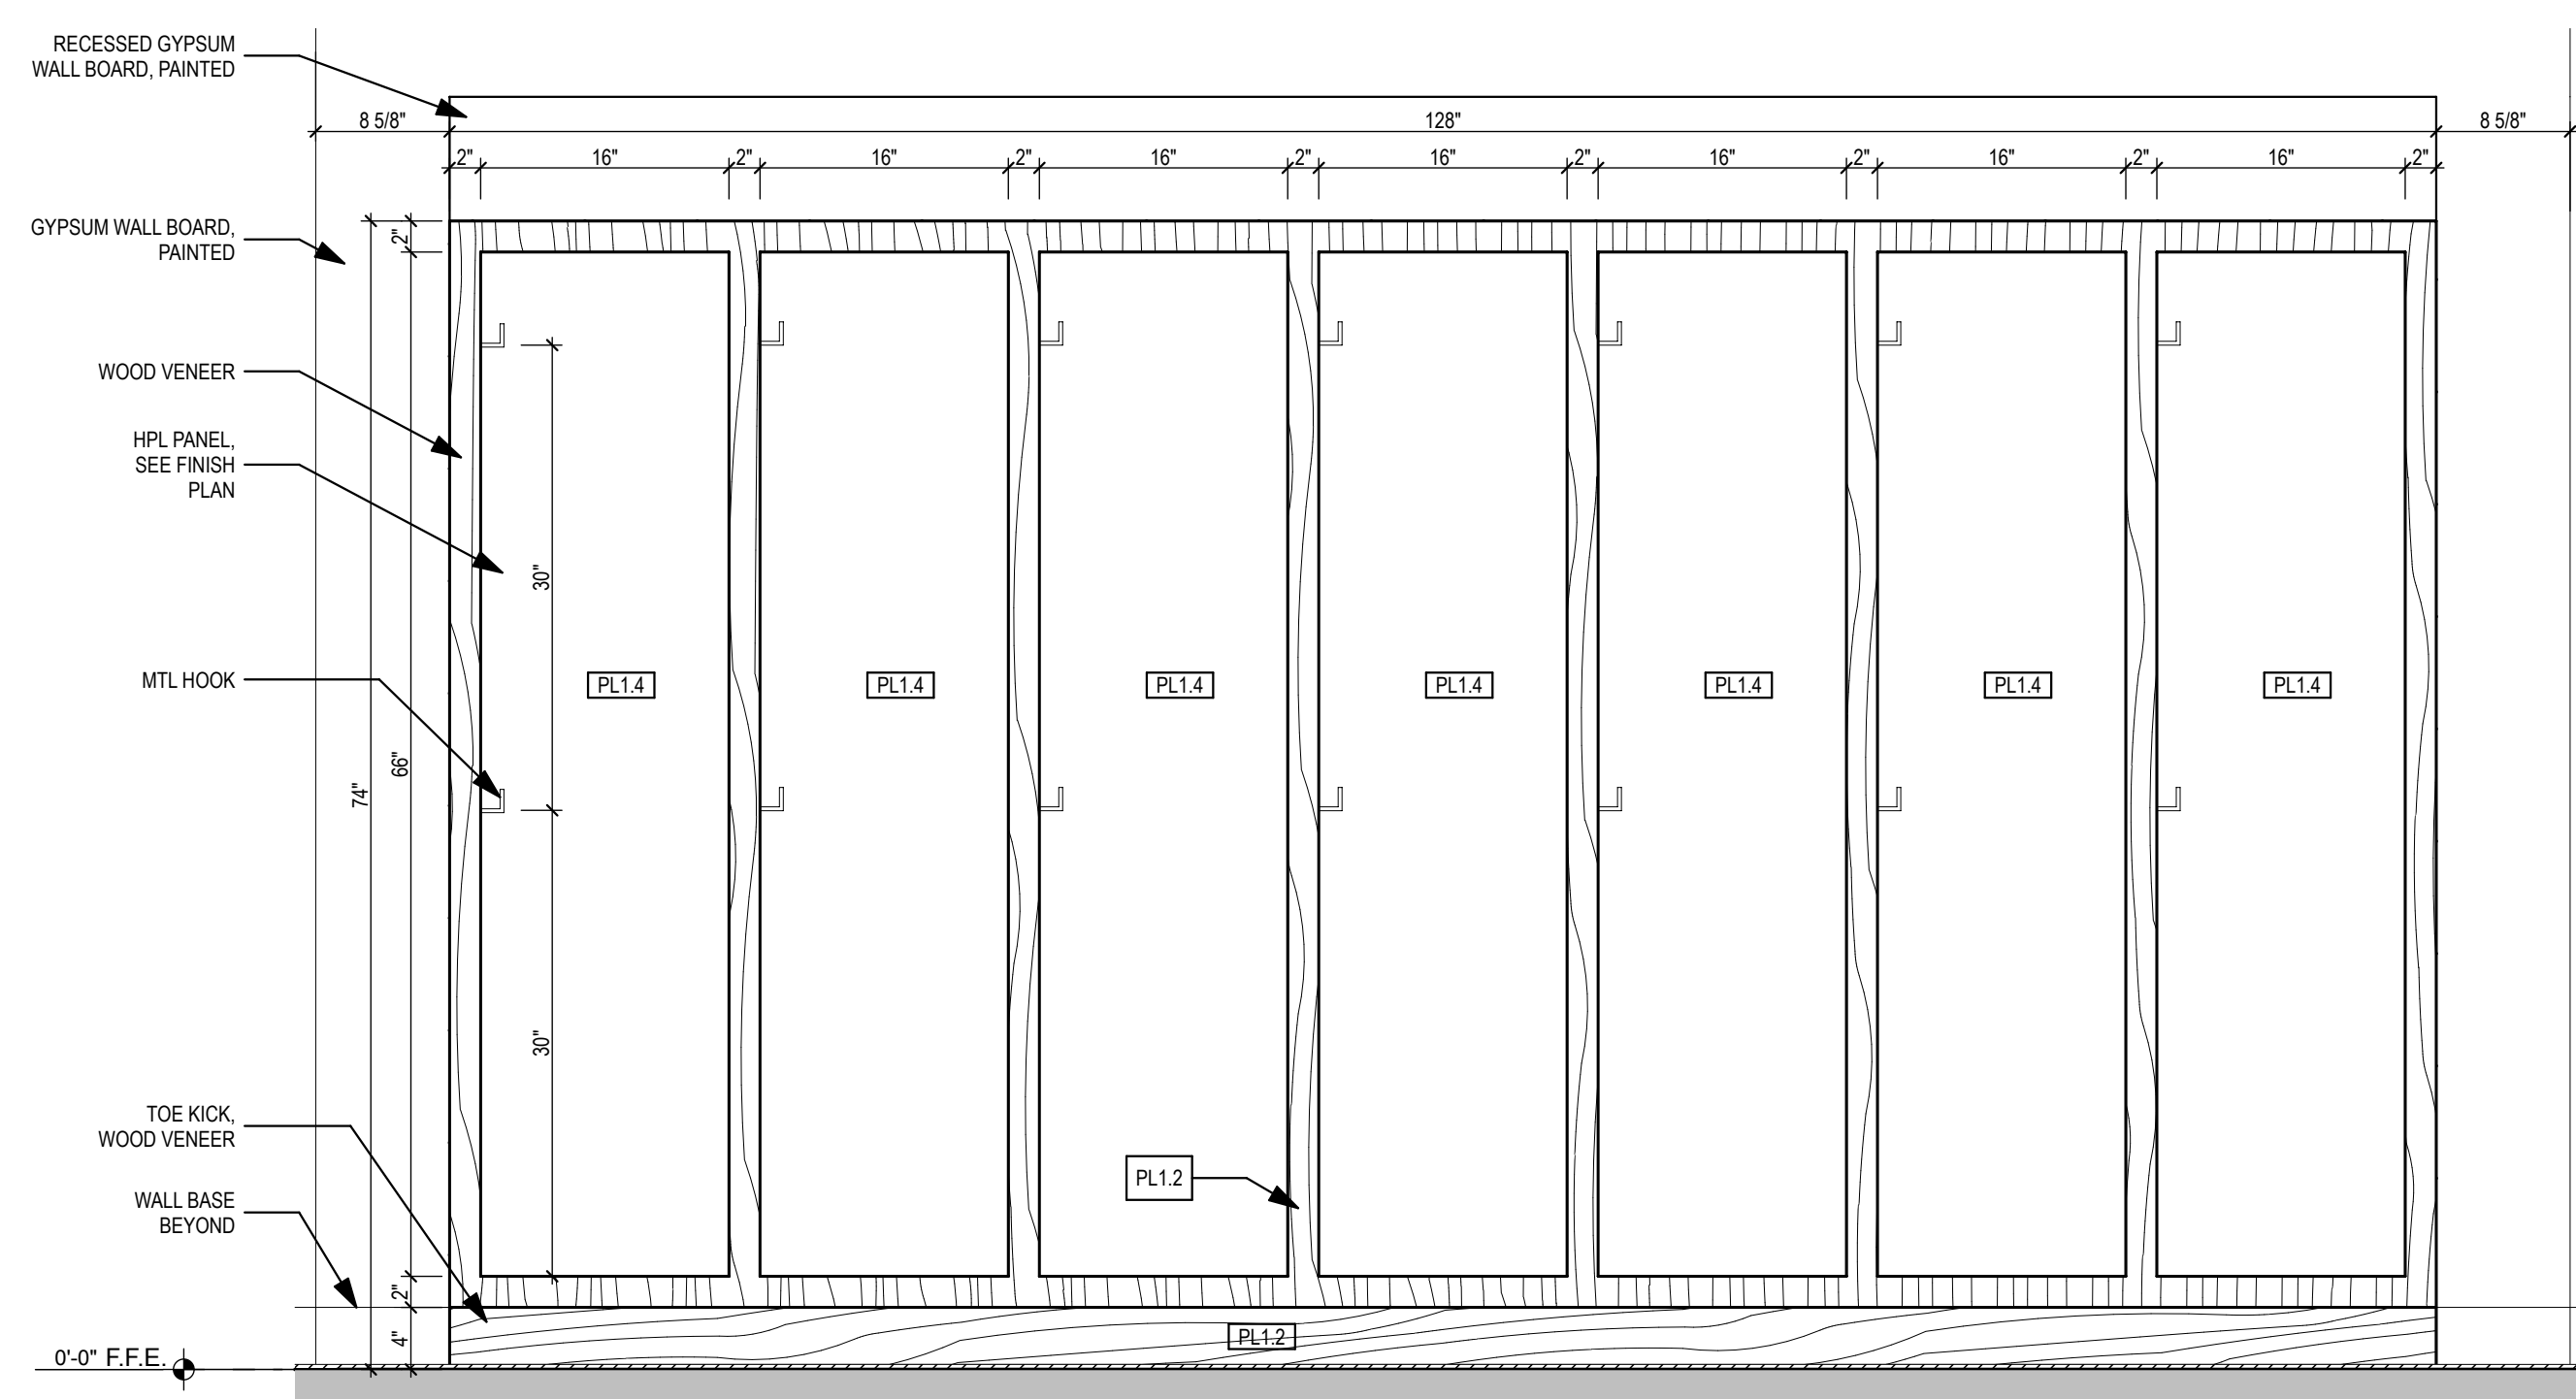

ELEVATION

NOTE: CONTRACTOR SHALL PROVIDE SHOP DRAWINGS PRIOR TO CONSTRUCTION. COORDINATE WITH ARCHITECT.

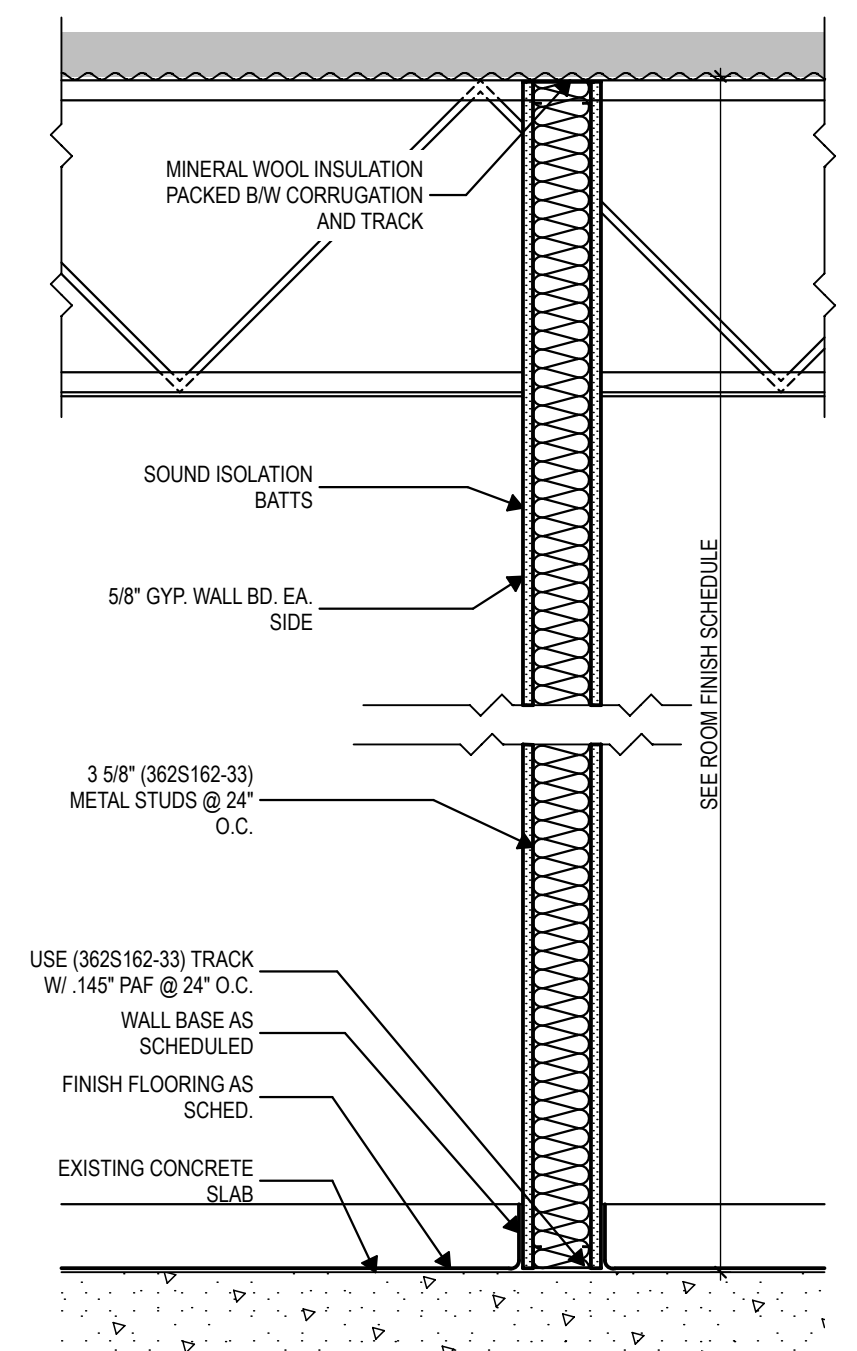

2 TYP. INTERIOR PARTITIONS
SCALE: 1" = 1'-0"

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CONSTRUCTION DOCS 100%	J. HAYES	H. LAYARD						
PERMIT DOCS								

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3300 Shamrock St. E.
Tallahassee, FL 32309

Project Title: **Canopy and Corridor Improvements**

Sheet No.

A3.0

Consultant: Civil
Plainman ENGINEERING


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FSM Engineering

Consultant: Structural
KEVER MCKEE ENGINEERING


Architect:
HAYS LAYARD ARCHITECTURE

Seal:

SECTIONS

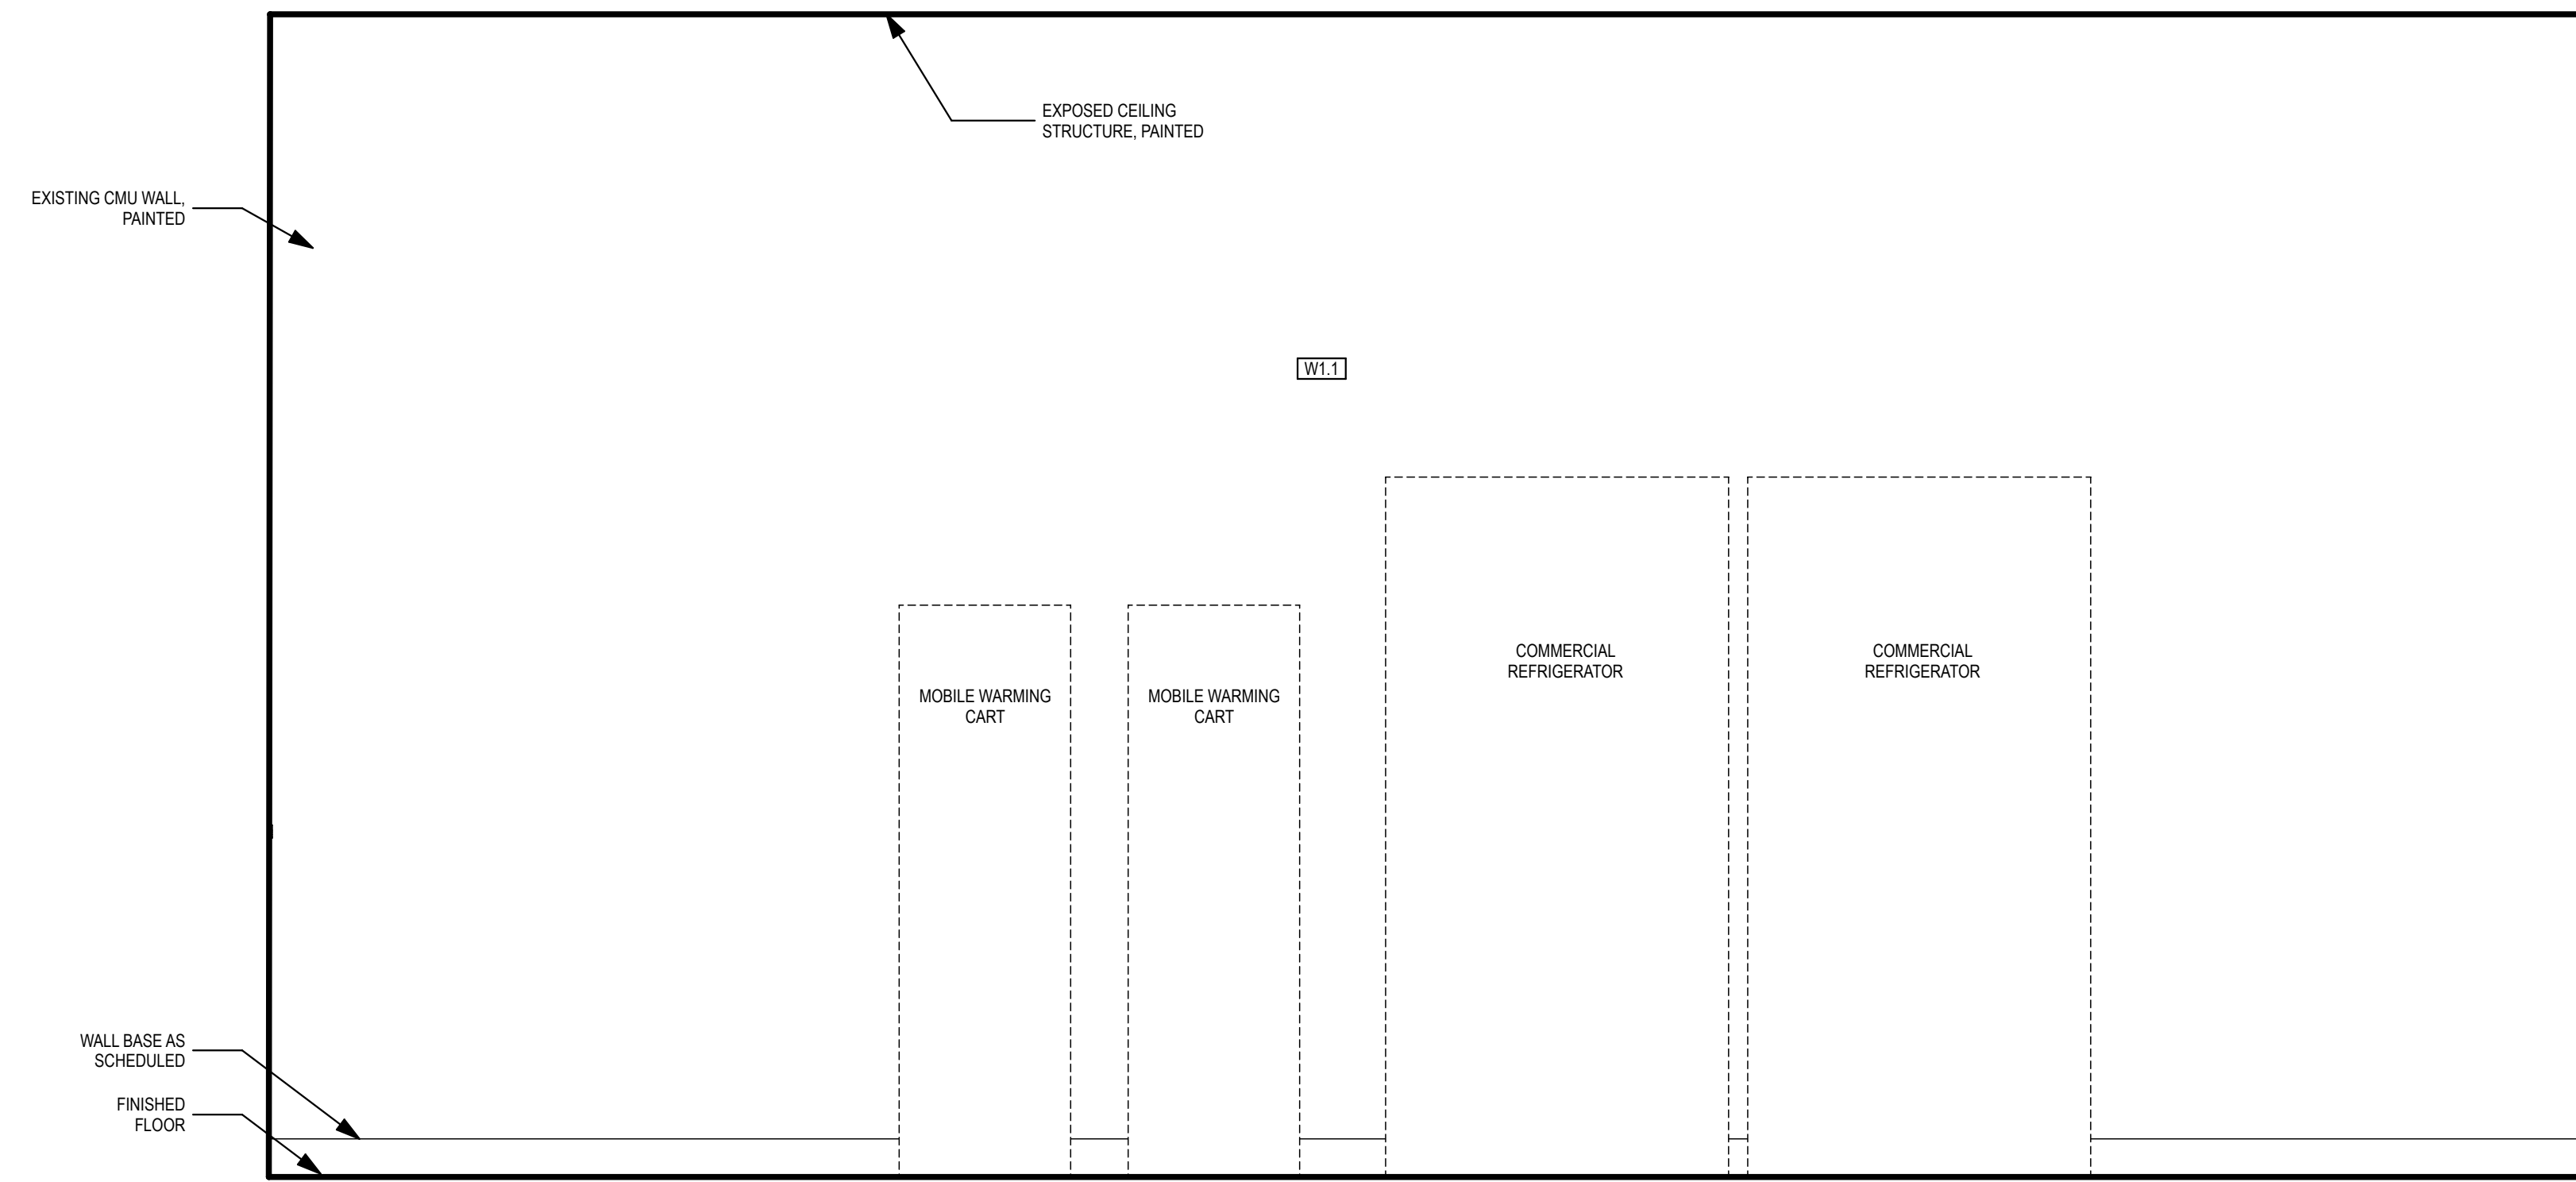


3 KITCHEN ROOM EAST
SCALE: 3/4" = 1'-0"

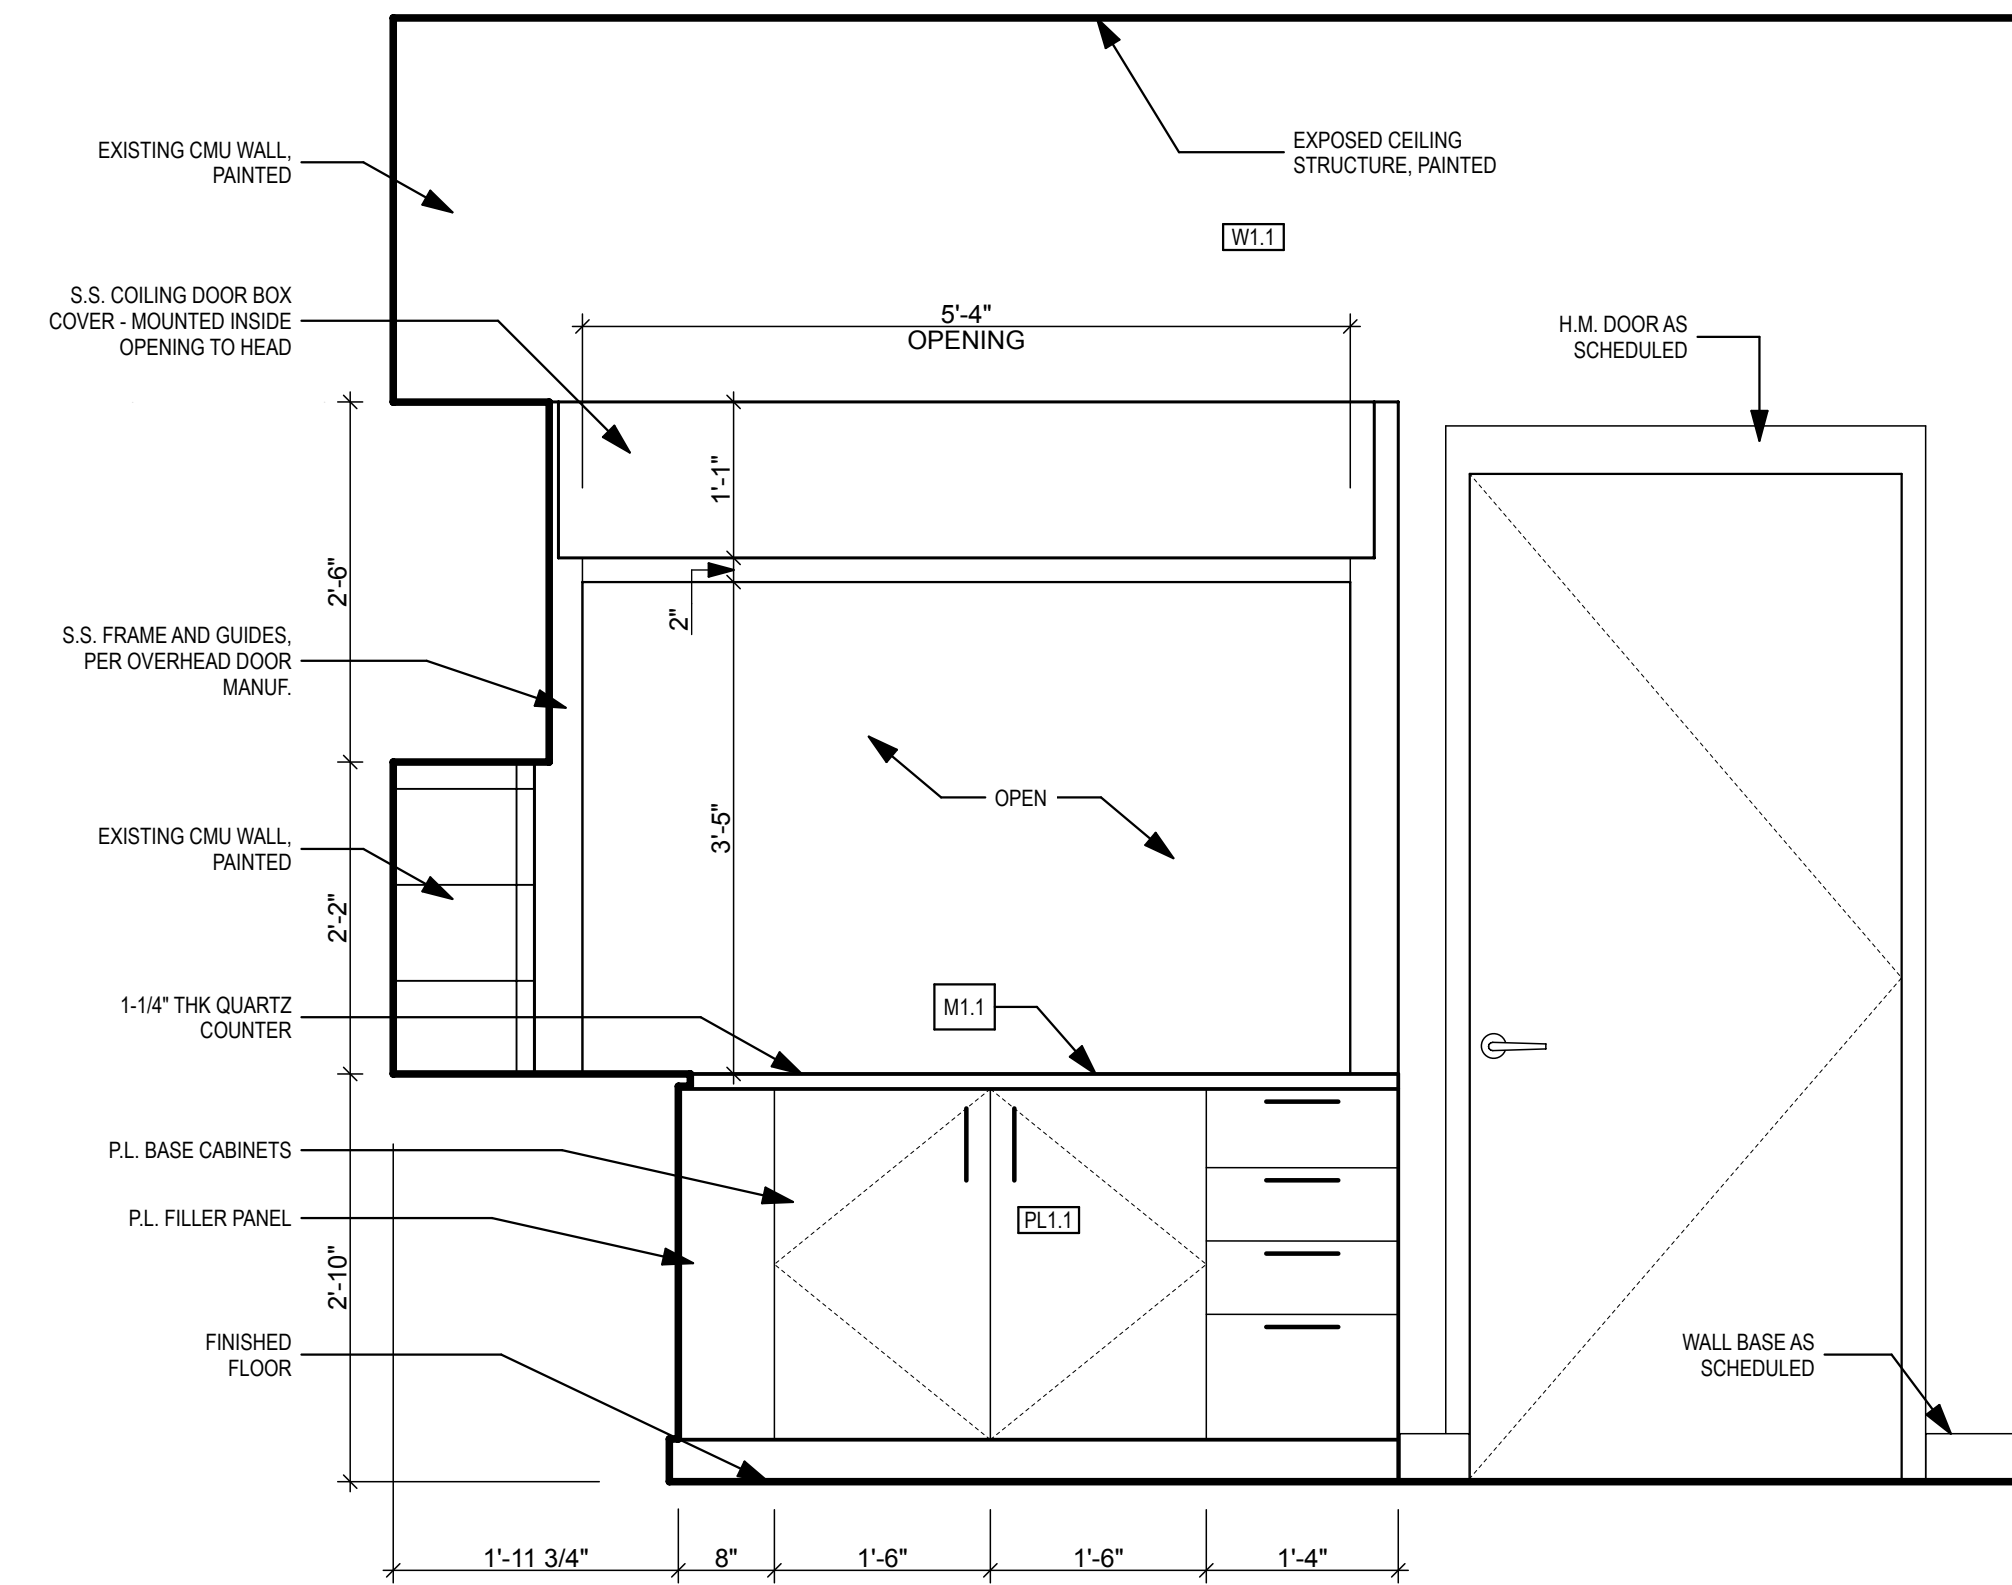

2 KITCHEN WALL NORTH
SCALE: 3/4" = 1'-0"


NOTE: CONTRACTOR SHALL PROVIDE SHOP DRAWINGS PRIOR TO CONSTRUCTION. COORDINATE WITH ARCHITECT.

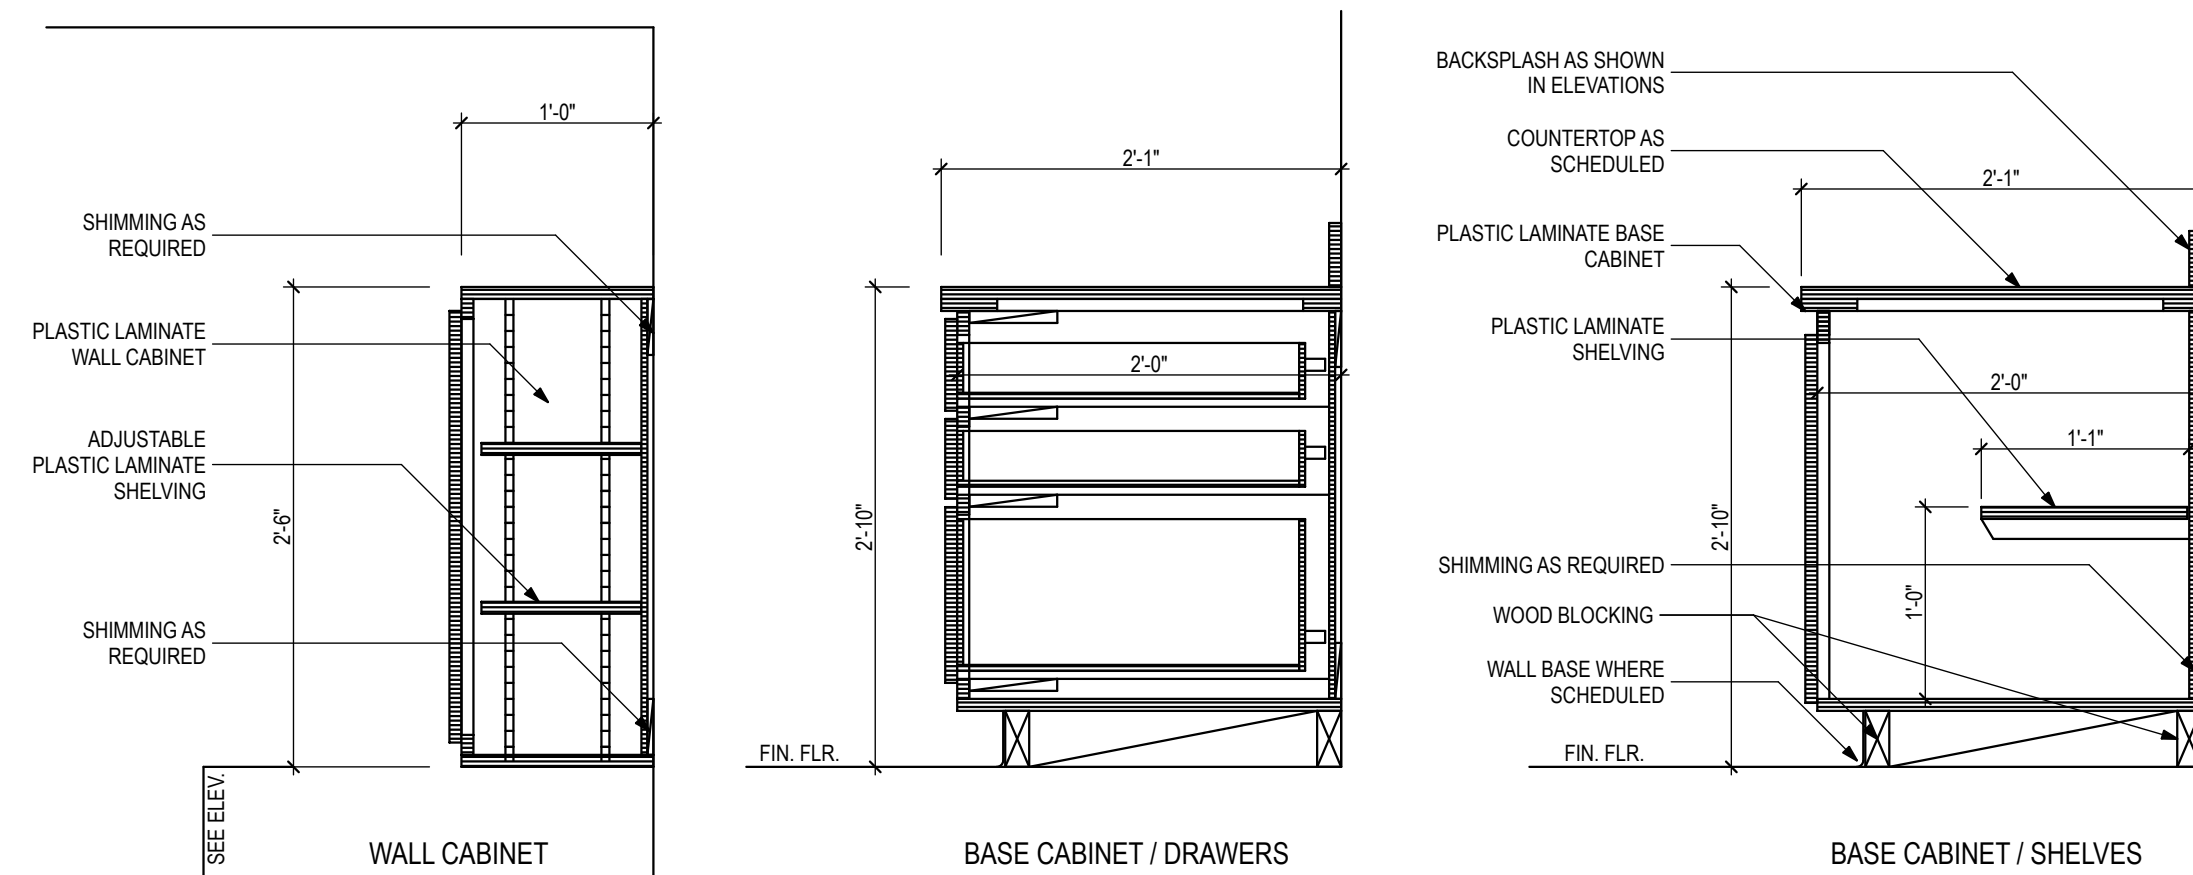

4 MILLWORK
SCALE: 1" = 1'-0"

KITCHEN EQUIPMENT SCHEDULE

ICE MACHINE:	HOSHIZAKI KM-301BJ, CRESENT CUBE ICEMAKER 30" WIDE X 28" DEEP X 39" HIGH 265 LBS ICE PRODUCED 24 HRS / 100 LBS STORAGE
WARMING CABINETS:	NON-INSULATED HOLDING CABINETS CRES COR, 131-UA-11B 26" WIDE X 32" DEEP X 70" HIGH MOBILE (ROLLING)
REFRIGERATOR:	NORLAKE ADVANTEDGE NLR23-S 27.5" WIDE X 33" DEEP X 84" HIGH
FREEZER:	NORLAKE ADVANTEDGE NLF23-S 27.5" WIDE X 33" DEEP X 84" HIGH
COFFEE MAKER:	BUNN, CWT1F35-APS AIRPOT SYSTEM W/ GOURMET FUNNEL AIRPOT DISPENSED COFFEE 9" WIDE X 21.5" DEEP X 24.1" HIGH PLUMBED WATER ACCESS - 1/4" MALE FLARE

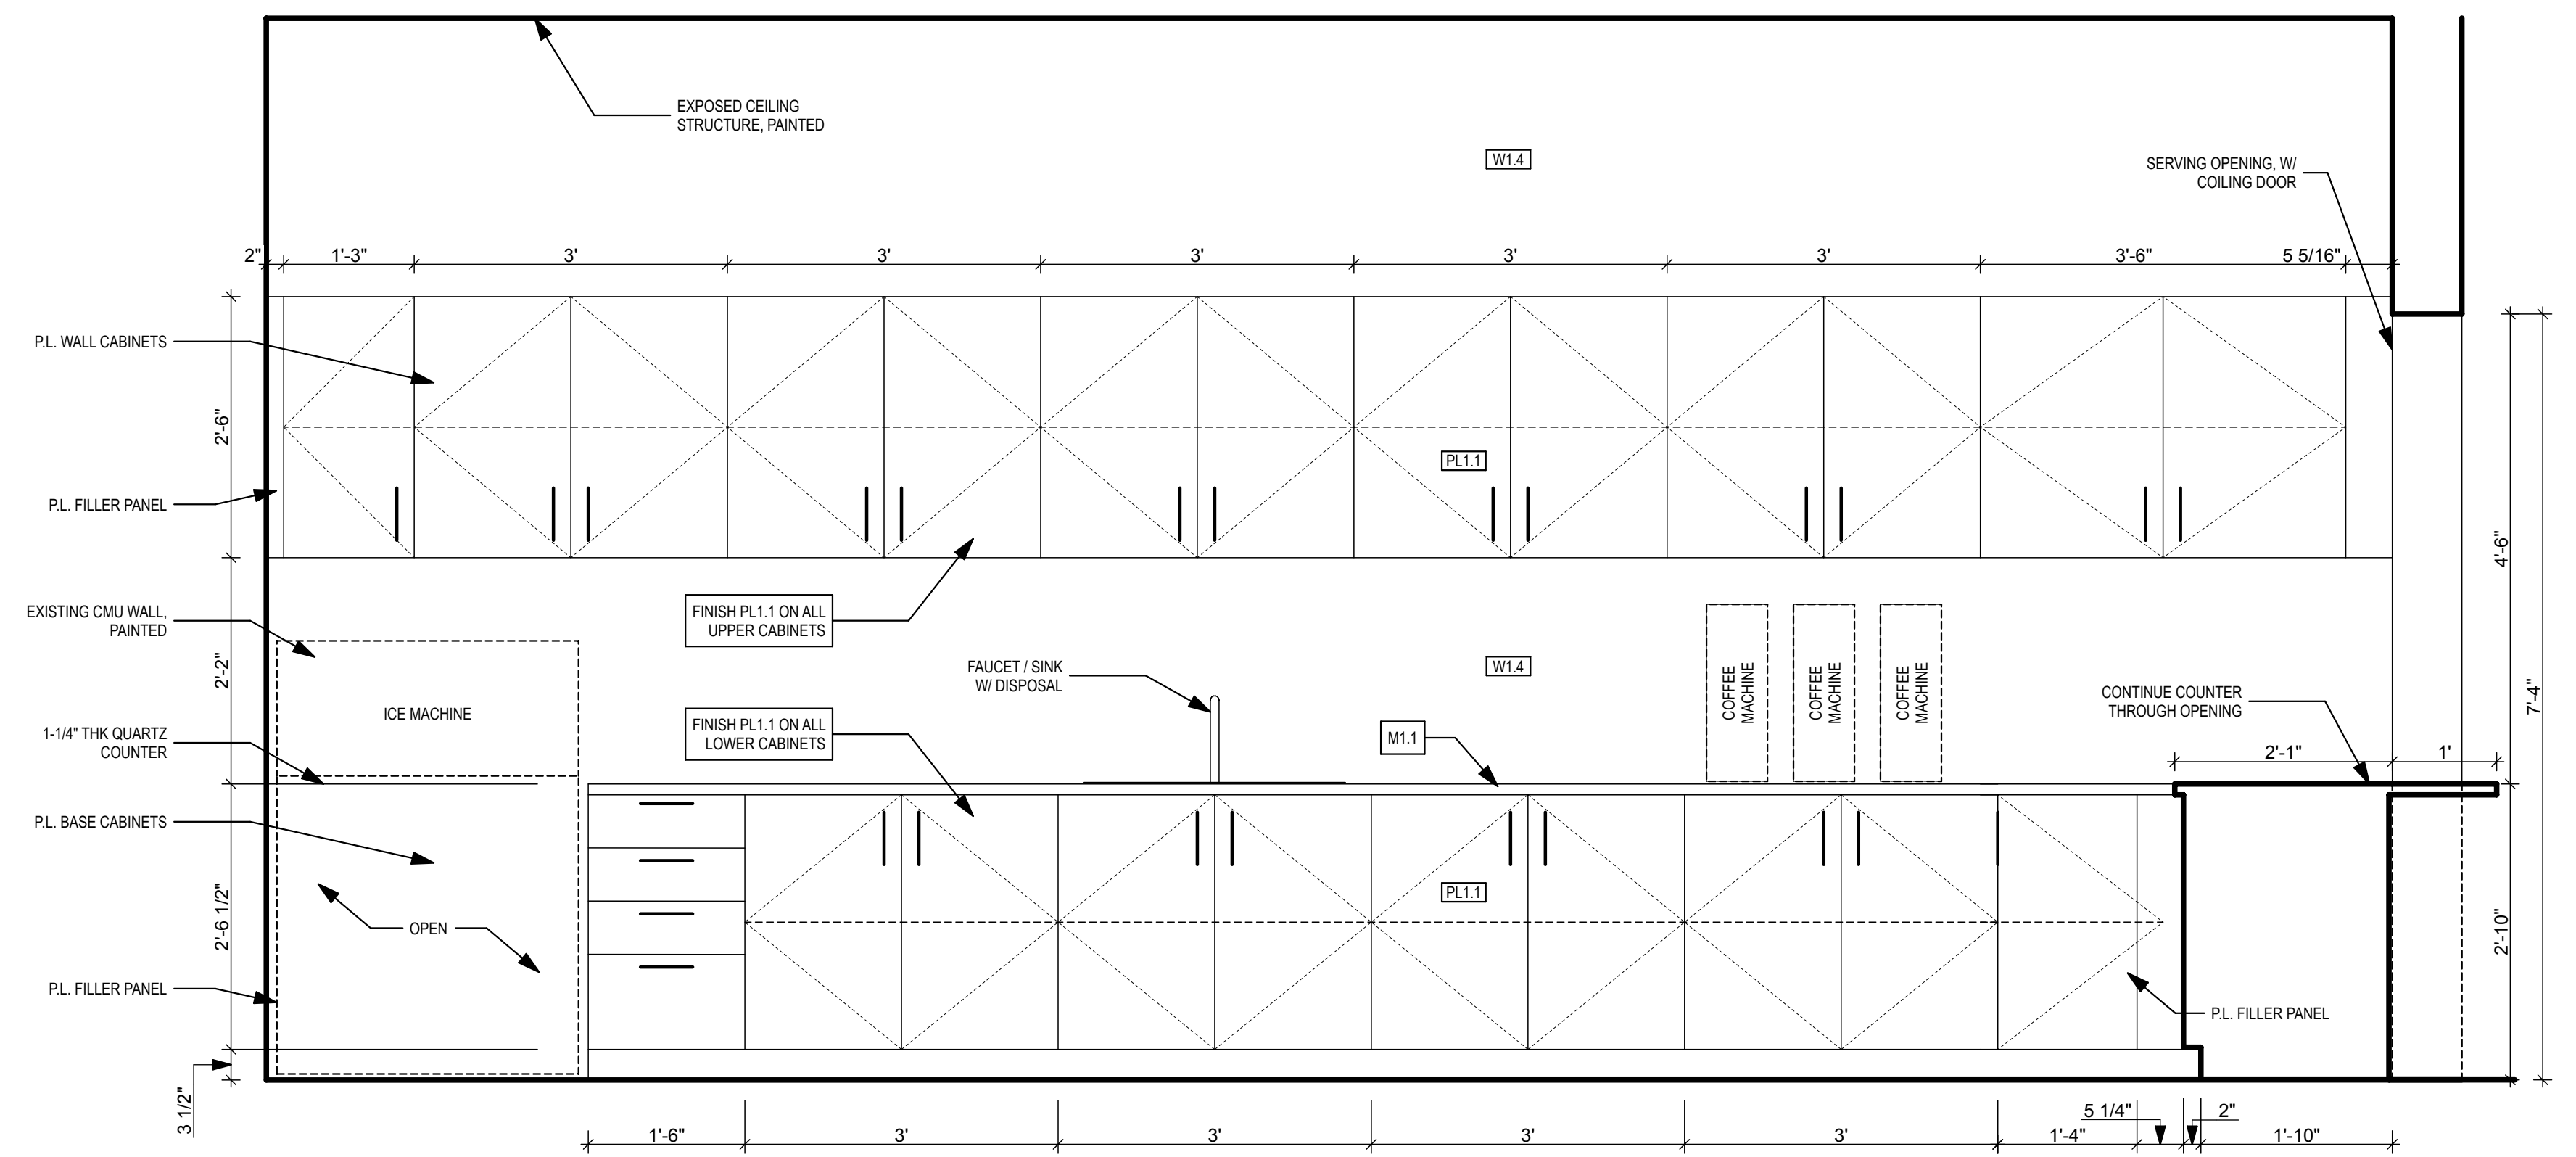


1 KITCHEN WALL WEST
SCALE: 3/4" = 1'-0"

NOTE: CONTRACTOR SHALL PROVIDE SHOP DRAWINGS PRIOR TO CONSTRUCTION. COORDINATE WITH ARCHITECT.

ID	REVISION	EDITED	REVIEWED	DATE


Client: Celebration Baptist Church
3900 Shamrock St. E.
Tallahassee, FL 32309

Project Title: Canopy and Corridor Improvements

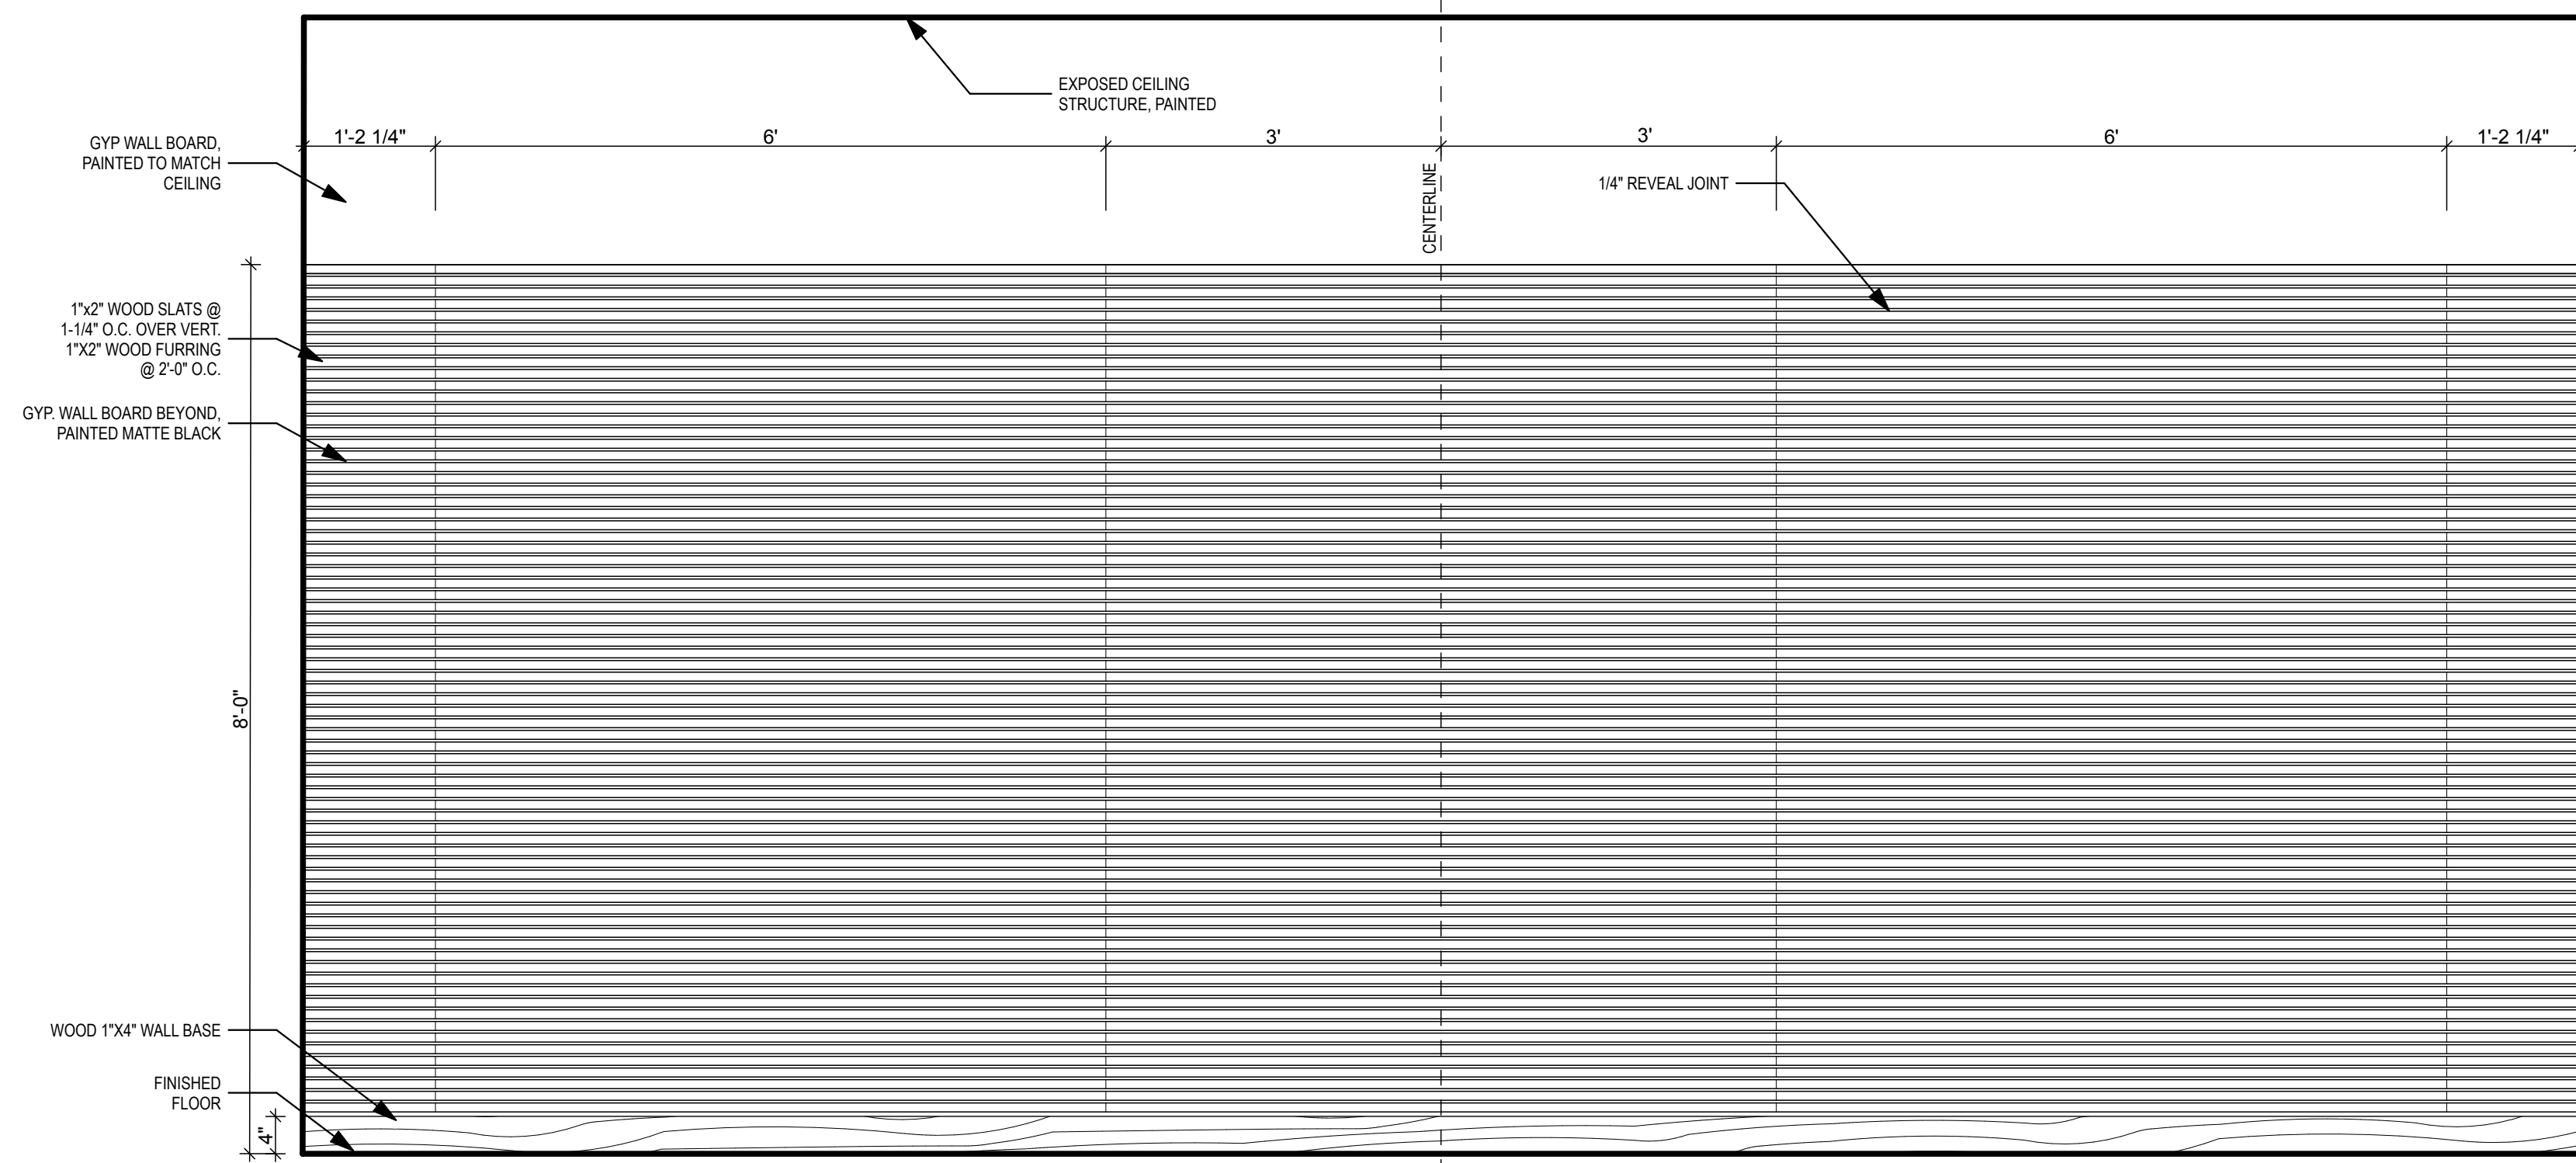


3 CORRIDOR EAST
SCALE: 3/4" = 1'-0"

NOTE: CONTRACTOR SHALL PROVIDE SHOP DRAWINGS PRIOR TO CONSTRUCTION. COORDINATE WITH ARCHITECT.

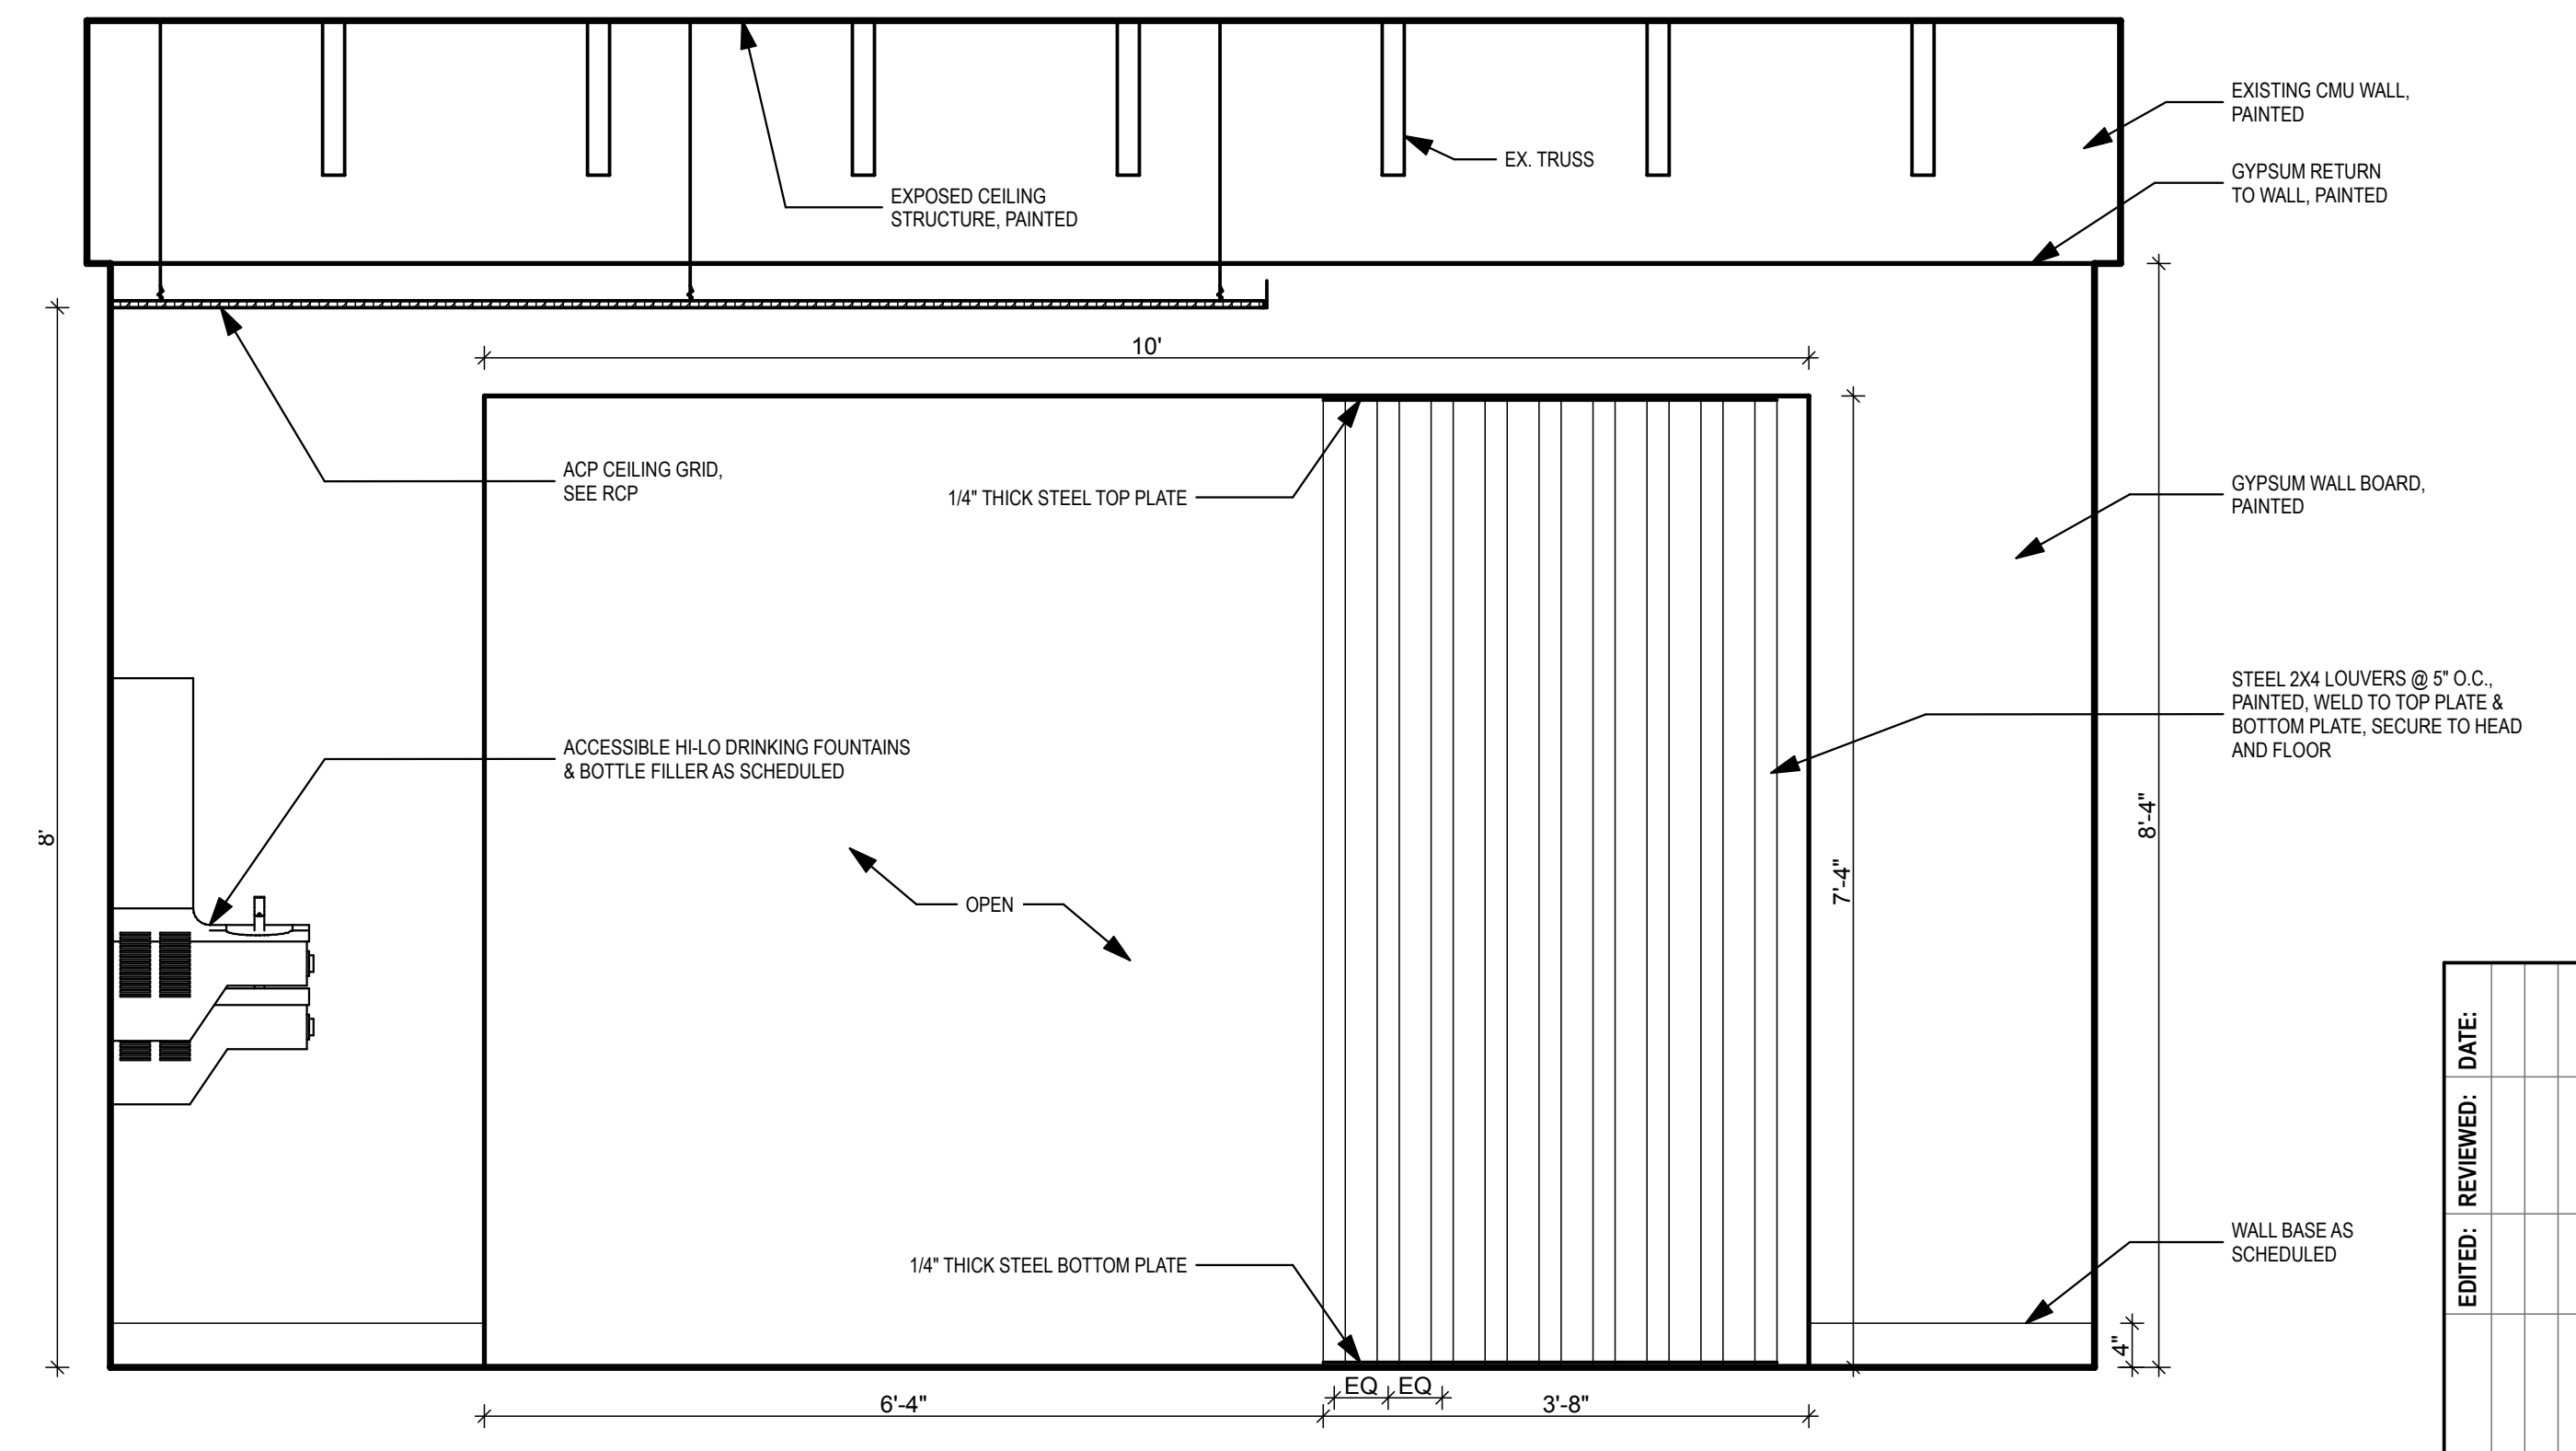


2 CORRIDOR NORTH
SCALE: 3/4" = 1'-0"

ALTERNATE WOOD SLAT VENEER
BASIS OF DESIGN: ARMSTRONG WOODWORKS GRILLE
BACKER, 1-3/8" BLADES, COLOR: GRILLE MAPLE (GMP)
ATTACH TO WALL PER MANUF. GUIDELINES
[CONTACT: WWW.ARMSTRONG.COM](http://CONTACT.WWW.ARMSTRONG.COM)
(877) 276-7876

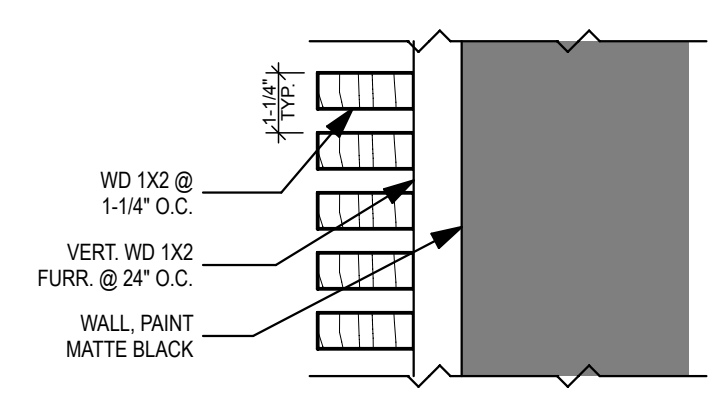

OPTION TO CUSTOM BUILD: POND CYPRESS, STAIN TBD.
SUBMIT SAMPLES AND SHOP DRAWING TO ARCHITECT FOR APPROVAL PRIOR TO ACCEPTANCE.

4 WOOD SLATS
SCALE: 3" = 1'-0"

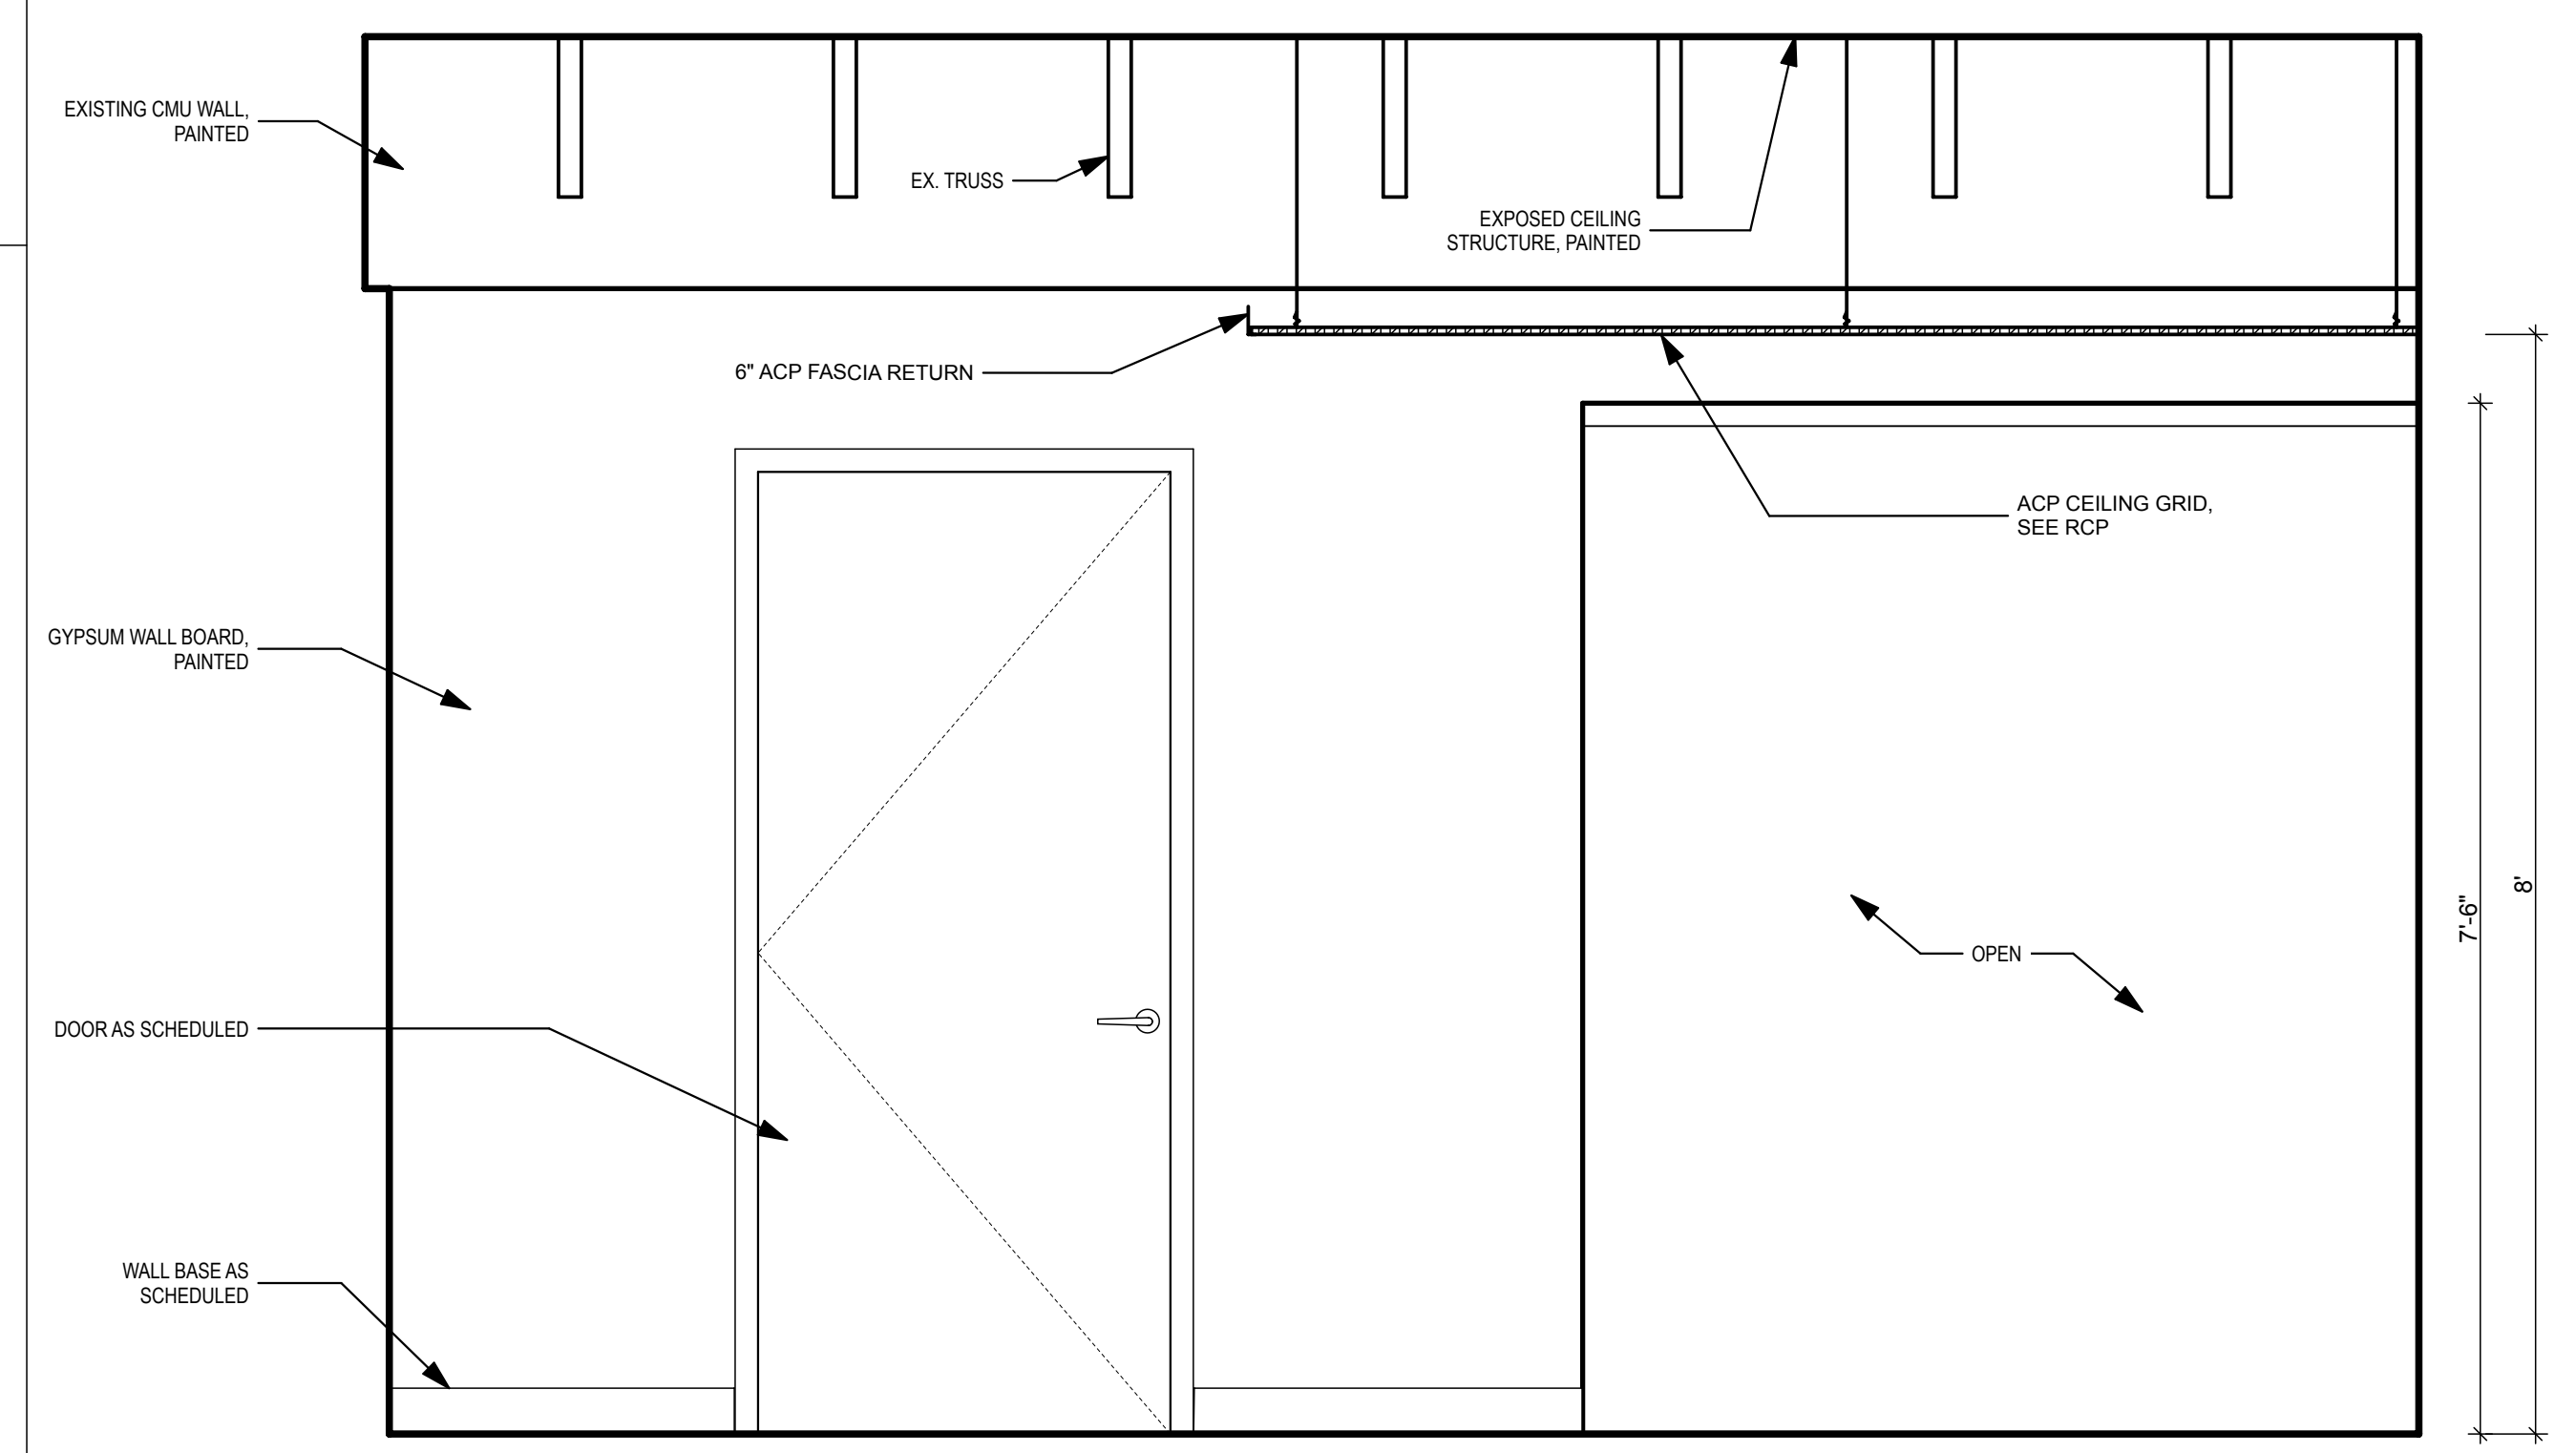

1 CORRIDOR SOUTH
SCALE: 3/4" = 1'-0"

ID	REVISION	EDITED	REVIEWED	DATE

PHASE	DRAWN	REVIEWED	DATE
CONCEPT SCHEM. DESIGN	H. Layerd	H. Layerd	08/20/2024
ADVANCED SCHEM. DESIGN	J. McKee	H. Layerd	07/23/2024
DESIGN DEVELOPMENT	J. McKee	H. Layerd	07/23/2024
CONSTRUCTION DOCS 90%	J. McKee	H. Layerd	07/23/2024
CONSTRUCTION DOCS 100%	J. McKee	H. Layerd	07/23/2024
PERMIT DOCS	J. McKee	H. Layerd	07/23/2024

Client: **Celebration Baptist Church**
3900 Shamrock St. E.
Tallahassee, FL 32309

Project Title: **Canopy and Corridor Improvements**


Consultant: Civil
Plainman ENGINEERING

Consultant: MEP
FSM Engineering

Consultant: Structural
KM KEVER MCKEE ENGINEERING


Architect:
HAYS LAYERD ARCHITECTURE

Seal:

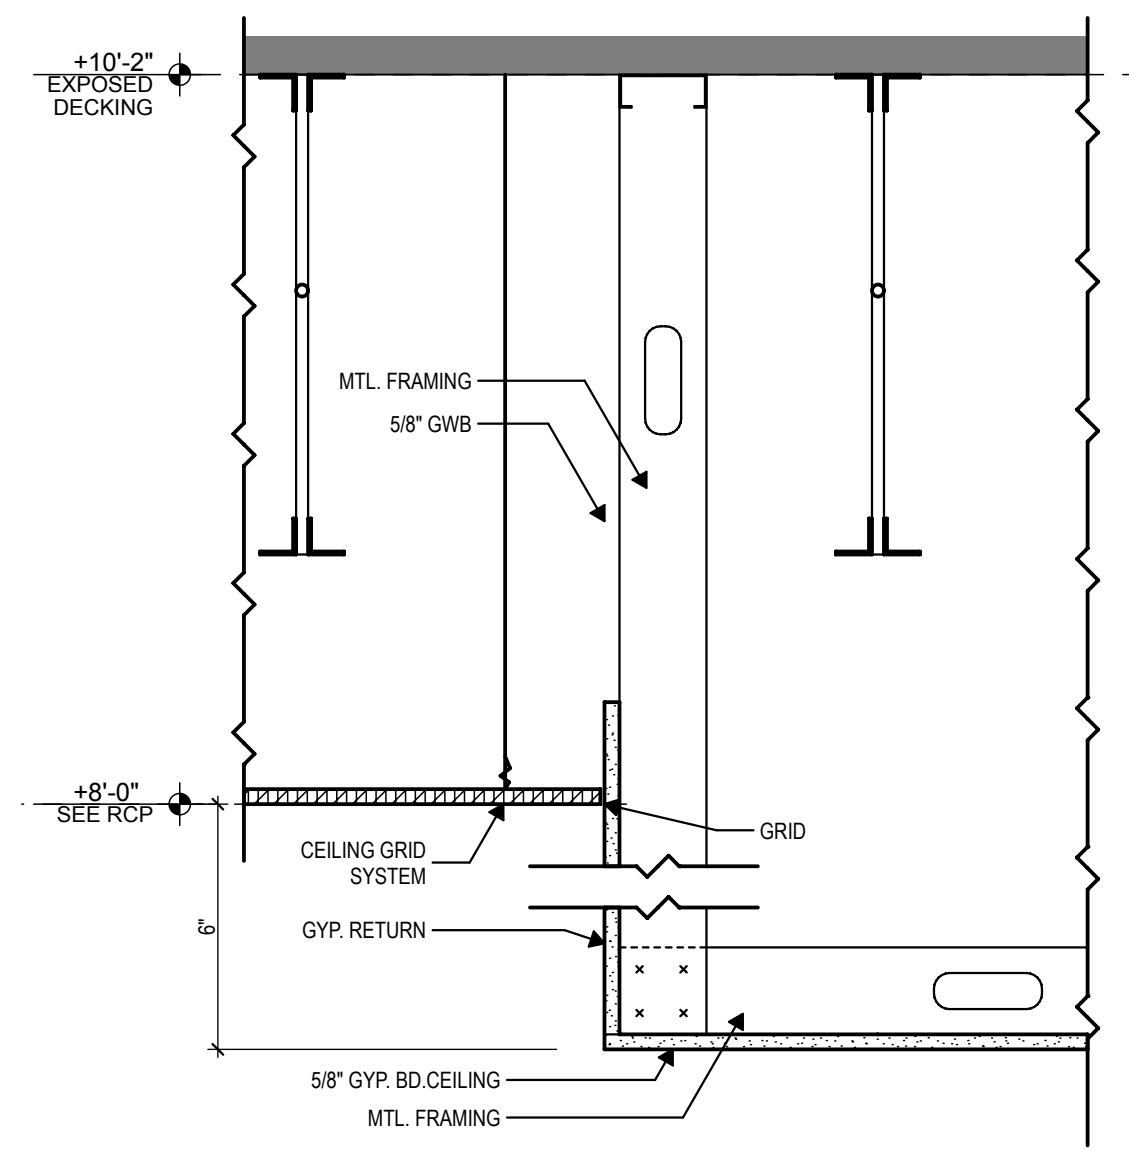

2 TYPICAL BULKHEAD

SCALE: 1 1/2" = 1'-0"

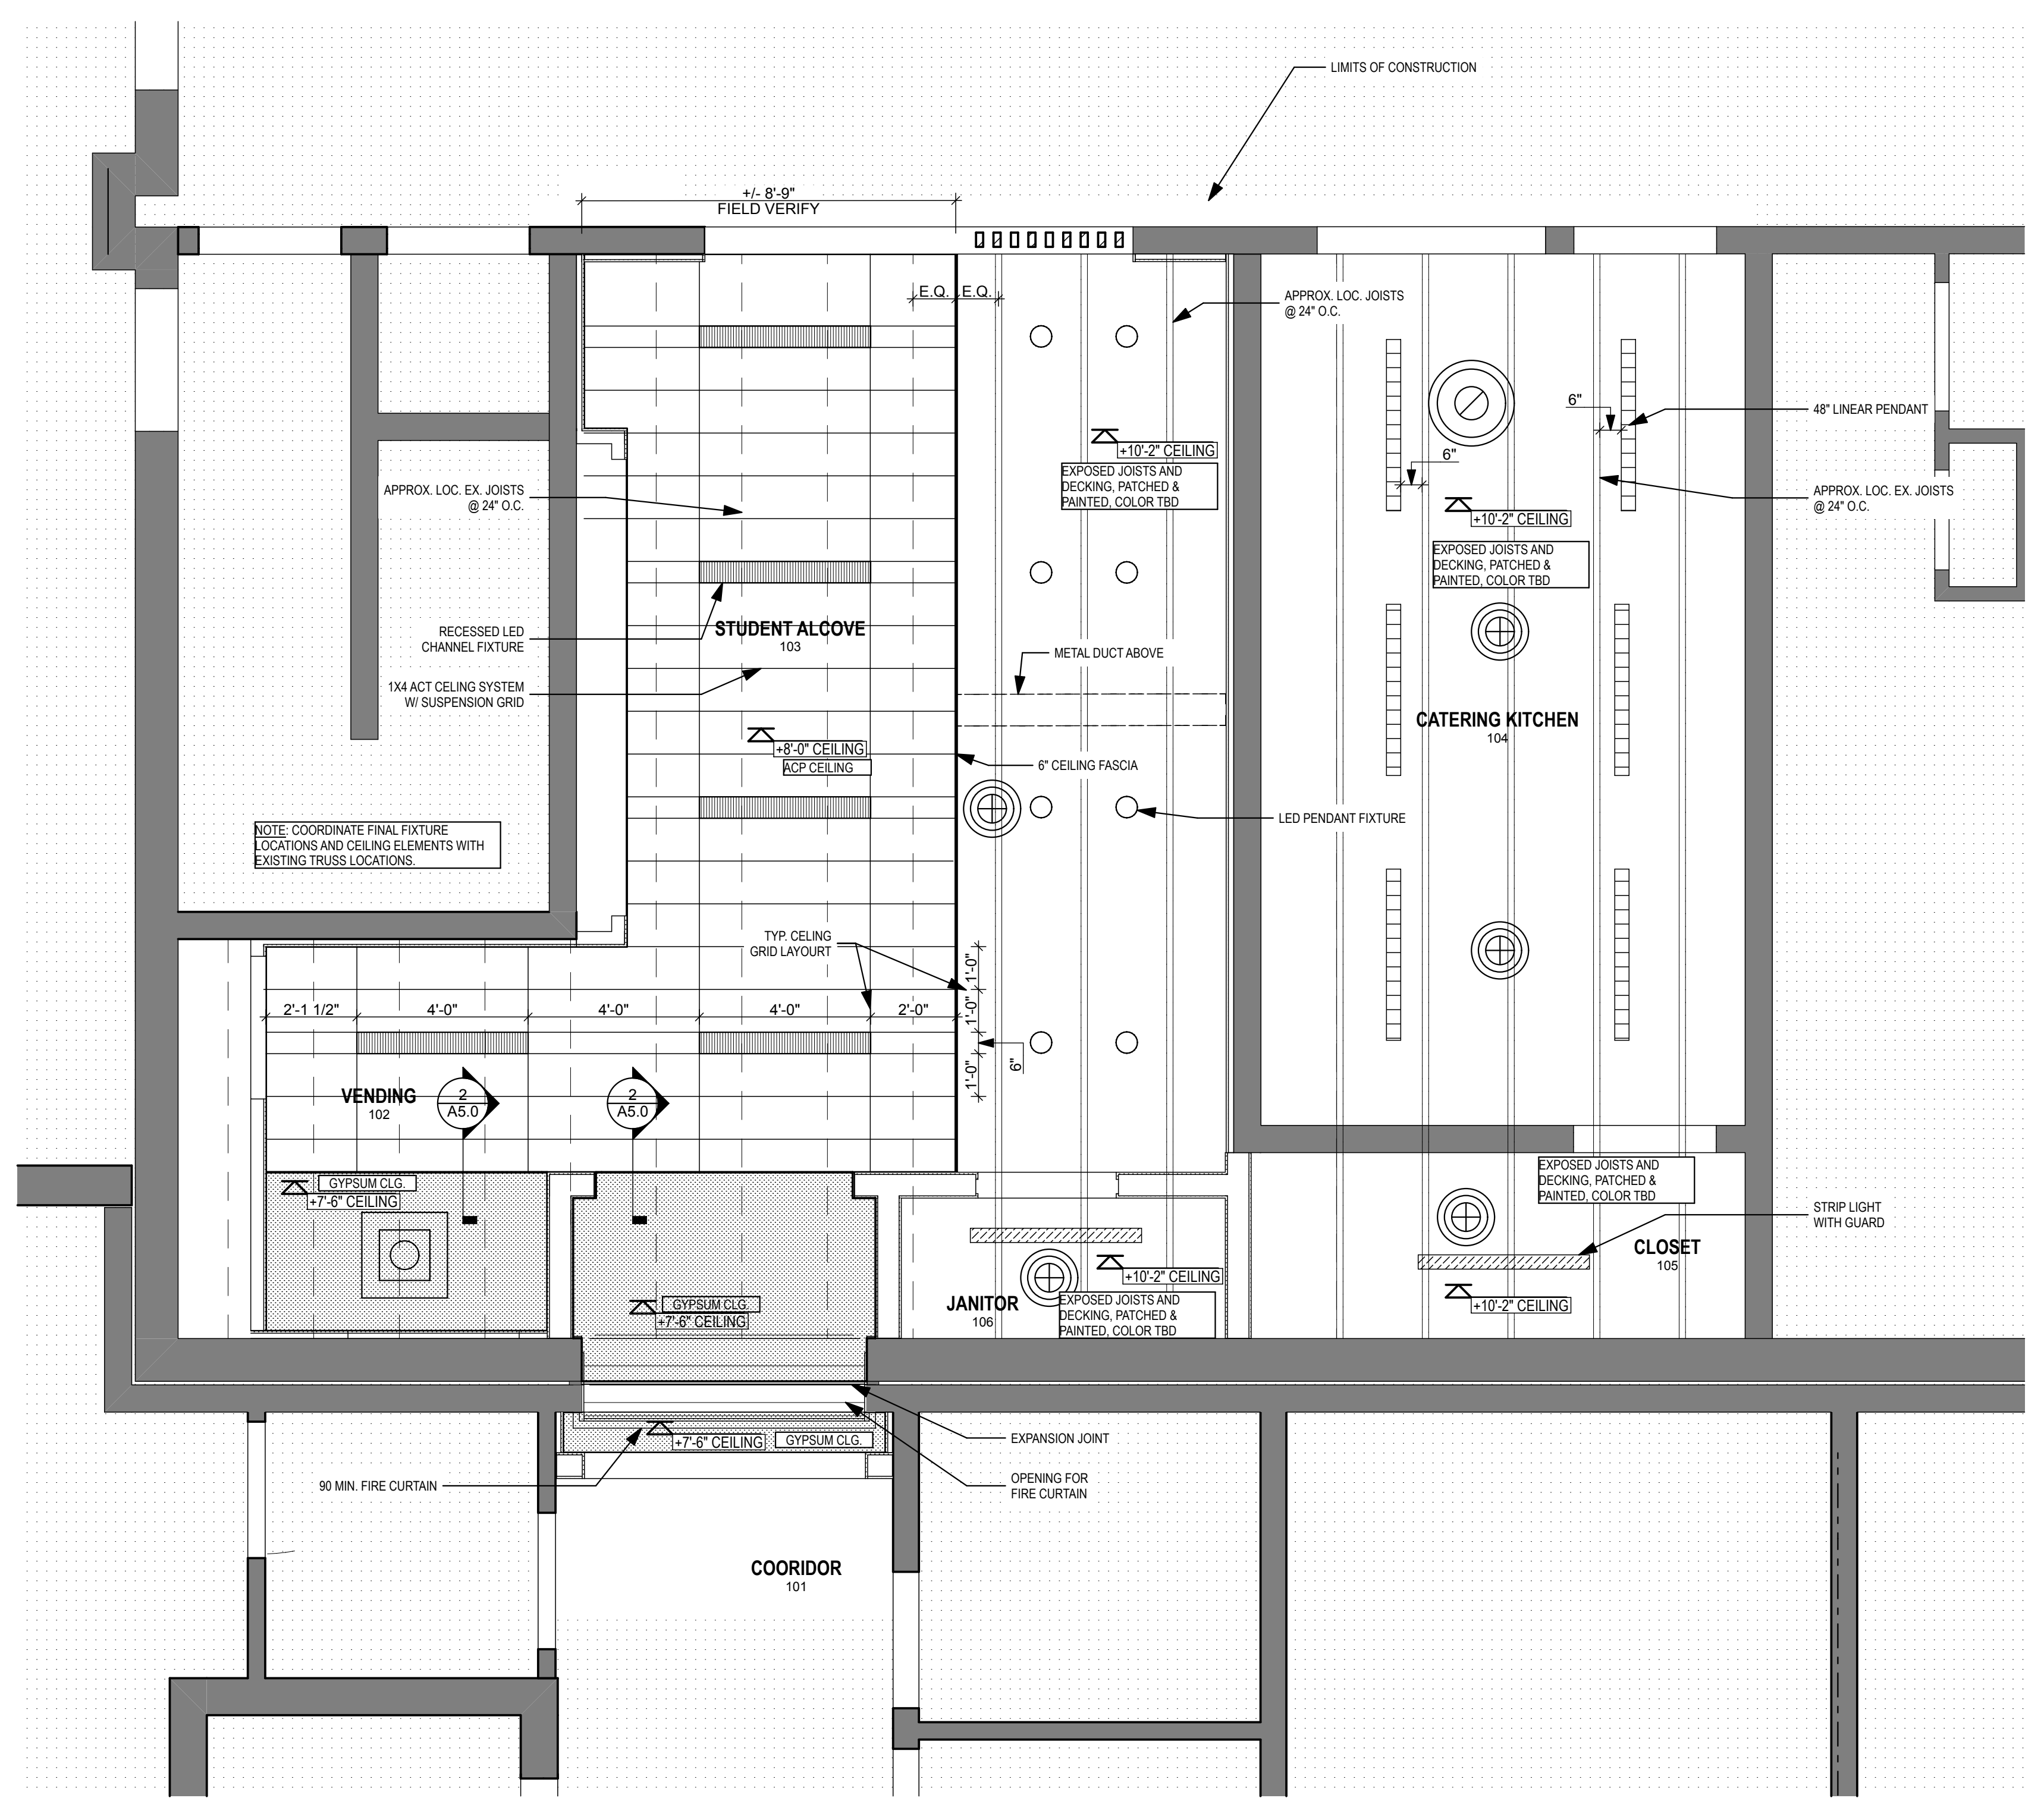



1 FIRST FLOOR REFLECTED CEILING PLAN

SCALE: 3/8" = 1'-0"

NOTE:
VERIFY ACP CEILING ALIGNMENT WITH ARCHITECT PRIOR TO INSTALL. DESIGN INTENT IS TO MAINTAIN WHOLE PANEL PIECES WHERE POSSIBLE.

RCP LEGEND

3/16" = 1'-0"

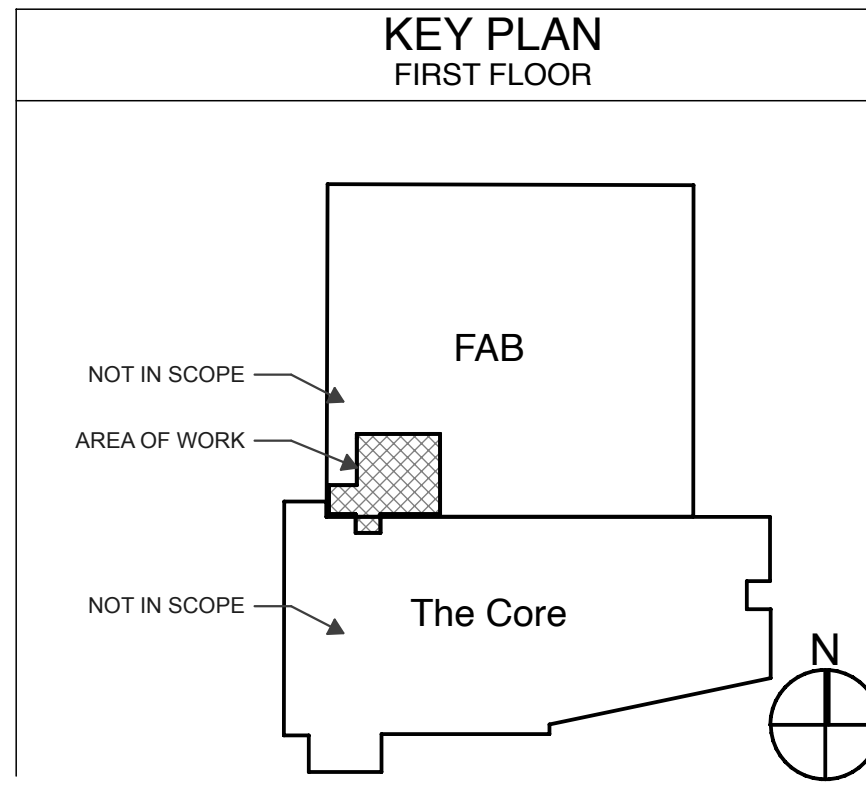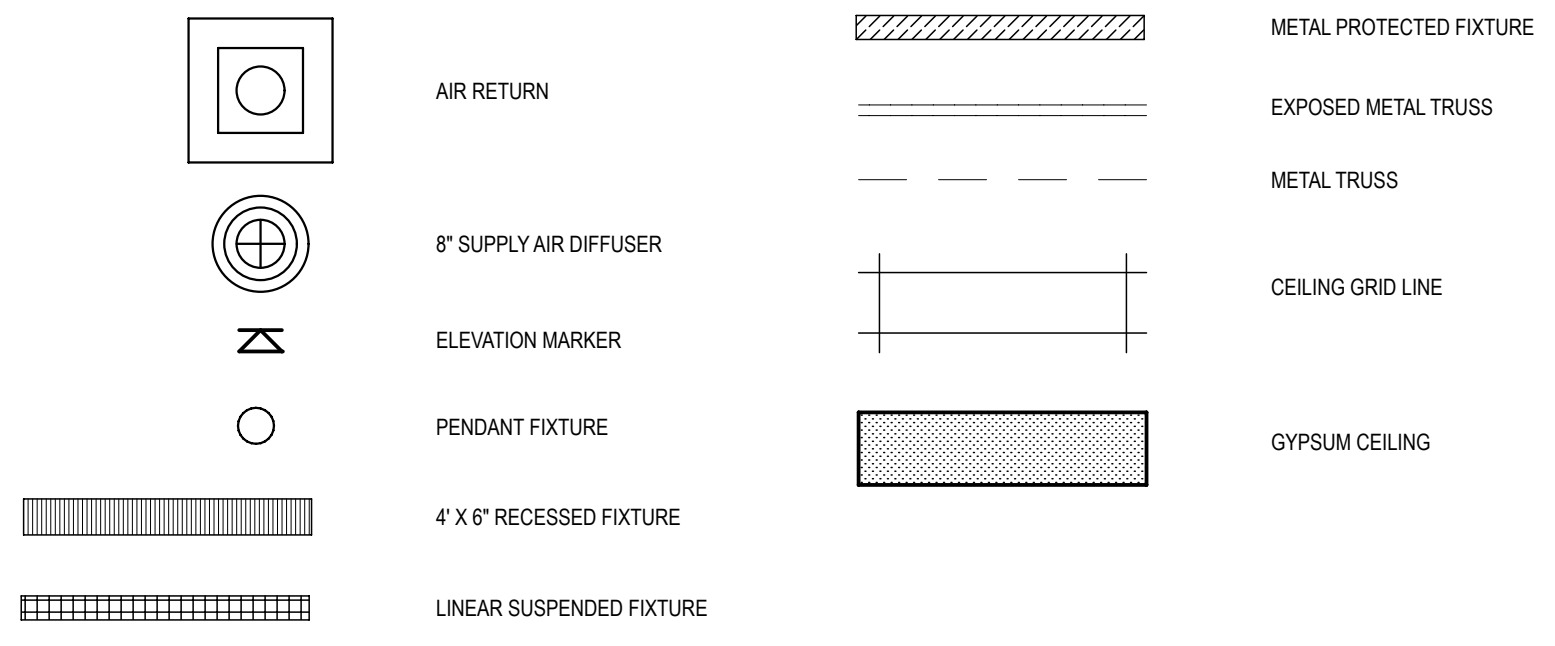

PHASE:	DRAWN:	REVIEWED:	DATE:	ID:	REVISION:	EDITED:	REVIEWED:	DATE:
CONCEPT SCHEM. DESIGN	H. Layerd	H. Layerd	10/20/24					
ADVANCED SCHEM. DESIGN	H. Layerd	H. Layerd	11/17/24					
DESIGN DEVELOPMENT	J. Hayes	H. Layerd	11/27/24					
CONSTRUCTION DOCS 90%	J. Hayes	H. Layerd	12/10/24					
CONSTRUCTION DOCS 100%	J. Hayes	H. Layerd	01/06/25					
PERMIT DOCS								

Client:
Celebration Baptist Church
3900 Shamrock St. E.
Tallahassee, FL 32309

Project Title:
Canopy and Corridor Improvements

Consultant:
Civil
Plainman ENGINEERING


Consultant:
MEP
FSM Engineering

Consultant:
Structural
KM KEVER MCKEE ENGINEERING

Architect:
HAYS LAYERD ARCHITECTURE


Seal:

Sheet No.
A5.0
REFLECTED CEILING PLAN

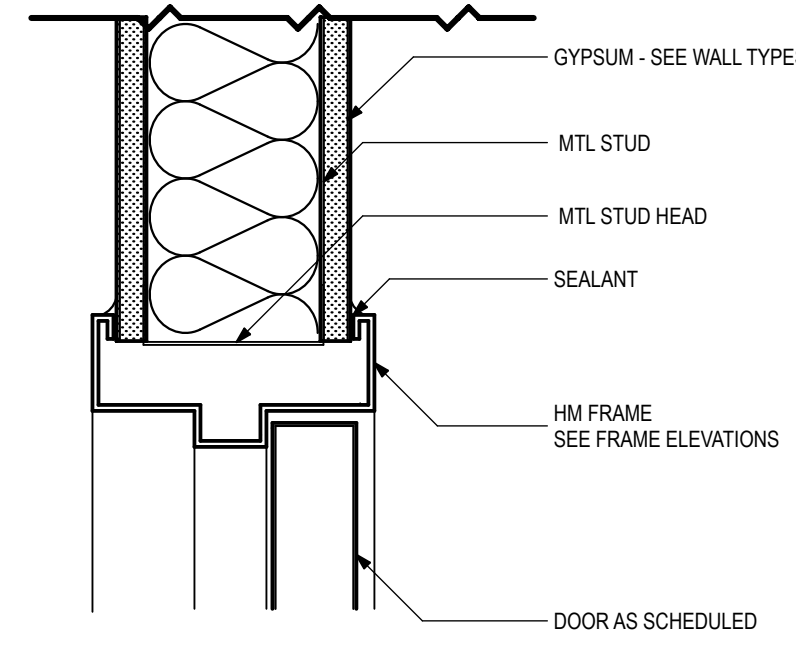


HM Door Head - Mtl. Stud

3" = 1'-0"

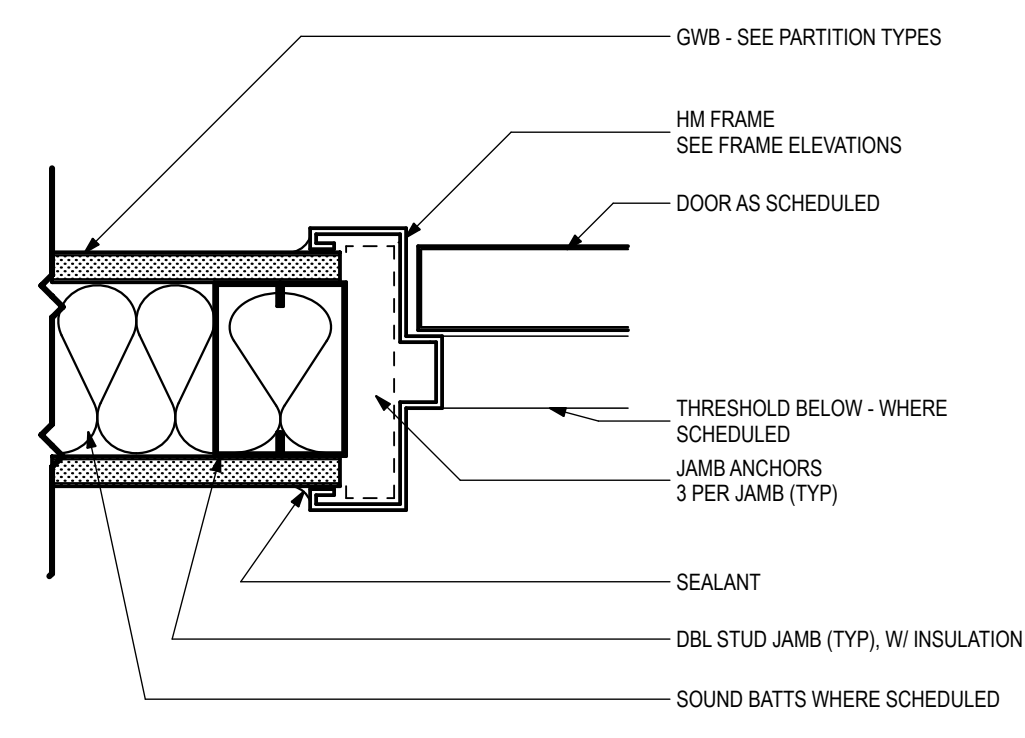


HM Door Jamb - Mtl Stud

3" = 1'-0"

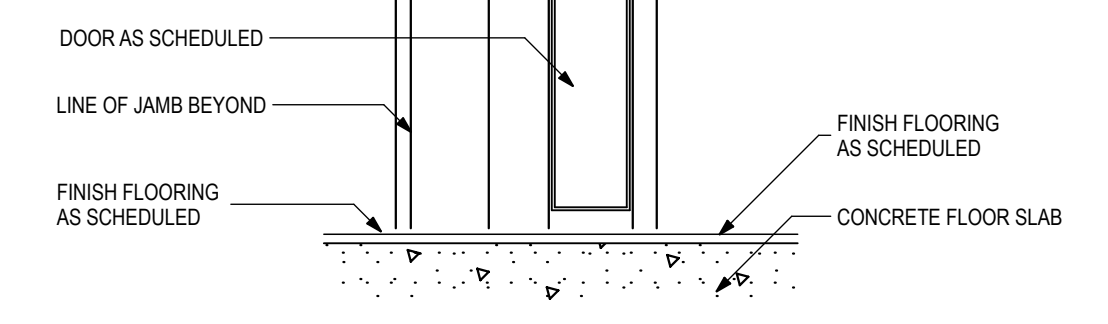


Interior Door - No Transition

3" = 1'-0"

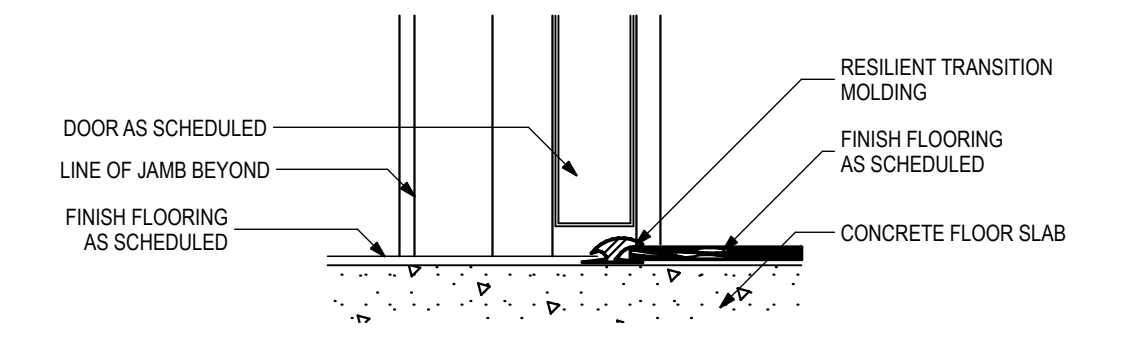


Interior Door - Threshold

3" = 1'-0"

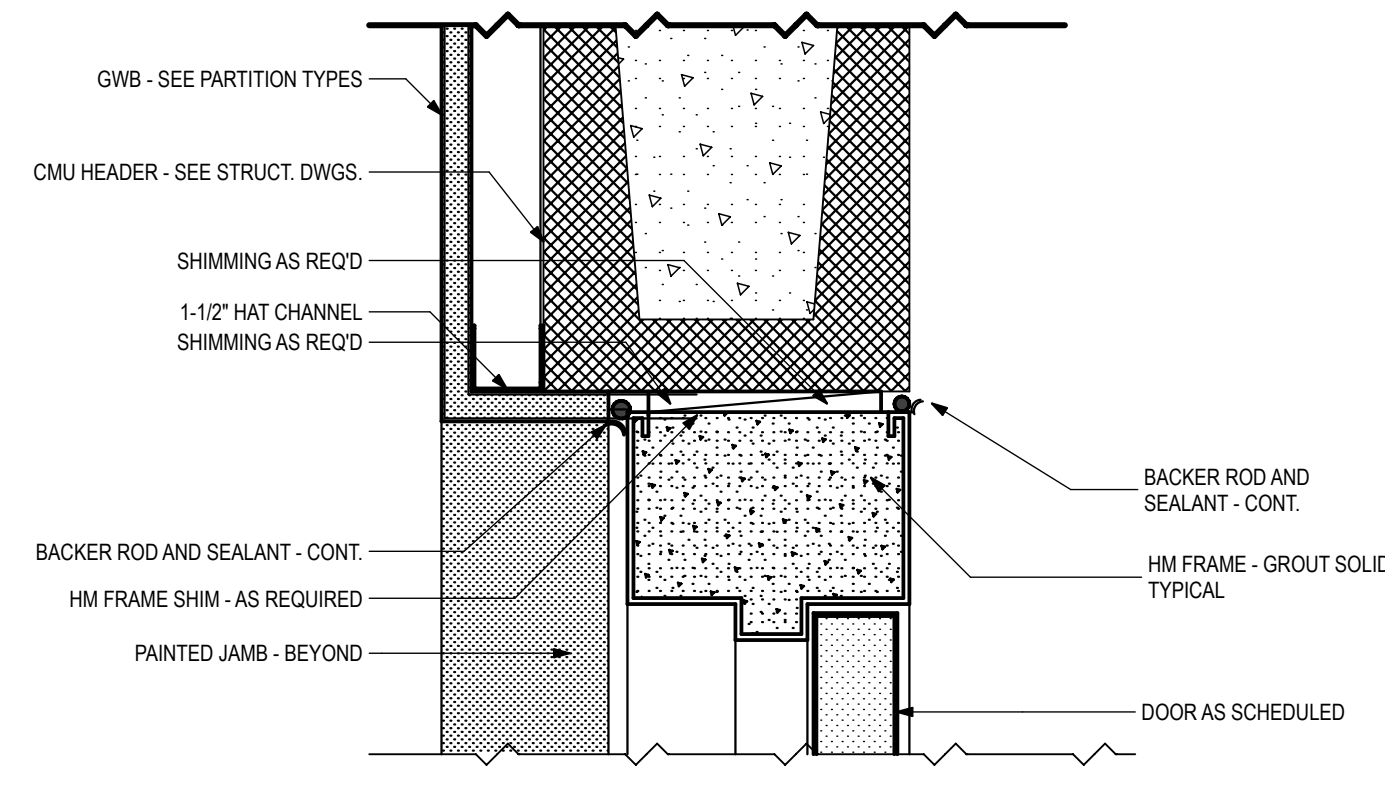


HM Door Head - CMU

3" = 1'-0"

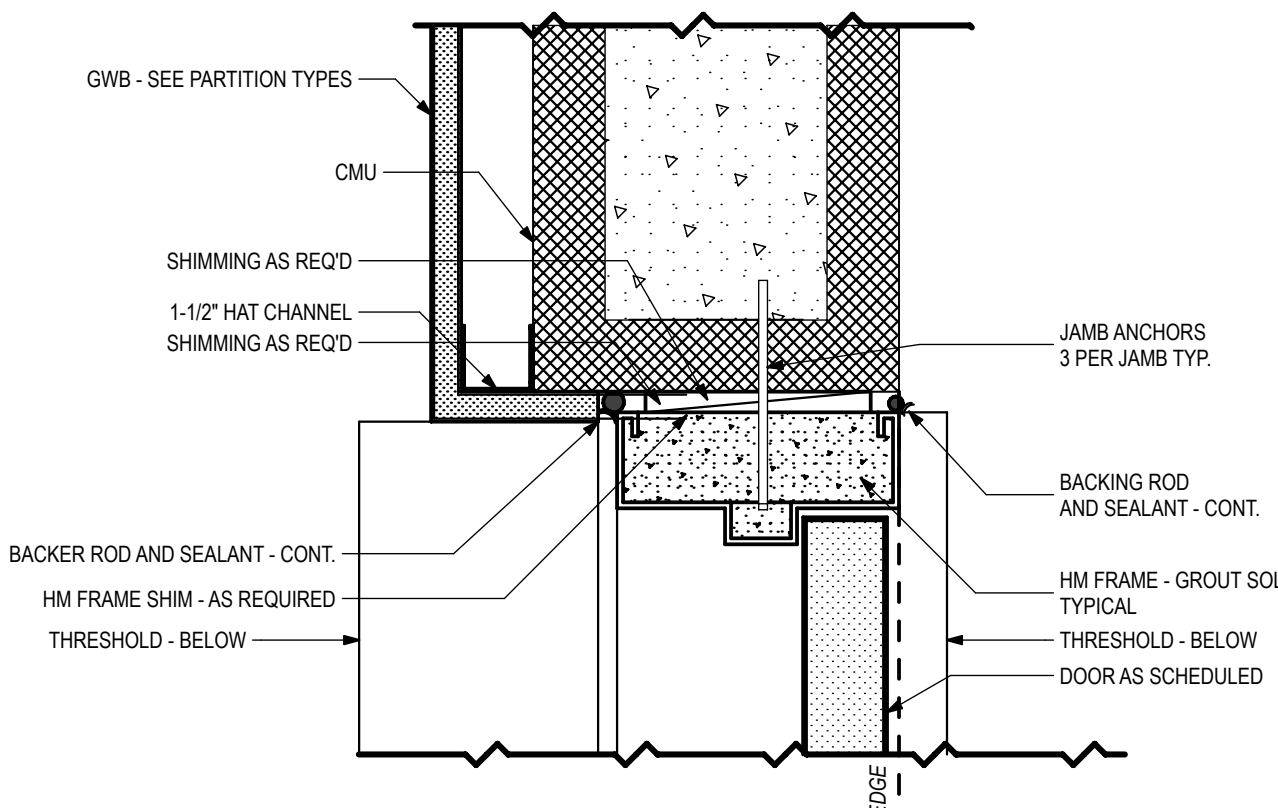


HM Door Jamb - CMU

3" = 1'-0"

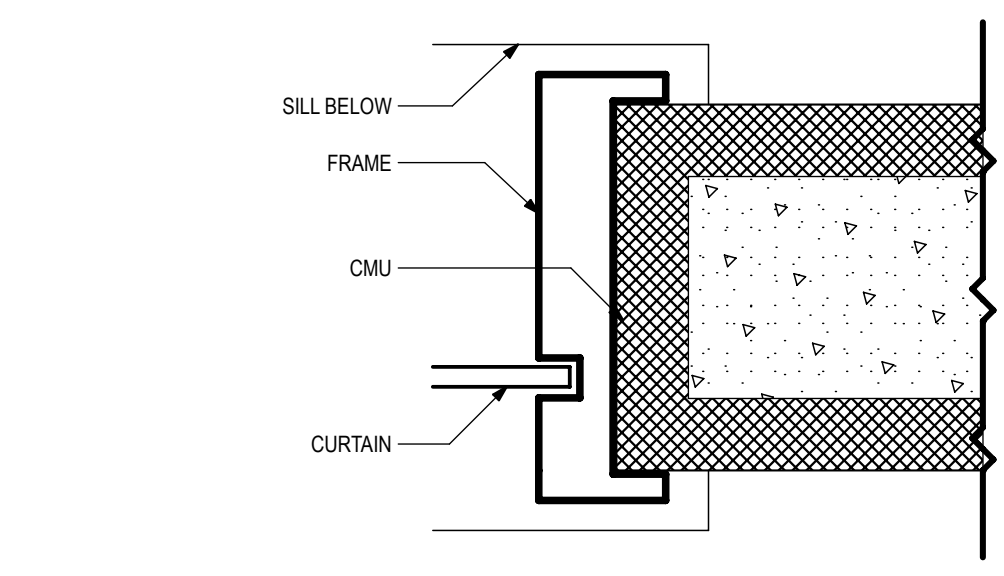

Overhead Door Jamb - CMU

3" = 1'-0"

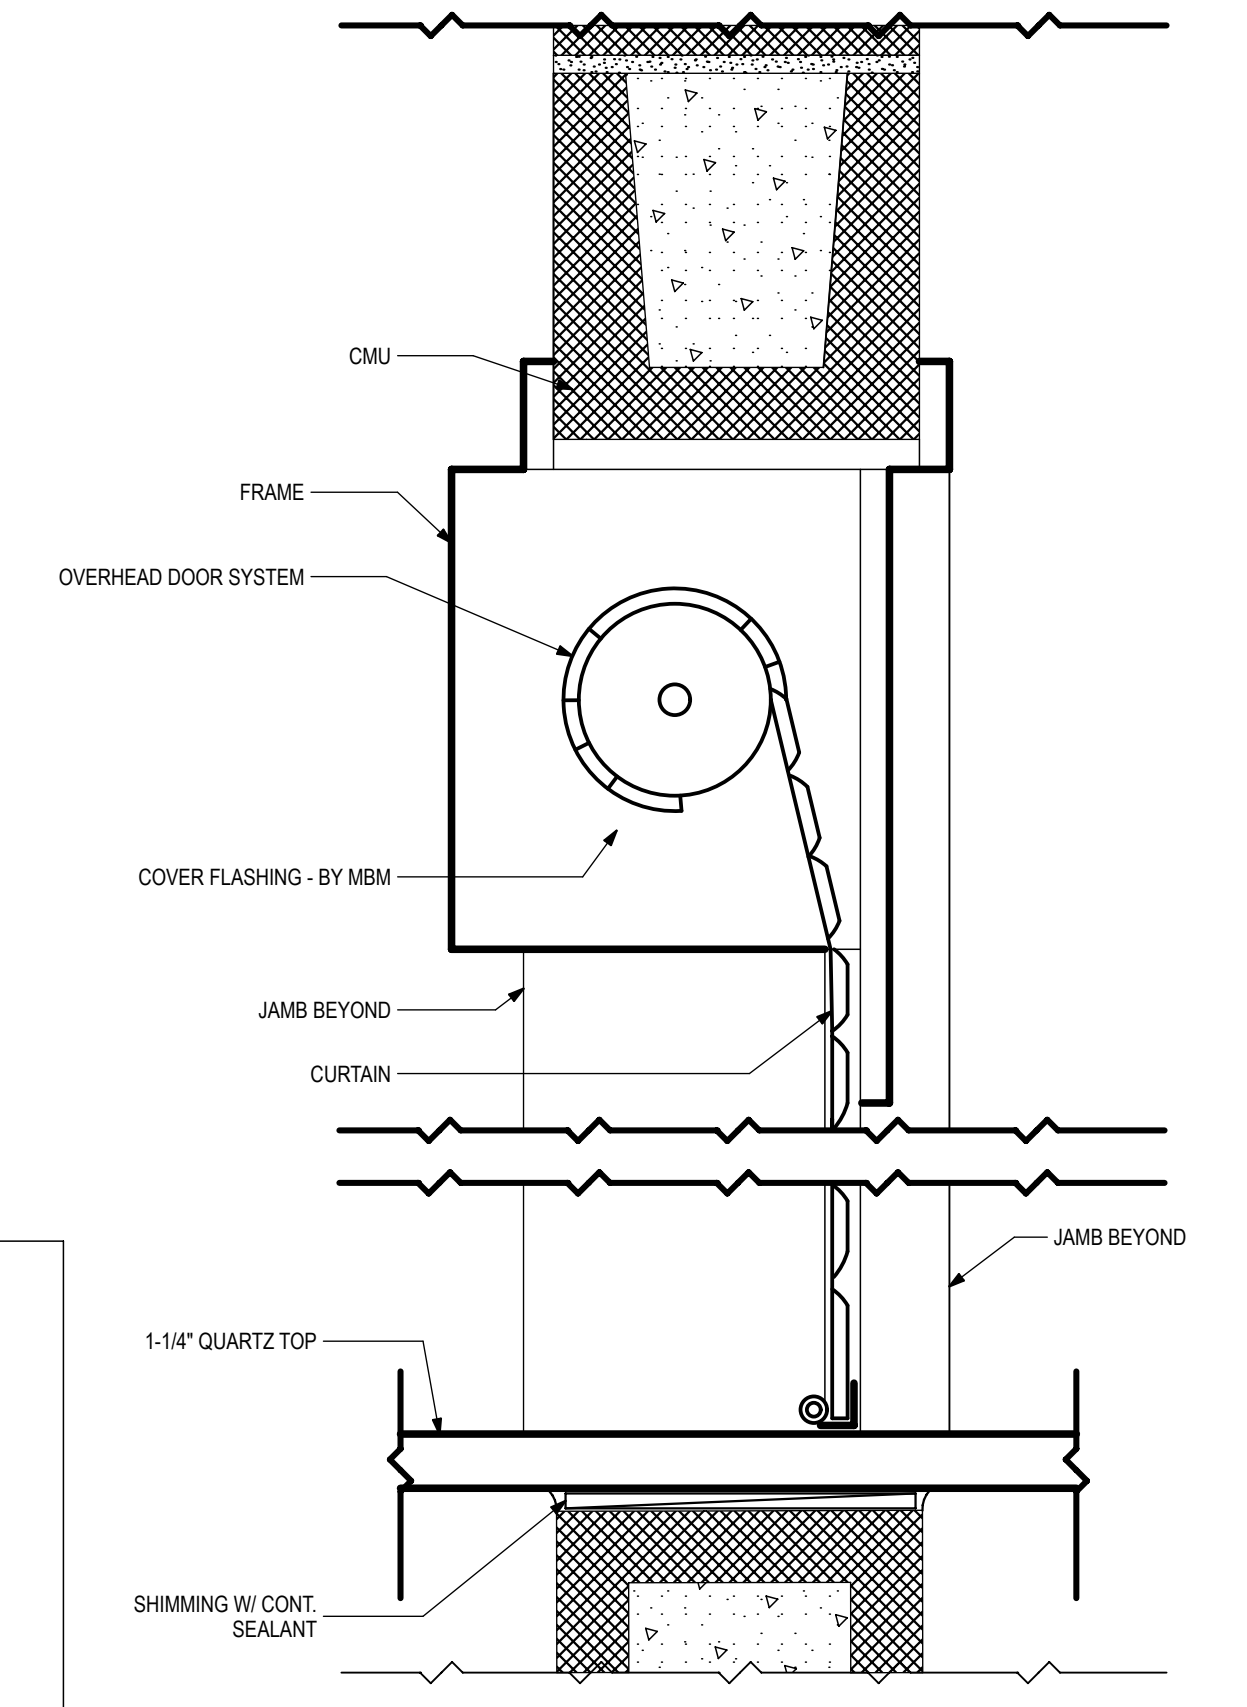

Overhead Door Head - CMU

3" = 1'-0"

1 DOOR DETAILS
SCALE: 3" = 1'-0"

DOOR NO	DOOR								NOTES	FRAME						LABEL	SIGN	HWR SET	REMARKS
	ELEV.	WIDTH	HEIGHT	THK	MATL	FINISH	COLOR	ELEV.		HEAD	JAMB	THR.	MATL	FINISH	COLOR				
GROUND FLOOR																			
D101	-	6'-4"	8'-0"	-	FA	FA	-	-	-	-	-	FA	FA	FA	90 MIN.	-	FIRE CURTAIN		
D102	A	3'-0"	7'-0"	1-3/4"	WD	FA	-	2	HM1	-	-	HM	ST	-	-	2.0			
D103A	A	PR (3'-0")	7'-0"	1-3/4"	WD	FA	-	1 / 2 / 3	HM2	-	-	HM	ST	-	90 MIN.	3.0			
D103B	A	3'-0"	7'-0"	1-3/4"	WD	FA	-	2	HM1	-	-	HM	ST	-	-	2.0			
D104A	A	3'-0"	7'-0"	1-3/4"	WD	FA	-	2	HM2	-	-	HM	ST	-	-	1.0			
D104B	A	3'-0"	7'-0"	1-3/4"	WD	FA	-	2	HM2	-	-	HM	ST	-	-	2.0			
D104C	B	5'-4"	4'-0"	-	S	FA	-	-	S1	-	-	S	FA	FA	-	-	OVERHEAD COILING COUNTER WINDOW		

LEGEND

S STEEL
FA FACTORY
HM HOLLOW METAL
PT PAINT
ST STAIN

NOTES

1. DOOR SHALL HAVE PANIC HARDWARE
2. DOOR PANEL WOOD AND STAIN TO MATCH EXISTING CORE BUILDING DOORS
3. HELD ON ELECTRONIC HOLD OPENS

COILING ROLL-UP COUNTER WINDOW


BASIS OF DESIGN: 650 METAL CURTAIN ROLLING COUNTER DOOR
MANUFACTURER: OVERHEAD DOOR CORPORATION
MATERIAL: PAINTED GALVANIZED STEEL
SLAT: F-158
OPENING: 5'-4" WIDE X 4'-8" HIGH
MOUNTING: BETWEEN JAMB MOUNTED, PUSH-UP, INTEGRAL FRAME
FEATURES: GUIDES AND HOOD PAINTED TO MATCH.
CONTACT: OVERHEADDOOR.COM
(800) 929-DOOR

Client: Celebration Baptist Church 3900 Shamrock St. E. Tallahassee, FL 32309	PROJECT TITLE:	Canopy and Corridor Improvements	
	PROJECT NO.:		
	DATE:		
	SCALE:		
	DRAWN BY:		
DESIGNED BY:	DATE:	REVISION:	DATE:
CONCEPT DESIGN	12/10/2024	REVISION:	DATE:
ADVANCED DESIGN	1/22/2025	REVISION:	DATE:
PERMIT DOCS 90%	1/27/2025	REVISION:	DATE:
CONSTRUCTION DOCS 90%	2/10/2025	REVISION:	DATE:
CONSTRUCTION DOCS 100%	2/10/2025	REVISION:	DATE:
PERMIT DOCS	2/10/2025	REVISION:	DATE:

Consultant: Civil Plainman ENGINEERING	Consultant: MEP FSM Engineering	Consultant: Structural KM KEVER MCKEE ENGINEERING	Architect: Hays Layerd Architecture 1221 Summer Haven Ct. Franklin, TN 37069 850-559-8813 hays@hayslayerd.com FL License: AP06759	Seal:
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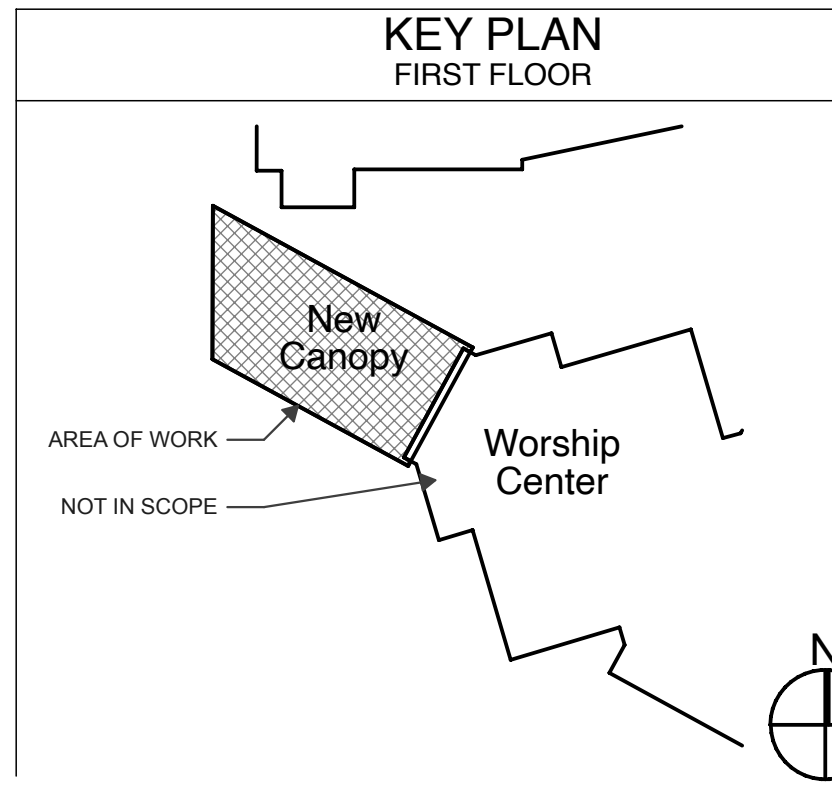
Project Title: Canopy and Corridor Improvements	Sheet No. A6.0
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EXTERIOR INDUSTRIAL FAN
 BASIS OF DESIGN: ESSENCE, 10 FT DIAMETER
 MANUFACTURER: BIG ASS FANS
 ENVIRONMENT: OUTDOOR
 WEIGHT: 81 LBS
 AIRFOIL CLEARANCE: 2 FT. ALL SIDES AND ABOVE
 COLOR: STEALTH BLACK – AIRFOILS, MOTOR, AND TRIM
 LIGHT: NO LIGHT KIT
 CONTACT: WWW.BIGASSFANS.COM
 (855) 852-9669

1 CANOPY FLOOR PLAN
 SCALE: 1/4" = 1'-0"

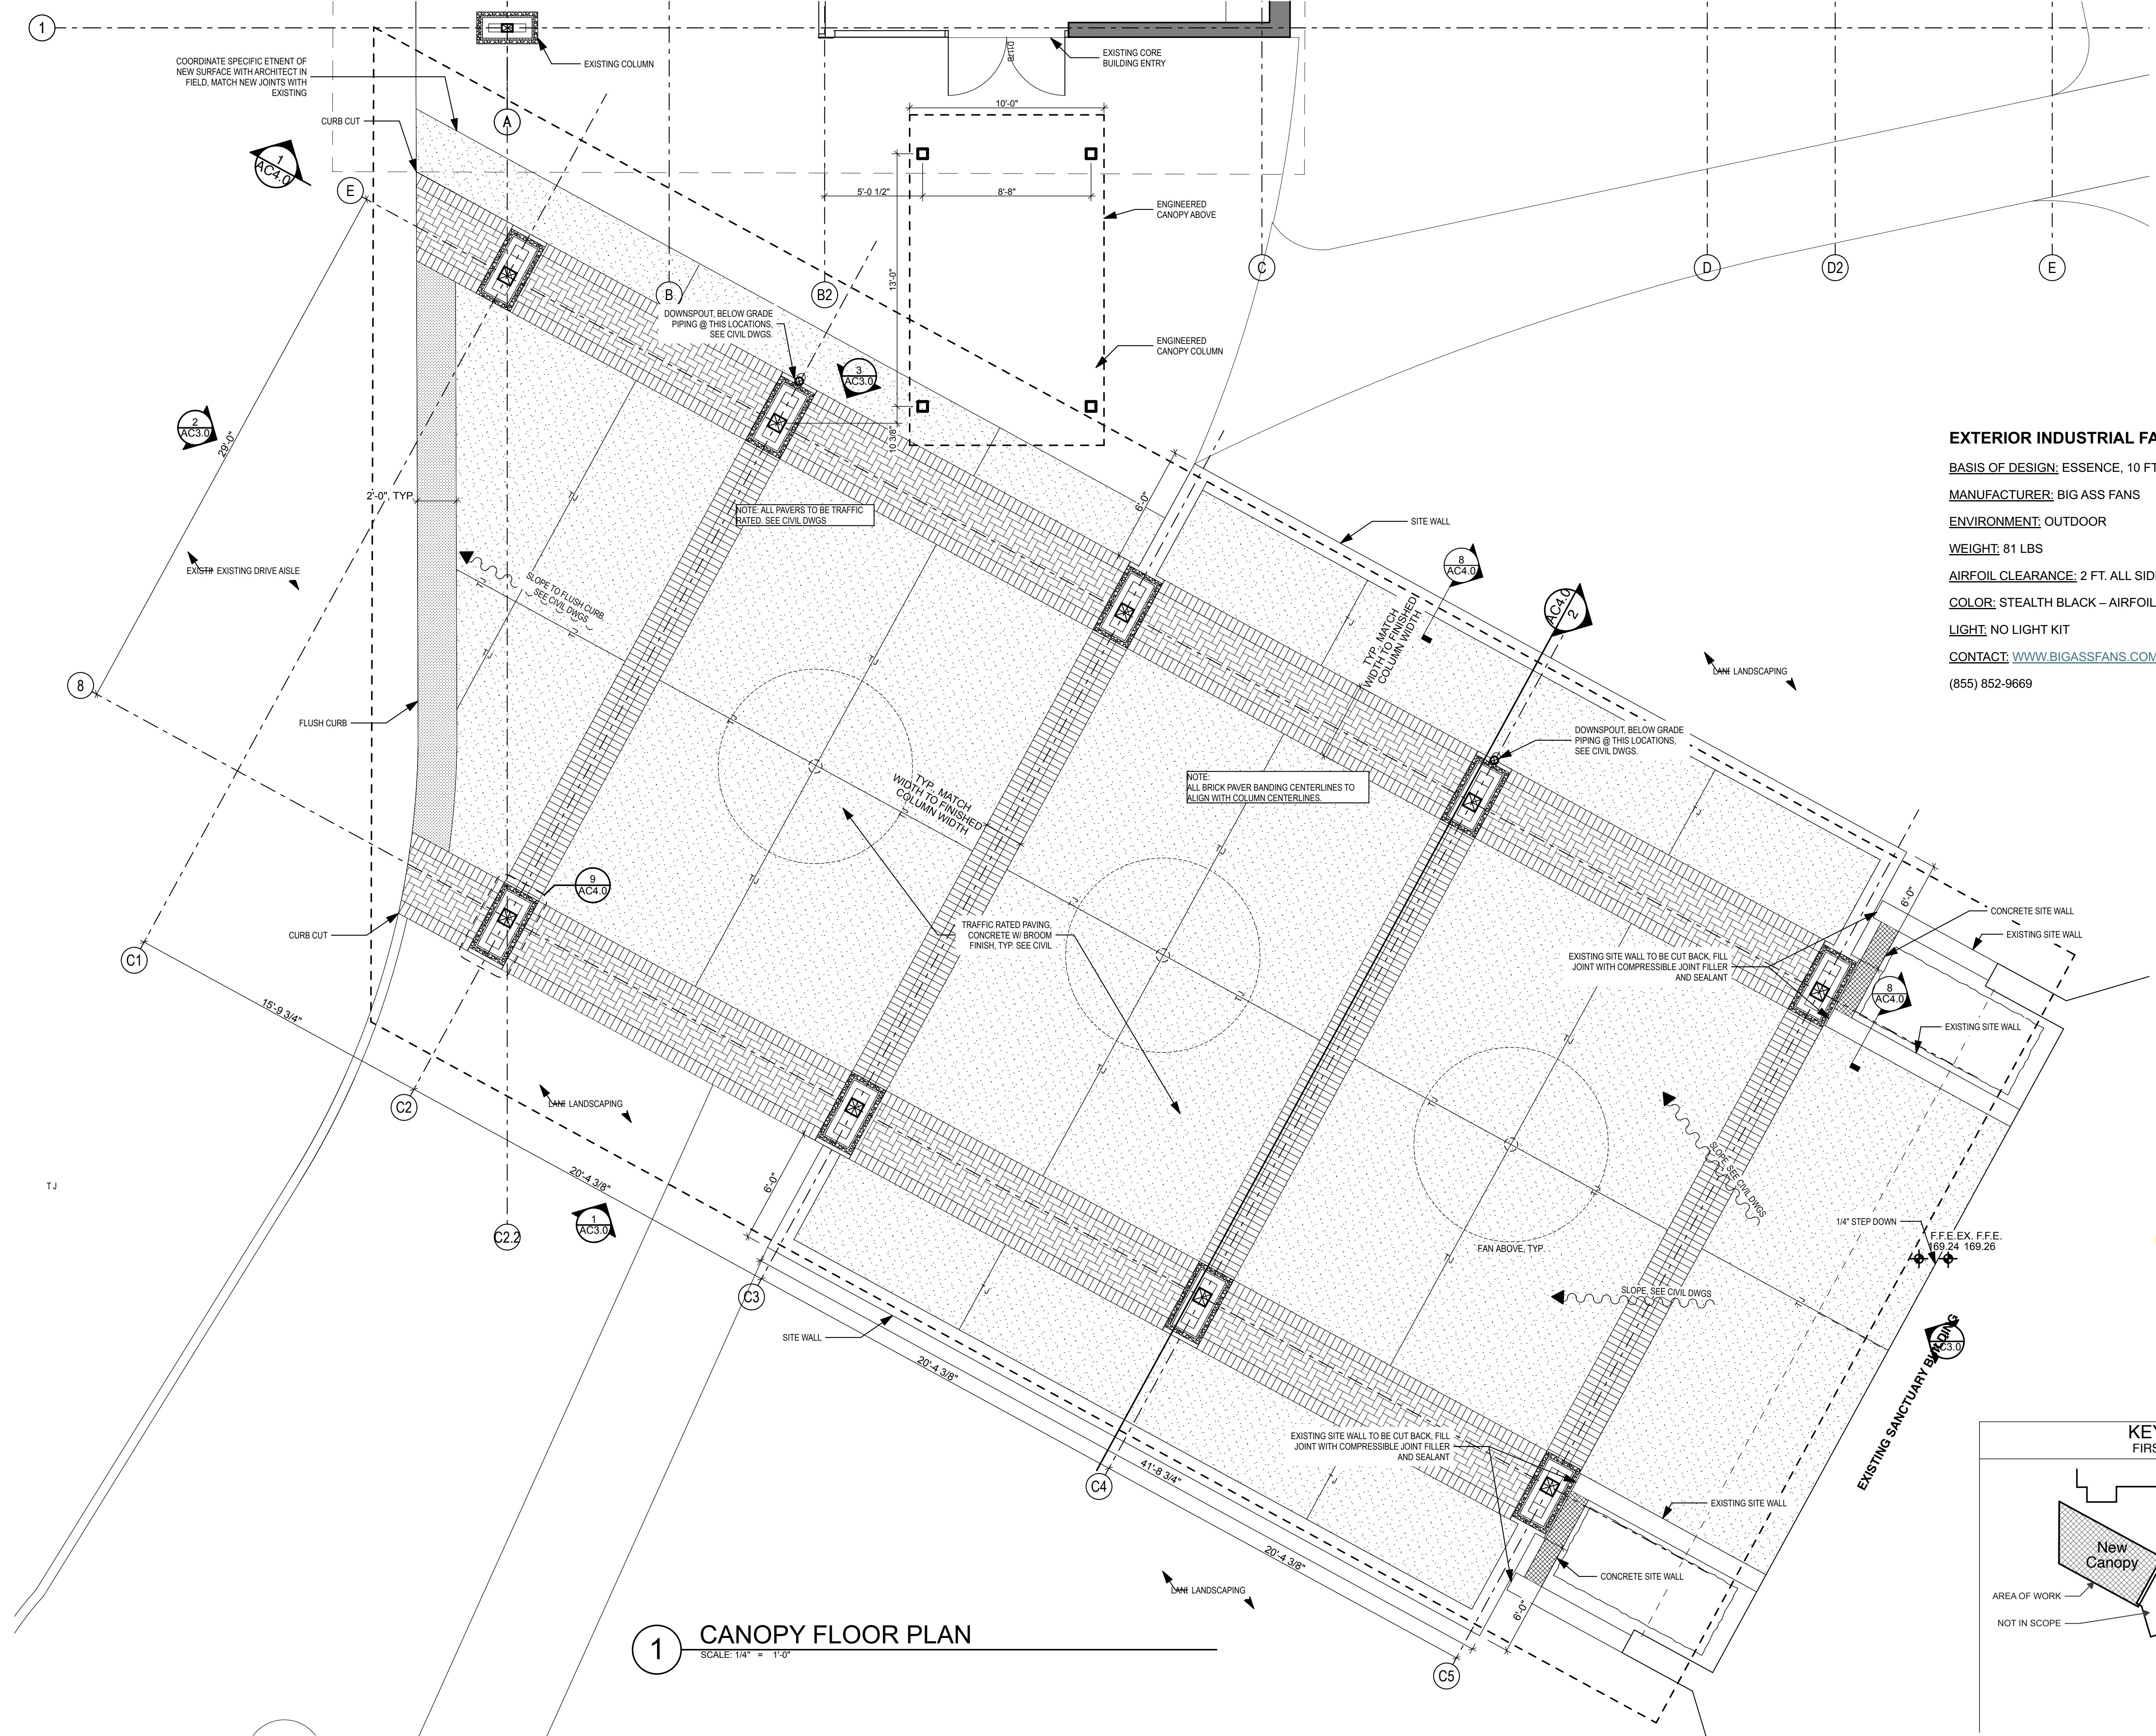

PHASE:	CONCEPT SCHEM. DESIGN	ADVANCED SCHEM. DESIGN	DESIGN DEVELOPMENT	CONSTRUCTION DOCS 90%	CONSTRUCTION DOCS 100%	PERMIT DOCS
DRAWN:	PL	PL	JL	JL	JL	JL
REVIEWED:	PL	PL	JL	JL	JL	JL
DATE:	10/20/2024	10/20/2024	10/20/2024	10/20/2024	10/20/2024	10/20/2024
ID:						
REVISION:						
EDITED:						
REVIEWED:						
DATE:						

Client: **Celebration Baptist Church**
 3300 Shamrock St. E.
 Tallahassee, FL 32309

Project Title: **Canopy and Corridor Improvements**

Sheet No. **AC1.0**

Consultant: Civil Plainman ENGINEERING 850-727-5367 kevermckee.com 1624 Metropolitan Blvd Tallahassee, FL 32309	Consultant: MEP FSM Engineering 850-727-5367 kevermckee.com 1624 Metropolitan Blvd Tallahassee, FL 32309	Consultant: Structural KM KEVER MCKEE ENGINEERING 850-727-5367 kevermckee.com 1624 Metropolitan Blvd Tallahassee, FL 32309	Architect: HAYS LAYER ARCHITECTURE 1221 Summer Haven Ct. Franklin, TN 37069 615-558-3813 hays@hayslayer.com FL License: AP06759	Seal:
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 THESE DRAWINGS / PLANS, IN PHYSICAL AND/OR DIGITAL FORM, ARE THE COPYRIGHTED PROPERTY OF HAYS LAYER ARCHITECTURE.

ALTERNATE: METAL CANOPY ROOF SYSTEM

BASIS OF DESIGN: MAXIMA 3" PANEL, BY MCELROY METAL INC.

MINIMUM SLOPE REQUIREMENT: 1/4 PER 12

MATERIAL: 24 GA. ASTM A792 (50 KSI STEEL), AZ50 PAINTED

FINISH: FLUOROPOLYMER (KYNAR 500 PDVF RESIN BASED)

COLOR: MATCH EXISTING CAMPUS METAL CANOPY COLOR

SUBMITTALS: SUBMIT FULL PANEL, 24" MIN. LENGTH, WITH PROPOSED COLOR FOR ARCHITECT'S APPROVAL PRIOR TO ACCEPTANCE.


TRIM & ACCESSORIES: CONTRACTOR TO FURNISH AND INSTALL ALL COMPLIMENTARY AND NECESSARY TRIMS, FLASHING, DRIP EDGES, SEALANTS, ANCHORS, CLOSURES, CLIPS, AND OTHER PRODUCTS REQUIRED FOR THE ROOF SYSTEM. CONTRACTOR TO SUBMIT SHOP DRAWINGS, COLOR SAMPLES, AND PRODUCT DATA SHEETS TO ARCHITECT FOR APPROVAL PRIOR TO ACCEPTANCE.

FLORIDA PRODUCT APPROVAL: 1832.4

WARRANTY: 20 YEAR MIN. FOR FINISH, MATERIAL, AND WATERTIGHTNESS.

CONTACT: WWW.MCELROYMETAL.COM

SEE SPECIFICATION MANUAL FOR ALTERNATES, SUBMITTALS, AND GENERAL REQUIREMENTS.

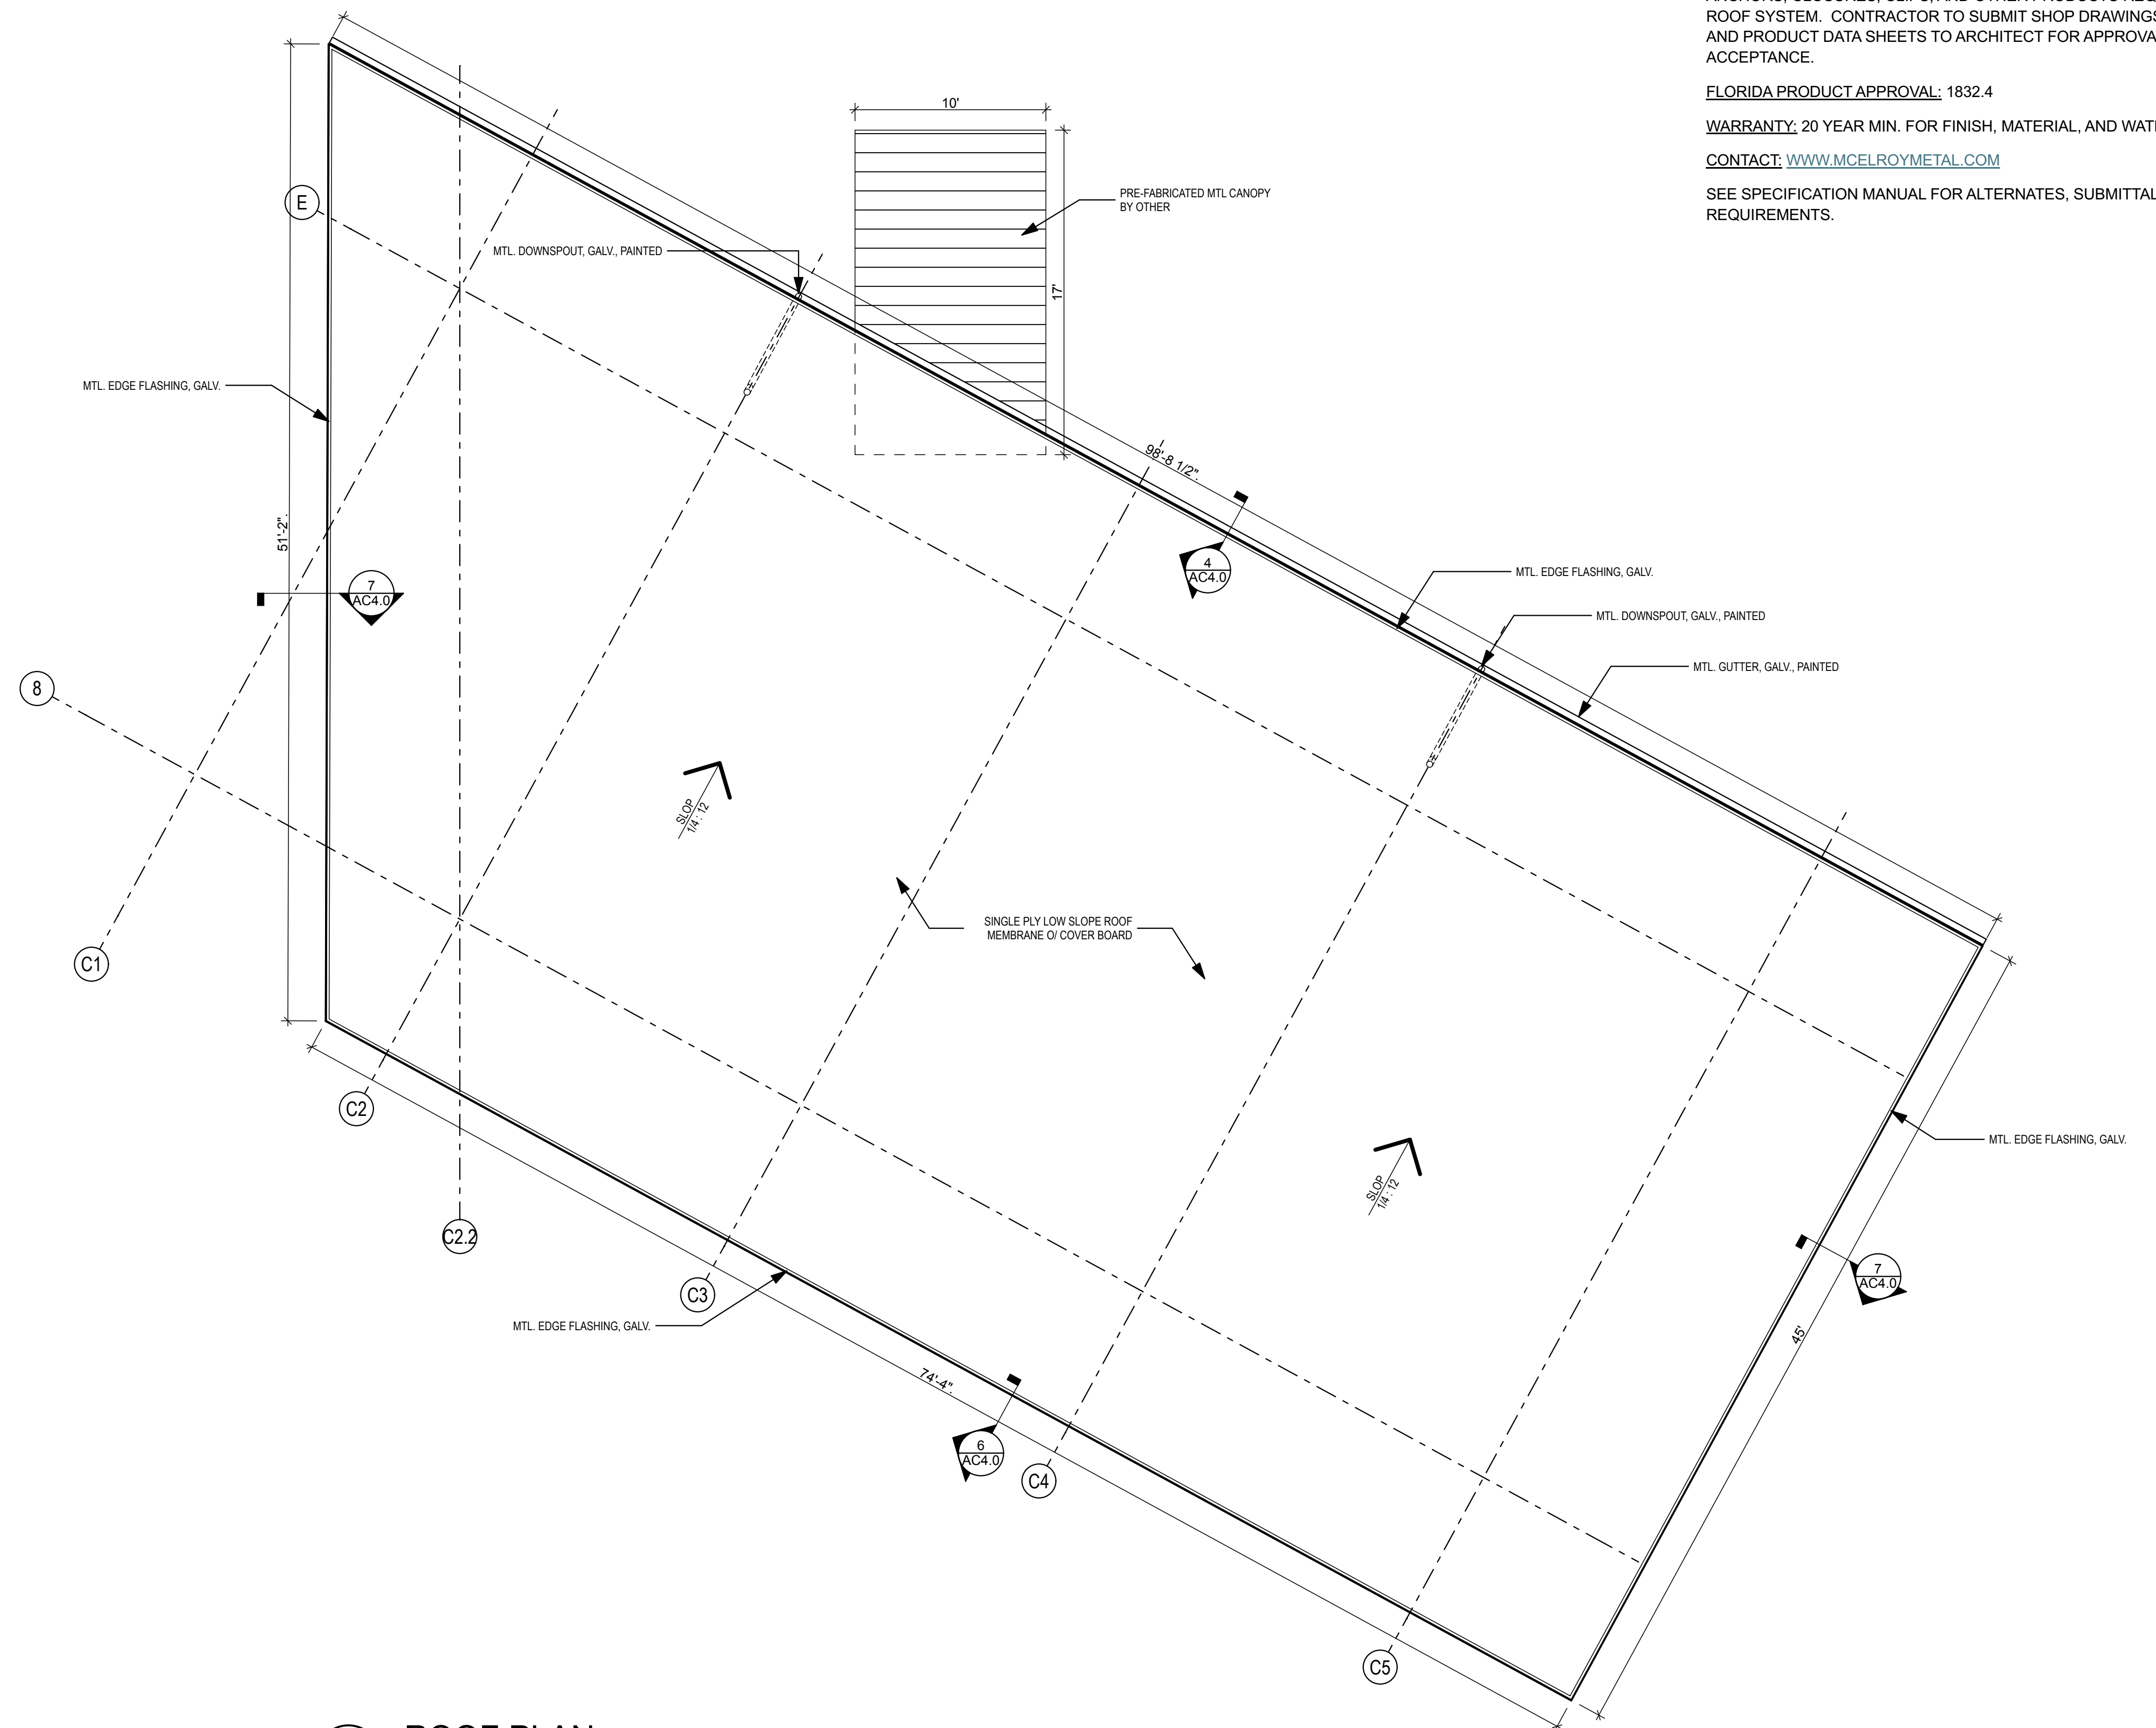

1 ROOF PLAN
SCALE: 3/16" = 1'-0"

PHASE:	DRAWN:	REVIEWED:	DATE:	ID:	REVISION:	EDITED:	REVIEWED:	DATE:
CONCEPT SCHEM. DESIGN	H. LAYARD	H. LAYARD	10/20/2024					
ADVANCED SCHEM. DESIGN	H. LAYARD	H. LAYARD	10/27/2024					
DESIGN DEVELOPMENT	J. HAYES	H. LAYARD	10/27/2024					
CONSTRUCTION DOCS 90%	J. HAYES	H. LAYARD	10/28/2024					
CONSTRUCTION DOCS 100%	J. HAYES	H. LAYARD	10/28/2024					
PERMIT DOCS	J. HAYES	H. LAYARD	10/28/2024					

Client: **Celebration Baptist Church**
3900 Sharnock St. E.
Tallahassee, FL 32309

Project Title: **Canopy and Corridor Improvements**

Consultant: Civil
Plainman ENGINEERING
904-382-2286 5404 Applecore Lane Tallahassee, FL 32309

Consultant: MEP
FSM Engineering
850-727-5367 kevermckee.com 1624 Metropolitan Blvd Tallahassee, FL 32309


Consultant: Structural
KEVER MCKEE ENGINEERING
850-559-3613 hays@hayslayerd.com FL License: AP06759

Architect:
HAYS LAYARD ARCHITECTURE
1221 Summer Haven Ct. Franklin, TN 37069 850-559-3613 hays@hayslayerd.com HAYS LAYARD ARCHITECTURE


Seal:

Sheet No. **AC2.0**
CANOPY ROOF PLAN


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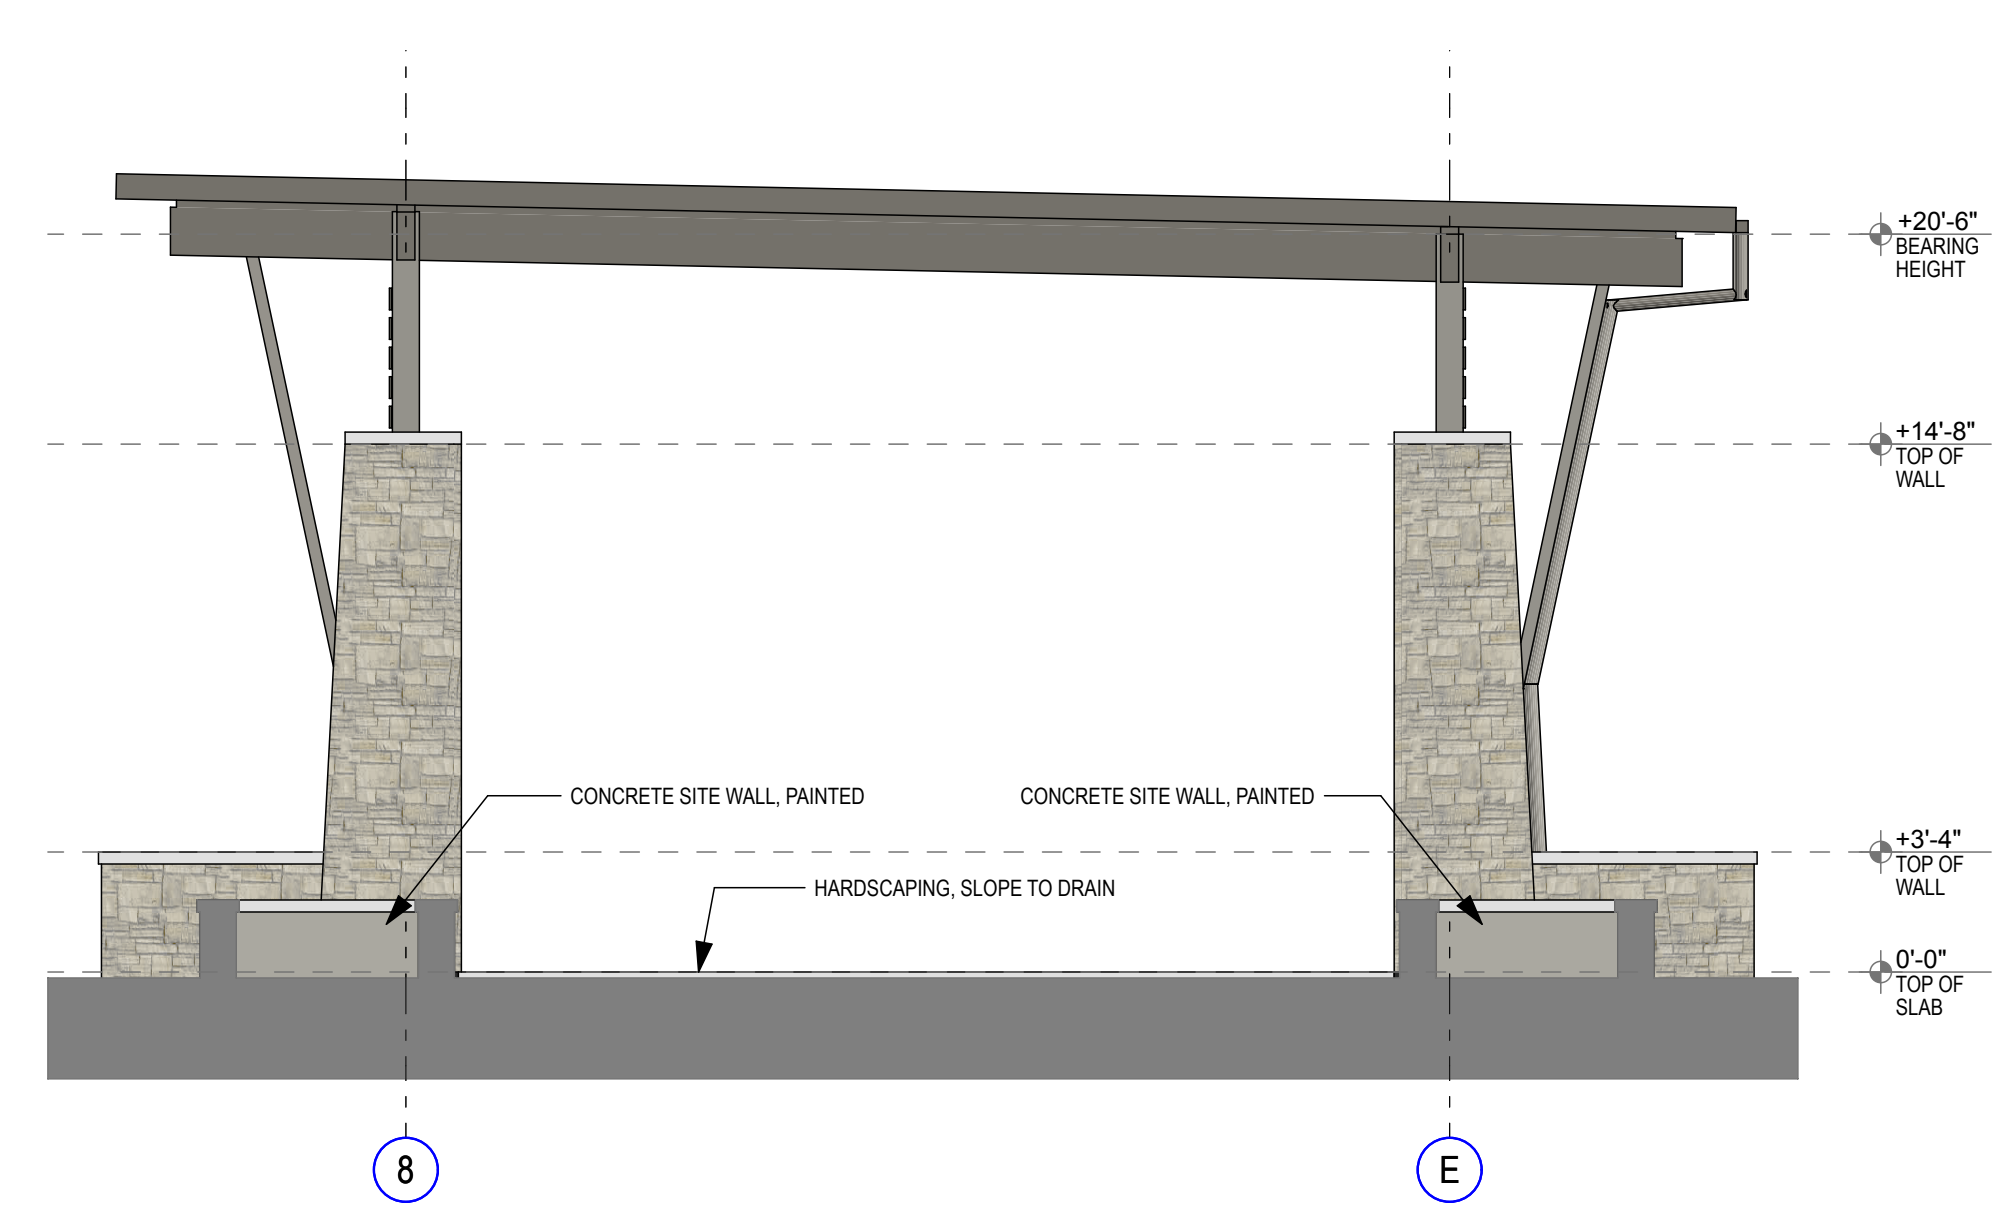
2 CANOPY ELEVATION 2
SCALE: 3/16" = 1'-0"

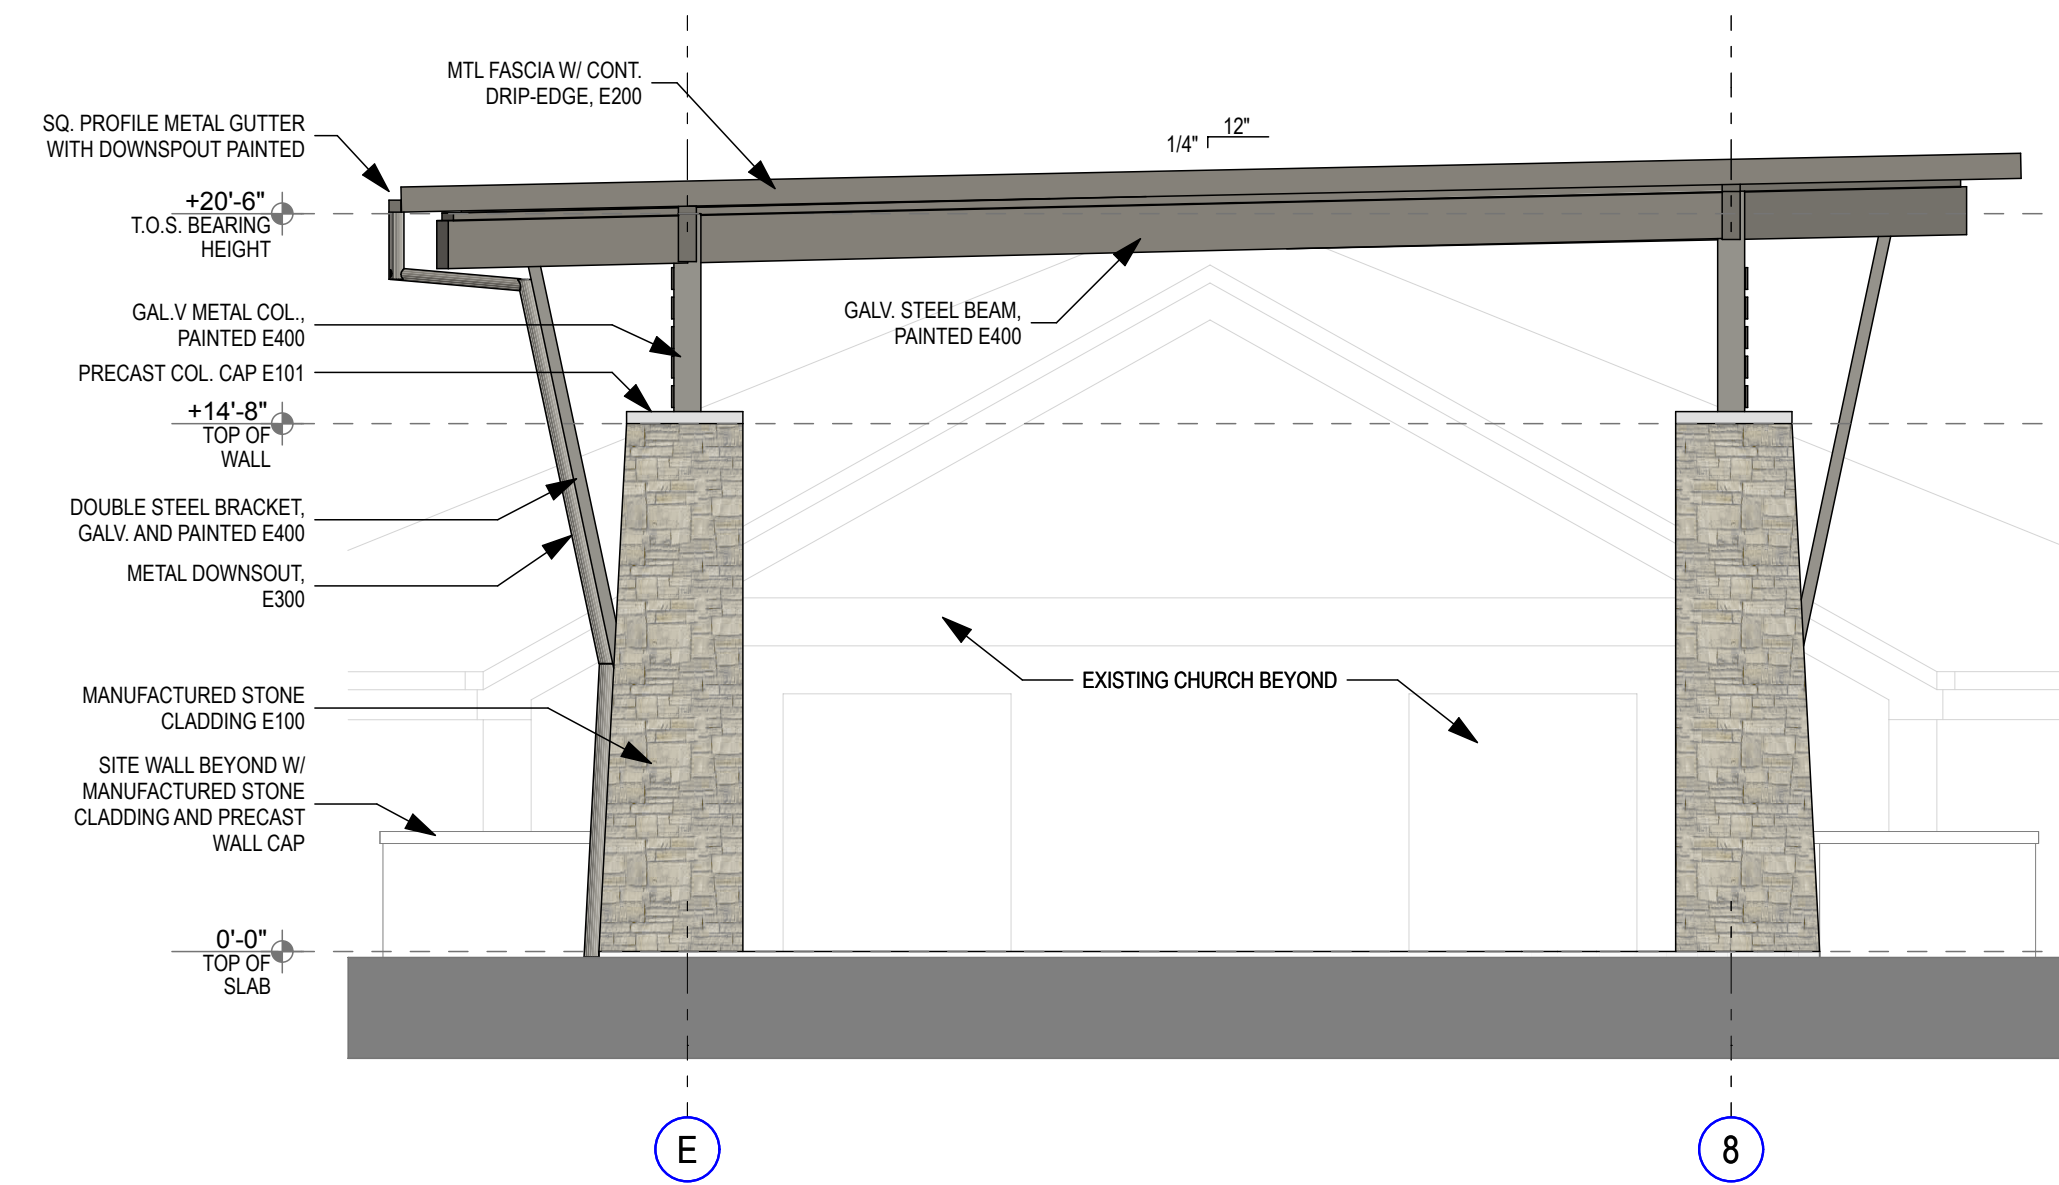

1 CANOPY ELEVATION 1
SCALE: 3/16" = 1'-0"

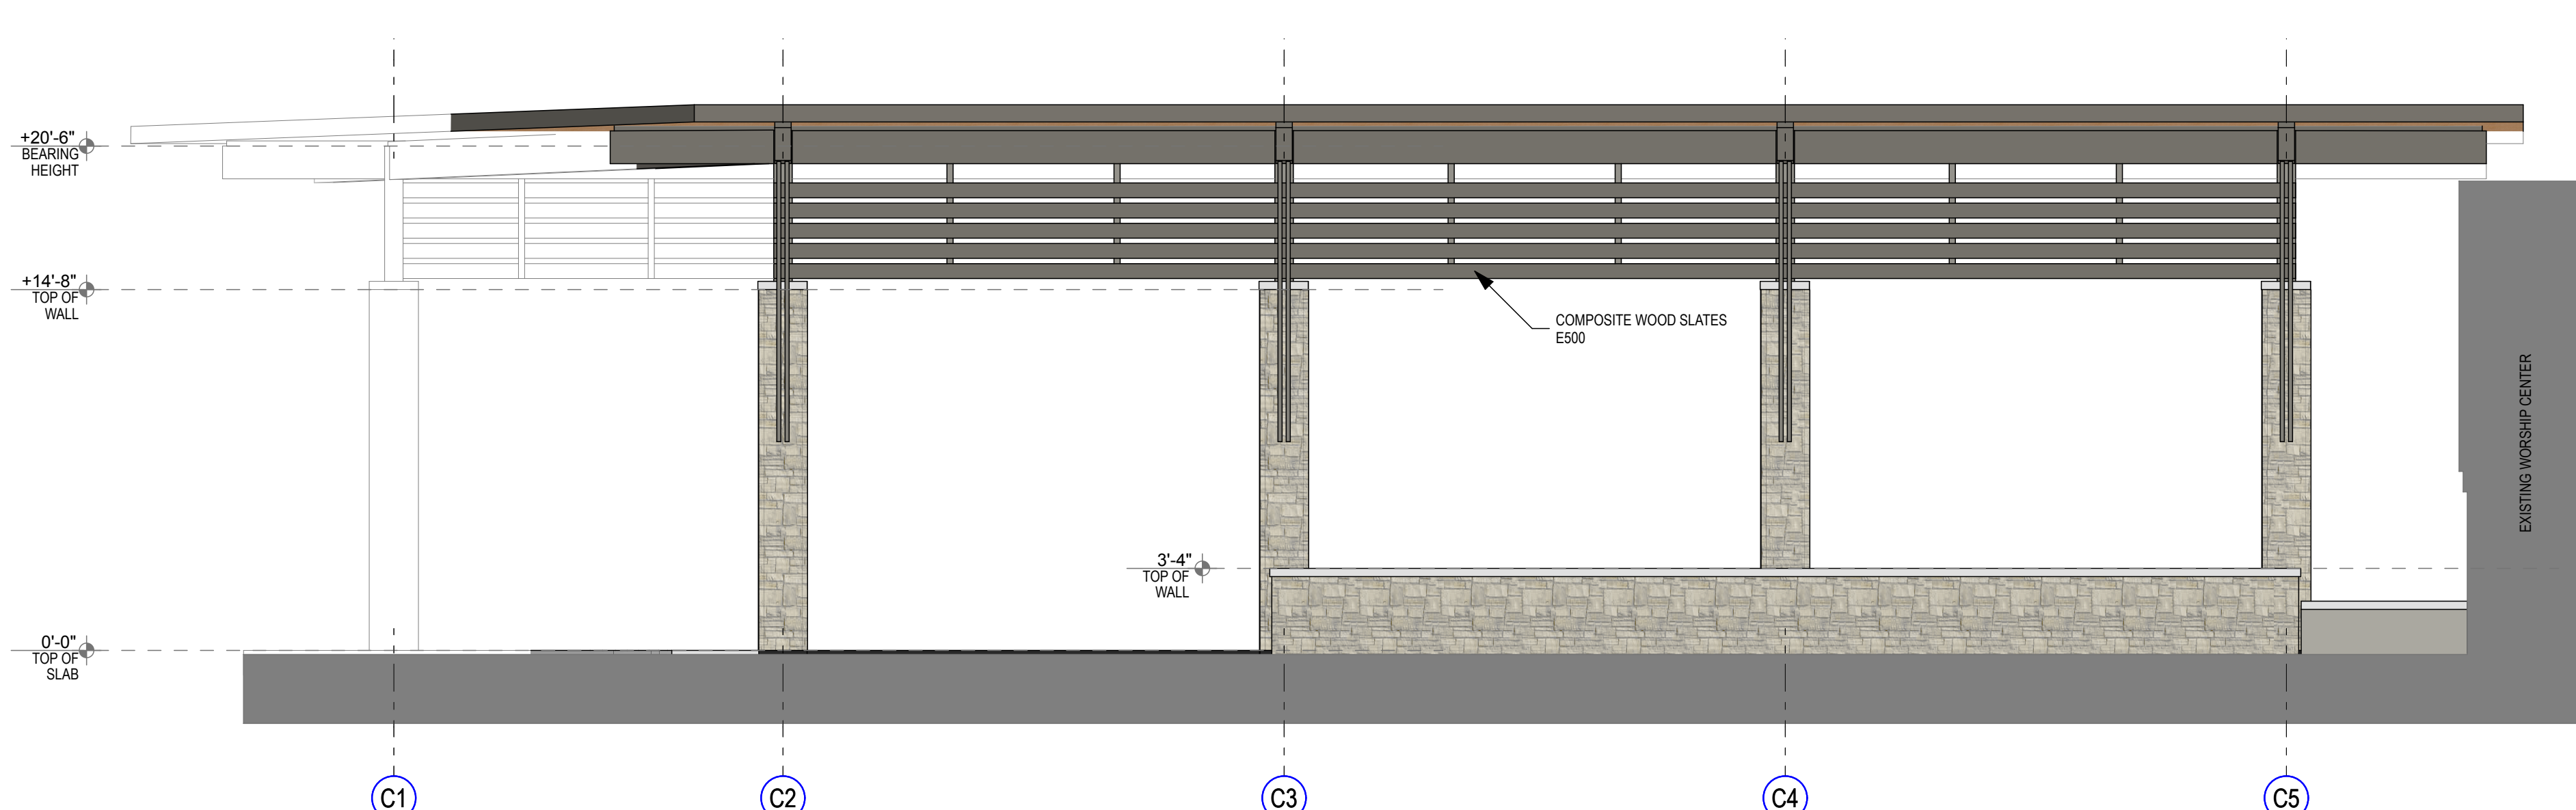

3 CANOPY ELEVATION 3
SCALE: 3/16" = 1'-0"

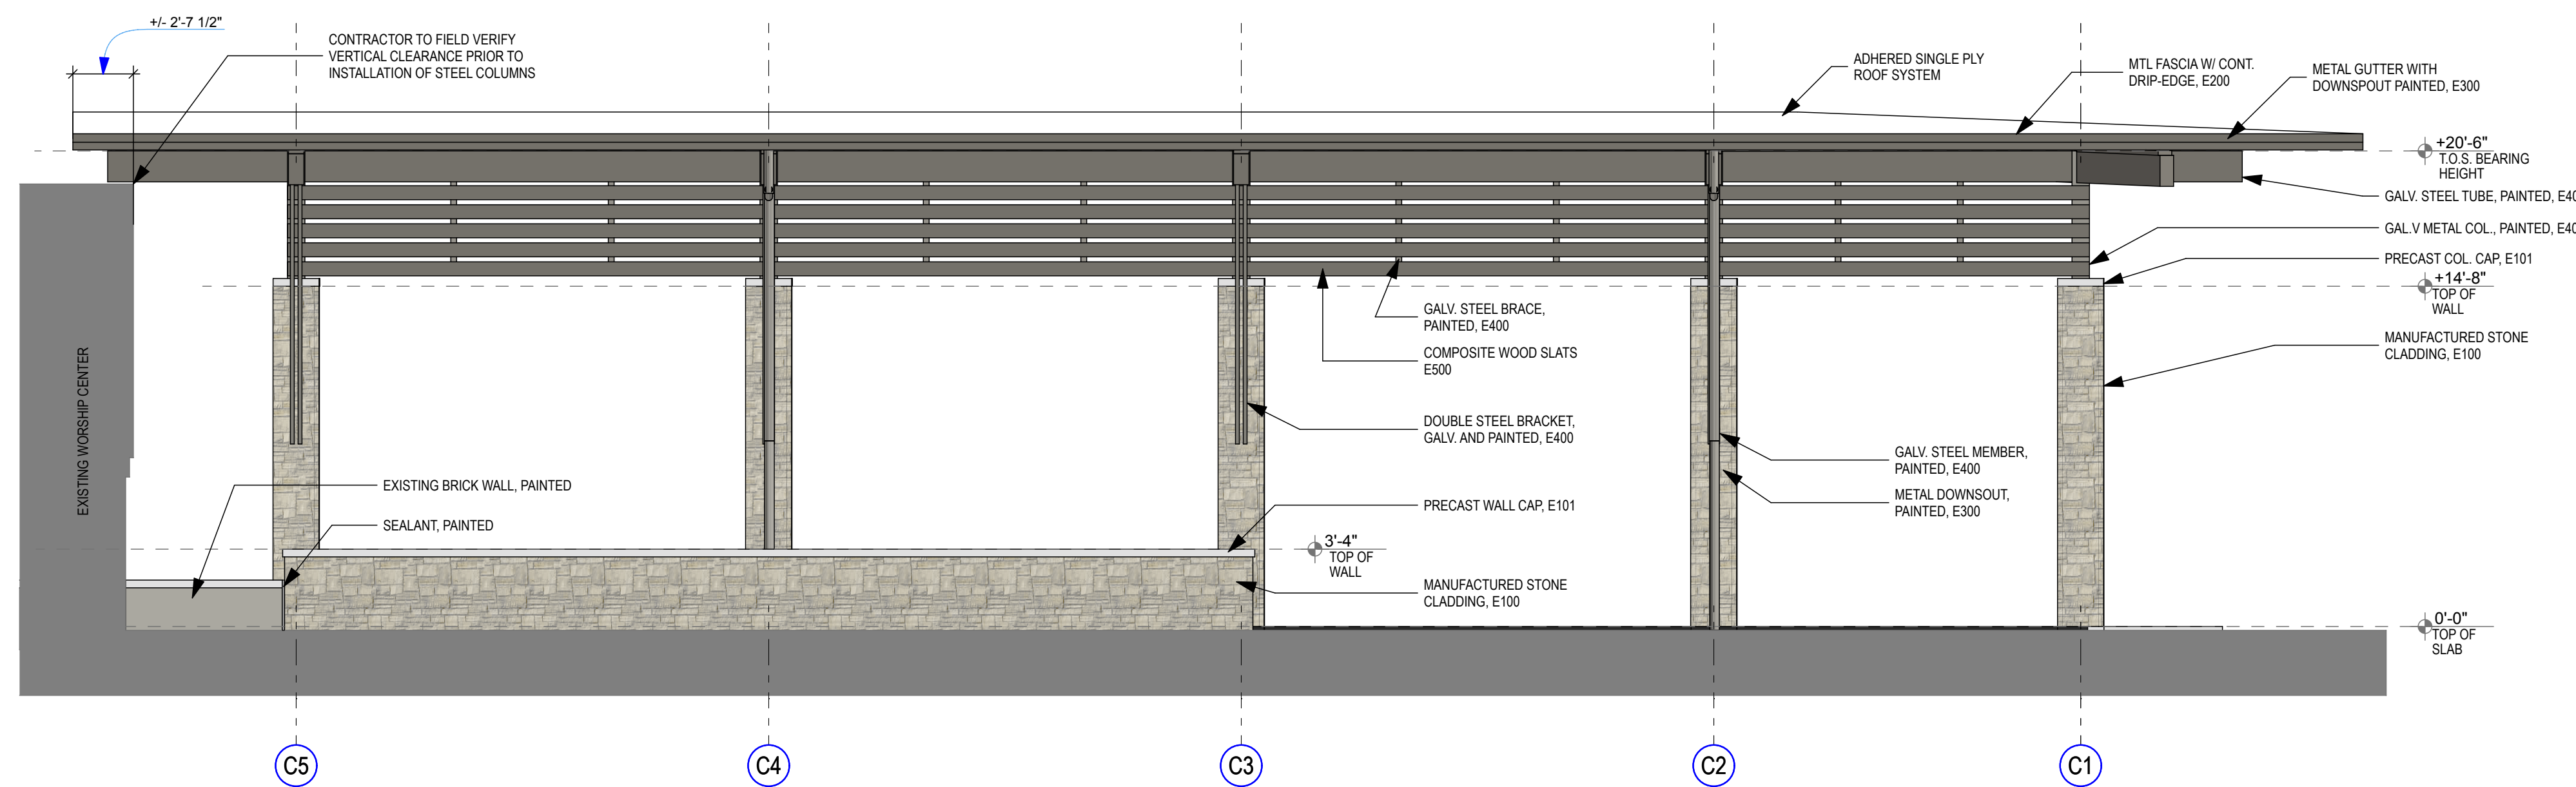

4 CANOPY ELEVATION 4
SCALE: 3/16" = 1'-0"

ALTERNATE: CANOPY SOFFIT WOOD PLANKS

BASIS OF DESIGN: AQUAFIR, NATURAL COLOR
MANUFACTURER: MONTANA TIMBER PRODUCTS
APPLICATIONS: SEAL-ONCE, ULTRA LOW VOC, WATER BASED STAIN AND SEALER, APPLIED ALL FOUR SIDES OF BOARD.
WEATHER BARRIER: APPLY WEATHER BARRIER BETWEEN PLANKS AND CLT STRUCTURE.
TEXTURE/PROFILE: SMOOTH, T&G, 1X6 NOMINAL
FASTENERS: COLOR MATCHED STAINLESS STEEL
SUBMITTALS: SUBMIT SAMPLES TO ARCHITECT FOR APPROVAL PRIOR TO ACCEPTANCE.
CONTACT: MONTANATIMBERPRODUCTS.COM
 (406) 215-4691

EXTERIOR FINISH SCHEDULE


E100 - STONE VENEER - COLOR: BLUEGRASS, PATTERN: 90% OLDE WORLD / 10% FIELDSTONE, HORIZON STONE CO.
 E101 - CAST STONE CAP: WET CAST, SAND COLOR. MATCH EXISTING CAMPUS CAST STONE
 E200 - PREFINISHED METAL FLASHING/TRIM/FASCIA/COPING - MATCH EX. CORE BLDG. METAL ROOF CHARCOAL GRAY
 E300 - METAL GUTTER / ROUND DOWNSPOUT SYSTEM - MATCH METAL ROOF COLOR, CHARCOAL GRAY
 E400 - TYP. EXPOSED STEEL PAINT COLOR - SHERWIN-WILLIAMS, SW 7645, THUNDER GRAY
 E500 - COMPOSITE WOOD SLATS: CONCORDIA DECKING, SQUARE EDGE (FLAT BOTTOM) PROFILE (.92" X 5.4"), FINISH BOTH SIDES, BY FIBERON

PHASE:	CONCEPT SCHEM. DESIGN	ADVANCED SCHEM. DESIGN	DESIGN DEVELOPMENT	CONSTRUCTION DOCS 90%	CONSTRUCTION DOCS 100%	PERMIT DOCS
DRAWN:	PL	PL	JL	JL	JL	JL
REVIEWED:	PL	PL	PL	PL	PL	PL
DATE:						
EDITED:						
REVISION:						
ID:						


Client: Celebration Baptist Church
 3900 Sharnrock St. E.
 Tallahassee, FL 32309

Project Title: Canopy and Corridor Improvements


DO NOT SCALE DRAWINGS. THESE DRAWINGS / PLANS, IN PHYSICAL AND/OR DIGITAL FORM, ARE THE COPYRIGHTED PROPERTY OF HAYS LAYERD ARCHITECTURE.

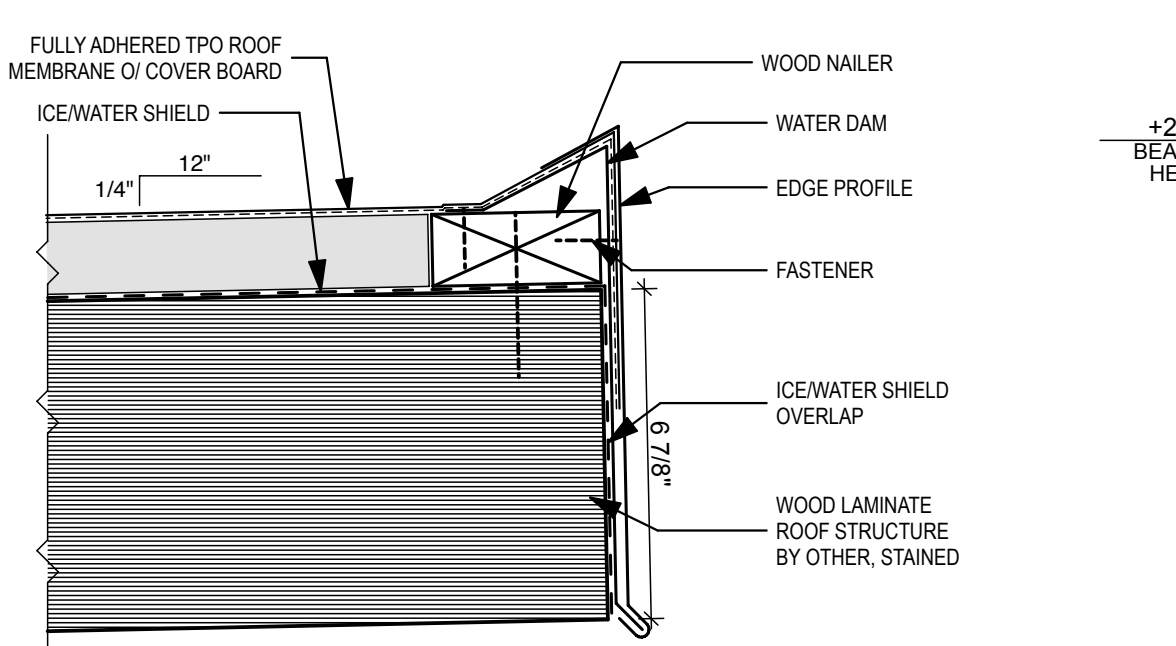


6 ROOF PEAK
SCALE: 3" = 1'-0"

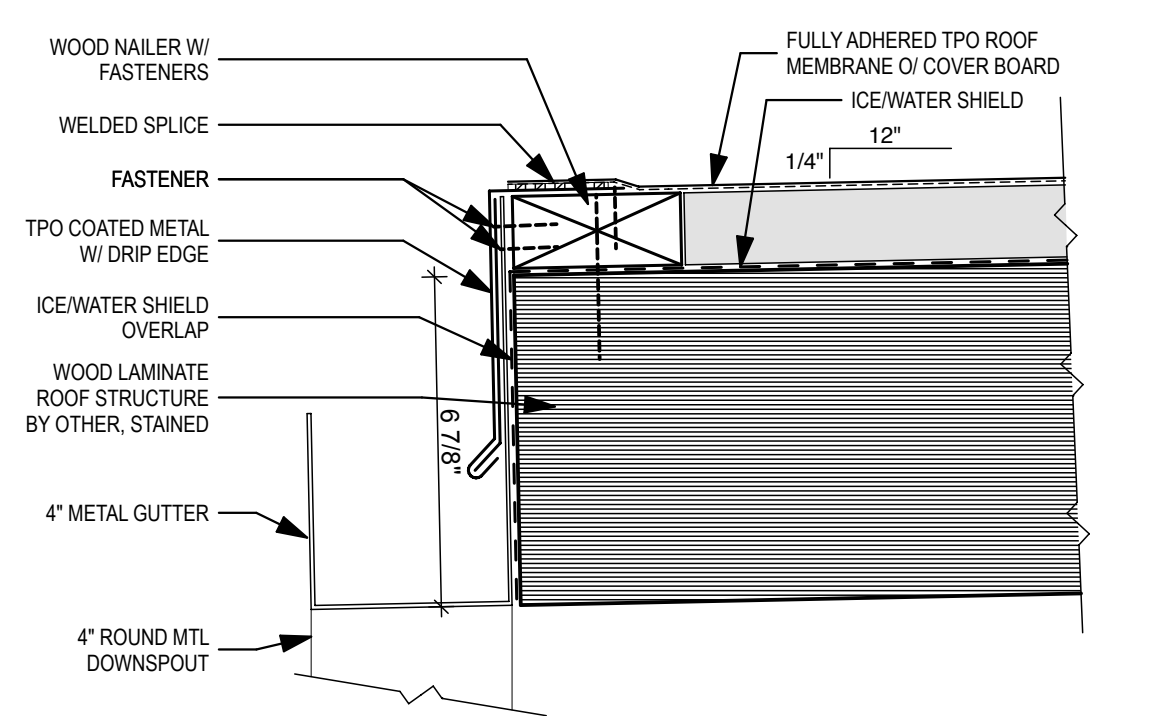


4 ROOF EDGE
SCALE: 3" = 1'-0"

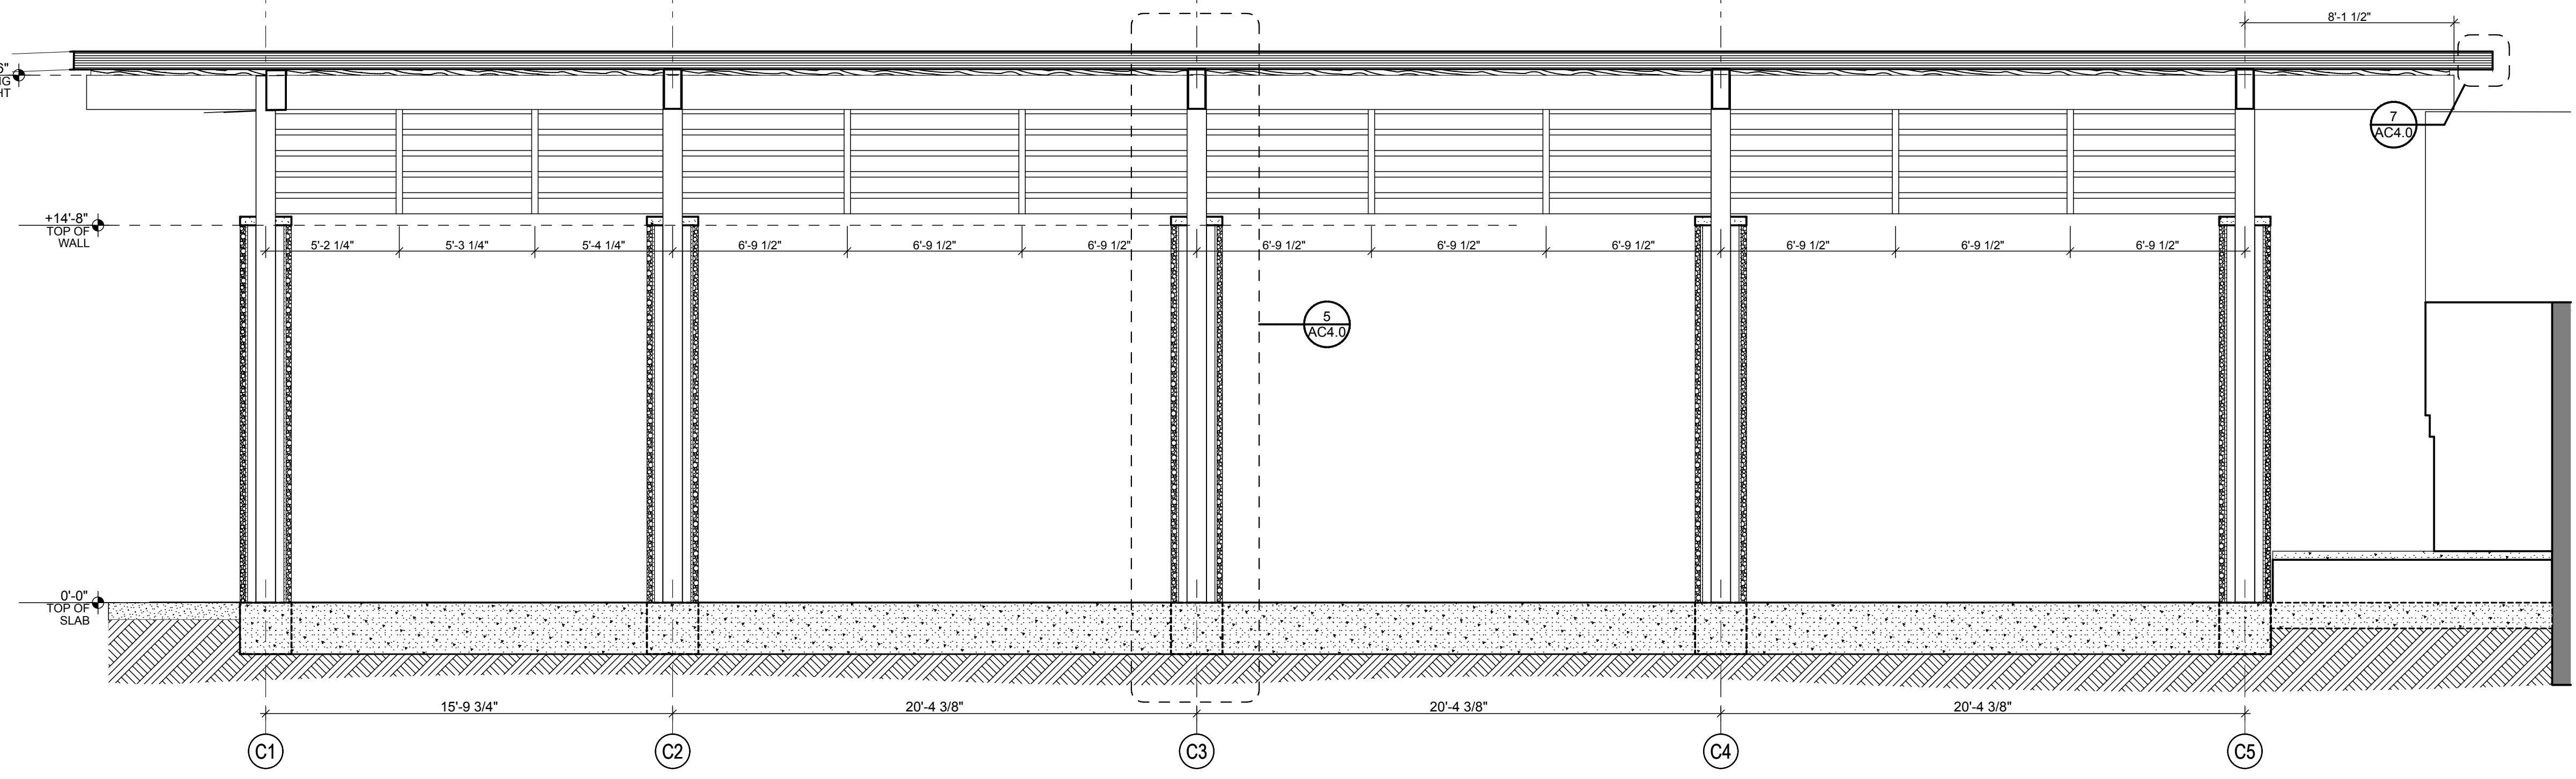


1 CANOPY LONG SECTION
SCALE: 1/4" = 1'-0"

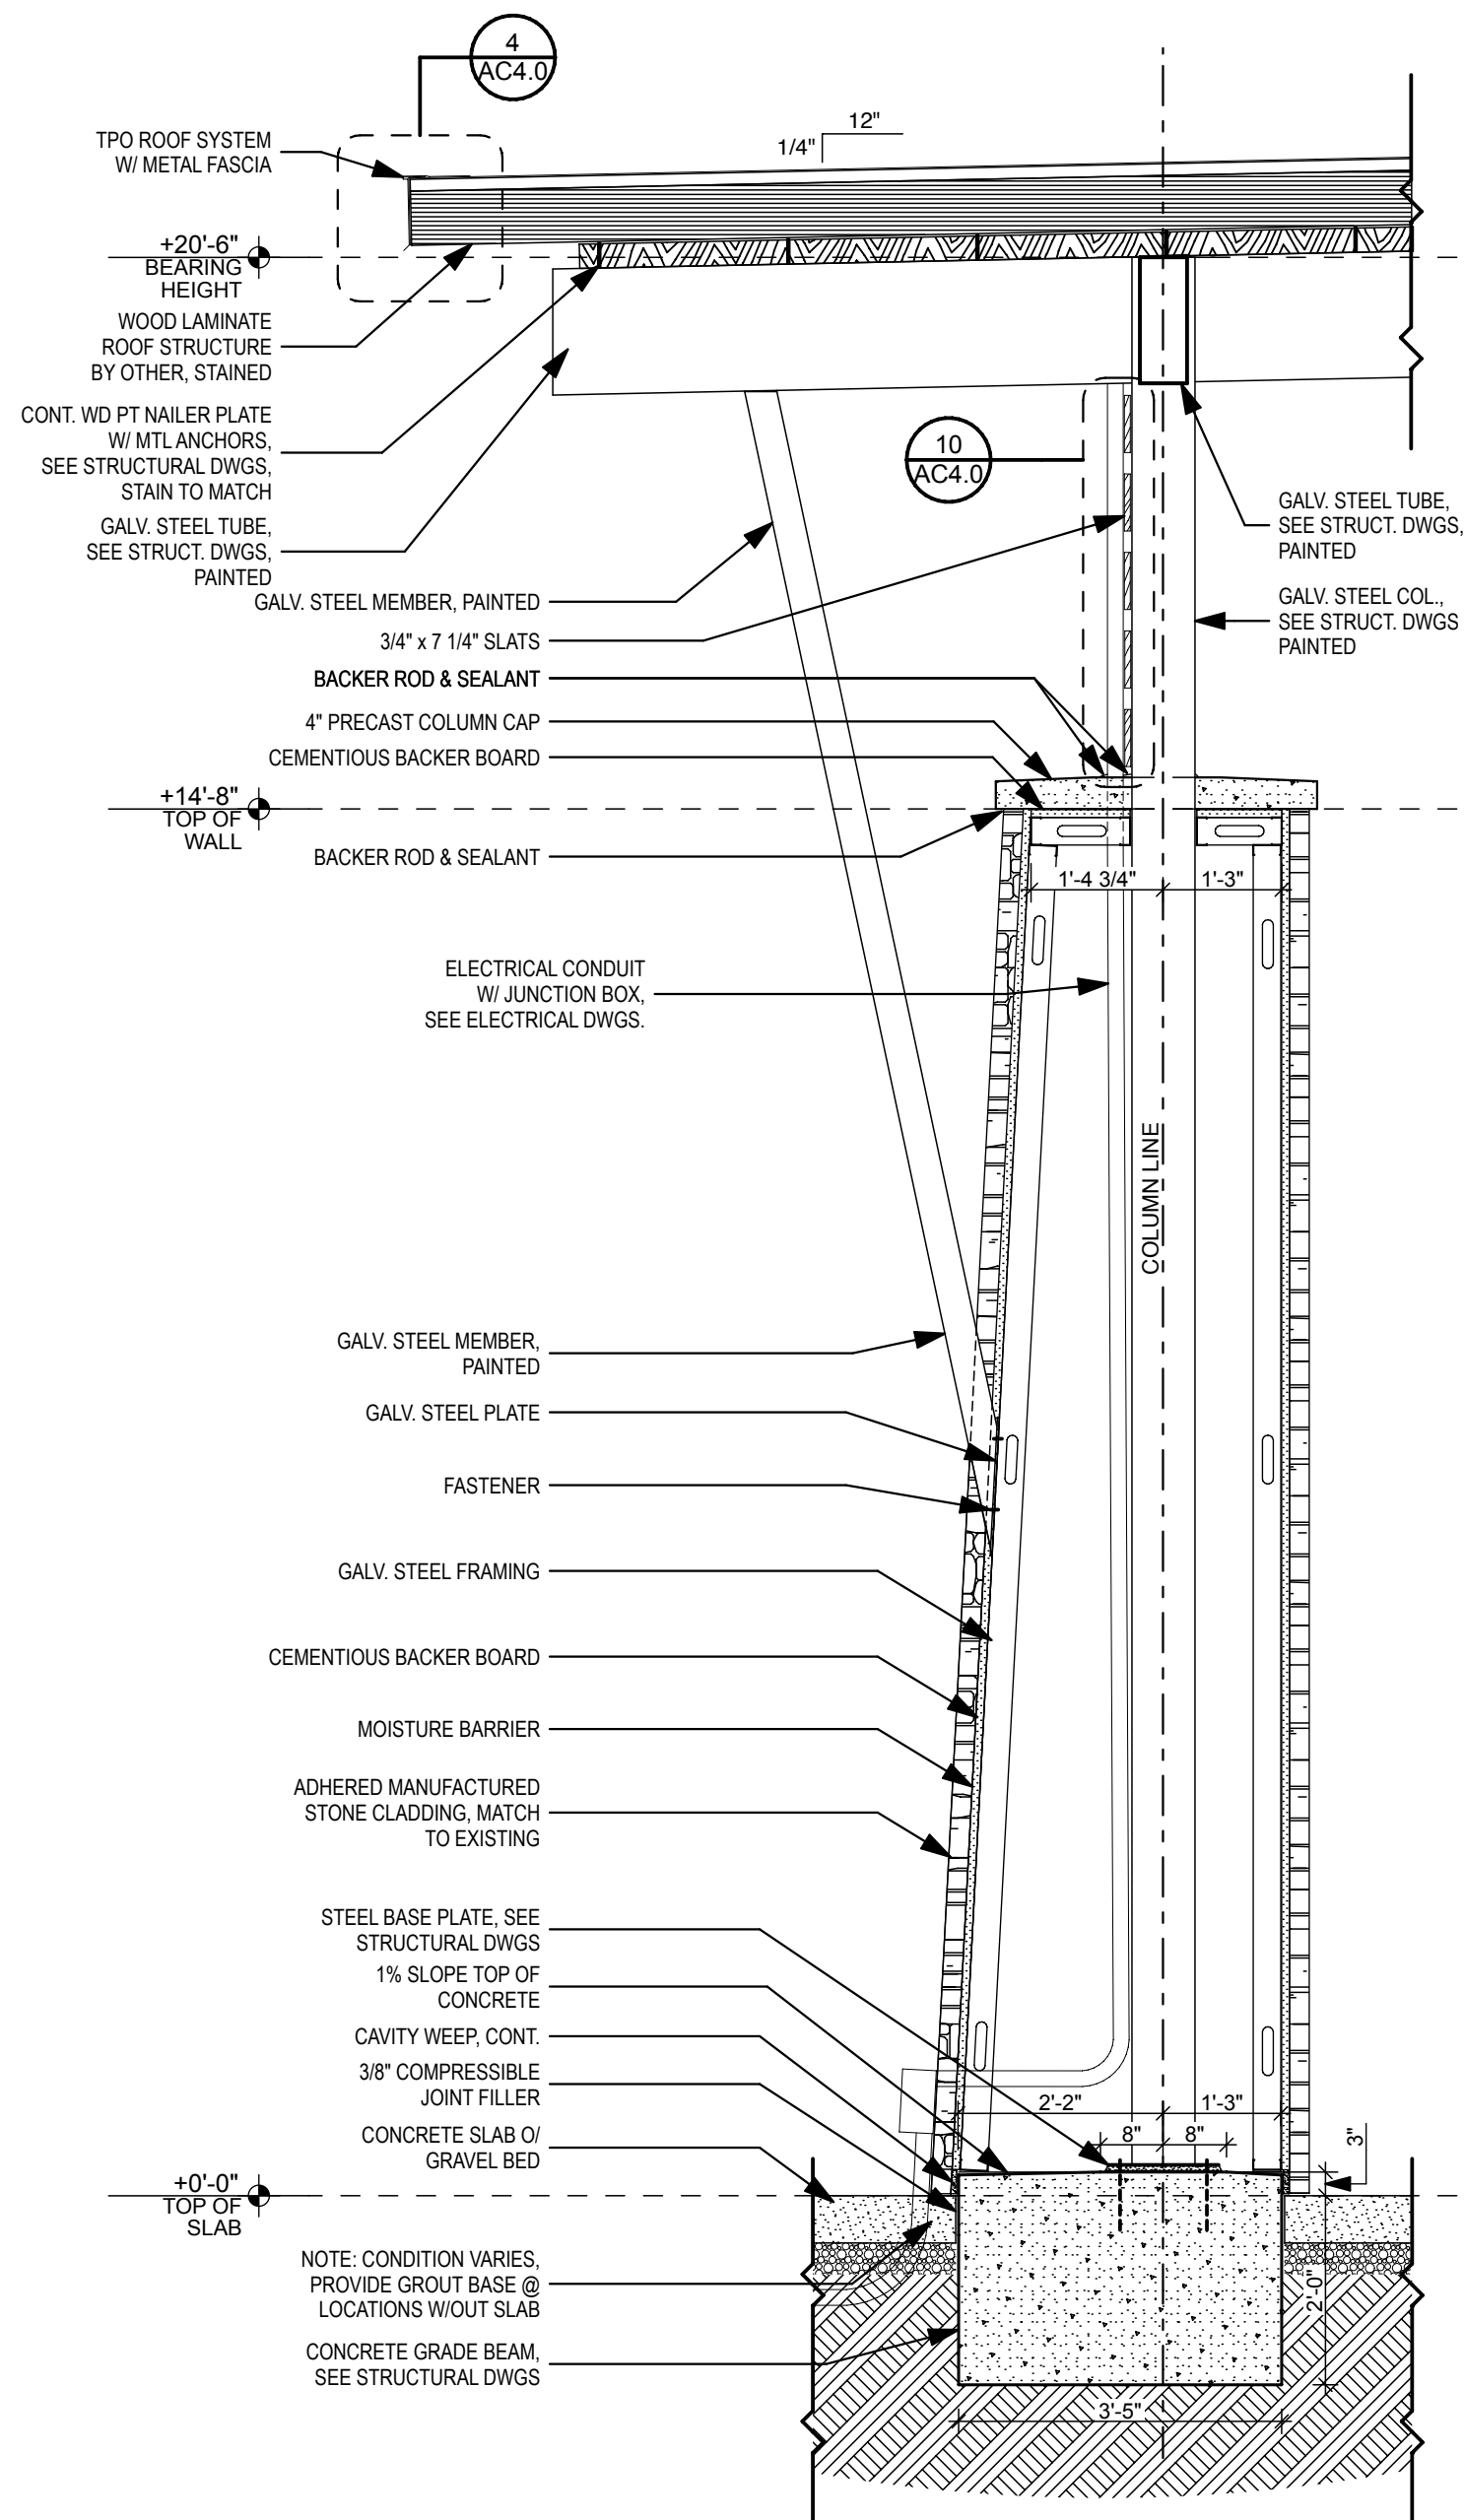



3 CANOPY COL. DETAIL
SCALE: 1/2" = 1'-0"

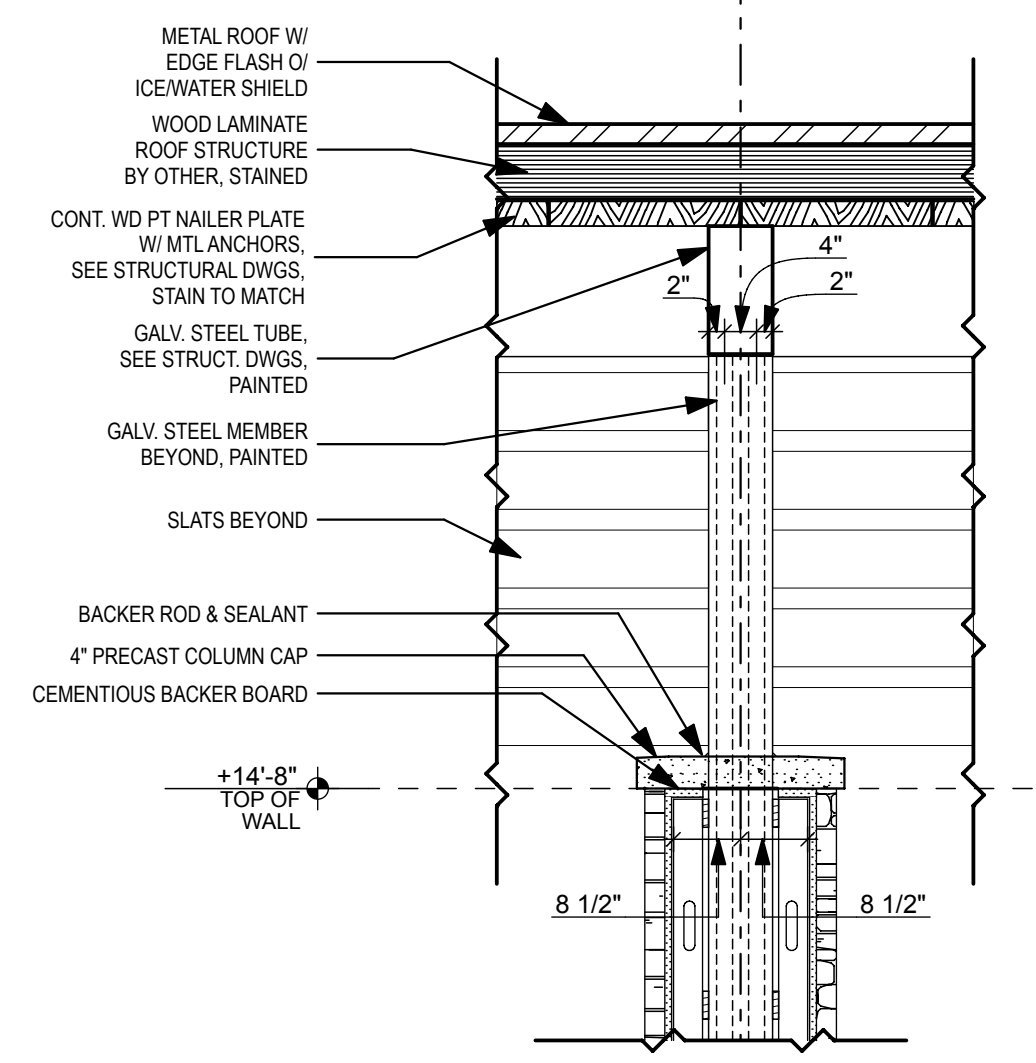


7 RAKE FLASH
SCALE: 3" = 1'-0"

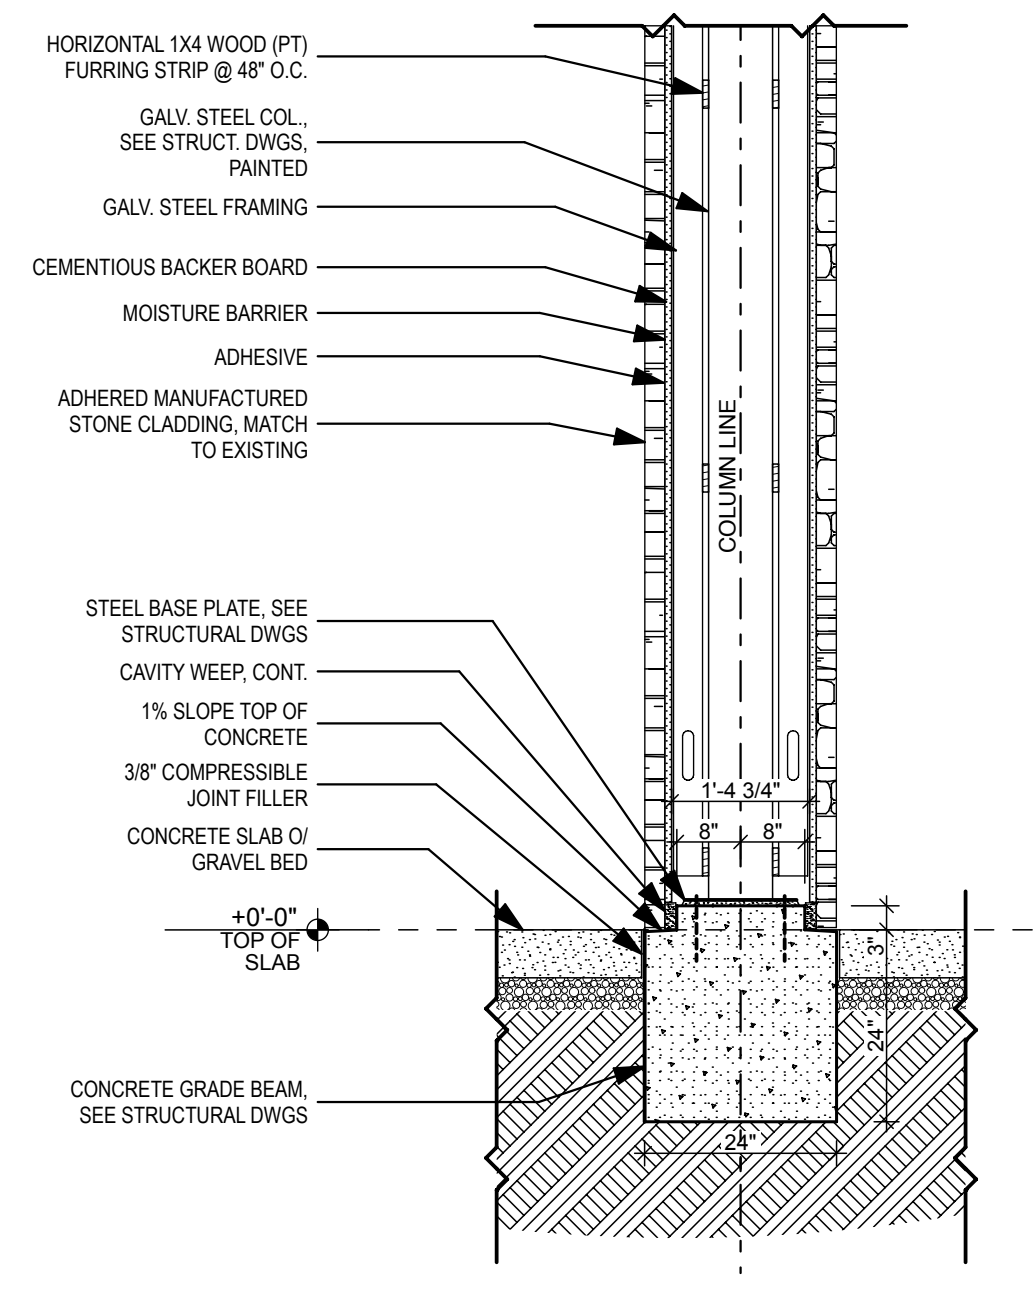


5 CANOPY COL. DETAIL
SCALE: 1/2" = 1'-0"

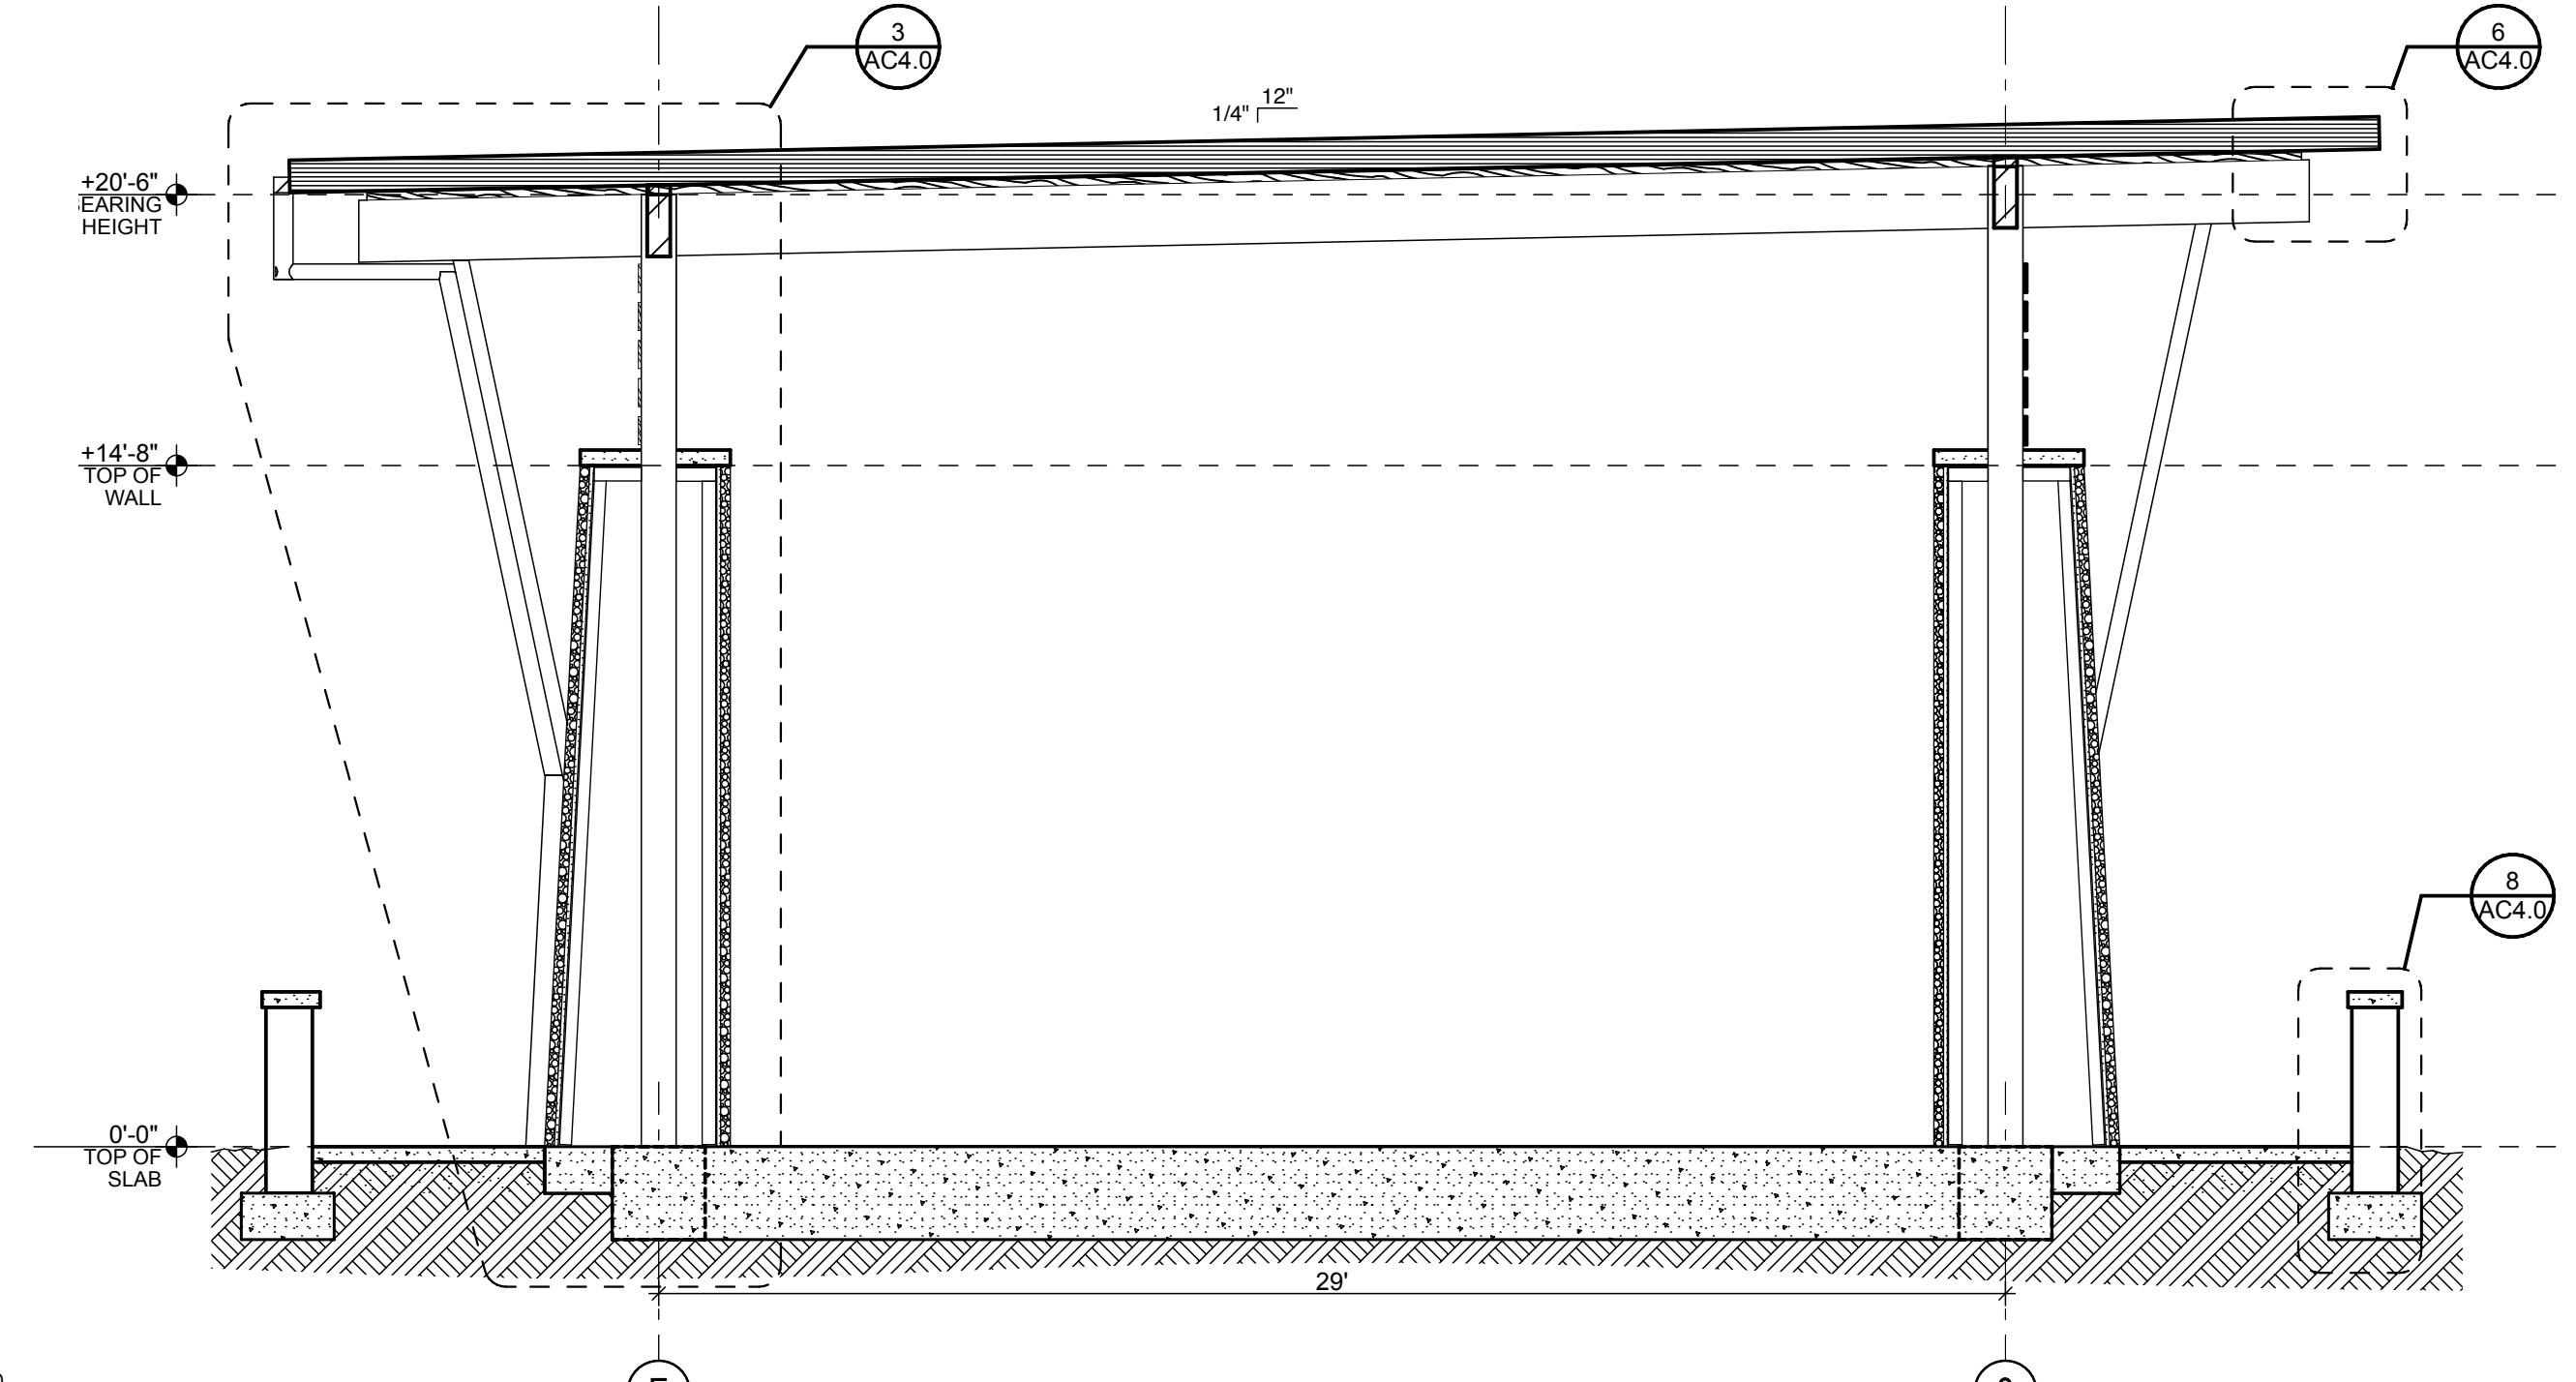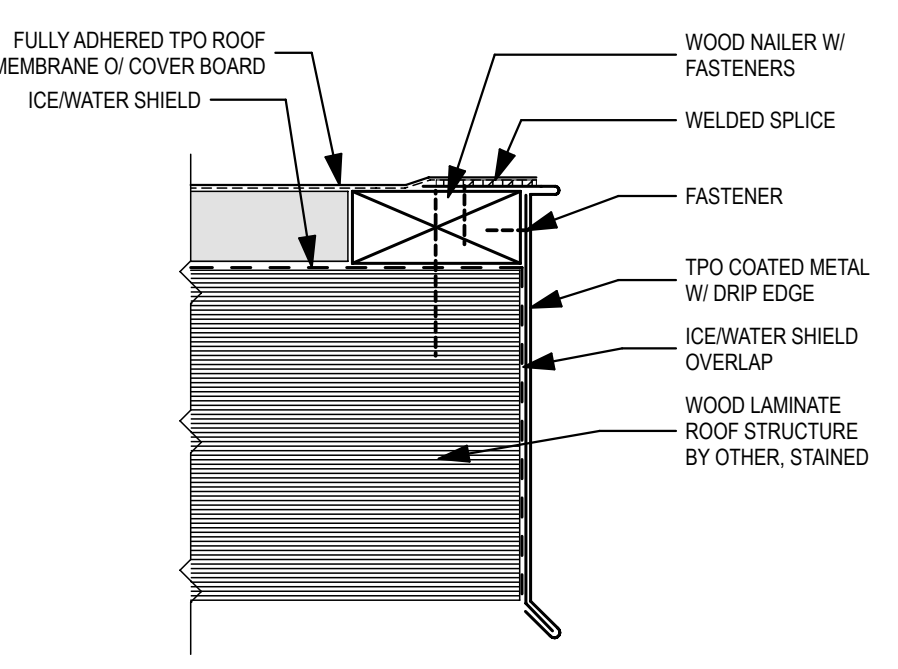


2 CANOPY CROSS SECTION
SCALE: 1/4" = 1'-0"

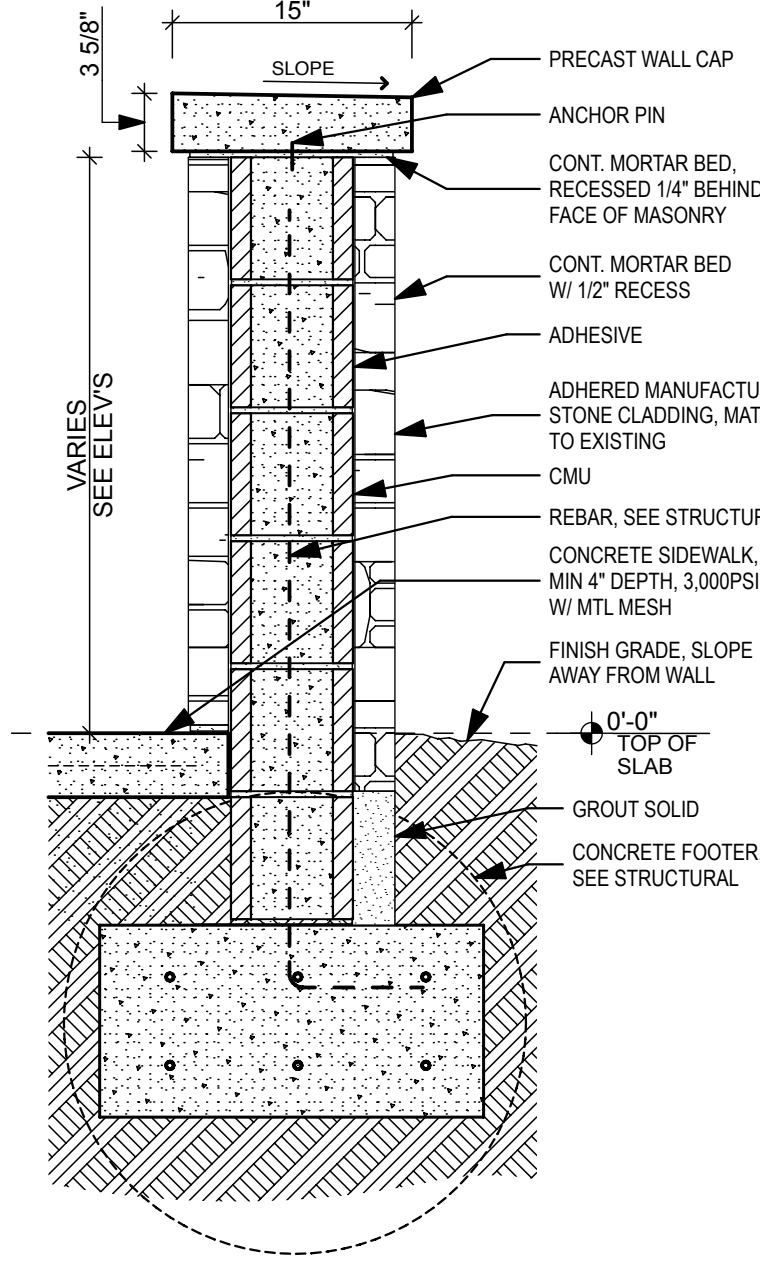

8 LOW WALL
SCALE: 1" = 1'-0"

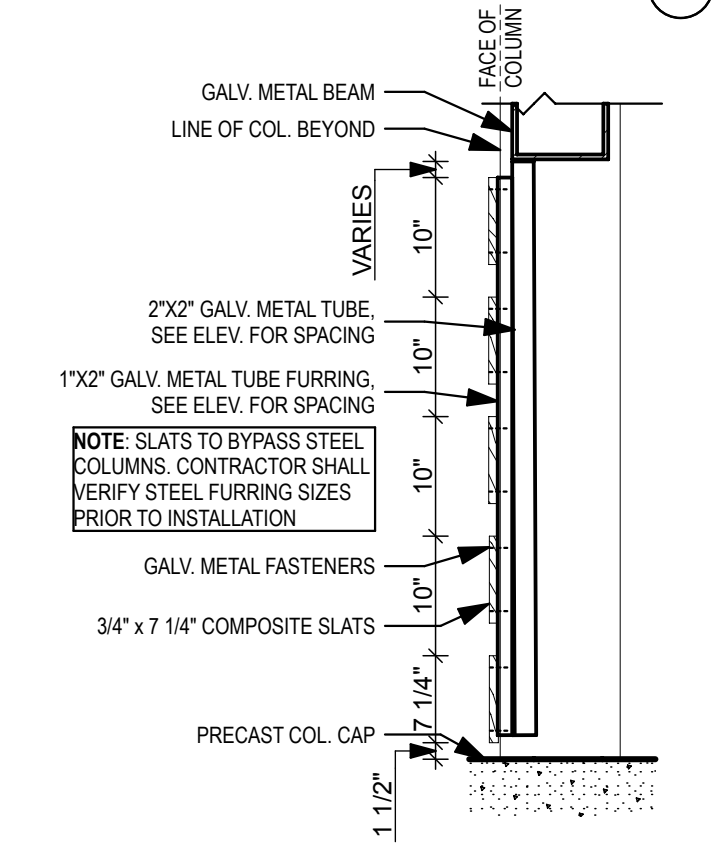

10 CANOPY SLATS
SCALE: 3/4" = 1'-0"

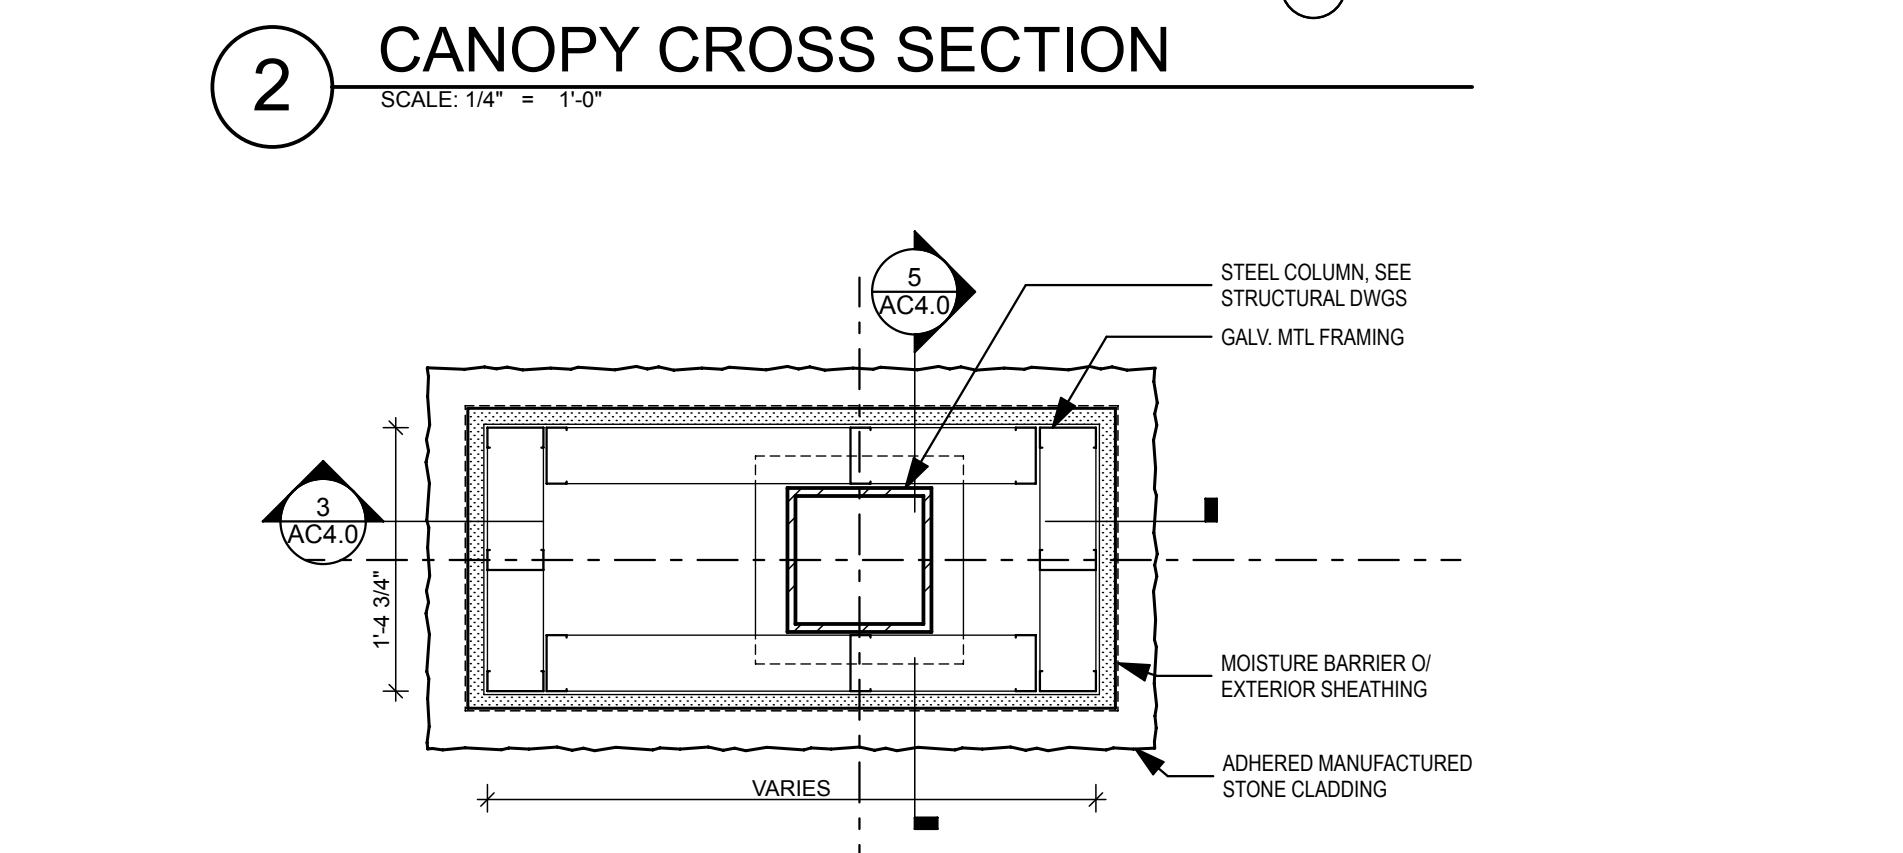

9 COLUMN PLAN DETAIL
SCALE: 1" = 1'-0"

PHASE:	CONCEPT SCHEM. DESIGN	DATE:	10/20/2024
	ADVANCED SCHEM. DESIGN	REVISION:	
	DESIGN DEVELOPMENT	ID:	
	CONSTRUCTION DOCS 90%	DRAWN:	J. HAYES
	CONSTRUCTION DOCS 100%	REVIEWED:	J. HAYES
	PERMIT DOCS	DATE:	

Consultant: Civil **Plainman ENGINEERING** | Consultant: MEP **FSM Engineering** | Consultant: Structural **KEVER MCKEE ENGINEERING** | Architect: **HAYS LAYER ARCHITECTURE** | Seal: **HAYS LAYER ARCHITECTURE**

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